COMMITTEE OF ADJUSTMENT



City Hall, 5th floor, 71 Main Street West, Hamilton, ON L8P 4Y5 Telephone (905) 546-2424, ext. 4221 Fax (905) 546-4202

E-mail: morgan.evans@hamilton.ca

NOTICE OF PUBLIC HEARING Minor Variance

You are receiving this notice because you are either:

• Assessed owner of a property located within 60 metres of the subject property

· Applicant/agent on file, or

• Person likely to be interested in this application

APPLICATION NO.:

GL/A-20:66

APPLICANTS:

Kalos Engineering Inc., on behalf of the owner Martin Raposa

SUBJECT PROPERTY:

Municipal address 3659 Upper James St., (Glanbrook) City

of Hamilton

ZONING BY-LAW:

Zoning By-law 05-200, as Amended

ZONING:

"A2" (Rural) Zone

PROPOSAL:

To permit the construction of a storage building (accessory building) which is accessory to the existing single detached dwelling,

notwithstanding,

- 1. A maximum lot coverage of 8.5% for all accessory buildings shall be permitted instead of the maximum permitted lot coverage of 5% of the total lot area;
- 2. A maximum gross floor area of 302 square metres for all accessory buildings shall be permitted instead of the maximum permitted gross floor area of 200 square metres for all accessory buildings; and
- 3. A maximum height of 9.0 metres shall be permitted instead of the maximum permitted height of 6.0 metres for an accessory building.

NOTES:

- 1. The requested variances have been written for the use of an accessory building which is accessory to the existing single detached dwelling only. Accessory, as defined in the Zoning By-law, shall mean, when used to describe a use of land, building or structure, shall mean a use which is commonly incidental, subordinate and exclusively devoted to the main use or main building situated on the same lot. Please be advised, should the intent be to utilize the proposed building for a use other than a building accessory to the existing single detached dwelling further approval will be required.
- 2. It does not appear the height of the proposed building has been provided in accordance with the definition of Building Height and Grade as defined in the Zoning By-law. The applicant shall ensure the requested variance is sufficient to satisfy the maximum height requirement in accordance with Building Height and Grade as defined in the Zoning By-law.
- 3. A further variance will be required if the eave and gutter of the proposed accessory building exceeds greater than 0.6 metres into the required 1.0 metre setback.
- 4. The lot area of 3804 square metres obtained from GISNet has been used to determine the proposed lot coverage.

This application will be heard by the Committee as shown below:

DATE:

Thursday, July 9th, 2020

TIME:

2:35 p.m.

PLACE: Via video link or call in (see attached sheet for details)

To be streamed at www.hamilton.ca/committeeofadjustment

for viewing purposes only

PUBLIC INPUT

Written: If you would like to submit written comments to the Committee of Adjustment you may do so via email or hardcopy. Please see attached page for complete instructions, including deadlines for submitting to be seen by the Committee.

Orally: If you would like to speak to this item at the hearing you may do so via video link or by calling in. Please see attached page for complete instructions, including deadlines for registering to participate.

MORE INFORMATION

For more information on this matter, including access to drawings illustrating this request:


- Visit <u>www.hamilton.ca/committeeofadjustment</u>
- Call 905-546-CITY (2489) or 905-546-2424 extension 4221, 4130, or 3935
- Email Committee of Adjustment staff at cofa@hamilton.ca

DATED: June 23rd, 2020.


Original Signed

Jamila Sheffield, Secretary-Treasurer Committee of Adjustment


Information respecting this application is being collected under the authority of the Planning Act, R.S.O., 1990, c. P. 13. All comments and opinions submitted to the City of Hamilton on this matter, including the name, address, and contact information of persons submitting comments and/or opinions, will become part of the public record and will be made available to the Applicant and the general public.

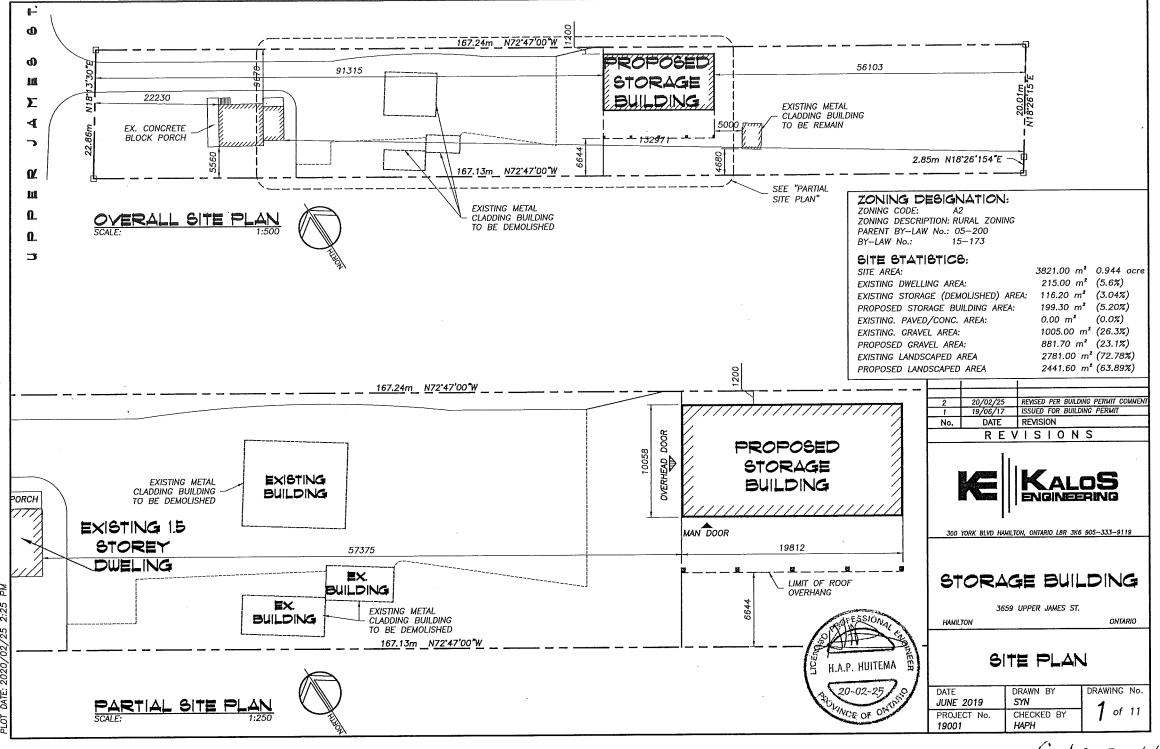

GUA-20:66 SKetch(1)

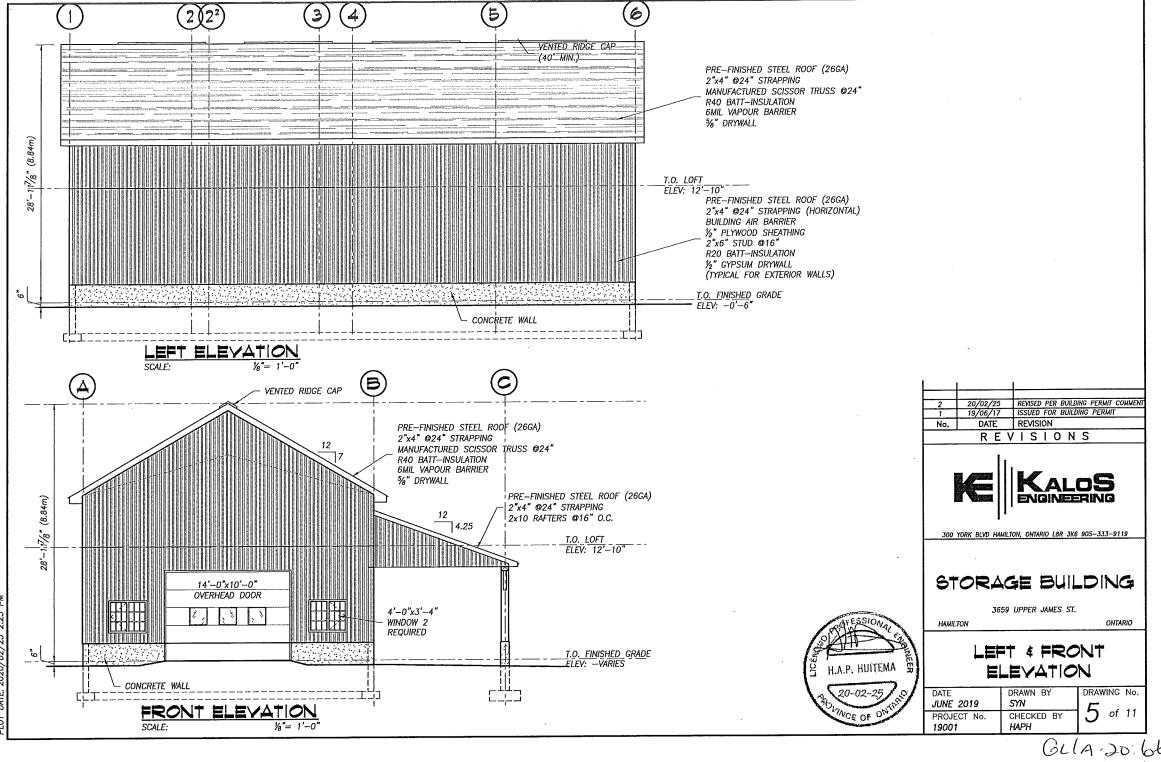

GLLA.20:66 Sketch(2)

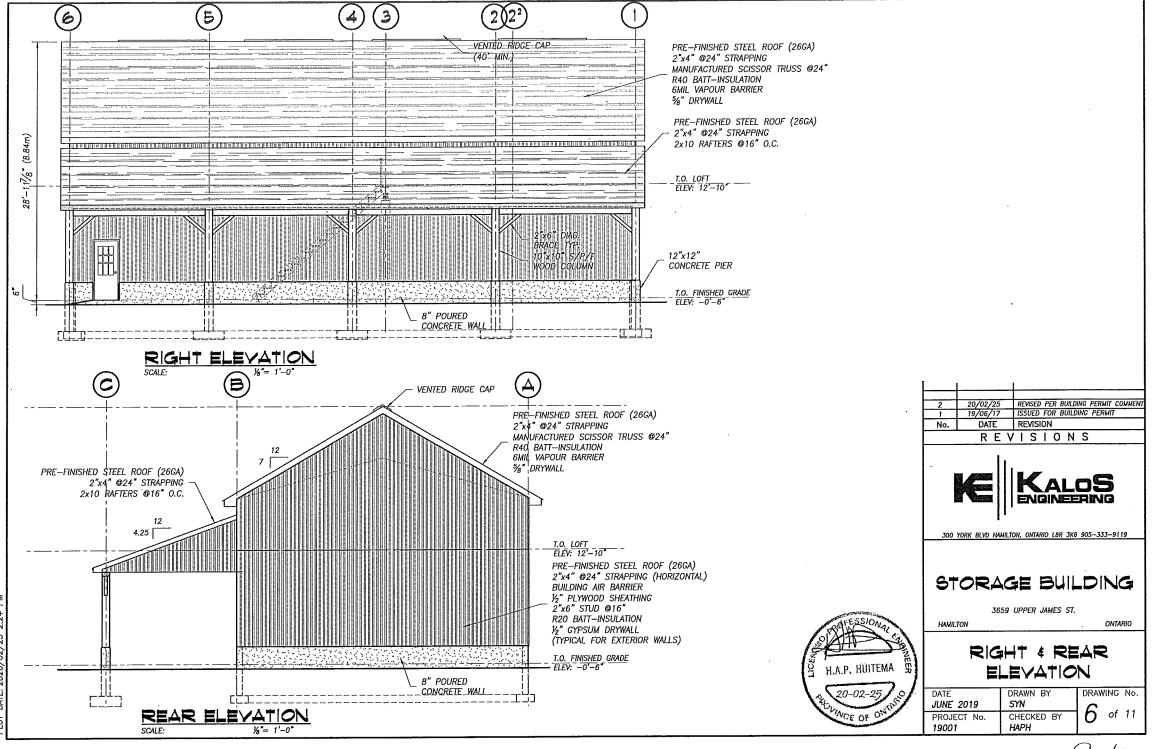



Planning and Economic Development Department Planning Division

Committee of Adjustment

City Hall 5th floor 71 Main Street West Hamilton, Ontario L8P 4Y5

Phone (905) 546-2424 ext.4221 Fax (905) 546-4202

PLEASE FILL OUT THE FOLLOWING PAGES AND RETURN TO THE CITY OF HAMILTON PLANNING DEPARTMENT.

FOR OF	FFICE USE ONLY. FEB 1 2 282		
APPLIC	APPLICATION NO. DATE APPLICATION RECEIVED COM DE ADULTE		
PAID_	DATE APPLICATION DEEMED COMPLETE		
SECRE SIGNAT	TARY'S TURE		
	CITY OF HAMILTON COMMITTEE OF ADJUSTMENT HAMILTON, ONTARIO		
	The Planning Act		
	Application for Minor Variance or for Permission		
under S	dersigned hereby applies to the Committee of Adjustment for the City of Hamilton Section 45 of the <i>Planning Act</i> , R.S.O. 1990, Chapter P.13 for relief, as described in blication, from the Zoning By-law.		
1. N	Name of Owner Martin Raposa Telephone No.		
2.			
3. N	Name of Agent Kalos Engineering Inc. Telephone No01		
4.			
Note:	Unless otherwise requested all communications will be sent to the agent, if any.		
	Names and addresses of any mortgagees, holders of charges or other encumbrances: CIBC		
_	1550 Upper James Street, Hamilton Postal Code L9B 2L6		
-	Postal Code		

6.	Nature and extent of relief applied for:			
	increased height for proposed storage building. seeking relief for 8.83m			
	height versus 6.0m maximum per by-law. it should be noted that maximum			
	height for single family dwelling (alos on this property) is 10.5m			
7.	Why it is not possible to comply with the provisions of the By-law? Desired function of the building includes a loft for added space, triggering an increased height of building			
8.	Legal description of subject lands (registered plan number and lot number or other legal description and where applicable, street and street number): 3659 Upper James Street, Mount Hope L0R 1W0			
9.	PREVIOUS USE OF PROPERTY			
	Residential X Industrial Commercial			
	Agricultural X Vacant			
	Other			
9.1	If Industrial or Commercial, specify use			
9.2	Has the grading of the subject land been changed by adding earth or other material, i.e. has filling occurred?			
	Yes No _X_ Unknown			
9.3	Has a gas station been located on the subject land or adjacent lands at any time?			
	Yes No X Unknown			
9.4	Has there been petroleum or other fuel stored on the subject land or adjacent lands?			
	Yes No X Unknown			
9.5	Are there or have there ever been underground storage tanks or buried waste on the subject land or adjacent lands?			
	Yes No _X Unknown			
9.6	Have the lands or adjacent lands ever been used as an agricultural operation where cyanide products may have been used as pesticides and/or sewage sludge was applied to the lands?			
	Yes No X Unknown			
9.7	Have the lands or adjacent lands ever been used as a weapon firing range?			
	Yes No _X			
9.8	Is the nearest boundary line of the application within 500 metres (1,640 feet) of the fill area of an operational/non-operational landfill or dump?			
	Yes No _X Unknown			
9.9	If there are existing or previously existing buildings, are there any building materials remaining on site which are potentially hazardous to public health (eg. asbestos, PCB's)?			
	Yes No _X_ Unknown			

9.10	Is there any reason to believe the subject land may have been contaminated by former uses on the site or adjacent sites? Yes No _X_ Unknown			
9.11	What information did you use to determine the answers to 9.1 to 9.10 above? Personal knowledge of the property			
9.12	a previous use inve	roperty is industrial or ntory showing all form d adjacent to the subj	er uses of the subje	S to any of 9.2 to 9.10, ct land, or if
	Is the previous use	inventory attached?	Yes	No X
I ackno		y of Hamilton is not re on on the property wh		
Feb	oruary 13, 2020			
Date		•	Signature of Prope	erty Owner
			Martin Raposa	
			Print Name of Own	er
10.	Dimensions of land	s affected:		
	Frontage	22.86m		
	Depth	167.24m		
	Area	3821.0 sm		
	Width of street	assumed 30m (fo	ormer Highway 6 so	uth)
11.		ildings and structures or area, gross floor a		
	Existing:	Single Family Dwell	ing - 1 storey - 82.7	sm
		Approx 11.8m x 7.4	6m, height approx 6	m
		Other existing acces	ssory buildings to be	removed
	Proposed:	Storage Shed - 1 sto	orey with loft - 199.3	sm
		19.8m x 10.05m, 8.	83m high	
	:			
			AND THE CONTRACT OF THE CONTRA	
12.		ings and structures or om side, rear and fror		subject lands;
	Existing:	Single Family Dwell	ing	,
		- front - 22.2m		
		- rear - 132.9m		
		- sides - 9.76m and	5.56m	
	Proposed:	Storage Building		
		- front - 91.3m		
		- rear - 56.1m		
		- sides - 1.2m and	6.64m (to lean to a	t side)

13.	Date of acquisition of subject lands: 2017		
14.	Date of construction of all buildings and structures on subject lands: circa 1970		
15.	Existing uses of the subject property: Single family dwelling		
16.	Existing uses of abutting properties: Single family dwelling		
17.	Length of time the existing uses of the subject property have continued: estimated 40 years		
18.	Municipal services available: (check the appropriate space or spaces)		
	Water		
	Sanitary Sewer Connected		
	Storm Sewers		
19.	Present Official Plan/Secondary Plan provisions applying to the land:		
20.	Present Restricted Area By-law (Zoning By-law) provisions applying to the land: 05-200 and 15-173		
21.	Has the owner previously applied for relief in respect of the subject property? Yes		
	If the answer is yes, describe briefly.		
22.	Is the subject property the subject of a current application for consent under Section 53 of the <i>Planning Act</i> ?		
	Yes		
23.	The applicant shall attach to each copy of this application a plan showing the dimensions of the subject lands and of all abutting lands and showing the location, size and type of all buildings and structures on the subject and abutting lands, and where required by the Committee of Adjustment such plan shall be signed by an Ontario Land Surveyor.		
	NOTE: It is required that two copies of this application be filed with the secretary-treasurer of the Committee of Adjustment together with the maps referred to in Section 5 and be accompanied by the appropriate fee in cash or by cheque made payable to the City of Hamilton.		

PART 24 AFFIDAVIT OR SWORN DECLARATION

This declaration to be sworn by a Commissioner of Oaths.

	g y
PART 25 OWNERS AUTHORIZAT	TION
contents of this application and hereby	ME) Martin Raposa am the d in this application, and I have examined the certify that the information submitted with the knowledge of these facts, and I hereby authorize:
Hank Huitema	of Kalos Engineering Inc.
• •	provide any of my personal information that will be during the processing of the application.
• •	
DATE February 13, 2020 PART 26 CONSENT OF THE OW	SIGNED Signature of Owner
DATE February 13, 2020 PART 26 CONSENT OF THE OW Complete the consent of the owner concent of Owner to the Disclosure of	SIGNED Signature of Owner
DATE February 13, 2020 PART 26 CONSENT OF THE OW Complete the consent of the owner concent of Owner to the Disclosure of Documentation Application information is collected und c. P.13. In accordance with that Act, it	SIGNED Signature of Owner NER Incerning personal information set out below.
DATE February 13, 2020 PART 26 CONSENT OF THE OWN Complete the consent of the owner consent of Owner to the Disclosure of Documentation Application information is collected und c. P.13. In accordance with that Act, it public access to all Planning Act applied to the City. I, Martin Raposa	SIGNED Signature of Owner NER Incerning personal information set out below. Application Information and Supporting der the authority of the Planning Act, R.S.O. 1990, is the policy of the City of Hamilton to provide
PART 26 CONSENT OF THE OWN Complete the consent of the owner concent of Owner to the Disclosure of Documentation Application information is collected und c. P.13. In accordance with that Act, it public access to all Planning Act applied to the City. I, Martin Raposa (Print name of Owner) that the information contained in this a reports, studies and drawings, provide agents, consultants and solicitors, conthe public record. As such, and in acceptable for the City of Hamilton making documentation available to the general	SIGNED Signature of Owner NER Incerning personal information set out below. Application Information and Supporting der the authority of the Planning Act, R.S.O. 1990, is the policy of the City of Hamilton to provide cations and supporting documentation submitted , the Owner, hereby agree and acknowledge application and any documentation, including ad in support of the application, by myself, my institutes public information and will become part of ordance with the provisions of the Municipal of Privacy Act, R.S.O. 1990, c. M.56, I hereby
PART 26 CONSENT OF THE OWN Complete the consent of the owner concent of Owner to the Disclosure of Documentation Application information is collected und c. P.13. In accordance with that Act, it public access to all Planning Act applied to the City. I, Martin Raposa (Print name of Owner) that the information contained in this a reports, studies and drawings, provide agents, consultants and solicitors, conthe public record. As such, and in acceptable for the City of Hamilton making documentation available to the general	Signature of Owner Application Information set out below. Application Information and Supporting der the authority of the Planning Act, R.S.O. 1990, is the policy of the City of Hamilton to provide cations and supporting documentation submitted The Owner, hereby agree and acknowledge application and any documentation, including ed in support of the application, by myself, my institutes public information and will become part of ordance with the provisions of the Municipal of Privacy Act, R.S.O. 1990, c. M.56, I hereby go this application and its supporting all public, including copying and disclosing the

PART 27 PERMISSION TO ENTER

Date: February 13, 2020

Secretary/Treasurer Committee of Adjustment City of Hamilton, City Hall

Dear Secretary/Treasurer;

Re:

Application to Committee of Adjustment

Location of Land: 3659 Upper James, Mount Hope L0R 1W0 (Municipal address)


I hereby authorize the members of the Committee of Adjustment and members of the staff of the City of Hamilton to enter on to the above-noted property for the limited purposes of evaluating the merits of this application.


Signature of Owner or Authorized Agent	
Martin Raposa	
Please print name	

Note: The Committee of Adjustment requires that all properties be identified with the municipal address clearly visible from the street. Where there is no municipal address or the property is vacant then the property shall be identified in accordance with the Committee's policy included on the back of the Application Form. Failure to properly identify the subject property may result in the deferral of the application.

PART 28 COLLECTION OF INFORMATION

The personal information contained on this form is collected under the authority of the *Planning Act*, R.S.O. 1990, c. P.13, and will be used for the purpose of processing the application. This information will become part of the public record and will be made available to the general public. Questions about the collection of this information should be directed to the Coordinator of Business Facilitation, Planning and Economic Development Department, City of Hamilton, 1st floor, 71 Main Street West, City Hall, Hamilton, Ontario, Telephone: 905-546-2424, ext.1284.

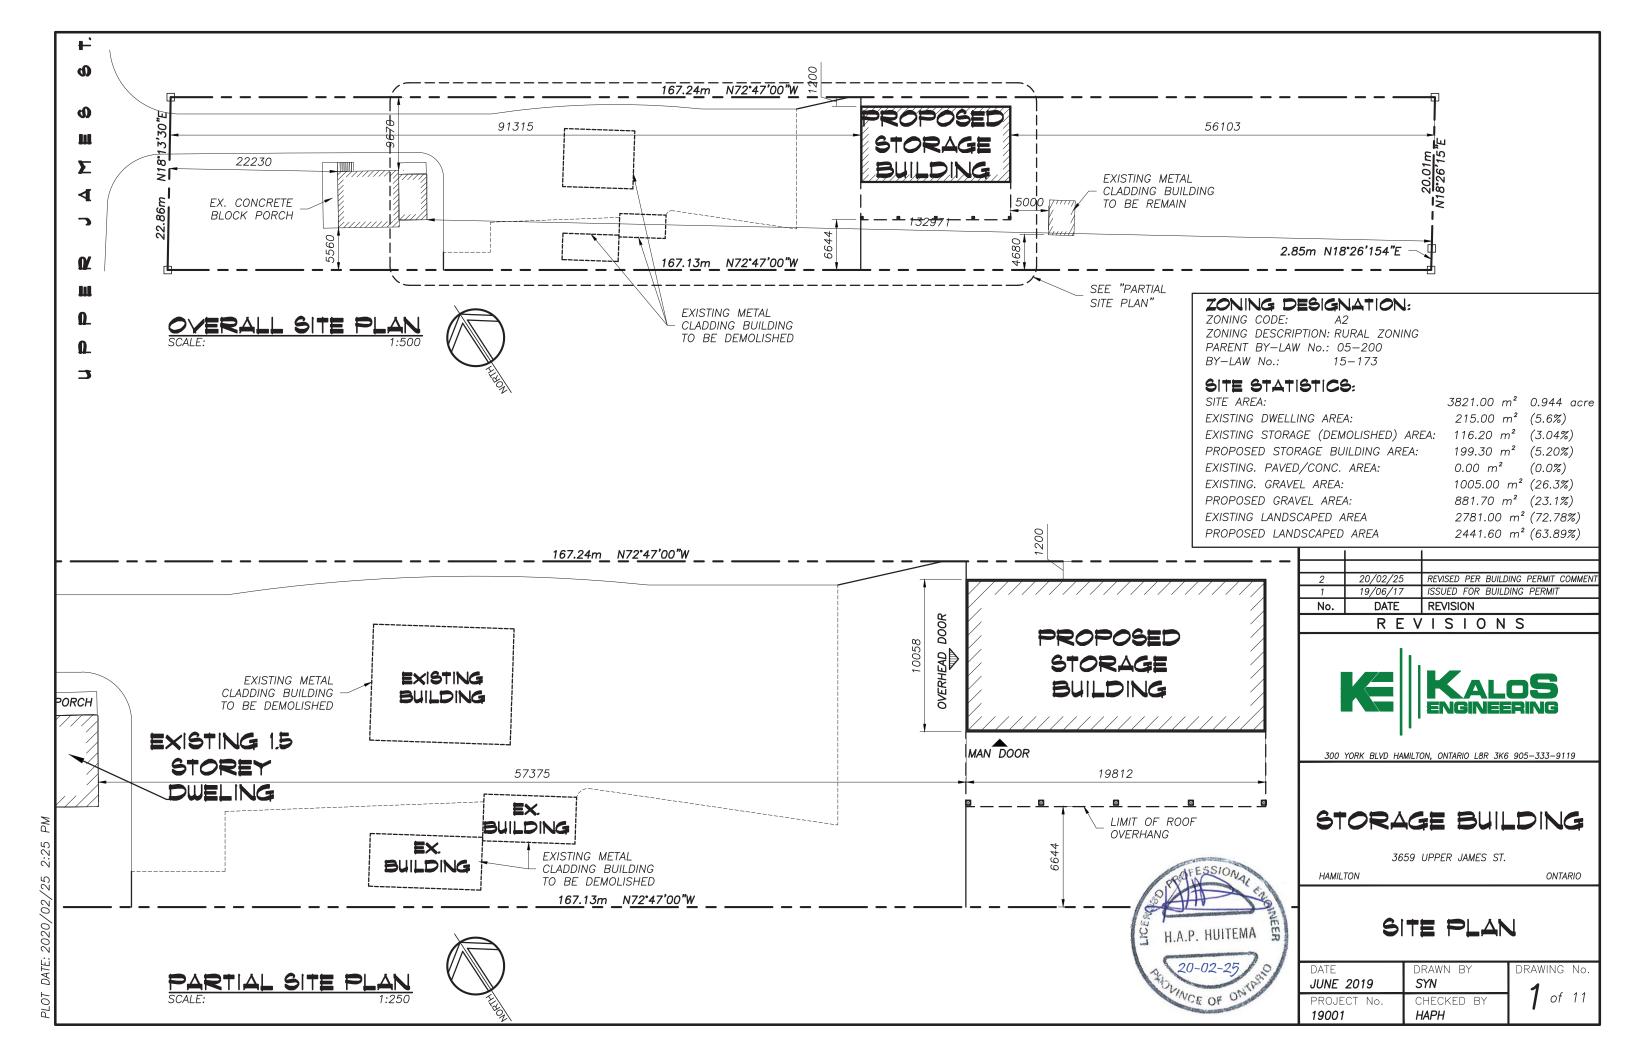

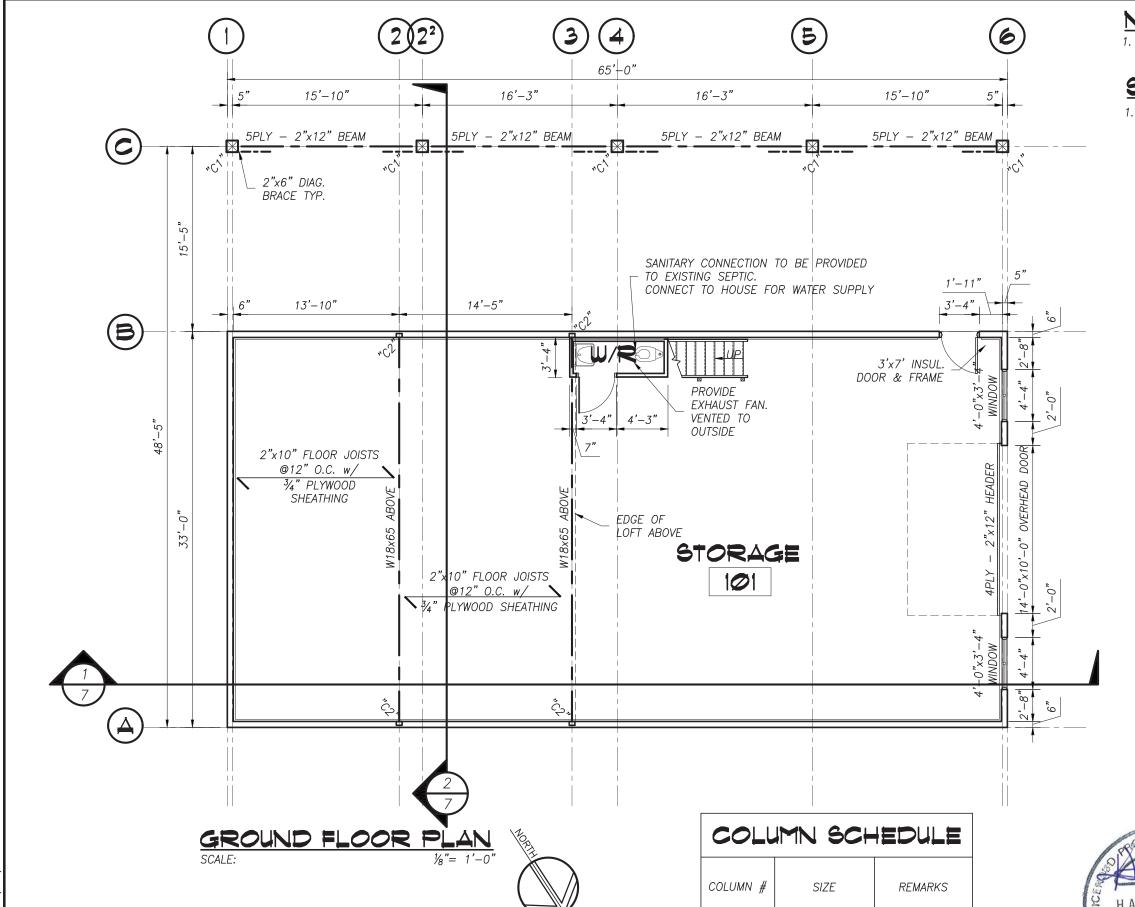

10"x10" S/P/F

TIMBER CÓLÚMN

6"x4"x0.25" HSS

COLUMN

0.25" BASE PL.

"C1"

NOTES

1. PROVIDE TEMPORARY SUPPORT UNDER ALL BEAMS UNTIL THEY ARE LATERALLY SUPPORTED

STAIR RAILING NOTE:

1. THE HANDRAILS MUST BE DESIGNED TO WITHSTAND LOADING AS SPECIFIED IN O.B.C.-2012 DIV. B. ARTICLE 3.4.6.5., 3.4.6.6. & GUARD RAILS MUST BE DESIGNED TO WITHSTAND LOADING AS SPECIFIED IN ARTICLES 4.1.5.14. & 4.1.5.16. SHOP DRAWINGS ARE TO BE STAMPED BY A PROFESSIONAL ENGINEER

DESIGN LOADING

LOFT FLOOR: DEAD LOAD


LIVE LOAD

= 12 psf $= 100^{\circ} psf$

ROOF LOAD:

DEAD LOAD LIVE LOAD (SNOW) = 15 psf = 30.1 psf

2	20/02/25	REVISED PER BUILDING PERMIT COMMENT
1	19/06/17	ISSUED FOR BUILDING PERMIT
No.	DATE	REVISION

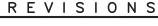



300 YORK BLVD HAMILTON, ONTARIO L8R 3K6 905-333-9119

STORAGE BUILDING

3659 UPPER JAMES ST.

HAMILTON


19001

ONTARIO


GROUND FLOOR

Mathematical	PLAN				
#	DATE	DRAWN BY	DRAWING No.		
	JUNE 2019	SYN	0		
	PROJECT No.	CHECKED BY	2 of 11		
	40004	1 114 511			

HAPH

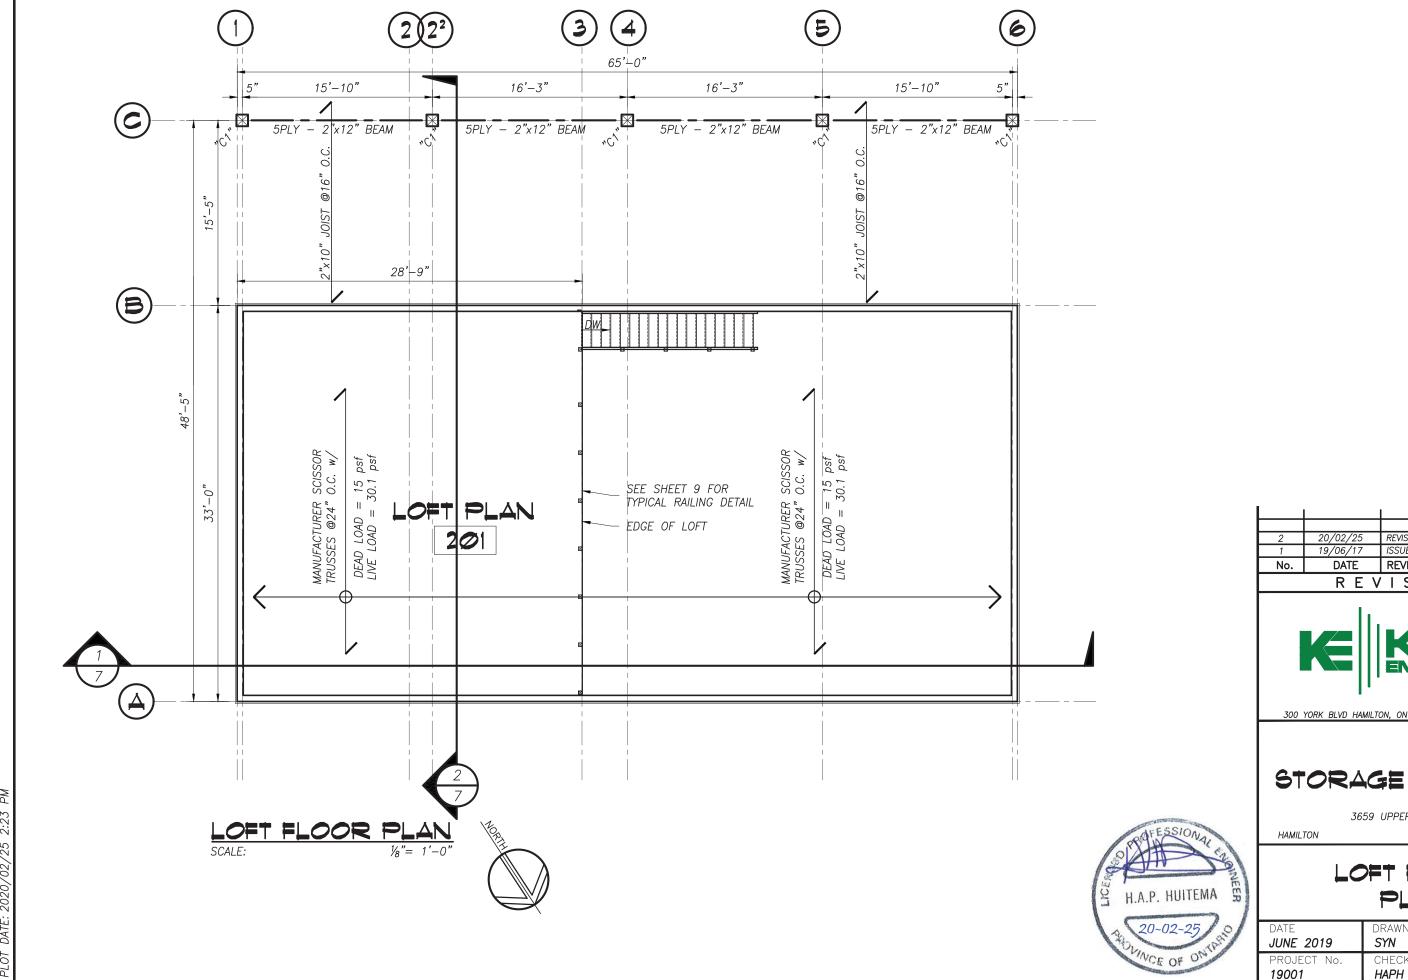

REVISED PER BUILDING PERMIT COMMEN REVISION

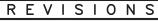



300 YORK BLVD HAMILTON, ONTARIO L8R 3K6 905-333-9119


STORAGE BUILDING

3659 UPPER JAMES ST.

ONTARIO

LOFT FLOOR PLAN

DATE	DRAWN BY	DRAWING No.
JUNE 2019	SYN	7
PROJECT No.	CHECKED BY	of 11

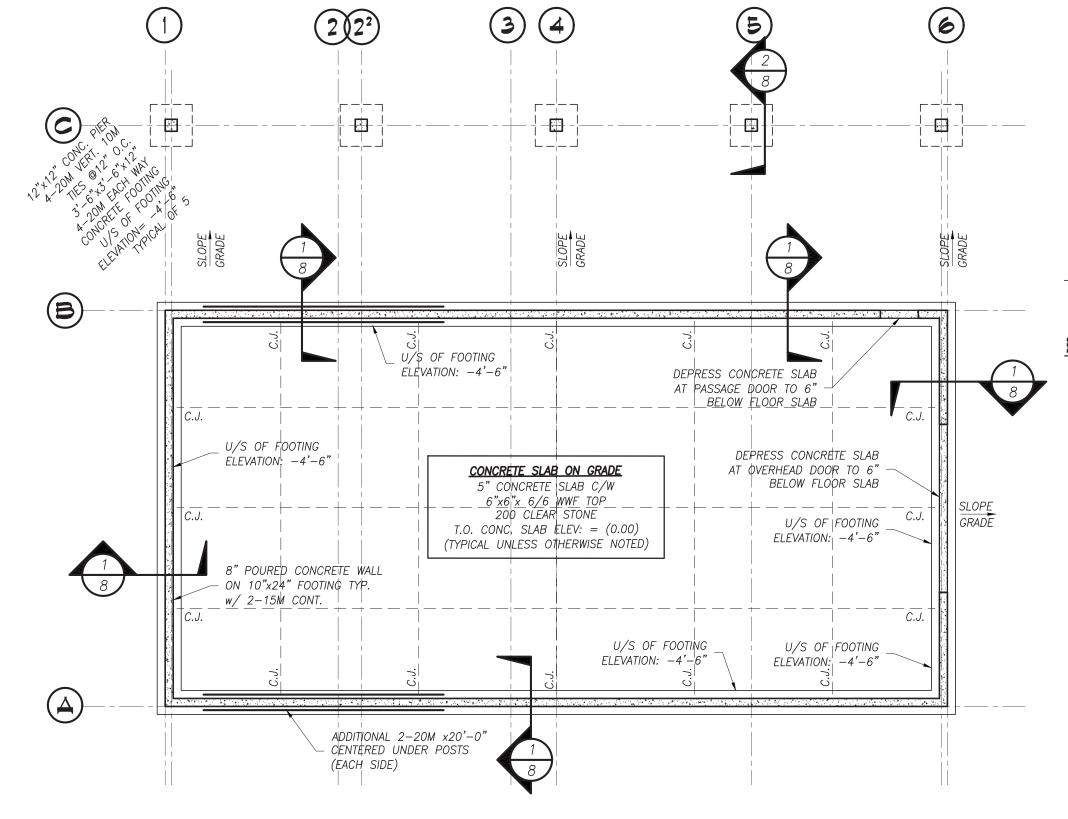

TYPICAL EXCAVATION AND BACKFILL AT FOUNDATION WALLS

FINISHED FLOOR

NOT TO SCALE

(REQUIRED BOTH SIDES OF ALL INTERIOR AND EXTERIOR FOUNDATION WALLS)

(REINFORCING NOT SHOWN FOR CLARITY)

NOTE: NATIVE SOIL IS UNSUITABLE FOR BACKFILL

FOUNDATION

SEE PLAN FOR

H.A.P. HUITEMA

2 20/02/25 REVISED PER BUILDING PERMIT COMMENT
1 19/06/17 ISSUED FOR BUILDING PERMIT
No. DATE REVISION

SLAB ON GRADE

8" CLEAR STONE

GRANULAR B (TYPE 2)

REVISIONS



300 YORK BLVD HAMILTON, ONTARIO L8R 3K6 905-333-9119

STORAGE BUILDING

3659 UPPER JAMES ST.

3639 UPPER JAMES

HAMILTON

ONTARIO


FOUNDATION PLAN


DATE	DRAWN BY	DRAWING	No
JUNE 2019	SYN	1	
PROJECT No.	CHECKED BY	4 of	11
19001	HAPH	•	


FOUNDATION PLAN SCALE: 1/9"= 1'-0"

NOTES:

- 1. TOP OF CONCRETE SLAB ON GRADE ELEVATION = 0.0 UNLESS NOTED OTHERWISE
- 2. REFER TO PAGE 10 FOR TYPICAL FOUNDATION DETAILS, CONCRETE AND MASONRY NOTES
- 3. COORDINATE PIER, ANCHOR BOLT LAYOUT WITH COLUMN BASE PLATES

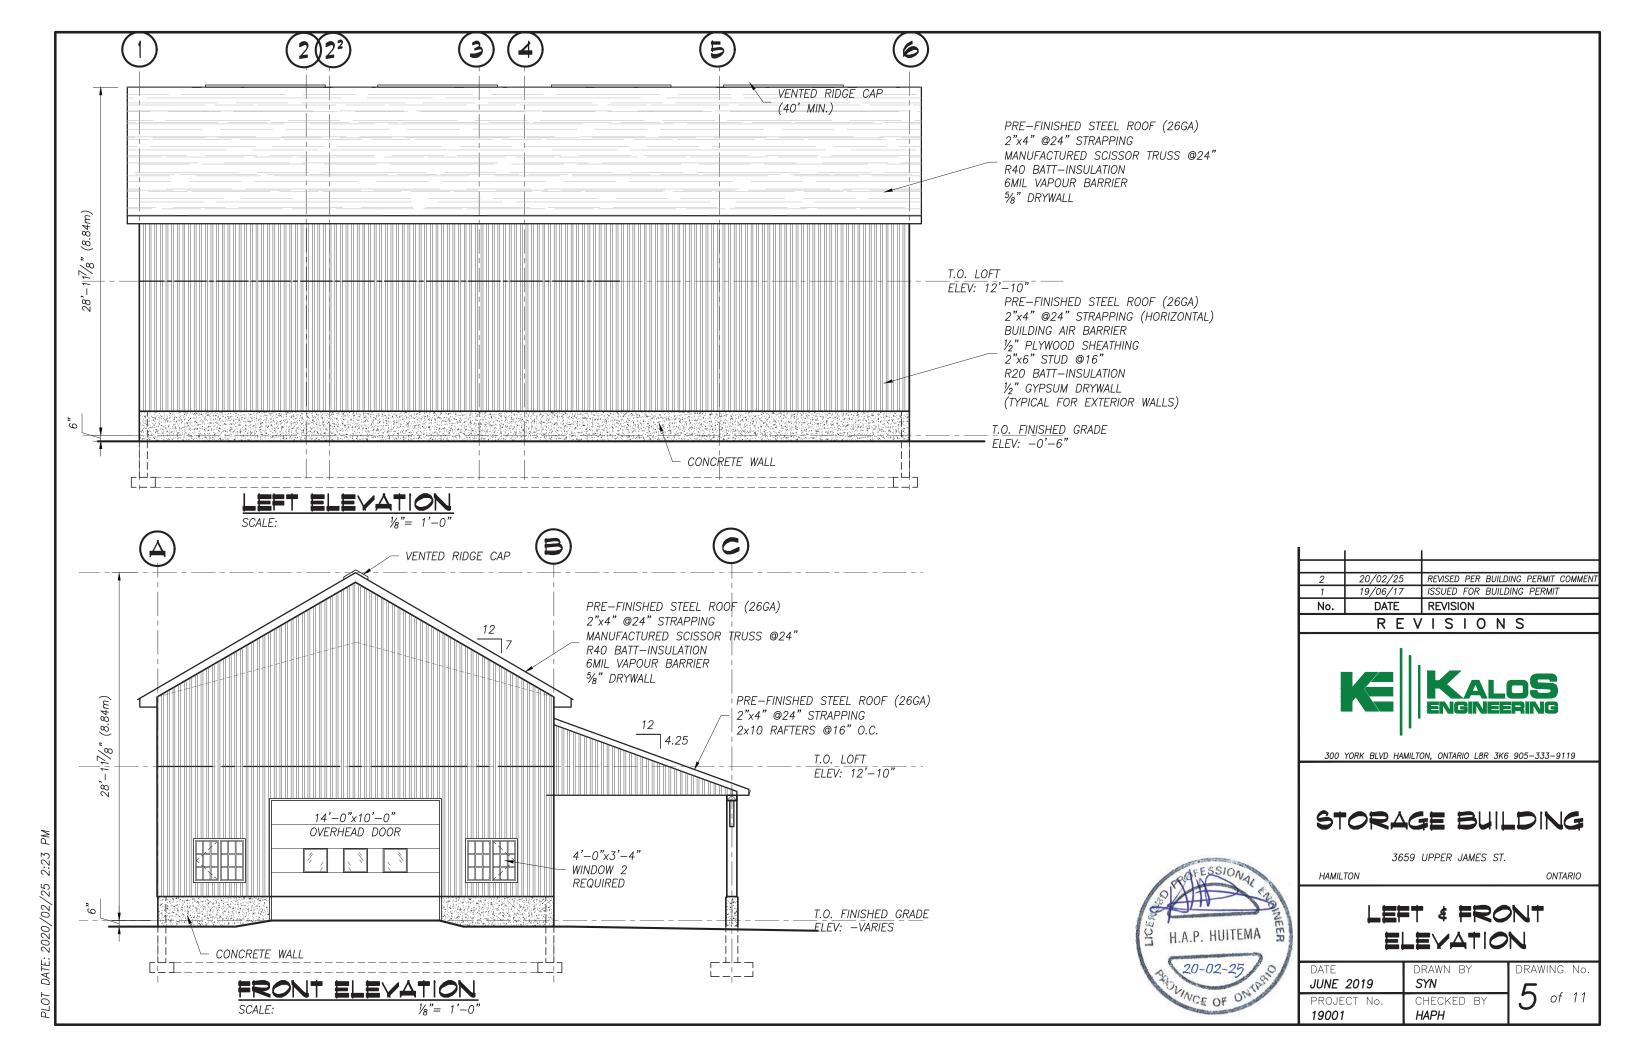


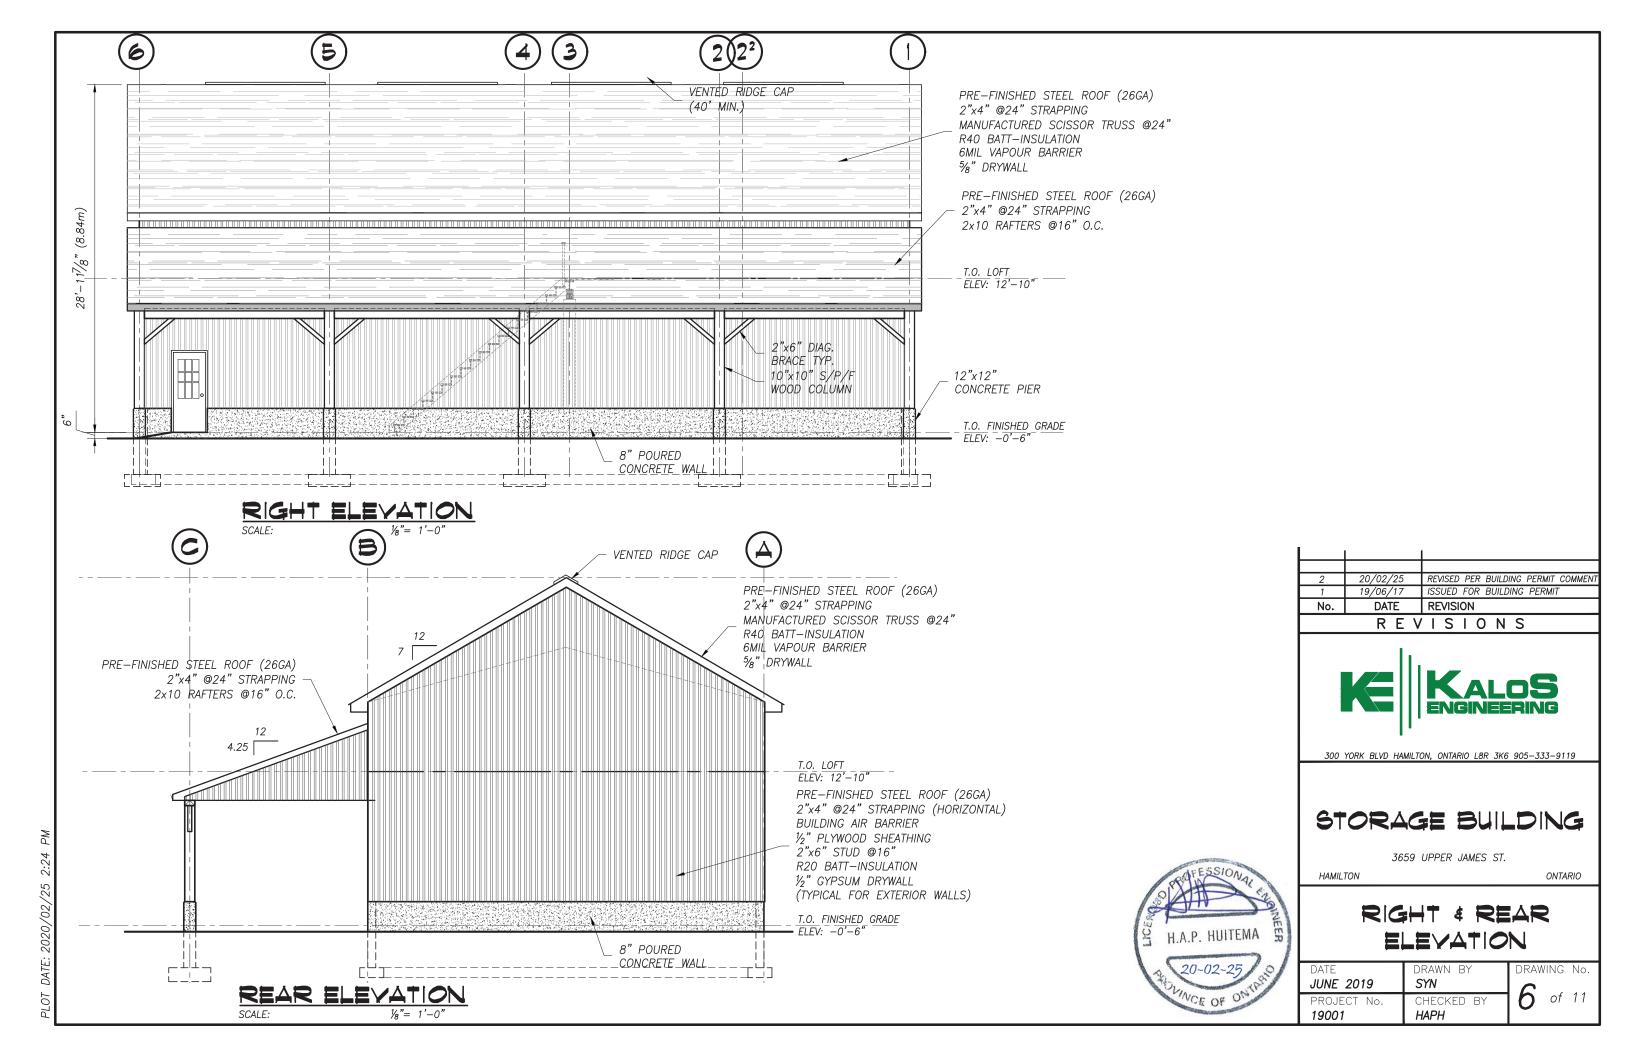

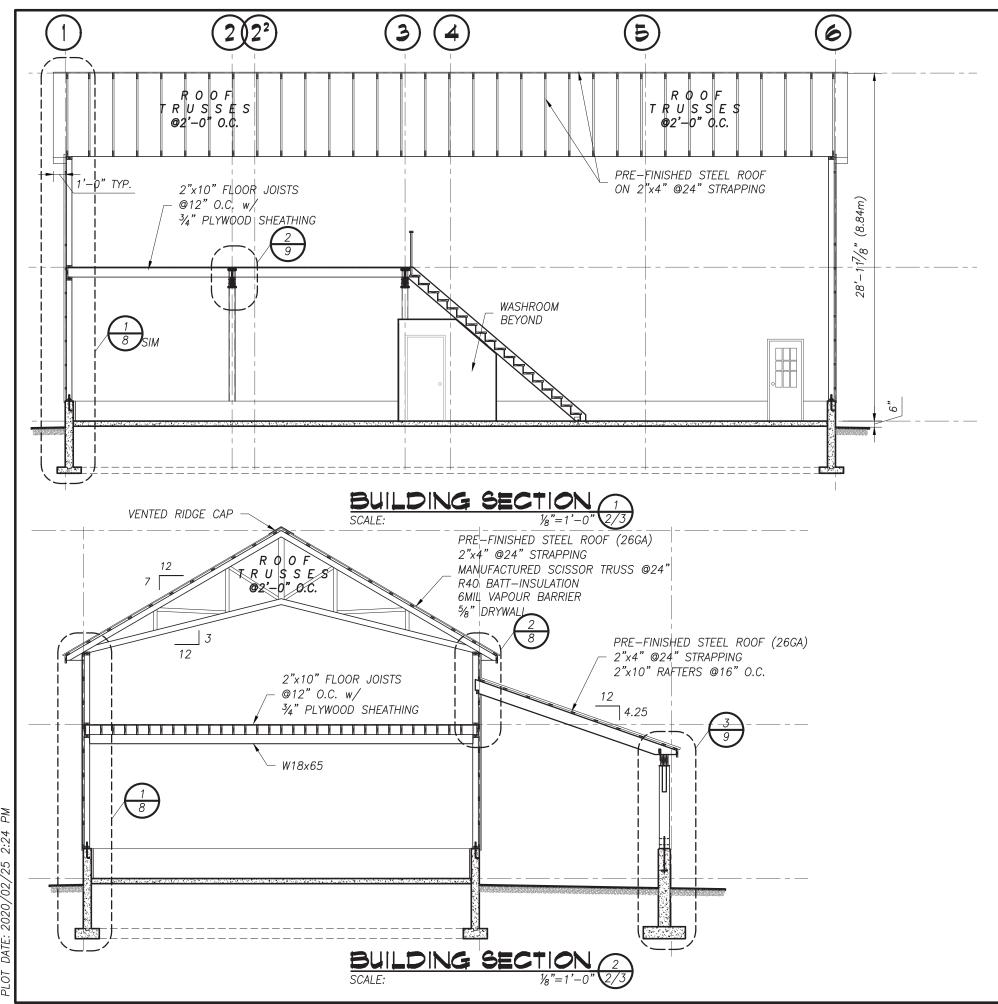

GENERAL NOTES

- 1. CHECK ALL DIMENSIONS ON THESE DRAWINGS WITH ALL OTHER DRAWINGS, INCLUDING BUT NOT LIMITED TO DRAWINGS PREPARED ARCHITECTURAL, MECHANICAL OR ELECTRICAL CONSULTANTS. REPORT ANY INCONSISTENCIES TO THE ENGINEER PRIOR TO COMMENCING WITH THE WORK. DO NOT SCALE THE DRAWINGS.
- 2. THE DESIGN LIVE LOADS ARE INDICATED ON THE DRAWINGS. CONSTRUCTION LOADS SHALL NOT EXCEED THE DESIGN LOADS.
- 3. THE COMPLETED STRUCTURE IS SHOWN ON THE DRAWINGS. THE CONTRACTOR SHALL PROVIDE ALL TEMPORARY BRACING, SHORING AND ANY OTHER TEMPORARY OR PERMANENT MEASURES AS REQUIRED DURING CONSTRUCTION. THE CONTRACTOR SHALL PROVIDE ALL TEMPORARY SUPPORT OF EXISTING OR ADJACENT STRUCTURES AS REQUIRED. ALL BRACING AND SHORING IS THE RESPONSIBILITY OF THE CONTRACTOR.
- 4. CONSTRUCTION FEATURES NOT FULLY SHOWN ARE COMPARABLE TO SIMILAR CONDITION DETAILS.
- 5. REFER TO OTHER CONSULTANTS DRAWINGS FOR DETAILS OF OPENINGS, PITS, CHAMFERS, DEPRESSIONS NOT INDICATED ON THE STRUCTURAL DRAWINGS.
- 6. ALL CONSTRUCTION SHALL BE IN CONFORMANCE WITH THE LATEST ONTARIO BUILDING CODE, LATEST APPLICABLE REGULATIONS AND GOOD CONSTRUCTION PRACTICES.
- 7. THE STRUCTURAL DRAWINGS SHALL BE READ IN CONJUNCTION WITH ALL OTHER CONTRACT DRAWINGS AND SPECIFICATIONS.
- 8. CLARIFY ANY QUERIES WITH THE ENGINEER REGARDING THE INTERPRETATION OF THE DRAWINGS. PRIOR TO THE COMMENCEMENT OF ANY WORK.

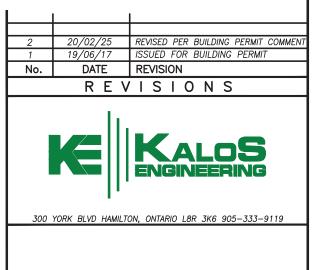



3659 UPPER JAMES ST.


HAMILTON


H.A.P. HUITEMA


ONTARIO


BUILDING SECTION

DATE	DRAWN BY	DRAWING No.
JUNE 2019	SYN	7
PROJECT No.	CHECKED BY	of 11
19001	HAPH	'

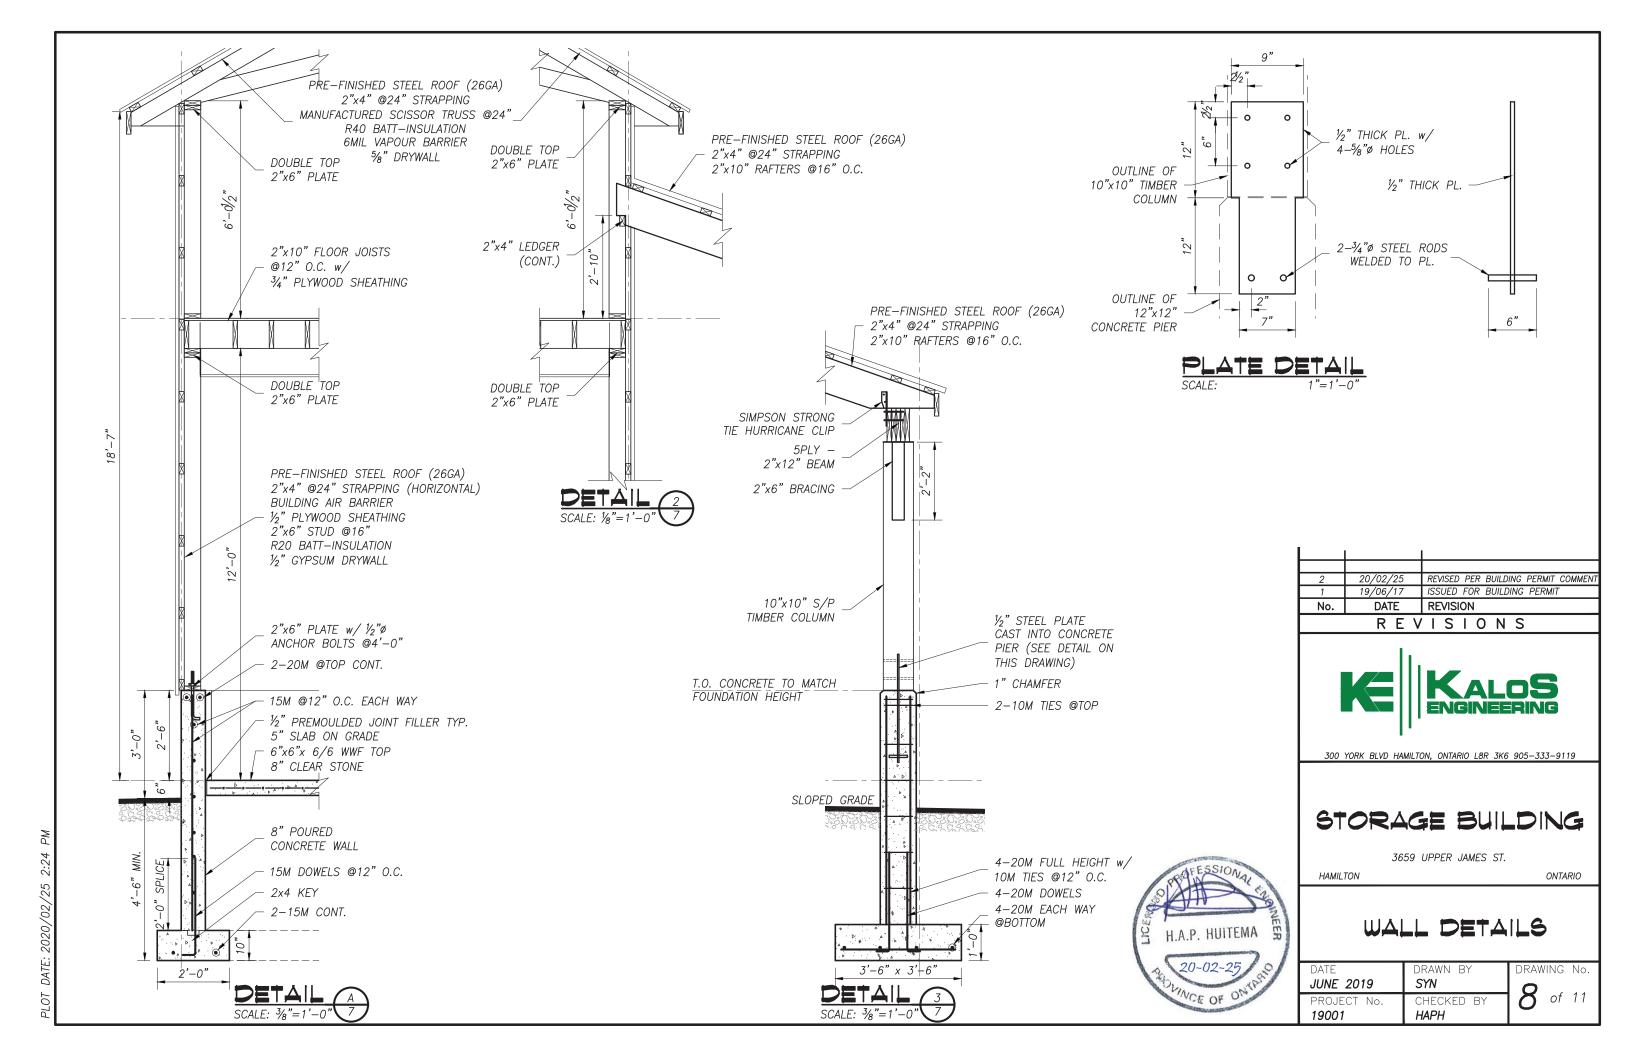

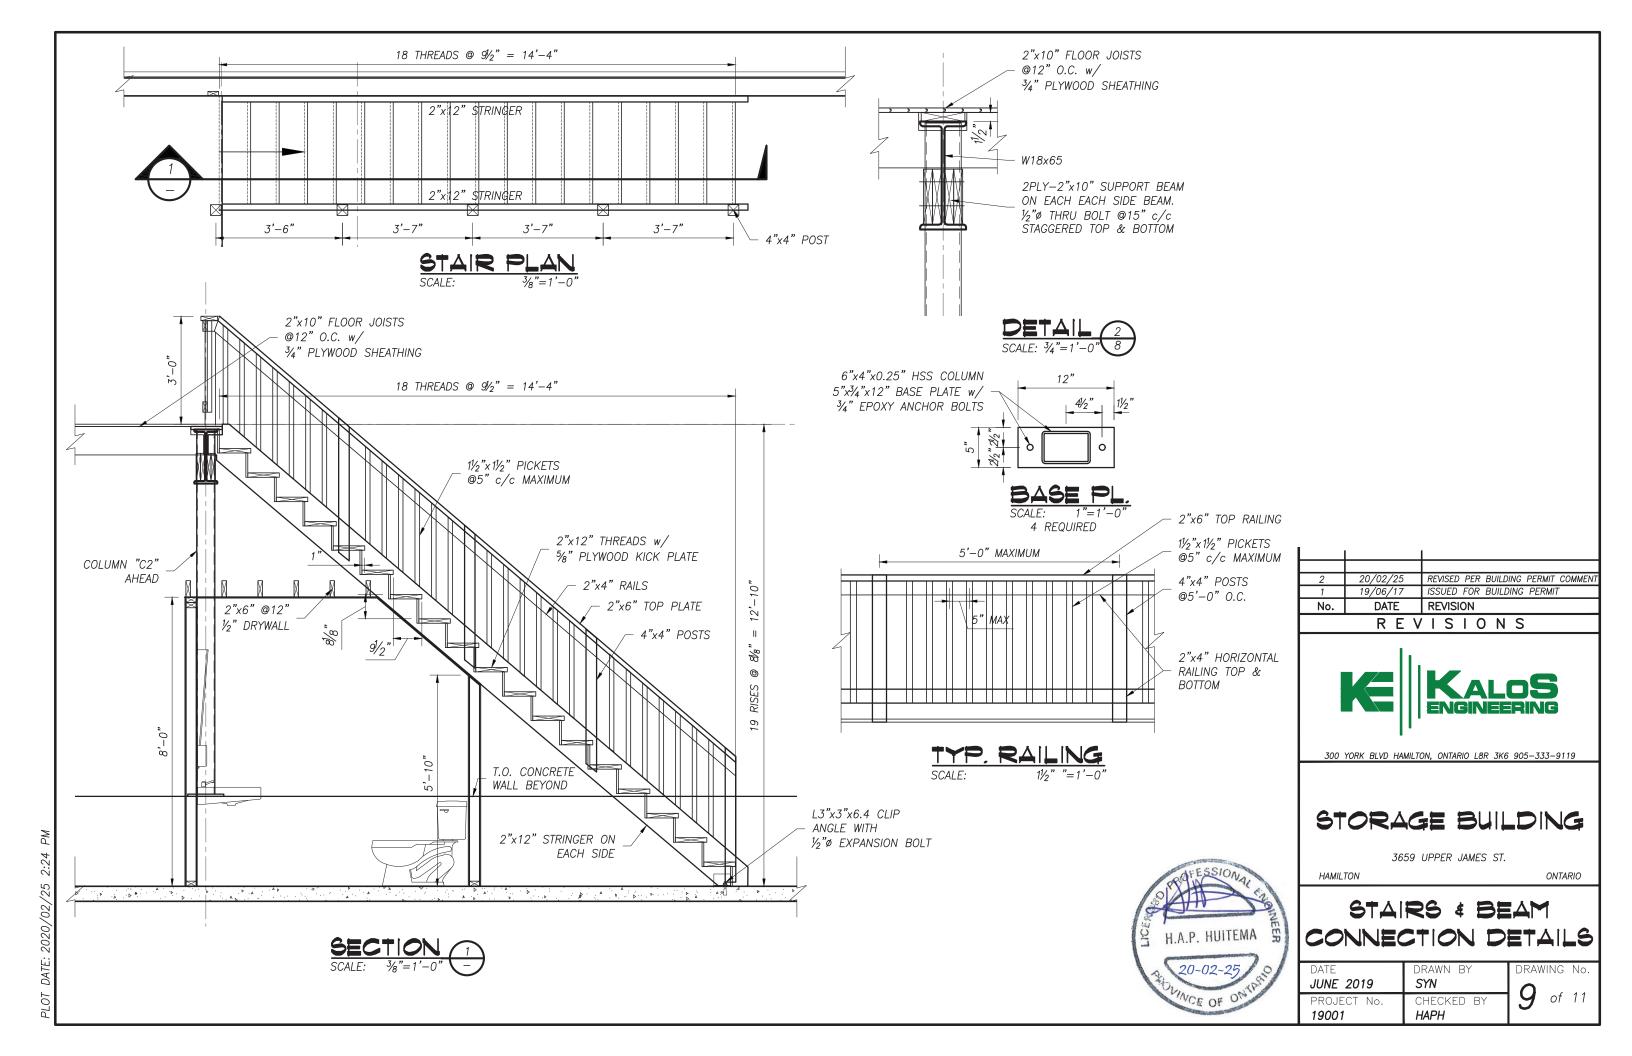


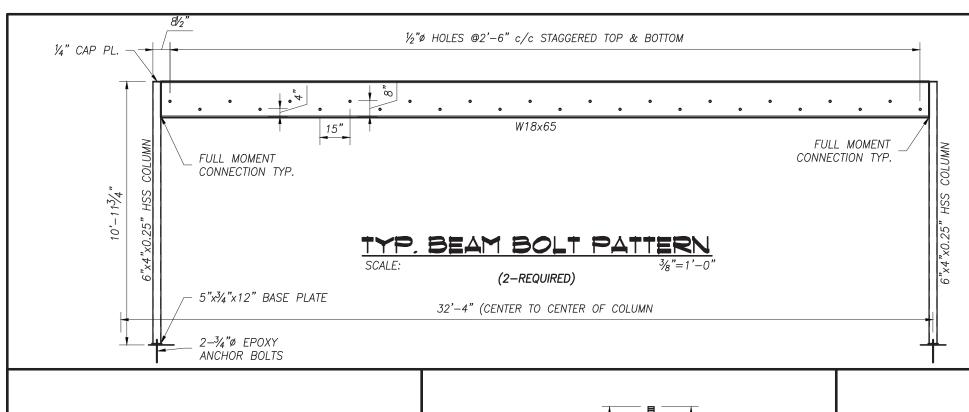

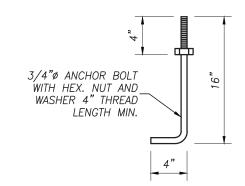


TYPICAL ANCHOR BOLT DETAIL

NOT TO SCALE

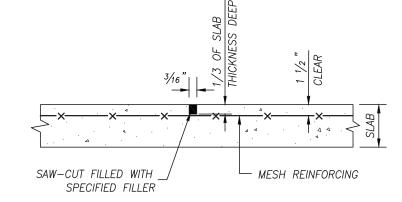


TYP. SAW-CUT CONTROL JOINT IN SLAB-ON-GRADE

NOT TO SCALE

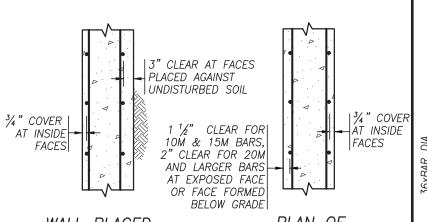

PLAN OF TYPICAL WALL

REINFORCING COVER NOT TO SCALE

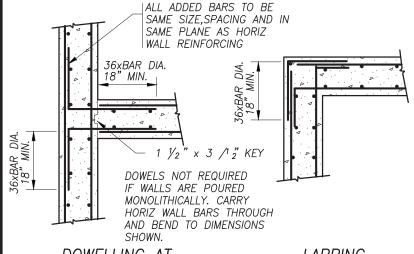

DOWELLING AT INTERSECTIONS

LAPPING AT CORNERS

TYPICAL CORNER DETAILS

NOT TO SCALE



No.	DATE	REVISION
1	19/06/17	ISSUED FOR BUILDING PERMIT
2	20/02/25	REVISED PER BUILDING PERMIT COMMENT

REVISIONS



300 YORK BLVD HAMILTON, ONTARIO L8R 3K6 905-333-9119

STORAGE BUILDING


3659 UPPER JAMES ST.

HAMILTON

ONTARIO

TYPICAL DETAILS

DATE JUNE 2019	SYN	DRAWING No.
PROJECT No. 19001	CHECKED BY HAPH	10 of 11

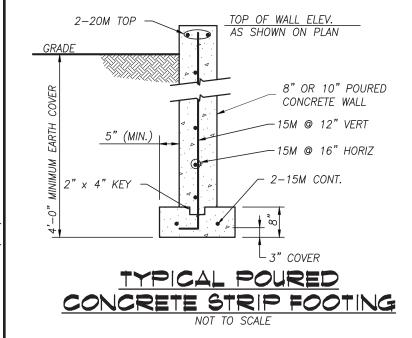

WALL PLACED AGAINST EARTH TYPICAL WALL

CONCRETE NOTES

- 1. ALL STRUCTURAL CONCRETE ELEMENTS HAVE BEEN DESIGNED IN ACCORDANCE WITH CSA STANDARD CAN/CSA A23.3. ALL CONCRETE CONSTRUCTION SHALL BE IN ACCORDANCE WITH CSA STANDARD CAN/CSA A23.1.
- 2. MINIMUM CONCRETE STRENGTH AT 28 DAYS SHALL BE:
 - FOOTINGSFOUNDATION WALLS
- 25 MPa TYPE N25 MPa TYPF F1
- SLAB ON GRADE
- 25 MPa TYPE N
- SLAB ON GRAL - PIERS
- 35 MPa TYPE C1
- SLUMP SHALL BE $3" \pm 1"$.
- AGGREGATE SHALL BE 3/4" MAXIMUM.
- AIR ENTRAINMENT TO BE $6\% \pm 1\%$ WHEN EXPOSED TO EXTERIOR.
- CONTRACTOR TO SUBMIT CONCRETE MIX DESIGN FOR REVIEW
- 3. THE DEFORMED REINFORCING STEEL SHALL CONFORM TO CSA STANDARD G30.18M-09 GRADE 300R FOR STIRRUPS AND TIES AND GRADE 400R FOR ALL OTHER REINFORCING. UNLESS OTHERWISE NOTED THE REINFORCING LAP LENGTH SHALL BE 'CLASS B' IN SPLICES. ALL REINFORCING HOOKS AND BENDS SHALL BE IN ACCORDANCE WITH A23.1.
- 4. WELDED WIRE FABRIC SHALL BE IN ACCORDANCE WITH CSA G30.5. ALL MESH SHALL BE CHAIRED PRIOR TO THE CONCRETE POUR. LIFTING OF THE MESH DURING THE CONCRETE POUR WILL NOT PERMITTED. ALL SPLICES SHALL BE A MINIMUM OF TWO CROSSWIRE SPACINGS PLUS 2".
- 5. THE REINFORCING COVER FOR CONCRETE SHALL BE:
 - 3" FOR CONCRETE AGAINST EARTH
 - 1½" FOR FORMED CONCRETE EXPOSED TO EARTH OR WEATHER WHERE THE REINFORCING BAR IS 15M OR SMALLER
 - 2" FOR FORMED CONCRETE EXPOSED TO EARTH OR WEATHER WHERE THE REINFORCING BAR IS 20M OR LARGER
 - 1" FOR INTERIOR CONCRETE. ALL CHAIRS, BOLSTERS, SPACERS AND BAR SUPPORTS SHALL BE IN ACCORDANCE WITH A23.1.
- 6. FOOTINGS SHALL BEAR ON NATIVE UNDISTURBED SOIL OR ENGINEERED FILL WITH A MINIMUM BEARING RESISTANCE OF:
 - 3000 psf (SLS)
 - 4000 psf (ULS).

THE CONTRACTOR SHALL VERIFY THE CAPACITY PRIOR TO PLACEMENT OF CONCRETE.

- 7. KEEP EXCAVATIONS DRY BEFORE CONCRETE IS PLACED. REMOVE ALL LOOSE MATERIAL, SOFT SOIL OR WATER PRIOR TO PLACING CONCRETE. PROVIDE A 3" MUD MAT FOR ALL FOOTINGS BELOW THE WATER TABLE.
- 8. ALL FOOTINGS SHALL BE CENTERED ON THE WALL UNLESS OTHERWISE NOTED.
- 9. THE FOOTING DESIGN IS BASED ON INFORMATION AVAILABLE AT THE TIME OF DESIGN. THE FOOTING DESIGN MAY BE ALTERED DURING CONSTRUCTION, IF THE SITE CONDITIONS WARRANT, BUT ONLY WITH THE EXPRESS PERMISSION OF THE ENGINEER.
- 10. PROTECT ALL FOOTINGS, WALLS AND SLABS AGAINST FROST ACTION DURING CONSTRUCTION. ALL EXTERIOR FOOTINGS SHALL FOUNDED BELOW THE FROST LINE, MINIMUM 5'-0" BELOW GRADE.

TIMBER FRAMING

- 1. ALL DESIGN AND CONSTRUCTION SHALL BE CARRIED OUT IN CONFORMANCE WITH CSA STANDARD 086.
- 2. SAWN LUMBER SHALL BE SPRUCE/PINE/FIR GRADE NUMBER 1 AND GRADE NUMBER 2 IN THE RATIO OF 67% (MINIMUM) AND 33% (MAXIMUM) RESPECTIVELY.
- 3. PROVIDE STEEL JOIST HANGERS AS SHOWN ON THE PLAN.
 FASTENING SHALL BE CARRIED OUT IN ACCORDANCE WITH THE
 MANUFACTURER'S SPECIFICATIONS. EACH HANGER SHALL BE
 CAPABLE OF SUPPORTING 8001bs.
- 4. PROVIDE TIMBER TRUSSES AND JOISTS FOR THE SIZES, SPANS, AND LOADS INDICATED ON THE DRAWINGS. DESIGN, INCLUDING BRIDGING, SHALL BE CARRIED OUT BY A REGISTERED PROFESSIONAL ENGINEER IN ACCORDANCE WITH CSA STANDARD 086-01 (R2006). BEARING SHOES FOR ALL MEMBERS SHALL BE DESIGNED FOR A MAXIMUM BEARING PRESSURE OF 1.1Mpa ON MASONRY.
- 5. ALL WOOD LINTELS OVER OPENINGS SHALL CONFORM TO THE ONTARIO BUILDING CODE. 2012 EDITION.
- 6. PROVIDE RIM JOISTS AROUND THE PERIMETER OF THE BUILDING AT THE TOP OF ALL STUD WALLS AND ANY JOIST/BEAM END—BEARING LOCATIONS. RIM JOISTS TO BE INSTALLED PER MANUFACTURERS REQUIREMENTS.
- 7. PROVIDE BLOCKING AT SUPPORT LOCATIONS FOR ALL JOISTS AND BEAMS AND AT THE MIDSPANS OF ALL JOISTS. BLOCKING IS TO BE PROVIDED ON TOP OF ALL LOAD—BEARING STUD WALLS SUPPORTING WALLS ABOVE. BLOCKING TO BE INSTALLED PER MANUFACTURERS REQUIREMENTS.
- 8. PROVIDE SQUASH BLOCKS BENEATH ALL BUILT—UP COLUMNS AND JAMBS AND WHERE REQUIRED AT RIM JOISTS. SQUASH BLOCKS TO BE INSTALLED PER MANUFACTURERS REQUIREMENTS.
- 9. DOUBLE TOP PLATES ARE TO BE PROVIDED ON ALL LOAD—BEARING STUD WALLS AND ON ANY CONCRETE OR BLOCK WALLS SUPPORTING WOOD JOISTS, BEAMS OR STUD WALLS.
- 10. PROVIDE MOISTURE BARRIER AROUND ALL WOOD MEMBERS IN DIRECT CONTACT WITH CONCRETE OR BLOCK. CONTINUOUS MOISTURE BARRIER IS REQUIRED AT POINTS OF CONTACT.
- 11. PROVIDE SOLID BLOCKING AND SIMPSON STRONG TIE (SST) SCW AROUND ALL STEEL COLUMNS.
- 12. ALL WALLS ARE TO BE LATERALLY SUPPORTED DURING CONSTRUCTION.
- 13. ALL TIMBER EXPOSED TO EXTERIOR SHALL BE PRESSURE TREATED

CLEAR SPAN	2"x4" STUD WALL	CLEAR SPAN	2"x6" STUD WALL
UP to 3'-0"	2 - 2" x 6"	UP to 5'-0"	3 - 2" x 6"
3'-0" to 5'-0"	2 - 2" x 8"	5'-0" to 6'-6"	3 - 2" x 8"
5'-0" to 6'-0"	2 - 2" x 10"	6'-6" to 7'-10"	3 - 2" x 10"
6'-0" to 7'-0"	2 - 2" x 12"	7'-10" to 9'-0"	3 - 2" x 12"

TYP, TIMBER LINTEL DETAIL

NOT TO SCALE

SUBMITTALS

- 1. SUBMIT FOR REVIEW BY THE CONSULTANT, DETAILED SHOP DRAWINGS FOR ALL STRUCTURAL WORK INCLUDING, BUT NOT LIMITED TO: CONCRETE FORMWORK, REINFORCING STEEL, STRUCTURAL STEEL.
- 2. THE SCALE OF THE DRAWINGS SHALL BE SUCH THAT THE DETAILS OF THE STRUCTURAL WORK ARE CLEARLY SHOWN, AND IN NO CASE SMALLER THAN $\frac{1}{4}$ "=1'-0" (1:50).
- 3. THE STRUCTURAL DRAWINGS SHALL NOT BE REPRODUCED, IN WHOLE OR IN PART, FOR USE AS SHOP DRAWINGS.
- 4. EACH DRAWING SUBMITTED FOR CONCRETE FORMWORK, STRUCTURAL STEEL AND TEMPORARY SHORING SHALL BEAR THE SEAL AND SIGNATURE OF A QUALIFIED PROFESSIONAL ENGINEER LICENSED IN THE PROVINCE OF ONTARIO.
- 5. CONTRACTOR SHALL ALLOW FOR A 5 WORKING DAY TURN AROUND TIME FOR STRUCTURAL CONSULTANT TO REVIEW THE SHOP DRAWINGS.

CALCULATIONS

1. SUBMIT CALCULATIONS, BEARING THE SEAL AND SIGNATURE OF PROFESSIONAL ENGINEER LICENSED IN THE PROVINCE OF ONTARIO, FOR STRUCTURAL WORK, IF REQUESTED BY THE CONSULTANT.

STRUCTURAL STEEL NOTES

- 1. ALL STRUCTURAL STEEL ELEMENTS, INCLUDING DESIGN OF ELEMENTS AND CONNECTIONS SHALL BE IN ACCORDANCE WITH CAN/CSA S16.
- 2. ALL STRUCTURAL STEEL SHALL CONFORM TO CSA G40.21 (300W).

 EXCEPT W SECTIONS AND PLATES G40.21 (350W), HSS

 MEMBERS G40.21 (350W) CLASS C OR ASTM A500 GRADE C,

 ANCHOR BOLTS ASTM A307, COLD FORM SECTIONS ASTM A570M

 GRADE 350W. UNLESS OTHERWISE NOTED, ALL SECTIONS SHALL

 BE PRIME PAINTED WITH THE SURFACE PREPARATION AND

 PAINTING PROCEDURES IN ACCORDANCE WITH CAN/CGSB 85.10.
- 3. ALL WELDING SHALL BE CARRIED OUT IN ACCORDANCE WITH CAN/CSA W59. THE STEEL FABRICATOR SHALL BE FULLY QUALIFIED UNDER THE REQUIREMENTS BY THE CANADIAN WELDING BUREAU IN CONFORMANCE WITH CAN/CSA W47.1.
- 4. DESIGN ALL MOMENT AND SHEAR CONNECTIONS FOR THE FULL CAPACITY OF THE SMALLER MEMBER IN THE CONNECTION UNLESS OTHERWISE NOTED.
- 5. PROVIDE MINIMUM BEARING LENGTH OF STEEL MEMBERS AS FOLLOWS:
 - ON MASONRY 6"
 - ON STEEL 4"
- 6. ALL BOLTS SHALL BE TIGHTENED WITH A SUITABLE TORQUE WRENCH IN ACCORDANCE WITH CSA S16.
- 7. ERECT STRUCTURAL STEEL IN ACCORDANCE WITH CSA S16 AND IN CONFORMANCE WITH THE APPROVED SHOP DRAWINGS.



		and opposite		
2	20/02/25	REVISED PER BUILDING PERMIT COMMENT		
1	19/06/17	ISSUED FOR BUILDING PERMIT		
No.	DATE	REVISION		
REVISIONS				



300 YORK BLVD HAMILTON, ONTARIO L8R 3K6 905-333-9119

STORAGE BUILDING

3659 UPPER JAMES ST.

HAMILTON

ONTARIO

TYPICAL NOTES

DATE	DRAWN BY	DRAWING No.
IUNE 2019	SYN	11
PROJECT No.	CHECKED BY	of 11
19001	HAPH	l''