COMMITTEE OF ADJUSTMENT



City Hall, 5th floor, 71 Main Street West, Hamilton, ON L8P 4Y5
Telephone (905) 546-2424, ext. 4221, 3935 Fax (905) 546-4202

E-mail: cofa@hamilton.ca

NOTICE OF PUBLIC HEARING Minor Variance

You are receiving this notice because you are either:

- Assessed owner of a property located within 60 metres of the subject property
- · Applicant/agent on file, or
- Person likely to be interested in this application

APPLICATION NO.:

HM/A-20:119

APPLICANTS:

Owner: Linda Yuk Ning Chick Agent: Fung Ying Carol Tsang

SUBJECT PROPERTY:

Municipal address 352 Beach Blvd., Hamilton

ZONING BY-LAW:

Zoning By-law 05-200, as Amended by By-law 19-062

ZONING:

C1 district (Residential Character Commercial)

PROPOSAL:

To permit the construction of a new single detached dwelling

notwithstanding that;

- 1. A maximum yard of 12.0m shall be permitted from the Beach Blvd street line and maximum yard of 39.43m shall be permitted from the QEW street line instead of the maximum 3.0m yard abutting a street permitted.
- 2. A minimum parking space size width of 2.7m shall be permitted instead of the minimum 3.0m parking space size width required.
- 3. Tandem/stacked parking may be permitted for single detached dwelling for a maximum of two (2) parking spaces whereas tandem parking is not permitted for single detached dwellings.
- 4. The minimum required 6.0m wide manoeuvring aisle for the two (2) parking spaces located within the private garage may be obstructed by another vehicle whereas the By-law requires an unobstructed 6.0m wide manoeuvring aisle for each parking space.

Notes:

The lands are subject to Site Plan Control DAB-20-068; however, this application is currently under review. Please note, further variances may be required at such time that a full zoning review is conducted on the proposal.

The applicant requested a variance to Hamilton Zoning By-law 6593; however, these lands are now under Hamilton Zoning By-law 05-200 and the requested variance is no longer applicable.

The Zoning By-law requires a minimum side yard of 1.5m. The north side yard dimension has not been measured to the nearest part of the building. Therefore, further variances may be required.

HM/A-20:119 Page 2

Where the driveway is provided in the front yard all other portions of the front yard shall be landscaped area. Insufficient details were provided from which to determine compliance; as such, further variances may be required.

The applicant shall ensure that the parking spaces and the driveways are maintained with a stable surface such as asphalt, concrete or other hard-surfaced material, crushed stone or gravel, and shall be maintained in a dust free condition; otherwise, further variances will be required.

This application will be heard by the Committee as shown below:

DATE:

Thursday, August 6th, 2020

TIME:

3:05 p.m.

PLACE:

Via video link or call in (see attached sheet for

details)

To be streamed at www.hamilton.ca/committeeofadjustment

for viewing purposes only

PUBLIC INPUT

Written: If you would like to submit written comments to the Committee of Adjustment you may do so via email or hardcopy. Please see attached page for complete instructions, including deadlines for submitting to be seen by the Committee.

Orally: If you would like to speak to this item at the hearing you may do so via video link or by calling in. Please see attached page for complete instructions, including deadlines for registering to participate.

MORE INFORMATION


For more information on this matter, including access to drawings illustrating this request:


- Visit <u>www.hamilton.ca/committeeofadjustment</u>
- Call 905-546-CITY (2489) or 905-546-2424 extension 4221, 4130, or 3935
- Email Committee of Adjustment staff at cofa@hamilton.ca


DATED: July 21, 2020.

Jamila Sheffield, Secretary-Treasurer Committee of Adjustment

Information respecting this application is being collected under the authority of the Planning Act, R.S.O., 1990, c. P. 13. All comments and opinions submitted to the City of Hamilton on this matter, including the name, address, and contact information of persons submitting comments and/or opinions, will become part of the public record and will be made available to the Applicant and the general public.

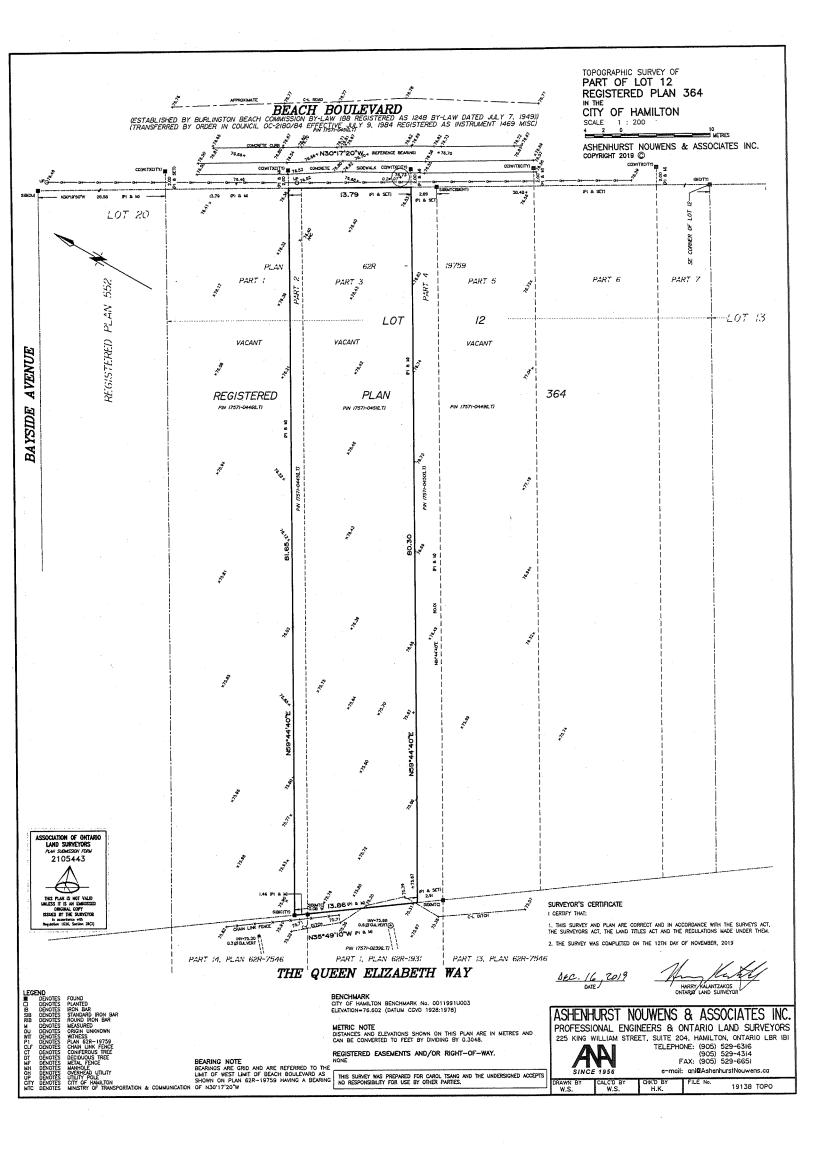

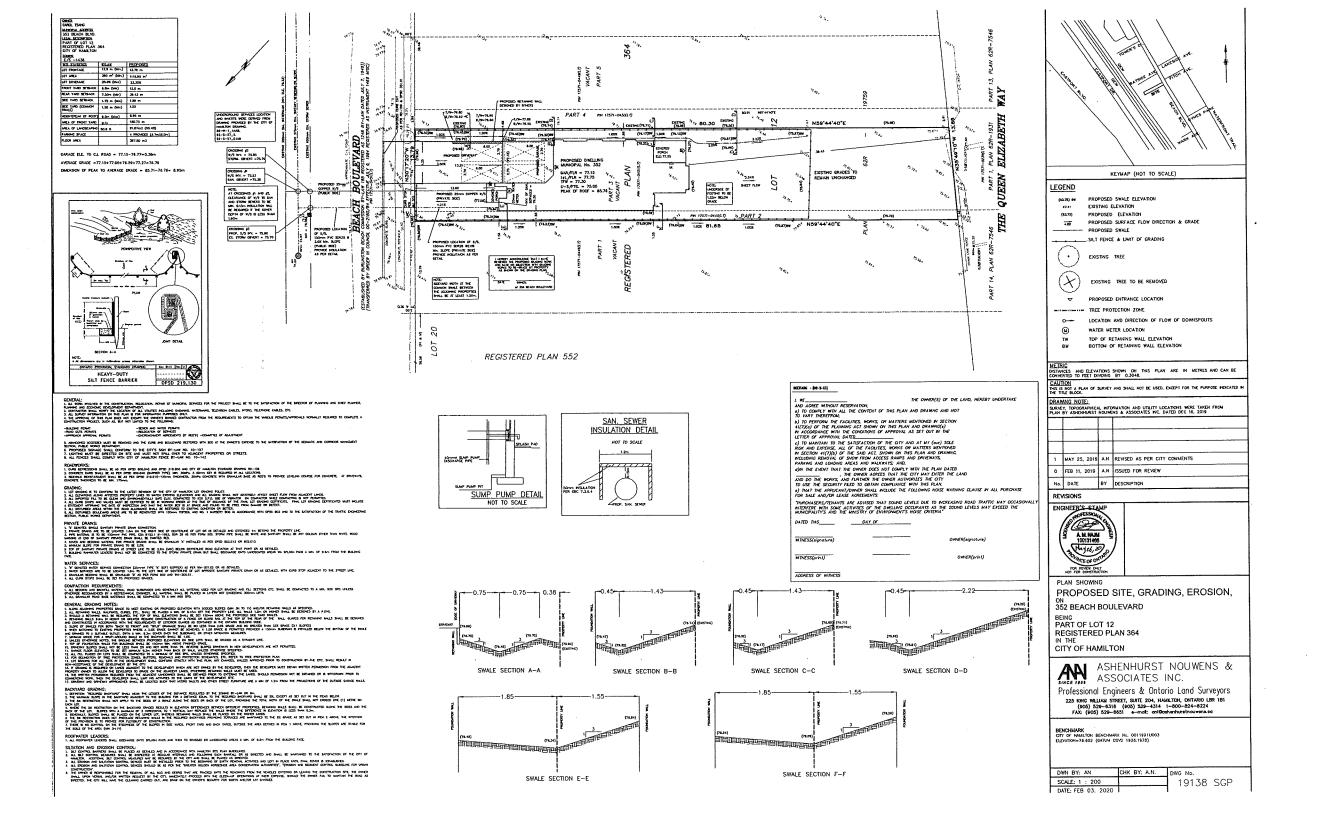

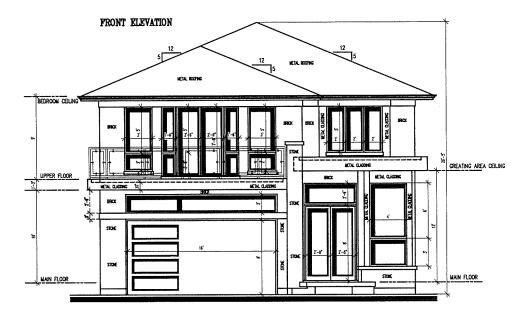

ASIGNARIS NOURIS & ASSOCIATES INC.
REGISSION, BENGES & ORIHAD LING SURFICES
225 FOR WILLIAM STREET
125 FOR WILLIAM STREET
125 SINCE 1956
SINCE 1956
LOCAL STREET
FAX(905) 252—431
FAX(905) 253—431

GENERAL NOTES:

- GENERAL NOTES:

 1. AL COSSIBLTION SOUL CONFORM TO THE GLE.
 AND LOCA, AUTHORITY HANGE JRESCHOOL.
 AND LOCA, AUTHORITY HANGE JRESCHOOL.
 200 HOT SALL CORNANCE, CORNECTION RESIDENCY.
 WEREY ALL DELEGOES FORCE TO COMBINION.
 STRUCT REAL BULLES WITED ORDERING.
 ALL WOOD LIBERES TO BE CONSTRUCTION
 SPRICE REAL BULLES WITED ORDERING.
 AND POLLINE JOSTS MORD HAN PAPALLE.
 PARTICULAR
 AND POLLINE COST HORD HANGE.
 AND POLLINE GUTS HANGE HANGE HANGE
 HEAVING THE AUTHORITY OF THE GUTS.
 BEATHER TO FORTED HIRT TO CONTROL
 TO SECTION 12.23 OF THE GULC.
 BESSTANCE TO FORTED HIRT TO CONTROL
 TO SECTION 12.23 OF THE GULC.
 BESSTANCE TO FORTED HIRT TO CONTROL
 TO SECTION 12.25 OF THE GULC.
 THE PAPAL TO THE SECTION 12.25 OF THE GULC.
 A JUT THOSE OF THE TO CONTROL
 TO THE SECTION 12.25 OF THE GUTS HAVE THE SECTION 12.


TO PERFORM ACTUAL CONSTRUCTION THE BAILDER SHALL USE SET OF DRAWNES SEALED — THEREFORE APPROYED — BY THE LOCAL BUILDING DEPARTMENT

PROPOSED RESIDENCE 352 BEACH BOULEVARD HAMILTON, Ontario

ELEVATION

DATE:	MAY 14, 2020
SCALE:	1/4"=1'-0"
DWG BY:	M.T.
FILE:	19138
S M. TRKULIA	DWG No.
M. TRKULIA	5 of 8

NOT ISSUED FOR CONSTRUCTION UNTIL SIGNED AND DATED

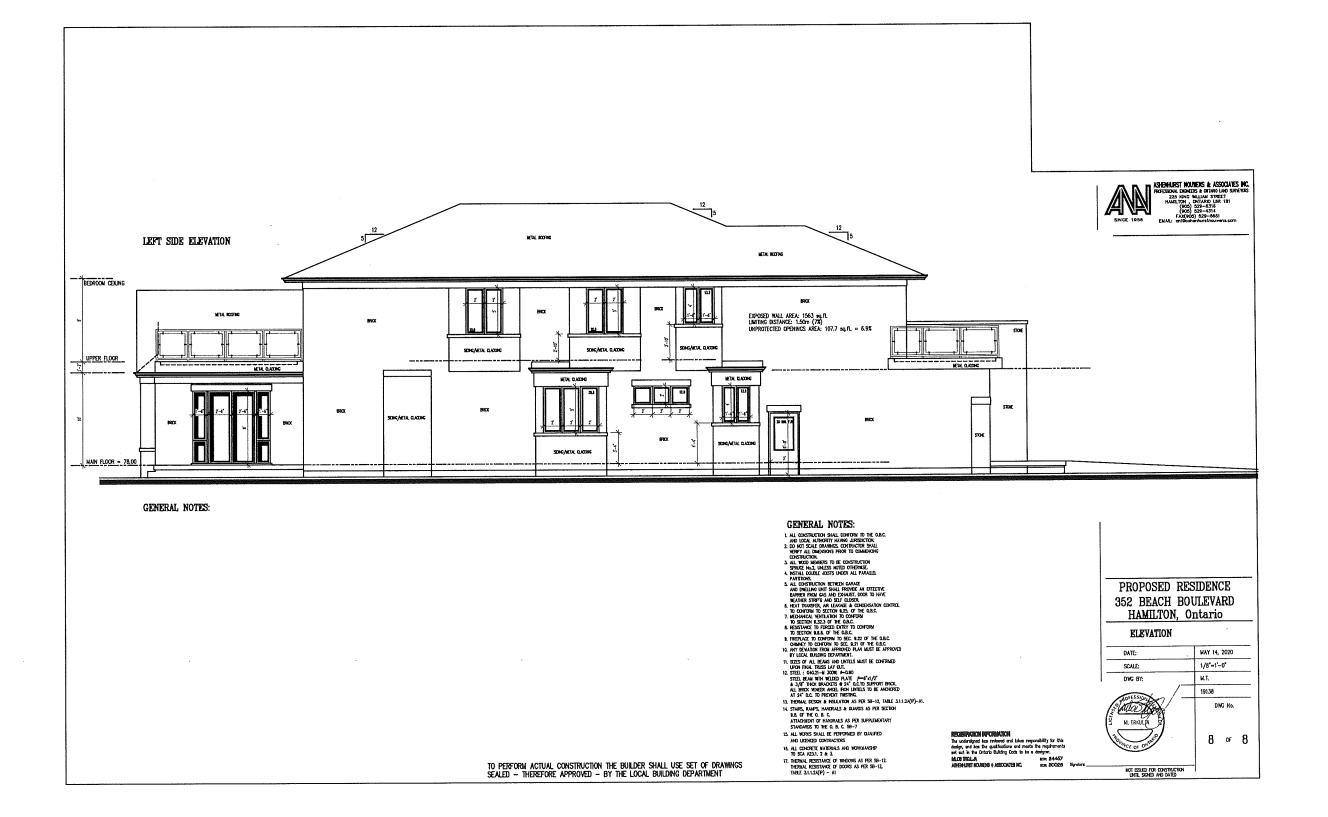



Planning and Economic Development Department Planning Division

Committee of Adjustment

City Hall 5th floor 71 Main Street West Hamilton, Ontario L8P 4Y5

Phone (905) 546-2424 ext.4221 Fax (905) 546-4202


PLEASE FILL OUT THE FOLLOWING PAGES AND RETURN TO THE CITY OF HAMILTON PLANNING DEPARTMENT.


FOR OFFICE USE ONLY.	
APPLICATION NO DATE APPLICATION RECEIVED	
PAID DATE APPLICATION DEEMED COMPLETE	
SECRETARY'S SIGNATURE	
CITY OF HAMILTON COMMITTEE OF ADJUSTMENT HAMILTON, ONTARIO	
The Planning Act	
Application for Minor Variance or for Permission	
The undersigned hereby applies to the Committee of Adjustment for the City of Hamilton under Section 45 of the <i>Planning Act</i> , R.S.O. 1990, Chapter P.13 for relief, as described in this application, from the Zoning By-law. 1. Name of Owner Chicks Linda Yuk Ning Telephone No. 2. Name of Agent Isang, Fung ling Casel Telephone No.	
4.	
Note: Unless otherwise requested all communications will be sent to the agent, if any.	
Names and addresses of any mortgagees, holders of charges or other encumbrances:	
Postal Code	

	apply for the forth parking spot
	Why it is not possible to comply with the provisions of the By-law? according to the zoning by-law-6593 Jun 13. 2019 section and the comments from the city for our building permit. We need C.O.A. to approve the forth
	permit. We rood C.O.A. to approve the forth parking space. Attached the 2-mail from the builing permit derision for ref. Legal description of subject lands (registered plan number and lot number or other
	Legal description of subject lands (registered plan number and lot number of other legal description and where applicable, street and street number): Advess: 352 Beach Blvd Hamilton L8H 6W5 Part of Lot 12. Plan 364. part 2 and part 3 Reference Plan No. 62R-19759
	PREVIOUS USE OF PROPERTY
	Residential Industrial Commercial
	Agricultural Vacant
	Other
	If Industrial or Commercial, specify use
	Has the grading of the subject land been changed by adding earth or other material, i.e. has filling occurred?
	Yes No Unknown \(\sqrt{} \)
	Has a gas station been located on the subject land or adjacent lands at any time? Yes No Unknown
	Has there been petroleum or other fuel stored on the subject land or adjacent
	Yes No Unknown
	Are there or have there ever been underground storage tanks or buried waste on the subject land or adjacent lands?
	Yes No Unknown
	Have the lands or adjacent lands ever been used as an agricultural operation where cyanide products may have been used as pesticides and/or sewage sludge was applied to the lands?
	Yes No Unknown
	Have the lands or adjacent lands ever been used as a weapon firing range?
	Yes No Unknown
,	Is the nearest boundary line of the application within 500 metres (1,640 feet) of the fill area of an operational/non-operational landfill or dump?
	Yes No Unknown

9.9	remaining on site which are potentially hazardous to public health (eg. asbestos, PCB's)?
	Yes No _V Unknown
9.10	Is there any reason to believe the subject land may have been contaminated by former uses on the site or adjacent sites? Yes No Unknown
9.11	What information did you use to determine the answers to 9.1 to 9.10 above?
	The subject property is a
0	Vacent land
9.12	If previous use of property is industrial or commercial or if YES to any of 9.2 to 9.10, a previous use inventory showing all former uses of the subject land, or if appropriate, the land adjacent to the subject land, is needed. Is the previous use inventory attached? Yes No
l ackr reme reaso	NOWLEDGEMENT CLAUSE nowledge that the City of Hamilton is not responsible for the identification and diation of contamination on the property which is the subject of this Application – by on of its approval to this Application.
Date	Signature Property Owner /
Date	Chick, Linda Yuk-Ning Print Name of Owner
10.	Dimensions of lands affected:
	Depth 13.79 m Left 80-30 m. right 81.65 m Area 1116.65 m
	Depth Left for som. Fight 81.65m
	Width of street
11.	Particulars of all buildings and structures on or proposed for the subject lands: (Specify ground floor area, gross floor area, number of stories, width, length, height, etc.)
	Existing: The subject land is a vacant land
	Proposed: to build a two storey single family dwelling
12.	Location of all buildings and structures on or proposed for the subject lands; (Specify distance from side, rear and front lot lines)
	The subject land is a vacant land

72 77	
	11
Date of acquisition of subject lands:	ver 11.2019
Date of construction of all buildings and structures o	n subject lands:
vill apply building permin	t upon approval from
Existing uses of the subject property:	
Vacant land	
Existing uses of abutting properties:	
Vacant land	
Length of time the existing uses of the subject propo	erty have continued:
unknown	
Municipal services available: (check the appropriate	
7700	onnected
	onnected
Storm Sewers	
Present Official Plan/Secondary Plan provisions ap	
Not available	
Present Restricted Area By-law (Zoning By-law) pro	
Not available	
1 VOC MUM LUDGE	7.21
	* A
Has the owner previously applied for relief in respe-	ct of the subject property?
Has the owner previously applied for relief in respec	* A
Has the owner previously applied for relief in respe-	ct of the subject property?
Has the owner previously applied for relief in respec	ct of the subject property?
Has the owner previously applied for relief in respec	ct of the subject property?
Has the owner previously applied for relief in respec	ct of the subject property?
Has the owner previously applied for relief in respectives Yes If the answer is yes, describe briefly.	ct of the subject property?
Has the owner previously applied for relief in respec	ct of the subject property?
Has the owner previously applied for relief in respectives Yes If the answer is yes, describe briefly. Is the subject property the subject of a current applied.	ct of the subject property?
Has the owner previously applied for relief in respectives Yes If the answer is yes, describe briefly. Is the subject property the subject of a current apple 53 of the Planning Act? Yes The applicant shall attach to each copy of this apple.	ication for consent under Section
Has the owner previously applied for relief in respectives Yes If the answer is yes, describe briefly. Is the subject property the subject of a current apple 53 of the Planning Act? Yes The applicant shall attach to each copy of this apple dimensions of the subject lands and of all abutting	ication for consent under Section No No No Ication a plan showing the lands and showing the location,
Has the owner previously applied for relief in respectives Yes If the answer is yes, describe briefly. Is the subject property the subject of a current apple 53 of the Planning Act? Yes The applicant shall attach to each copy of this apple dimensions of the subject lands and of all abutting size and type of all buildings and structures on the	ication for consent under Section No No ication a plan showing the lands and showing the location, subject and abutting lands, and
Has the owner previously applied for relief in respectives Yes If the answer is yes, describe briefly. Is the subject property the subject of a current apple 53 of the Planning Act? Yes The applicant shall attach to each copy of this apple dimensions of the subject lands and of all abutting	ication for consent under Section No No ication a plan showing the lands and showing the location, subject and abutting lands, and

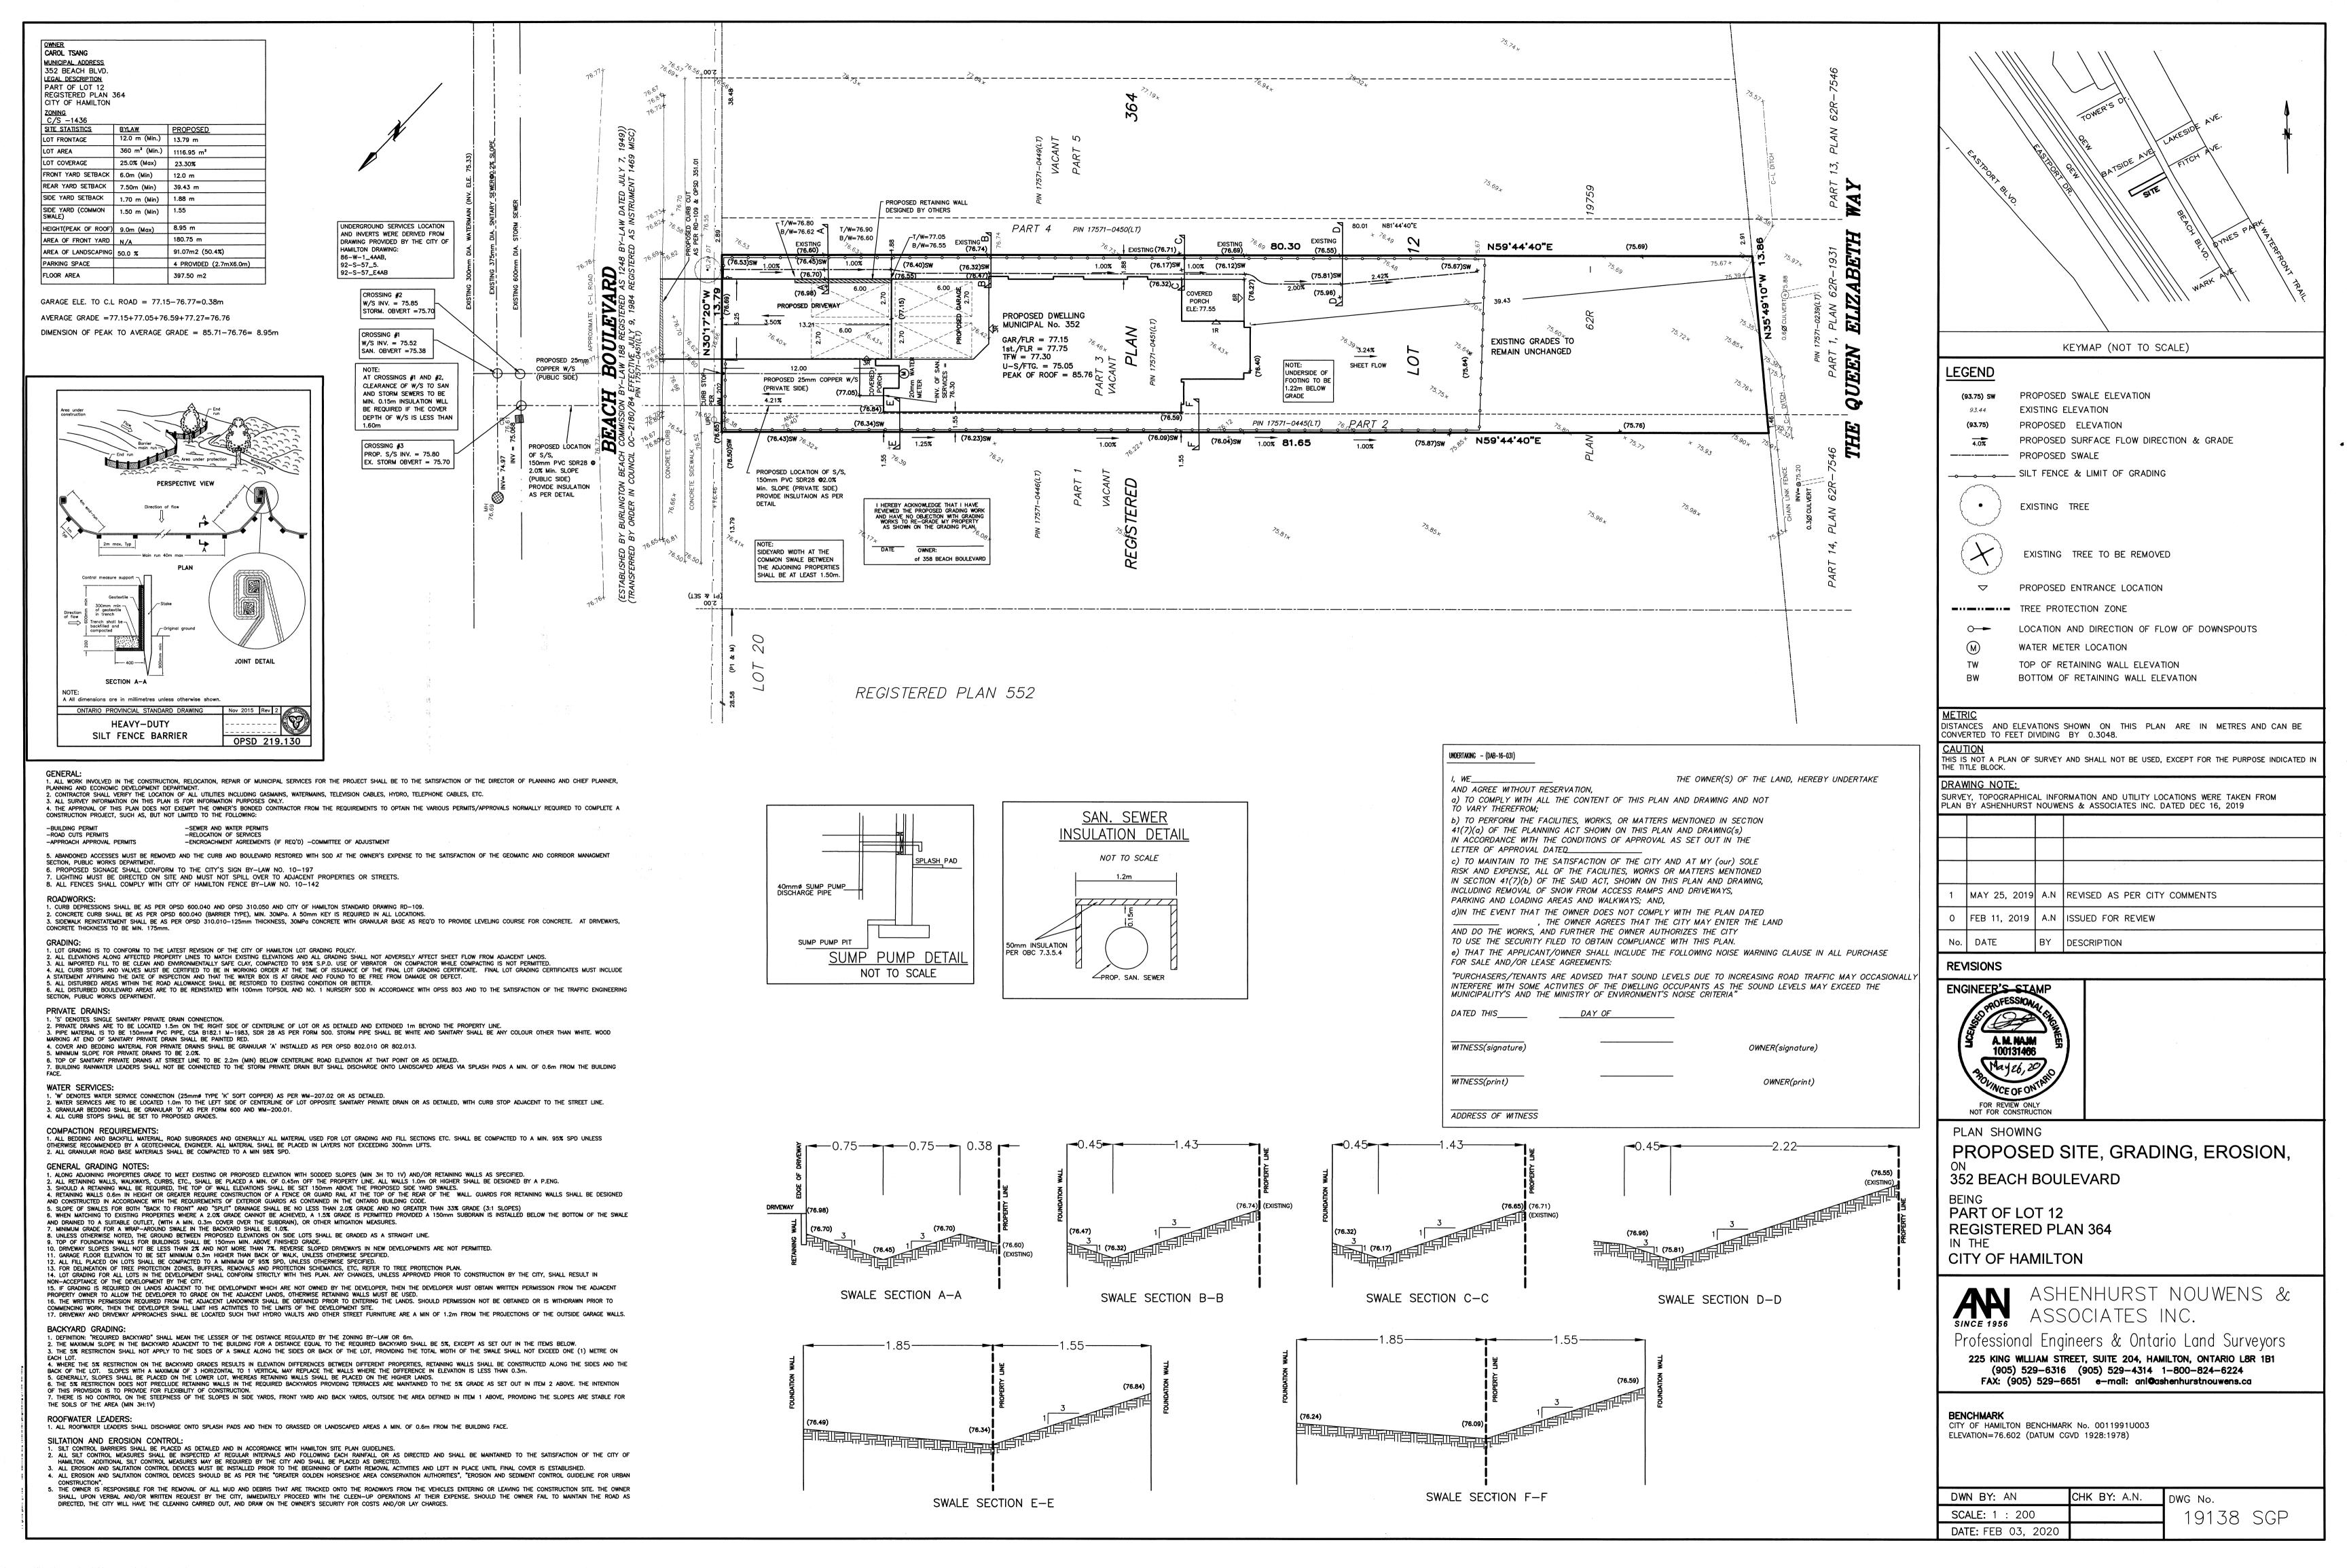

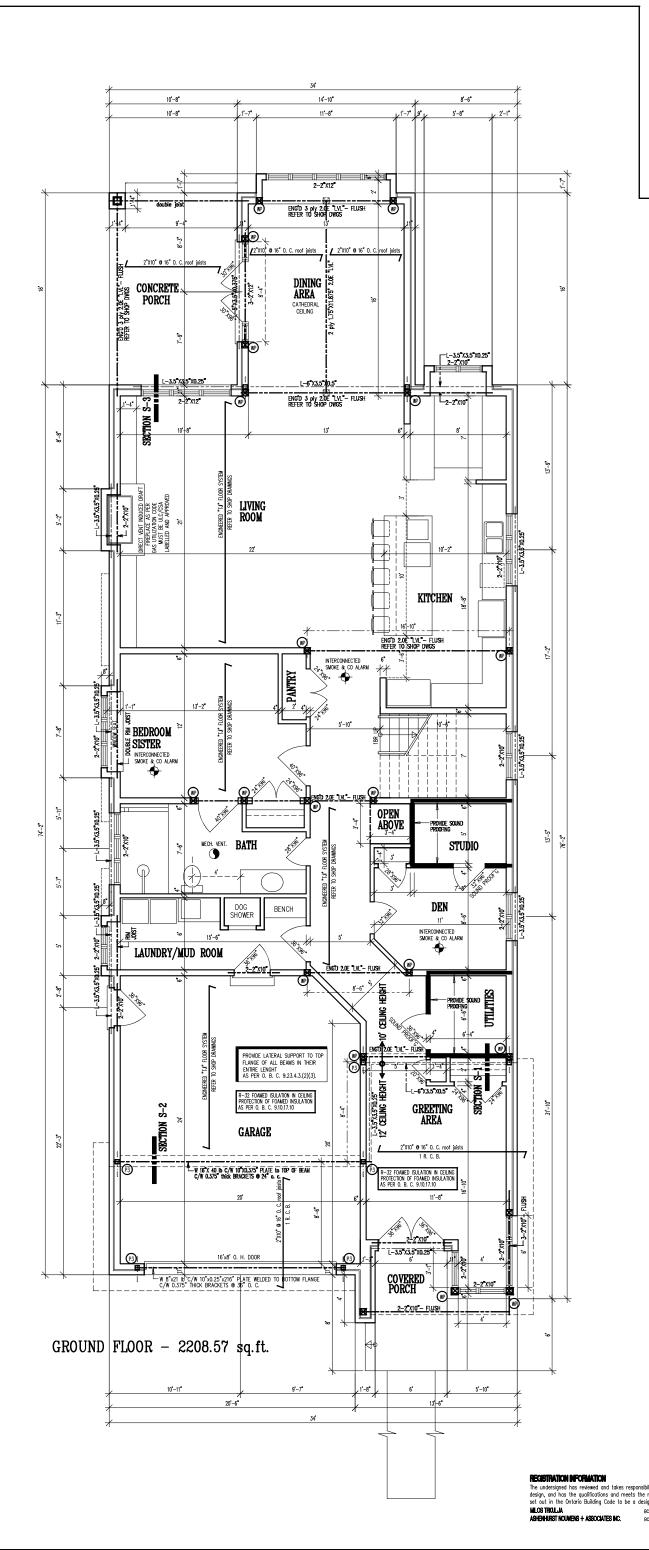

ASHENHURST NOUWENS & ASSOCIATES INC.

PROFESSIONAL ENGINEERS & ONTARIO LAND SUF 225 KING WILLIAM STREET HAMILTON, ONTARIO LBR 1B1 (905) 529-6316 (905) 529-4314 FAX(905) 529-6551 EMAIL: ani@ashenhurstnouwens.com

- GENERAL NOTES:

E SET OF DRAWINGS DEPARTMENT

SHALL USE

N THE BUILDER SI BY THE LOCAL I

. CONSTRUCTION 1 E APPROVED - B

TO PERFORM ACTUAL (SEALED - THEREFORE

- GENERAL NOTES:

 1. ALL CONSTRUCTION SHALL CONFORM TO THE O.B.C. AND LOCAL AUTHORITY HAVING JURISDICTION.

 2. DO NOT SCALE DRAWINGS, CONTRACTOR SHALL VERIFY ALL DIMENSIONS PRIOR TO COMMENCING CONSTRUCTION.

 3. ALL WOOD MERGES TO BE CONSTRUCTION SPACE.

 4. INSTALL DOUBLE, JOSTS UNDER ALL PARALLEL PARTITIONS.

 5. ALL CONSTRUCTION BETWEEN GARAGE AND EMELING UNITS HALL PROVIDE AN EFFECTIVE BARRIER FROM GAS AND EXHAUST, DOOR TO HAVE WEATHER STIPP'S AND SELF CLOSER.

 6. HEAT TRANSFER, AR LEAKAGE & CONDENSATION CONTROL.

 7. OCHOPMEN TO SECTION 9.2.5. OF THE O.B.C.

 7. MECHANICAL VENITALIATION TO CONFORM TO SECTION 9.2.3. OF THE O.B.C.

 9. FIREPLACE TO CONFORM TO SECTION 5.C. 2.1 OF THE O.B.C.

 CHINNEY TO CONFORM TO SEC. 9.2 OF THE O.B.C.

 10. ANY DEVIATION FROM APPROVED PLAN MUST BE APPROVED BY DICAL BUILDING DEPARTMENT.

 11. SIZES OF ALL BEAMS AND LINIES MUST BE CONFIRMED UPON FINAL TRUSS LAY OUT.

 12. STEEL F. COLZI—M 300M; #=0.90

 STEEL BEAM WITH WELDED PLAT F. 6"X1/2"

 & 3/8" THINCK BRACKETS B 2.4" O.C.TO SUPPORT BRICK, ALL BRICK VENERE ANGEL RON LINISLIST DEE ANCHORED AT 7.4" O.C. TO PREVENT TWISTING.

 13. THERMAL DESIGN & INSULATION SPER SB-12, TABLE 3.1.1.

 **STARS PARKED SHAMPS AND MINISLIST ON SPER SB-12, TABLE 3.1.1.

 **STARS PARKED SHAMPS AND MINISLIST ON SPER SB-12, TABLE 3.1.1.

 **STARS PARKED SHAMPS AND MINISLISTION SPER SB-12, TABLE 3.1.1.

 **STARS PARKED SHAMPS AND MINISLISTION SPER SB-12, TABLE 3.1.1.

 **STARS PARKED SHAMPS AND MINISLATION SPER SB-12, TABLE 3.1.1.

 **STARS PARKED SHAMPS AND MINISLATION SPER SB-12, TABLE 3.1.1.

 **STARS PARKED SHAMPS AND MINISLATION SPER SB-12, TABLE 3.1.1.

 **STARS PARKED SHAMPS AND MINISLATION SPER SB-12, TABLE 3.1.1.

 **STARS PARKED SHAMPS AND MINISLATION SPER SB-12, TABLE 3.1.1.

 **STARS PARKED SHAMPS AND MINISLATION SPER SB-12, TABLE 3.1.1.

 **STARS PARKED SHAMPS AND MINISLATION SPER SB-12, TABLE 3.1.1.

 **STARS PARKED SHAMPS AND MINISLATION SPER SB-12, TABLE 3.1.1.
- A 124 O.C. TO PREVENT IMISSING.

 3. THERMAL DESIGN & INSULATION AS PER SB-12, TABLE 3.1.1.2A(IP)-A1.

 14. STAIRS, RAMPS, HANDRAILS & GUARDS AS PER SECTION

 9.8. OF THE O. B. C.
 ATTACHMENT OF HANDRAILS AS PER SUPPLEMENTARY

 STANDARDS TO THE O. B. C. SB-7

 15. ALL WORKS SHALL BE PERFORMED BY QUALIFIED

 AND LICENSEY CONTRACTIONS
- AND LICENCED CONTRACTORS
- 16. ALL CONCRETE MATERIALS AND WORKMANSHIP TO SCA A23.1, 2 & 3.
- 17. THERMAL RESISTANCE OF WINDOWS AS PER SB-12.
 THERMAL RESISTANCE OF DOORS AS PER SB-12,
 TABLE 3.1.1.2A(IP) A1

WP 3-2"X6" WOOD POST ONTO 6 MIL POLY DAMP-PROOFING INTO "SIMPSON STRONG TIE" SADDLE.

(P3) HSS-4"x4"x0.25" C/W 6"x4"x0.375 TOP PLATE & 8"x4"x0.375" BOTTOM PLATE ANCHORED INTO FOUNDATION WALL WITH 2 0.5 dia "HILTI" BOLTS


PROPOSED RESIDENCE 352 BEACH BOULEVARD HAMILTON, Ontario

FLOOR PLAN

DATE:	MAY 14, 2020
SCALE:	1/8"=1'-0"
DWG BY:	M.T.
FILE:	19138
	DWC No.



2 OF 8

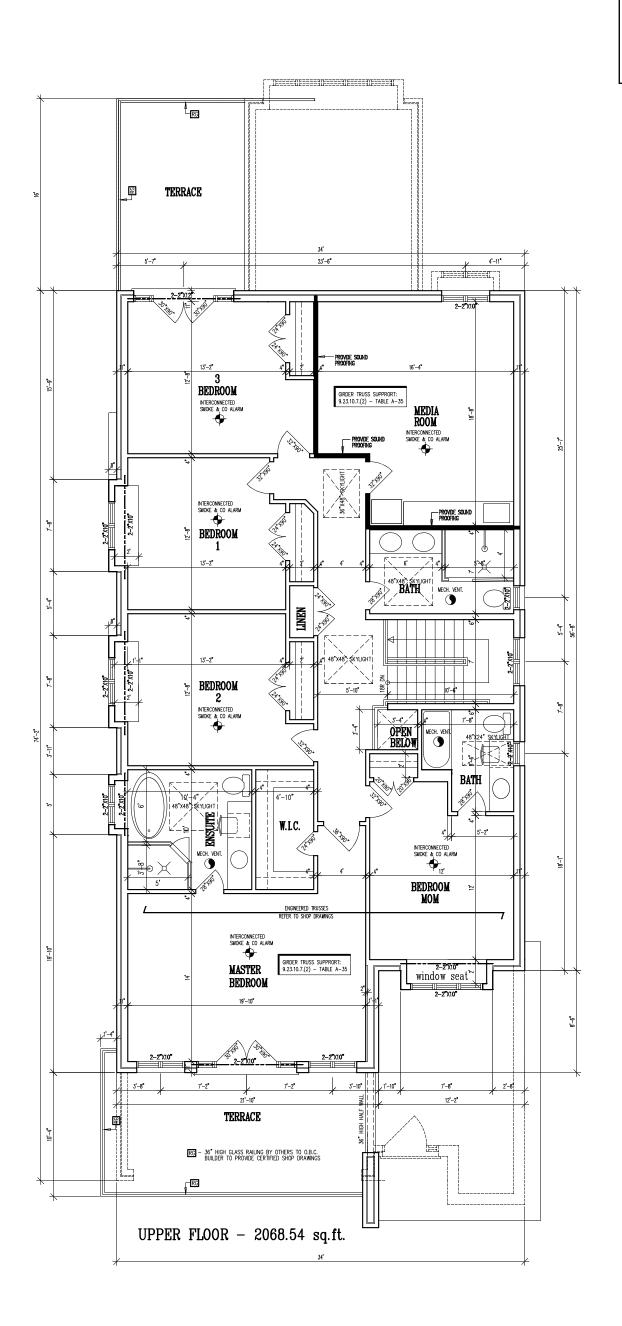



ASHENHURST NOUWENS & ASSOCIATES INC.

PROFESSIONAL ENGINEERS & ONTARIO LAND SUR 225 KING WILLIAM STREET HAMILTON, ONTARIO LBR 1B1 (905) 529-6316 (905) 529-4314 FAX(905) 529-6651 EMAIL: ani@ashenhurstnouwens.com

GENERAL NOTES:

SE SET OF DRAWINGS 3 DEPARTMENT

SHALL USE :

N THE BUILDER SI BY THE LOCAL I

TO PERFORM ACTUAL CONSTRUCTION SEALED — THEREFORE APPROVED — I

- GENERAL NOTES:

 1. ALL CONSTRUCTION SHALL CONFORM TO THE O.B.C. AND LOCAL AUTHORITY HAVING JURISDICTION.

 2. DO NOT SCALE DRAWINGS. CONTRACTOR SHALL VERIFY ALL DIMENSIONS PRIOR TO COMMENCING CONSTRUCTION.

 3. ALL WOOD MEMBERS TO BE CONSTRUCTION.

 3. ALL WOOD MEMBERS TO BE CONSTRUCTION.

 5. ALL WOOD NEW STATES TO THE CONSTRUCTION SPRUCE. ALL CONSTRUCTION BETWEEN GARAGE.

 4. INSTALL DOUBLE JOISTS UNDER ALL PARALLEL PARTITIONS.

 5. ALL CONSTRUCTION BETWEEN GARAGE.

 AND EMELLING UNIT SHALL PROVIDE AN EFFECTIVE BARRIER FROM GAS AND EXHAUST. DOOR TO HAVE WATHER STRIPP AND DEF CLOSER.

 6. HEAT TRANSFER, AR LEAKAGE & CONDENSATION CONTROL.

 7. OCHOPMEN TO SECTION 2.5. OF THE O.B.C.

 7. MECHANICAL VENITIATION TO CONFORM TO SECTION 9.8.8. OF THE O.B.C.

 9. FIREPLACE TO CONFORM TO SEC. 9.2 OF THE O.B.C.

 CHINNEY TO CONFORM TO SEC. 9.2 OF THE O.B.C.

 10. ANY DEWALTON FROM APPROVED PLAN MUST BE APPROVED BY LOCAL BUILDING DEPARMENT.

 11. SIZES OF ALL BEAMS AND LINTELS MUST BE CONFIRMED UPON FINAL TRUSS LAY OUT.

 12. STEEL: GAD JEMIN SORD, #=-9.90

 STEEL BEAM WITH WELDED PLATE TO THIS IN THE STATE.

 13. THERMAL DESIGN & INSULATION SOR PER SECTION.

 14. STARRS RANGE HANDELLING AND FARS SPER SECTION.
- AT 24" O.C. TO PREVENT TWISTING.

 3. THERMAL DESIGN & INSULATION AS PER SB-12, TABLE 3.1.1.2A(IP)-A1.

 4. STAIRS, RAMPS, HANDRAILS & GUARDS AS PER SECTION

 9.8. OF THE O. B. C.
 ATTACHMENT OF HANDRAILS AS PER SUPPLEMENTARY
 STANDARDS TO THE O. B. C. SB-7

 15. ALL WORKS SHALL BE PERFORMED BY QUALIFIED

 AND LICENCED CONTRACTORS

 ALL CONTRACTORS
- 16. ALL CONCRETE MATERIALS AND WORKMANSHIP TO SCA A23.1, 2 & 3.
- 17. THERMAL RESISTANCE OF WINDOWS AS PER SB-12.
 THERMAL RESISTANCE OF DOORS AS PER SB-12,
 TABLE 3.1.1.2A(IP) A1

PROPOSED RESIDENCE 352 BEACH BOULEVARD HAMILTON, Ontario

FLOOR PLAN

DATE:	MAY 14, 2020
SCALE:	1/8"=1'-0"
DWG BY:	M.T.
FILE:	19138

3 OF 8



ASHEMHURST NOUWENS & ASSOCIATES INC.
PROFESSIONAL ENGINEERS & ONTARIO LAND SURVEYORS
225 KING WILLAM STREET
HAMILETOSOS 529—6318 F181
(905) 529—6314
FAX(905) 529—6651
EMAIL: ani@ashenhurstnouwens.com

GENERAL NOTES:

SHALL USE SET OF DRAWINGS L BUILDING DEPARTMENT

N THE BUILDER SI BY THE LOCAL I

TO PERFORM ACTUAL CONSTRUCTION SEALED - THEREFORE APPROVED - I

- GENERAL NOTES:

 1. ALL CONSTRUCTION SHALL CONFORM TO THE O.B.C.
 AND LOCAL AUTHORITY HANNG JURISDICTION.

 2. DO NOT SCALE DRAWINGS. CONTRACTOR SHALL
 VERIFY ALL DIMENSIONS PRORY TO COMMENCING
 CONSTRUCTION.

 3. ALL WOOD MEMBERS TO BE CONSTRUCTION
 SERVICE NO. 2. UNLESS NOTED OTHERWISE.

 4. INSTALL DOUBLE JUSTS UNDER ALL PRAFILEL
 PARTITIONS.

 5. ALL CONSTRUCTION BETWEEN GARAGE
 AND DWELLING UNIT SHALL PROVIDE AN EFFECTIVE
 BARRIER FROM GAS AND EAHURST, DOOR TO HAVE
 WEATHER STRIPFG AND SELF CLOSER.
 6. HEAT TRANSFER, ARL EAKAGE & CONDENSATION CONTROL
 TO CONFORM TO SECTION 9.25. OF THE O.B.C.
 7. MECHANICAL EVITILIATION TO CONFORM
 TO SECTION 9.23. OF THE O.B.C.
 CHINNEY TO CONFORM TO SEC. 9.22 OF THE O.B.C.
 CHINNEY TO CONFORM TO SEC. 9.22 OF THE O.B.C.
 CHINNEY TO SECOND T

- 16. ALL CONCRETE MATERIALS AND WORKMANSHIP TO SCA A23.1, 2 & 3.
- 17. THERMAL RESISTANCE OF WINDOWS AS PER SB-12.
 THERMAL RESISTANCE OF DOORS AS PER SB-12,
 TABLE 3.1.1.2A(P) A1

PROPOSED RESIDENCE 352 BEACH BOULEVARD HAMILTON, Ontario

ELEVATION

DATE:	MAY 14, 2020
SCALE:	1/4"=1'-0"
DWG BY:	M.T.
FILE:	19138
TOFESSIO.	DWG No.

M. TRKULJA

5 OF 8

REGISTRATION INFORMATION RECEITATION INFORMATION
The undersigned has reviewed and takes responsibility for this design, and has the qualifications and meets the requirements set out in the Chitario Building Code to be a designer.

MALOS TROLLA.

ASPENIAST NOUNCING + ASSOCIATES NC.

BOX: 30026

NOT ISSUED FOR CONSTRUCTION UNTIL SIGNED AND DATED



ASHEMHURST NOUWENS & ASSOCIATES INC.
PROFESSIONAL ENGINEERS & ONTARIO LAND SURVEYORS
225 KING WILLAM STREET
HAMILETOSOS 529—6318 F181
(905) 529—6314
FAX(905) 529—6651
EMAIL: ani@ashenhurstnouwens.com

GENERAL NOTES:

SHALL USE SET OF DRAWINGS L BUILDING DEPARTMENT

N THE BUILDER SI BY THE LOCAL I

TO PERFORM ACTUAL CONSTRUCTION SEALED - THEREFORE APPROVED - I

- GENERAL NOTES:

 1. ALL CONSTRUCTION SHALL CONFORM TO THE O.B.C.
 AND LOCAL AUTHORITY HAWING JURISDICTION.

 2. DI NOT SCALE BRANNOS. CONTRACTOR SHALL
 VERLY ALL DEMANDAS PRORE TO COMMENCING
 CONSTRUCTION.
 3. ALL WOOD EMBERS TO BE CONSTRUCTION
 SPRUCE NO.2, UNLESS NOTED OTHERWISE.
 4. INSTALL DOMELE JUSTS UNDER ALL PRAFILEL
 PARTITIONS.
 5. ALL CONSTRUCTION BETWEEN GRAAGE
 AND DWELLING UNIT SHALL PROVIDE AN EFFECTIVE
 BARRIER FROM GAS AND SEHD CLOSER.
 6. HEAT TRANSFER, AR LEAKAGE & CONDENSATION CONTROL
 TO CONFORM TO SECTION 9.25. OF THE O.B.C.
 7. MECHANICAL VENTILIATION TO CONFORM
 TO SECTION 9.25. OF THE O.B.C.
 8. RESISTANCAL VENTILIATION SEC. 9.22 OF THE O.B.C.
 CHINNEY TO CONFORM TO SEC. 9.22 OF THE O.B.C.
 CHINNEY TO CONFORM TO SEC. 9.22 OF THE O.B.C.
 CHINNEY TO CONFORM TO SEC. 9.22 OF THE O.B.C.
 CHINNEY TO CONFORM TO SEC. 9.22 OF THE O.B.C.
 CHINNEY TO CONFORM TO SEC. 9.22 OF THE O.B.C.
 CHINNEY TO CONFORM TO SEC. 9.22 OF THE O.B.C.
 CHINNEY TO CONFORM TO SEC. 9.22 OF THE O.B.C.
 CHINNEY TO CONFORM TO SEC. 9.22 OF THE O.B.C.
 CHINNEY TO CONFORM TO SEC. 9.21 OF THE O.B.C.
 CHINNEY TO CONFORM TO SEC. 9.22 OF THE O.B.C.
 CHINNEY TO CONFORM TO SEC. 9.22 OF THE O.B.C.
 CHINNEY TO CONFORM TO SEC. 9.21 OF THE O.B.C.
 CHINNEY TO CONFORM TO SEC. 9.21 OF THE O.B.C.
 CHINNEY TO CONFORM TO SEC. 9.21 OF THE O.B.C.
 CHINNEY TO CONFORM TO SEC. 9.21 OF THE O.B.C.
 CHINNEY TO CONFORM TO SEC. 9.21 OF THE O.B.C.
 CHINNEY TO CONFORM TO SEC. 9.21 OF THE O.B.C.
 CHINNEY TO CONFORM TO SEC. 9.22 OF THE O.B.C.
 CHINNEY TO CONFORM TO SEC. 9.21 OF THE O.B.C.
 CHINNEY TO CONFORM TO SEC. 9.21 OF THE O.B.C.
 CHINNEY TO CONFORM TO SEC. 9.22 OF THE O.B.C.
 CHINNEY TO CONFORM TO SEC. 9.22 OF THE O.B.C.
 CHINNEY TO CONFORM TO SEC. 9.21 OF THE O.B.C.
 CHINNEY TO CONFORM TO SEC. 9.22 OF THE O.B.C.
 CHINNEY TO CONFORM TO SEC. 9.22 OF THE O.B.C.
 CHINNEY TO CONFORM TO SEC. 9.22 OF THE O.B.C.
 CHINNEY TO CONFORM TO SEC. 9.22 OF THE O.B.C.
 CHINNEY TO CONFORM TO SEC. 9.22 OF THE O.B.C.
 CHINNEY TO SECTION 9.8.80 THE SECTION 9.80 OF THE SECTION 9.80 OF THE SECTION 9.80 OF THE SECTION
- 16. ALL CONCRETE MATERIALS AND WORKMANSHIP TO SCA A23.1, 2 & 3.
- 17. THERMAL RESISTANCE OF WINDOWS AS PER SB-12.
 THERMAL RESISTANCE OF DOORS AS PER SB-12,
 TABLE 3.1.1.2A(IP) A1

PROPOSED RESIDENCE 352 BEACH BOULEVARD HAMILTON, Ontario

ELEVATION

DATE:	MAY 14, 2020
SCALE:	1/4"=1'-0"
DWG BY:	M.T.
FILE:	19138
TOFESSIO	DWG No.

M. TRKULJA

6 OF 8


NOT ISSUED FOR CONSTRUCTION UNTIL SIGNED AND DATED

REGISTRATION INFORMATION The undersigned has reviewed and takes responsibility for this design, and has the qualifications and meets the requirements set out in the Ontario Building Code to be a designer.

MLOS TROLLIA BOWLENS + ASSOCIATES NC.

BOW 20457

ASPENHIST NOWENS + ASSOCIATES NC.

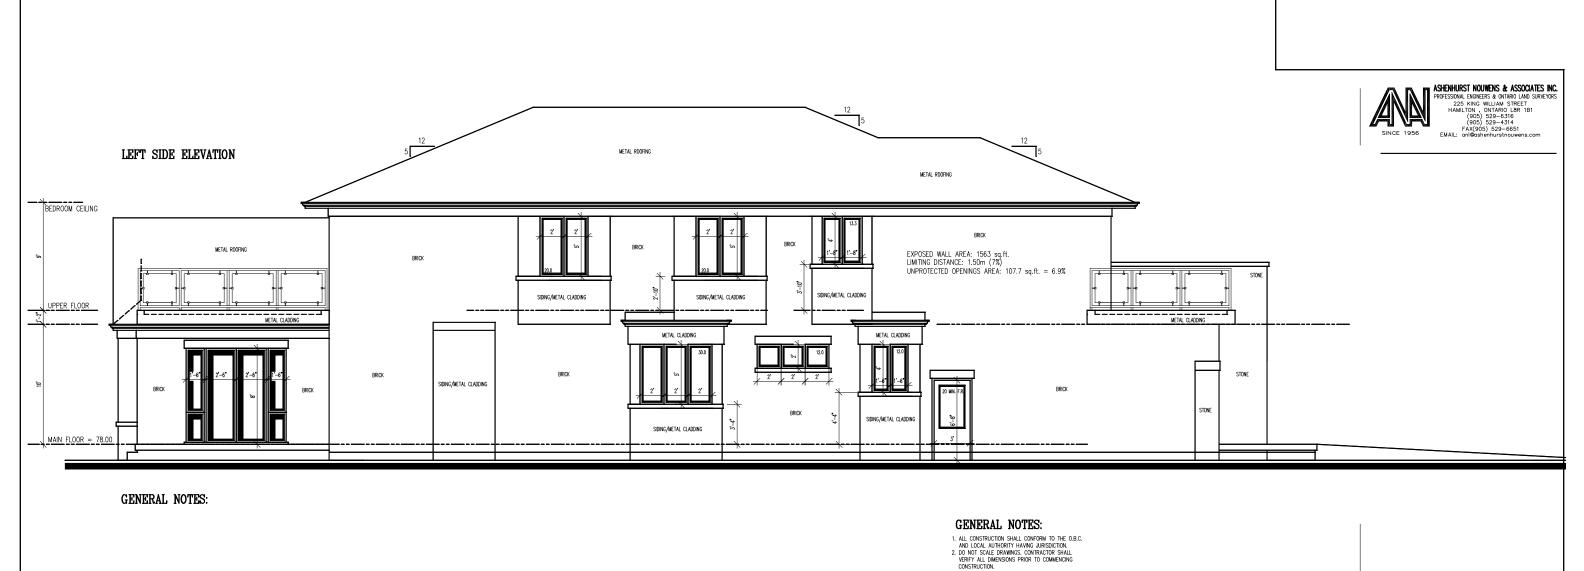

CONSTRUCTION. 3. ALL WOOD MEMBERS TO BE CONSTRUCTION SPRUCE No.2, UNLESS NOTED OTHERWISE. 4. INSTALL DUBLE JOISTS UNDER ALL PARALLEL PARTITIONS. 5. ALL CONSTRUCTION BETWEEN GARAGE AND DWELLING UNIT SHALL PROVIDE AN EFFECTIVE BARRIER FROM GAS AND SELF GLOSER. 6. HEAT TRANSFER, ARI EAKAGE & CONDENSATION CONTROL TO CONFORM TO SECTION 9.25. OF THE O.B.C. 7. MECHANICAL VERTILLATION TO CONFORM TO SECTION 9.23. OF THE O.B.C. 7. MECHANICAL VERTILLATION TO CONFORM TO SECTION 9.23. OF THE O.B.C. 7. MECHANICAL VERTILLATION TO SECTION 9.25. OF THE O.B.C. CHINNEY TO CONFORM TO SECTION 9.21 OF THE O.B.C. CHINNEY TO CONFORM TO SECTION 9.22 OF THE O.B.C. CHINNEY TO CONFORM TO SECTION 9.21 OF THE O.B.C. CHINNEY TO CONFORM TO SECTION 9.21 OF THE O.B.C. CHINNEY TO CONFORM TO SECTION 9.21 OF THE O.B.C. CHINNEY TO CONFORM TO SECTION 9.21 OF THE O.B.C. CHINNEY TO CONFORM TO SECTION 9.21 OF THE O.B.C. CHINNEY TO CONFORM TO SECTION 9.21 OF THE O.B.C. CHINNEY TO CONFORM TO SECTION 9.21 OF THE O.B.C. CHINNEY TO CONFORM TO SECTION 9.21 OF THE O.B.C. CHINNEY TO CONFORM TO SECTION 9.21 OF THE O.B.C. CHINNEY TO CONFORM TO SECTION 9.21 OF THE O.B.C. CHINNEY TO CONFORM TO SECTION 9.21 OF THE O.B.C. CHINNEY TO CONFORM TO SECTION 9.21 OF THE O.B.C. CHINNEY TO CONFORM TO SECTION 9.21 OF THE O.B.C. CHINNEY TO CONFORM TO SECTION 9.21 OF THE O.B.C. THERMAL DESINON & MOUNTED MUTTELS MUST BE CONFIRMED UPON FINAL TRUSS BACKETS 9.24 O.C.TO SUPPORT BRICK. ALL BORDER WITH WELLIGED C.O.TO SUPPORT BRICK. ALL BORDER WITH WELLIGED C.O.TO SUPPORT BRICK. ALL BORDER WITH TWISTING. THERMAL DESION & MOUNTED AND PER SE-12, TABLE 3.1.1.24(IP)-A1. 14. STARIS, RAMPS, HANDRAILS & GUARDS AS PER SECTION 9.81 OF THE O.B.C. ATTACHMENT OF HANDRAILS AS PER SUPPLEMENTARY STANDARDS TO THE O.B.C. SE-7 5. ALL WORKS SHALL BE FERFORMED BY QUALIFIED AND LICENCED CONTRACTORS 16. ALL CONSETE BEFORMED BY QUALIFIED AND LICENCED CONTRACTORS 17. ALL CONSETE BEFORMED BY QUALIFIED AND LICENCED CONTRACTORS 18. ALL CONSETE BEFORMED BY QUALIFIED AND UCENCED CONTRACTORS

17. THERMAL RESISTANCE OF WINDOWS AS PER SB-12.

THERMAL RESISTANCE OF DOORS AS PER SB-12, TABLE 3.1.1.2A(IP) - A1

REGISTRATION INFORMATION

The undersigned has reviewed and takes responsibility for this design, and has the qualifications and meets the requirements set out in the Ontario Building Code to be a designer.

MILOS TRKULJA Ashenhurst nouwens + Associates Inc.

BCIN: **24457** BCIN: **30026** Signature:

352 BEACH BOULEVARD HAMILTON, Ontario

ELEVATION

DATE: MAY 14, 2020

SCALE: 1/8"=1'-0"

DWG BY: M.T.


19138


DWG No.


NOT ISSUED FOR CONSTRUCTION UNITE SIGNED AND DATED


PROPOSED RESIDENCE

TO PERFORM ACTUAL CONSTRUCTION THE BUILDER SHALL USE SET OF DRAWINGS SEALED - THEREFORE APPROVED - BY THE LOCAL BUILDING DEPARTMENT

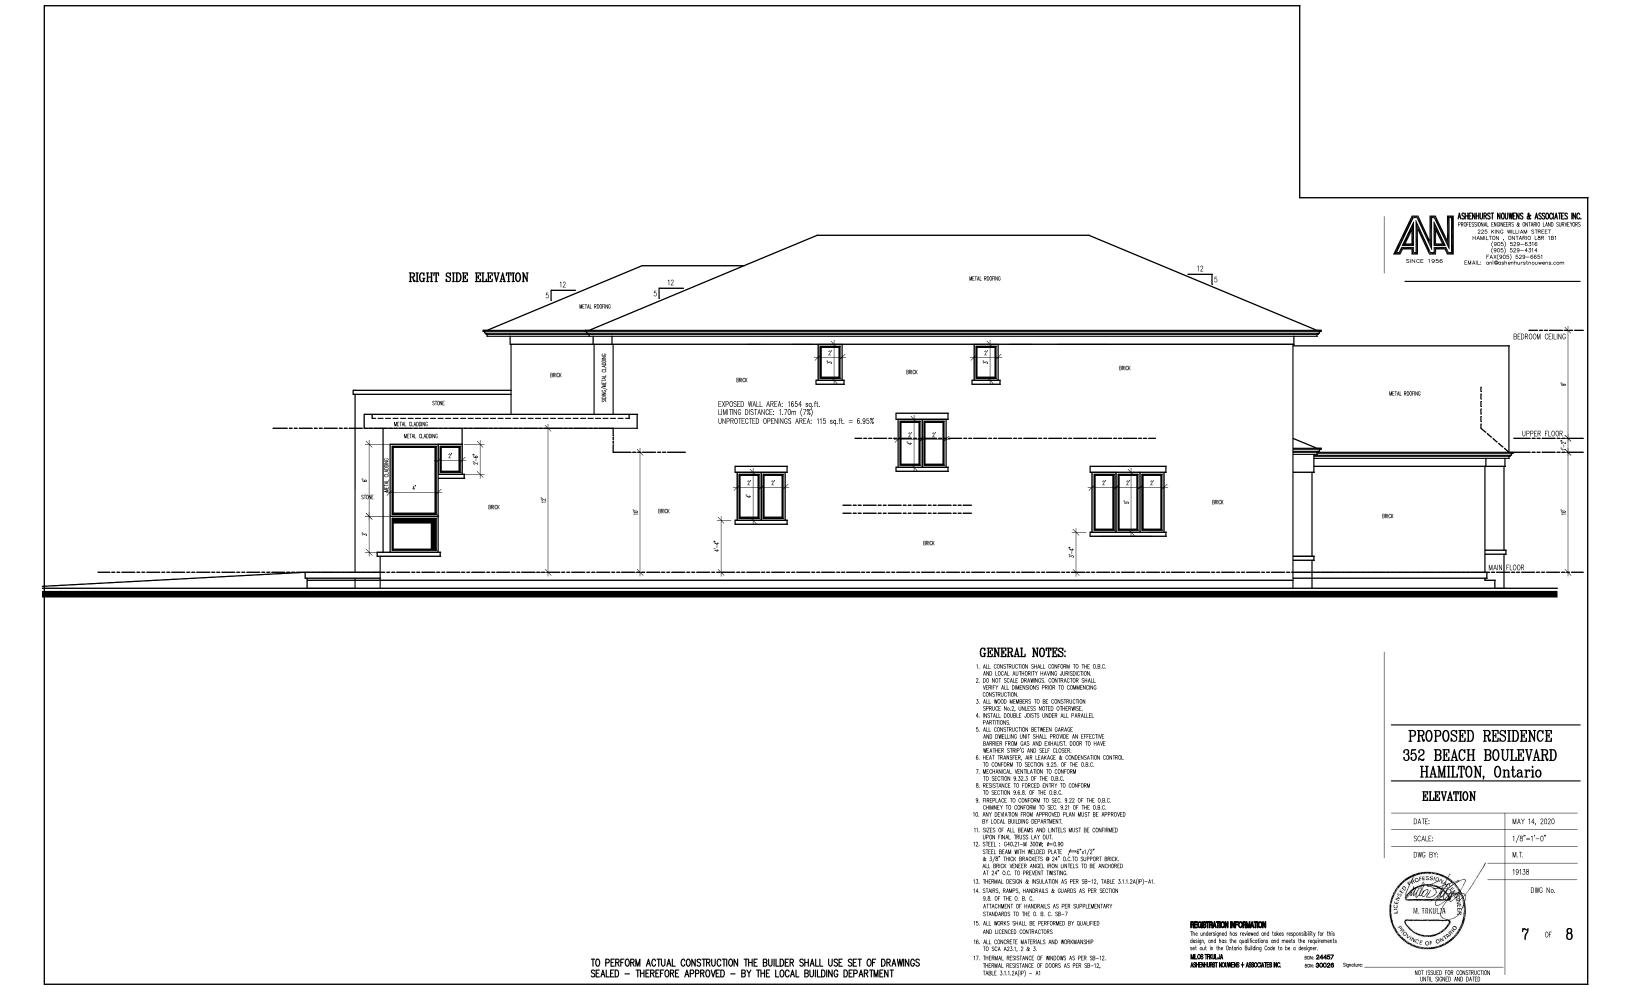

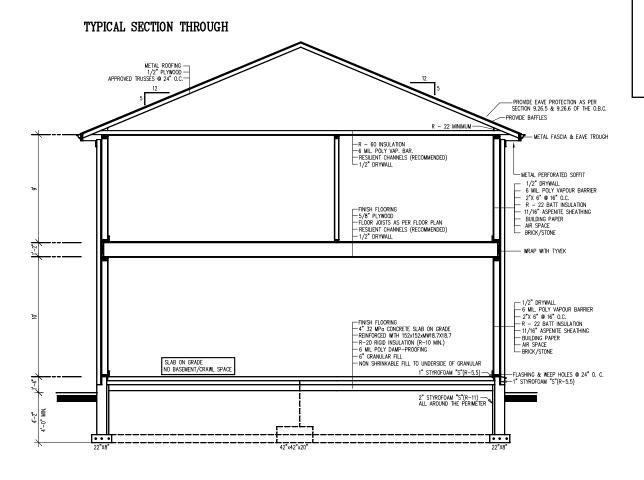


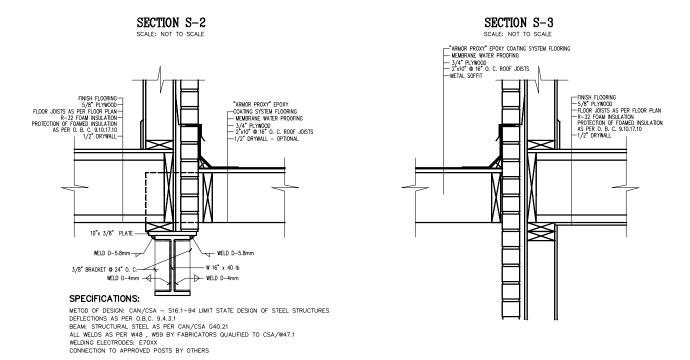

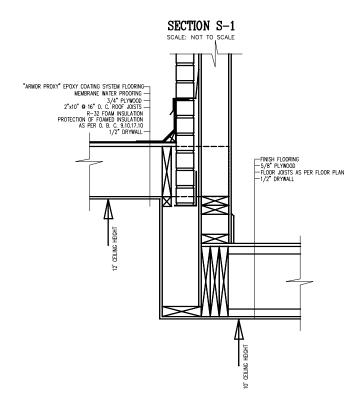

IRON RAILING DETAIL

INTO WOOD - NOT TO SCALE

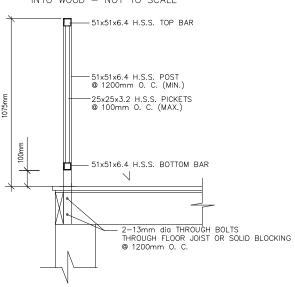

REGISTRATION INFORMATION

The undersigned has reviewed and takes responsibility for this design, and has the qualifications and meets the requirements set out in the Ontario Building Code to be a designer.

MLOS TRKULJA
ASHEMFURST NOUWENS + ASSOCIATES INC.



ASHENHURST NOUWENS & ASSOCIATES INC.

PROFESSIONAL ENGINEERS & ONTARIO LAND SUR 225 KING WILLIAM STREET HAMILTON, ONTARIO LBR 1B1 (905) 529-6316 (905) 529-4314 FAX(905) 529-6651 EMAIL: anl@ashenhurstnouwens.com

GENERAL NOTES:

SE SET OF DRAWINGS S DEPARTMENT

SHALL USE L BUILDING D

N THE BUILDER S BY THE LOCAL

CONSTRUCTION : E APPROVED - B

PERFORM ACTUAL ALED - THEREFORE

SEA

- GENERAL NOTES:

 1. ALL CONSTRUCTION SHALL CONFORM TO THE O.B.C.
 AND LOCAL AUTHORITY HAVING JURISDICTION.

 2. DO NOT SCALE DRAWINGS, CONTRACTOR SHALL
 VERIFY ALL DIMENSIONS PRIOR TO COMMENCING
 CONSTRUCTION.

 3. ALL WOOD MEMBERS TO BE CONSTRUCTION

 3. ALL WOOD MEMBERS TO BE CONSTRUCTION

 5. FOR THE CONSTRUCTION SET OF THE PARTITION.

 5. ALL CONSTRUCTION BETWEEN GARAGE
 AND DWELLING UNITS HALL PROVIDE AN EFFECTIVE
 BARRIER FROM GAS AND EXHAUST, DOOR TO HAVE
 WATHER STRIPP GAND SELF CLOSER.

 6. HEAT TRANSFER, AR LEAKAGE & CONDENSATION CONTROL

 TO CONFORM TO SECTION 2.5. OF THE O.B.C.

 7. MECHANICAL VENITIATION TO CONFORM
 TO SECTION 9.8.3. OF THE O.B.C.

 8. RESISTANCE TO FORCED ENTRY TO CONFORM
 TO SECTION 9.8.8. OF THE O.B.C.

 9. FIREPLACE TO CONFORM TO SEC. 9.2 OF THE O.B.C.
 CHINNEY TO CONFORM TO SEC. 9.22 OF THE O.B.C.
 CHINNEY TO CONFORM TO SEC. 9.22 OF THE O.B.C.

 10. ANY DEVALTION FROM APPROVED PLAN MUST BE APPROVED
 BY LOCAL BUILDING DEPRATIMENT.

 11. SIZES OF ALL BEAMS AND LINTELS MUST BE CONFIRMED
 UPON FINAL TRUSS LAY OUT.

 12. STEEL J. GAD ZIM OND, #=0.90

 STEEL BEAM WITH WELDED PLATE #651/2"

 6. 3/8" THICK BRACKETS OF 24" O.C. TO SUPPORT BRICK.
 ALL BRICK VENEER ANGEL RON LINTELS TO BE ANCHORED
 AT 24" O.C. TO PREVENT INSTINK.

 13. THERMAL DESIGN & INSULATION AS PER SB-12, TABLE 3.11.2

 14. STABRS RAMBES HANDIRALIS & CALIADORS AS PER SECTION.
- A 124 O.C. TO PREVENT IMISSING.

 3. THERMAL DESIGN & INSULATION AS PER SB-12, TABLE 3.1.1.2A(IP)-A1.

 14. STAIRS, RAMPS, HANDRAILS & GUARDS AS PER SECTION

 9.8. OF THE O. B. C.
 ATTACHMENT OF HANDRAILS AS PER SUPPLEMENTARY

 STANDARDS TO THE O. B. C. SB-7

 15. ALL WORKS SHALL BE PERFORMED BY QUALIFIED

 AND LICENSEY CONTRACTIONS
- AND LICENCED CONTRACTORS
- 16. ALL CONCRETE MATERIALS AND WORKMANSHIP TO SCA A23.1, 2 & 3.
- 17. THERMAL RESISTANCE OF WINDOWS AS PER SB-12.
 THERMAL RESISTANCE OF DOORS AS PER SB-12,
 TABLE 3.1.1.2A(P) A1

GARAGE FLOOR 4" CONC. SLAB
REINFORCED WITH
152x152 MW18.7xMW18.7
6" GRAN. FILL

WALL ASSEMBLY WITH SIDING

1/2 DKTWALL
6 ML. POLY VAPOUR BARRIER
2"X 6" 0 16" O.C.
R - 22 DATI NOSILATION
1/2" PLYWOOD SHEATHING
BUILDING PAPER
SIDING/METAL CLADDING AS PER OWNER'S SELECTION

PROPOSED RESIDENCE 352 BEACH BOULEVARD HAMILTON, Ontario

SECTION/DETAILS

DATE:	MAY 14, 2020
SCALE:	1/4"=1'-0"
DWG BY:	M.T.
FILE:	19138
TOFESS/ON A	DWG No.



OF **8**

NOT ISSUED FOR CONSTRUCTION UNTIL SIGNED AND DATED