COMMITTEE OF ADJUSTMENT



City Hall, 5th floor, 71 Main Street West, Hamilton, ON L8P 4Y5
Telephone (905) 546-2424, ext. 4221, 3935 Fax (905) 546-4202

E-mail: cofa@hamilton.ca

NOTICE OF PUBLIC HEARING Minor Variance

You are receiving this notice because you are either:

Assessed owner of a property located within 60 metres of the subject property

· Applicant/agent on file, or

Person likely to be interested in this application

APPLICATION NO.:

HM/A-20:134

APPLICANTS:

Brent Vanderwoude on behalf of the owner Sean Dowell

SUBJECT PROPERTY:

Municipal address 175 Montrose Ave., Hamilton

ZONING BY-LAW:

Zoning By-law 6593, as Amended

ZONING:

"C" (Urban Protected Residential, etc.) district

PROPOSAL:

To permit the construction of a westerly 2.13m (7') \times 3.56m (11'8") dormer addition and to convert the existing single-family dwelling to contain two dwelling units and to recognize the location of an existing 5.48m (18'0") \times 7.31m (24'0") accessory building (existing garage)

notwithstanding that:

- 1. A minimum floor area of 56m2 shall be provided for the basement dwelling unit instead of the requirement that each dwelling unit shall have a floor area of at least 65m2 for a residential conversion.
- 2. The external appearance of the dwelling shall permitted to be altered by the dormer addition, new windows and doors and blocking of existing windows and doors instead of the requirement that the external appearance and character of the dwelling shall be preserved for a residential conversion.
- 3. The manoeuvring for the two (2) parking spaces in the rear yard for both dwelling units shall be located partially off-site and on the Malta Drive road allowance instead of the requirement that the manoeuvring for one parking space for one of the dwelling units may be permitted off-site for a residential conversion.
- 4. A minimum front yard depth of 5.9m shall be recognized instead of the minimum required front yard depth of 6.0m.
- 5. A minimum easterly side yard of 4.2m shall be recognized for the existing accessory building instead of the minimum required side yard of 6.0m.

NOTE:

- i) Be advised that Variance No. 4 is intended to recognize the location of the existing building which appears to be a result due to an error in construction.
- ii) Be advised that the location of basement walkout does not constitute an encroachment into a required yard provided the foundation wall does not project not more than 150 mm above the adjacent grade, with or without a guard. The plans submitted show the foundation

HM/A-20:134 Page 2

wall projecting 150mm above adjacent grade which conforms to a building policy. Be advised that if this wall projects more than 150mm above adjacent grade, a further variance shall be required for a non-complying westerly side yard width.

This application will be heard by the Committee as shown below:

DATE:

Thursday, October 22nd, 2020

TIME:

1:45 p.m.

PLACE:

Via video link or call in (see attached sheet for

details)

To be streamed at www.hamilton.ca/committeeofadjustment

for viewing purposes only

PUBLIC INPUT

Written: If you would like to submit written comments to the Committee of Adjustment you may do so via email or hardcopy. Please see attached page for complete instructions, including deadlines for submitting to be seen by the Committee.

Orally: If you would like to speak to this item at the hearing you may do so via video link or by calling in. Please see attached page for complete instructions, including deadlines for registering to participate.

MORE INFORMATION


For more information on this matter, including access to drawings illustrating this request:

- Visit <u>www.hamilton.ca/committeeofadjustment</u>
- Call 905-546-CITY (2489) or 905-546-2424 extension 4221, 4130, or 3935
- Email Committee of Adjustment staff at <u>cofa@hamilton.ca</u>

DATED: October 6th, 2020.

Jamila Sheffield, Secretary-Treasurer Committee of Adjustment

Information respecting this application is being collected under the authority of the Planning Act, R.S.O., 1990, c. P. 13. All comments and opinions submitted to the City of Hamilton on this matter, including the name, address, and contact information of persons submitting comments and/or opinions, will become part of the public record and will be made available to the Applicant and the general public.

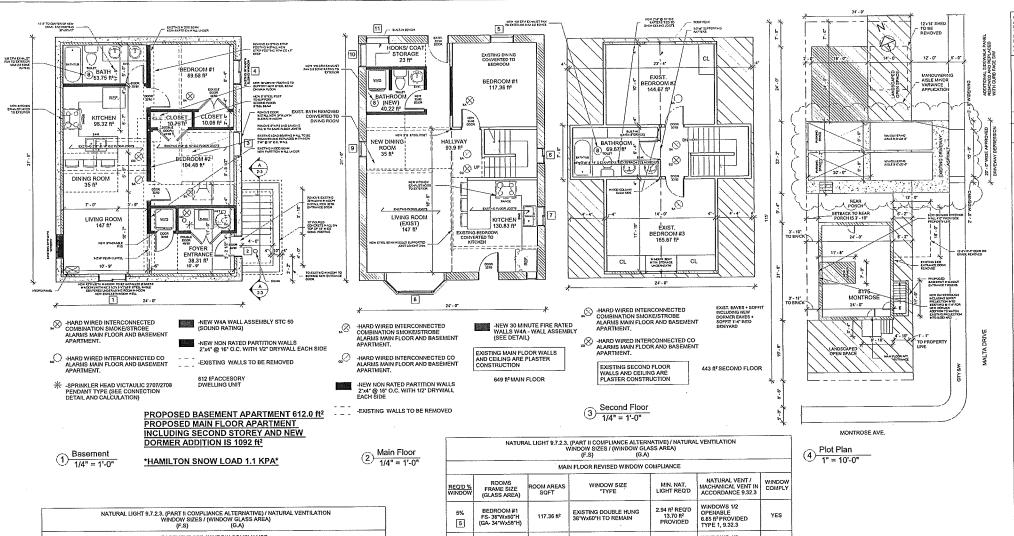

	NATURA	AL LIGHT 9,7.2.3. V	(PART II COMPLIANCE ALTERN YINDOW SIZES / (WINDOW GLA (F.S) (G.A)	ATIVE) / NATURA SS AREA)	L VENTILATION	
		E	ASEMENT APT. WINDOW COM	PLIANCE		
REO'D % WINDOW	ROOMS FRAME SIZE (GLASS AREA)	ROOM AREAS SQFT	WINDOW SIZE *TYPE	MIN. NAT. LIGHT REQ'D	NATURAL VENT / MACHANICAL VENT IN ACCORDANCE 9.32.3	WINDOW
5% 1 +	COMBINATION ROOM L.R./+D.R. NEW FS- 42*Wx36*H (GA- 40*Wx34*H) EXISTING FS- 38*Wx24*H (GA- 36*Wx22*H)	145 ft ² 4 35 ft ² TOTAL 180 ft ²	NEW SLIDING EGRESS WINDOW WITH NEW 3 1/2'x3 1/2'x3/8' STEEL ANGLE OVER FOR BRICK EXISTING SLIDING WINDOW TO BE REPLACED WITH NEW ENTRANCE DOOR	9.0 ft ² REQ'D 9.44 ft ² PROVIDED	WINDOWS 1/2 OPENABLE 4.72 ft² PROVIDED TYPE 1, 9.32.3	YES
2.5%	BEDROOM #2 NEW FS- 38"Wx24"H (GA- 36"Wx22"H)	104.48 ft²	EXISTING DOOR TO BE REMOVED, INSTALL NEW 38"Wx24"H SLIDING WINDOW NEW 3 1/2"x3 1/2"x3/8" STEEL ANGLE OVER FOR BRICK	2.61 ft² REQ'D 5.5 ft² PROVIDED	WINDOWS 1/2 OPENABLE 2.75 ft² PROVIDED TYPE 1, 9.32.3	YES
2.5%	BEDROOM #1 FS- 38"Wx24"H (GA- 36"Wx22"H)	89.58 ft²	EXISTING SLIDING WINDOW TO BE REPLACED WITH NEW SAME SIZE	2.24 ft² REQ'D 5.5 ft² PROVIDED	WINDOW 1/2 OPENABLE 2.75 ft ² PROVIDED TYPE 1, 9.32.3	YES

		MAI	N FLOOR REVISED WINDOW C	OMPLIANCE		
REO'D % WINDOW		ROOM AREAS SQFT	WINDOW SIZE	MIN. NAT. LIGHT REQ'D	NATURAL VENT / MACHANICAL VENT IN ACCORDANCE 9.32.3	WINDOW
5% 5	BEDROOM#1 FS-36"Wx50"H (GA-34"Wx58"H)	117.36 ft²	EXISTING DOUBLE HUNG 38 Wx60°H TO REMAIN	2.94 ft² REQ'D 13.70 ft² PROVIDED	WINDOWS 1/2 OPENABLE 6.85 ft ² PROVIDED TYPE 1, 9.32.3	YES
NON 6	STAIRWELL FS-24"Wx24"H	N/A	EXISTING SLIDER 24"Wx24"H TO REMAIN	NON REQ'D 4.0 ft ² PROVIDED	WINDOWS 1/2 OPENABLE 2.0 ft² PROVIDED TYPE 1, 9.32.3	YES
NON	KITCHEN REDUCED SIZE TO FS- 30"Wx36"H (GA- 28"Wx34"H)	130.83 ft²	EXISTING DOUBLE HUNG 30'Wx60'H REDUCED IN SIZE TO F.S 30'Wx36'H SLIDER	NON REQ'D 7.5 ft ² PROVIDED	WINDOW 1/2 OPENABLE 3.75 ft² PROVIDED TYPE 1, 9.32.3	YES
5% 8	LR. BAY CENTER FIXED FS-60"Wx60"H 2 SIDE CASEMENT FS-18"Wx60"H	147 ft²	EXISTING BAY WINDOW CENTER FIXED FS- 60"Wx60"H 2 SIDE CASEMENT FS- 18"Wx60"H	7.35 REQ'D 36.24 ft ² PROVIDED	2 CASEMENT OPENABLE 12.88 ft² PROVIDED TYPE 1, 9.32.3	YES
5% 9	D.R. FS- 24"Wx60"H (GA- 22"Wx58"H)	35 ft²	EXISTING DOUBLE HUNG 24"Wx60"H TO REMAIN	1.75 ft² REQ'D 8.86 ft² PROVIDED	WINDOW 1/2 OPENABLE 4.43 ft² PROVIDED TYPE 1, 9.32.3	YES
NON	COAT STORAGE FS- 30"Wx60"H (GA- 28"Wx58"H)		EXISTING DOUBLE HUNG 30"Wx60"H TO REMAIN	NON REO'D 12.5 ft ² PROVIDED +	WINDOW 1/2 OPENABLE 6.25 fl² PROVIDED †	YES
+ 11	COAT STORAGE FS-35"Wx48"H (GA-34"Wx46"H)	23 ft²	EXISTING DOUBLE HUNG 36"Wx48"H TO REMAIN	12.0 ft ² PROVIDED TOTAL 24.5 ft ² PROVIDED	WINDOW 1/2 OPENABLE 5.0 ft² PROVIDED 12.25 ft² TOTAL PROVIDED TYPE 1, 9,32,3	YES

CONTRACTOR MUST VEREY AND ACCEPT RESPONSIBILITY FOR ALL DIMENSIONS AND CONDITIONS ON THE JOB AND MUST REPORT ANY DISCREPANCES TO THE DESIGNER BEFORE PROCEEDING WITH WORK, ALL CHANGES MUST BE AUTHORIZE & APPROVED BY THE DESIGNER

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175 Montrose Av., Hamilton, ON

Revision Schedule

No. Description Data
Totally Revised Sept. 2,2000

FOR PERMIT BUILDING 25-Sep-20 10:30:28 AM

> PROPOSED BASEMENT APARTMENT

SHEET TITL

FLOOR PLANS / WINDOW CHART

JOB:	00000
SCALE:	As Indicated
SHEET No.	1-3

PROPOSED BASEMENT APT.- 175 MONTROSE AVE., HAMILTON

- 612 ft2 BASEMENT APARTMENT PROPOSED
- Current use Single Family Dwelling
- Building approx. 60 years old.
- 1.1.2.6. Application of Part 11(1)Part 11 of Division B applies to the design and construction of existing buildings, or parts of existing buildings, that have been in existence for at least five years.
- PROPOSED LOWEST CEILING HEIGHT IN BASEMENT TO DRYWALL UNDER DUCTWORK IS 6'-5"

OBC REVIEW- PART 9 SFD WITH BASEMENT APARTMENT

SEPARATE ENTRANCES PROVIDED FOR MAIN FLOOR AND BASEMENT DWELLING UNIT - Totally separated, existing side door to basement removed, floor framed in, new basement window installed, new separate basement walkout to be constructed, directly to exterior from basement.

9.9.10.1.(1) EGRESS WINDOW PROVIDED FOR BASEMENT APT. - NEW Dining Room Window 42"wide x 36" high - no

opening less than 15", min. open area of 3,8ft2
PROPOSED FIRE SEPARATION/ FIRE RESISTANCE RATING NOTES

Ontario Building Code Review

- 9.10.8.1 Fire Resistance Ratings for Floors Table 9.10.8.1 45 minutes required, using Part 11 Compliance Alternative 15
- Propose 15 Minute Fire Resistance Rating For Horizontal Fire Separation in accordance with Part 11 Compliance
 Alternative C147 (page 49, Division B) Sentence (b) In detached houses, semi-detached houses....containing not more than two dwelling units, 15 min horizontal fire separation is acceptable where.
- Smoke alarms are installed in every dwelling unit and in common areas in conformance with Subsection 9.10.19., and
- Smoke alarms are interconnected

FIRE SEPARATION/ FIRE RESISTANCE RATINGS AND NOTES: 1. PROPOSE TO INSTALL SMOKE ALARMS AS PER ABOVE

PROPOSED HORIZONTAL FIRE SEPARATION ON BASEMENT CEILING - REQ'D. TO PROVIDE MIN. 15 MINUTE FRR (FIRE RESISTANCE RATING)- STC (SOUND TRANSMISSION) OF 50)

PROPOSING TO USE SUPPLEMENTARY STANDARD SB-3 -ASSEMBLY - F8D (PROVIDES 30 MINUTE FRR AND 50 STC RATING) - FLOOR JOIST CAVITY FILLED WITH ABSORPTIVE MATERIAL - RESILIENT METAL CHANNEL SPACED AT 24" OC - 1 LAYER 5/8" TYPE X - FIRE RATED DRYWALL. (SEE CEILING SECTION - DETAILS)

3) SERVICE ROOM IS TO BE SPRINKLERED (see sprinkler calculations)— NO FIRE SEPARATION ON CEILING. - W4A WALL ASSEMBLY PROPOSED TO SATISFY SOUND TRANSMISSION RATING OF 50. SINCE A FRR RATING ON SERVICE ROOM WALLS NOT REQUIRED WITH SPRINKLER PROTECTION (CONSTRUCTED IN ACCORDANCE WITH - SUPPLEMENTARY STANDARD SB-3 - WAA WALL ASSEMBLY - PROVIDES STC50 - 2X4 STUDS AT 16" OC, STUD CAVITY FILLED WITH ABSORPTIVE MATERIAL, 2 LAYERS 5/8" TYPE X FIRE RATED DRYWALL ON RESILIENT METAL CHANNEL SIDE, ONE LAYER OF 5/8" TYPE X FIRE RATED DRYWALL ON OTHER SIDE - FROM CONCRETE TO FLOOR SHEATHING ABOVE). DOOR TO SERVICE ROOM IS NOT RATED, BUT MUST BE LOCKABLE.

VERTICAL WALLS ADJACENT TO FOUNDATION TO BE CONSTRUCTED IN ACCORDANCE WITH WALL ASSEMBLY W1C-SB3 - PROVIDING FIRE RESISTANCE RATING OF 30 MINUTES - (SEE FOUNDATION WALL SECTION)

4) 9.10.13.1 Doors, Dampers and Other Closures in Fire Separations - Table 9.10.13.1. Fire Protection Rating for Closures (in fire

Non Required for a 15 minute Fire Separation - Chart requires Closures for Fire Separations requiring a FRR rating beginning with 30 minutes.

- 9.10.13.13. Fire Dampers (Ducts Penetrating Fire Separations) Part 11 Compliance Alternative C167/C168 (Division B page
- C167-in a building containing not more than 4 dwelling units, the existing heating or air-conditioning system may be altered to serve more than one dwelling unit, provided smoke alarms are installed in each dwelling unit and provided a smoke detector is installed in the supply or return air duct system serving the entire building which would turn off the fuel supply and electrical power to the heating system upon activation of such detector. Proposing to install the above requirements, therefore fire dampers will not be required.
- 5) 9.10.18.5 SMOKE DETECTOR REQUIRED IN RECIRCULATING AIR HANDLING SYSTEM SMOKE DETECTOR INSTALLED IN RETURN AIR PLENUM, UPON DETECTION OF SMOKE FURNACE IS SHUT DOWN,
- 6) 9.10.19. SMOKE ALARMS SHALL BE HARD WIRED AND INTERCONNECTED (BASEMENT AND MAIN FLOOR), INSTALLED IN EVERY SLEEPING ROOM, EVERY HALLWAY ADJACENT TO SLEEPING ROOMS, EVERY LEVEL, MUST BE AUDIBLE AND
- 7) 9,33.4, CARBON MONOXIDE ALARMS SHALL BE HARD WIRED/ INTERCONNECTED/ INSTALLED IN EACH SUITE OF RESIDENTIAL OCCUPANCY ADJACENT TO EACH SLEEPING AREA IN SUITE, IN SERVICE ROOM WITH FUEL BURNING
- 8) PROTECTION OF WOOD/ STEEL BEAMS AND COLUMNS

- 9.10.8.3 Fire Resistance Ratings for Walls, Columns and Arches - (1) Except as otherwise.......all loadbearing walls steel/wood beams, columns... in the storey immediately below a floor or roof assembly shall have a fire-resistance rating of not less than that required for the supported floor or roof assembly. TO BE FRAMED WITH 2X4 STUDS AND CLAD WITH 5/8"

TYPE X ORYWALL TO PROVIDE 15 MINUTE FRR(MINIMUM REQUIRED), USING SB-2 METHOD OF CALCULATION 2.3.4.

[60 MINUTE ACTUAL FRR. ACHIEVED.


9) WINDOWS (See Basement Window Chart for Window Compliance)

9.7.2.3. Minimum Window Areas – Basement Window Areas – Part 11 Compliance Alternative C107....windows may be reduced

Proposed Combination Dining Room/Living Room- 9.5.1.4. Combination Rooms(1) Two or more areas may be considered as a ation room.....Kitchen does not require Natural Lighting

WINDOWS Main Floor (See Main Floor Window Chart for Compliance)

Main Floor Plan is altered from existing, please see Main Floor plan and Window Chart for Compliance

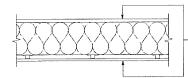


F8D - CEILING ASSEMBLY



HORIZONTAL FIRE SEPARATION 15 MIN. REQ'D / STC RATING OF 50 REQ'D / 30 MINUTES PROVIDED 1 1/2" = 1'-0"

W4A - WALL ASSEMBLY:

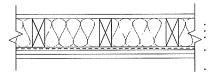

2"x4"STUDS SPACED 16" O.C 4" THICK ABSORPTIVE MATERIAL 1/2" RESILIENT METAL CHANNELS ON ONE SIDE SPACED 16" O.C. 21 AVERS OF 5/8" TYPE X GYPSUM BOARD ON RESILIENT METAL CHANNEL SIDE 11 AYER OF 5/8" TYPE X GYPSUM


★ SERVICE ROOM - REQUIRES STC RATING OF 50 - ROOM SPRINKLERED FIRE SEPARATION NOT REQ'D


TYPICAL BASEMENT

FOUNDATION WALL

12" REGULAR GYPSUM BOARD

VERTICAL FIRE SEPARATION OF 30 MIN. REQ'D. STC RATING OF 50 REQ'D - 1 HOUR PROVIDED

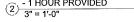


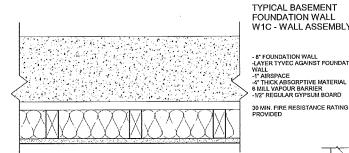

W1C WALL ASSEMBLY AROUND FOUNDATION WALLS

EXTERIOR BASEMENT FOUNDATION WALL DETAIL W1C

3" = 1'-0"

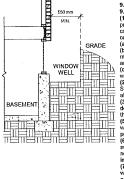

9.9.10. Egress from Bedrooms

9.9.10.1. Egress Windows or Doors for Bedrooms
(1) Except where a door on the same floor level as the bedroom provides direct access to the exterior, every floor level containing a bedroom in a *suite* shall be provided with at least one outside window that,

(a) is openable from the inside without the use of tools,

(b) provides an individual, unobstructed open portion having a minimum area of 0.35 m² with no dimension less than 360 mm,

and
(c) maintains the required opening described in Clause (b)
without the need for additional support.
(2) Except for basement areas, the window required in
Sentence (1) shall have a maximum sill height of 1 000 mm

above the floor. (3) When sliding windows are used, the minimum dimension described in Sentence (1) shall apply to the openable portion of the window.

(5) Where a window required in Sentence (1) opens into a window well, a clearance of not less than 550 mm shall be provided in front of the window.


(6) Where the sash of a window referred to in Sentence (5) wings towards the window well, the operation of the sash shall not reduce the clearance in a manner that would restrict escape in an emergency.

in an emergency.

(7) Where a protective enclosure is installed over the window well referred to in Sentence (5), such enclosure shall be openable from the inside without the use of keys, tools or special knowledge of the opening mechanism

WINDOW EGRESS DETAIL

4) 1/2" = 1'-0"

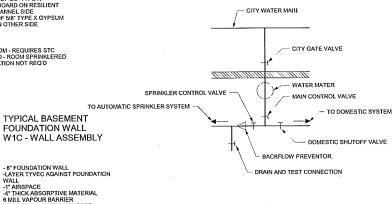

NEW WALKOUT DRAPN CONNECTED TO SANTARY SEVIER IN HOME, UNLESS PERMITTED OTHERWISE BY BURLOWN INSPECTOR ONNECTION WITH BUILDING MISPECTOR PROR TO PISTALLATION

NEW SPRINKLER CONNECTION

(5) DETAIL NFPA 13D-20

SECTION THROUGH NEW BASEMENT WALKOUT RASING AROUND STARWELL OPENING AND ON STARS -36" HIGH METAL GUARD MRI 6" ABOVE GRADE NEW 32/80 NEW 18'x6" FOOTING

175 Montrose Av.. Hamilton, ON

CONTRACTOR MUST VERIFY AND ACCEPT RESPONSBUITY FOR ALL DRIENSIONS AND CONDITIONS ON THE JOB AND MUST REPORT ANY DISCREPANCIES TO THE DESIGNER

C/3

Revision Schedule Description Date
Totally Revised Sept. 2,2020 25-Sep-20 10:30:31 AM

PROPOSED **BASEMENT** APARTMENT


-SPRAY TAR DAVPROOFING -DELTA MS DRAWAGE LAYER AROUND WALKOUT


SECTIONS **DETAILS / NOTES**


JOB:	00000
SCALE:	As indicated
SHEET No	2.2

4" TO 6" THRESHOLD REQUIRED AT DOOF TO WALKOUT PLEASE SEE PROFESSIONAL STRUCTURAL ENGINEER DRAWING FOR FROST PROTECTION AND CONNECTION

6 SECTION A-A

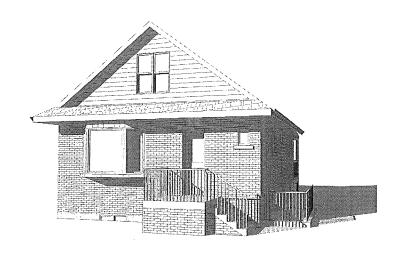

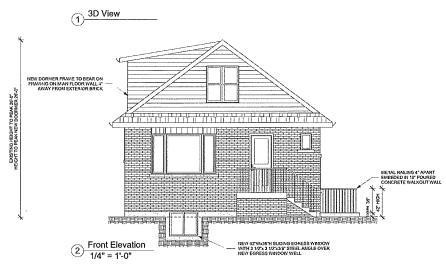

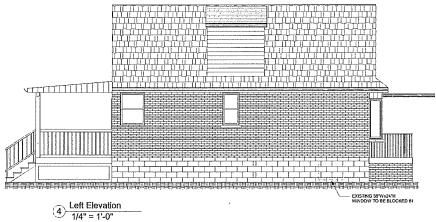

NEW DORMER AWTCH EXISTING OVERHANG BITO SIDEYAR 16* ROOF RAFTERS 2'x8" @ 16" O.C. TIED TO EACH CEALING JOIST BAFFLES FOR AIR VENTILATION NEW 16" OVERHANG PICLUNDING EAVESTROUGH SIDING TO MATCH TYVEC 7/16" ASPERITE 2'x4" & 16" O.C. RIZ INSULATION FOLY VAPOUR BARRIER 1/2" DRYWALL EXIST, 16' OVERHANG PROJECTION INTO SIDE YARD INCLUNDING EAVESTROUGH TERES. 6 Typical Section View
1/4" = 1'-0" Right Elevation
1/4" = 1'-0"

NEW W200x27 STEEL BEAM -

- EXTERIOR WALLS TYVEC

TYVEC _Z'A' @ 16' O.C. R12 INSULATION VAPOUR BARRER 1/Z DRYWALL

MAIN FLOOR

BASEMENT

OLD STRP FOOTING REMOVED NEW 18 Wx6 DEEP FOOTING POURED

EXIST, 30 WASO'N REDUCED TO 30 WASO'N SLIDER

NEW 35'x35'x16' CONCRETE PAD FOOTING TO SUPPORT STEEL BEAM ON MAIN FLOOR SUPPORTING SECOND FLOOR



(5) Rear Elevation 1/4" = 1'-0"

CONTRACTOR MUST VERIFY AND ACCEPT RESPONSELITY FOR ALL DIMENSIONS AND CONDITIONS ON DAMENSIONS AND CONDITIONS ON THE JOB AND MUST REPORT ANY DISCREPANCIES TO THE DESIGNER BEFORE PROCEEDING WITH WORK ALL CHANGES MUST BE AUTHORIZE & APPROVED BY THE DESIGNER.

9:28 SLOPE LESS THAN 1'ON DOONNER S LAYFRISH OF BOIL ROOMN'S STROKERED 1 LAYER OF SINGLES ON TOP TO MATCH REMANDER OF ROOF -STALL ROOM ONTO HICKERS -SPECIAL ROOM ONTO HICKERS -SPECIAL ROOM ONTO HICKERS -SPECIAL ROOM ON TO BE 10'O.C. -6 MILL POLYVIA.

Ceiling Main Floor

Ground Floor 9

BASEMENT WALKOUT TO BE DESIGNED BY PROFESSIONAL STRUCTURAL ENGINEER

NEW 3-216" RIDGE BEAM UNDER NEW RAFTERS FOR DORMER SPAIRING 6-4" TO EXISTING WALLS SUPPORTED BY NEW BEAM MAIN FLOOR

JA Home & Commercial Expertion Services were, hypothorised at the home of the







175 Montrose Av., Hamilton, ON

Revision Schedule Description Date
Totally Ravised Sept. 2.2020


FOR PERMIT BUILDING 25-Sep-20 10:30:43 AM

PROPOSED BASEMENT **APARTMENT**

SHEET TITLE:

SECTION AND **ELEVATIONS**

JOB:	00000
SCALE:	As indicated
SHEET No	3-3

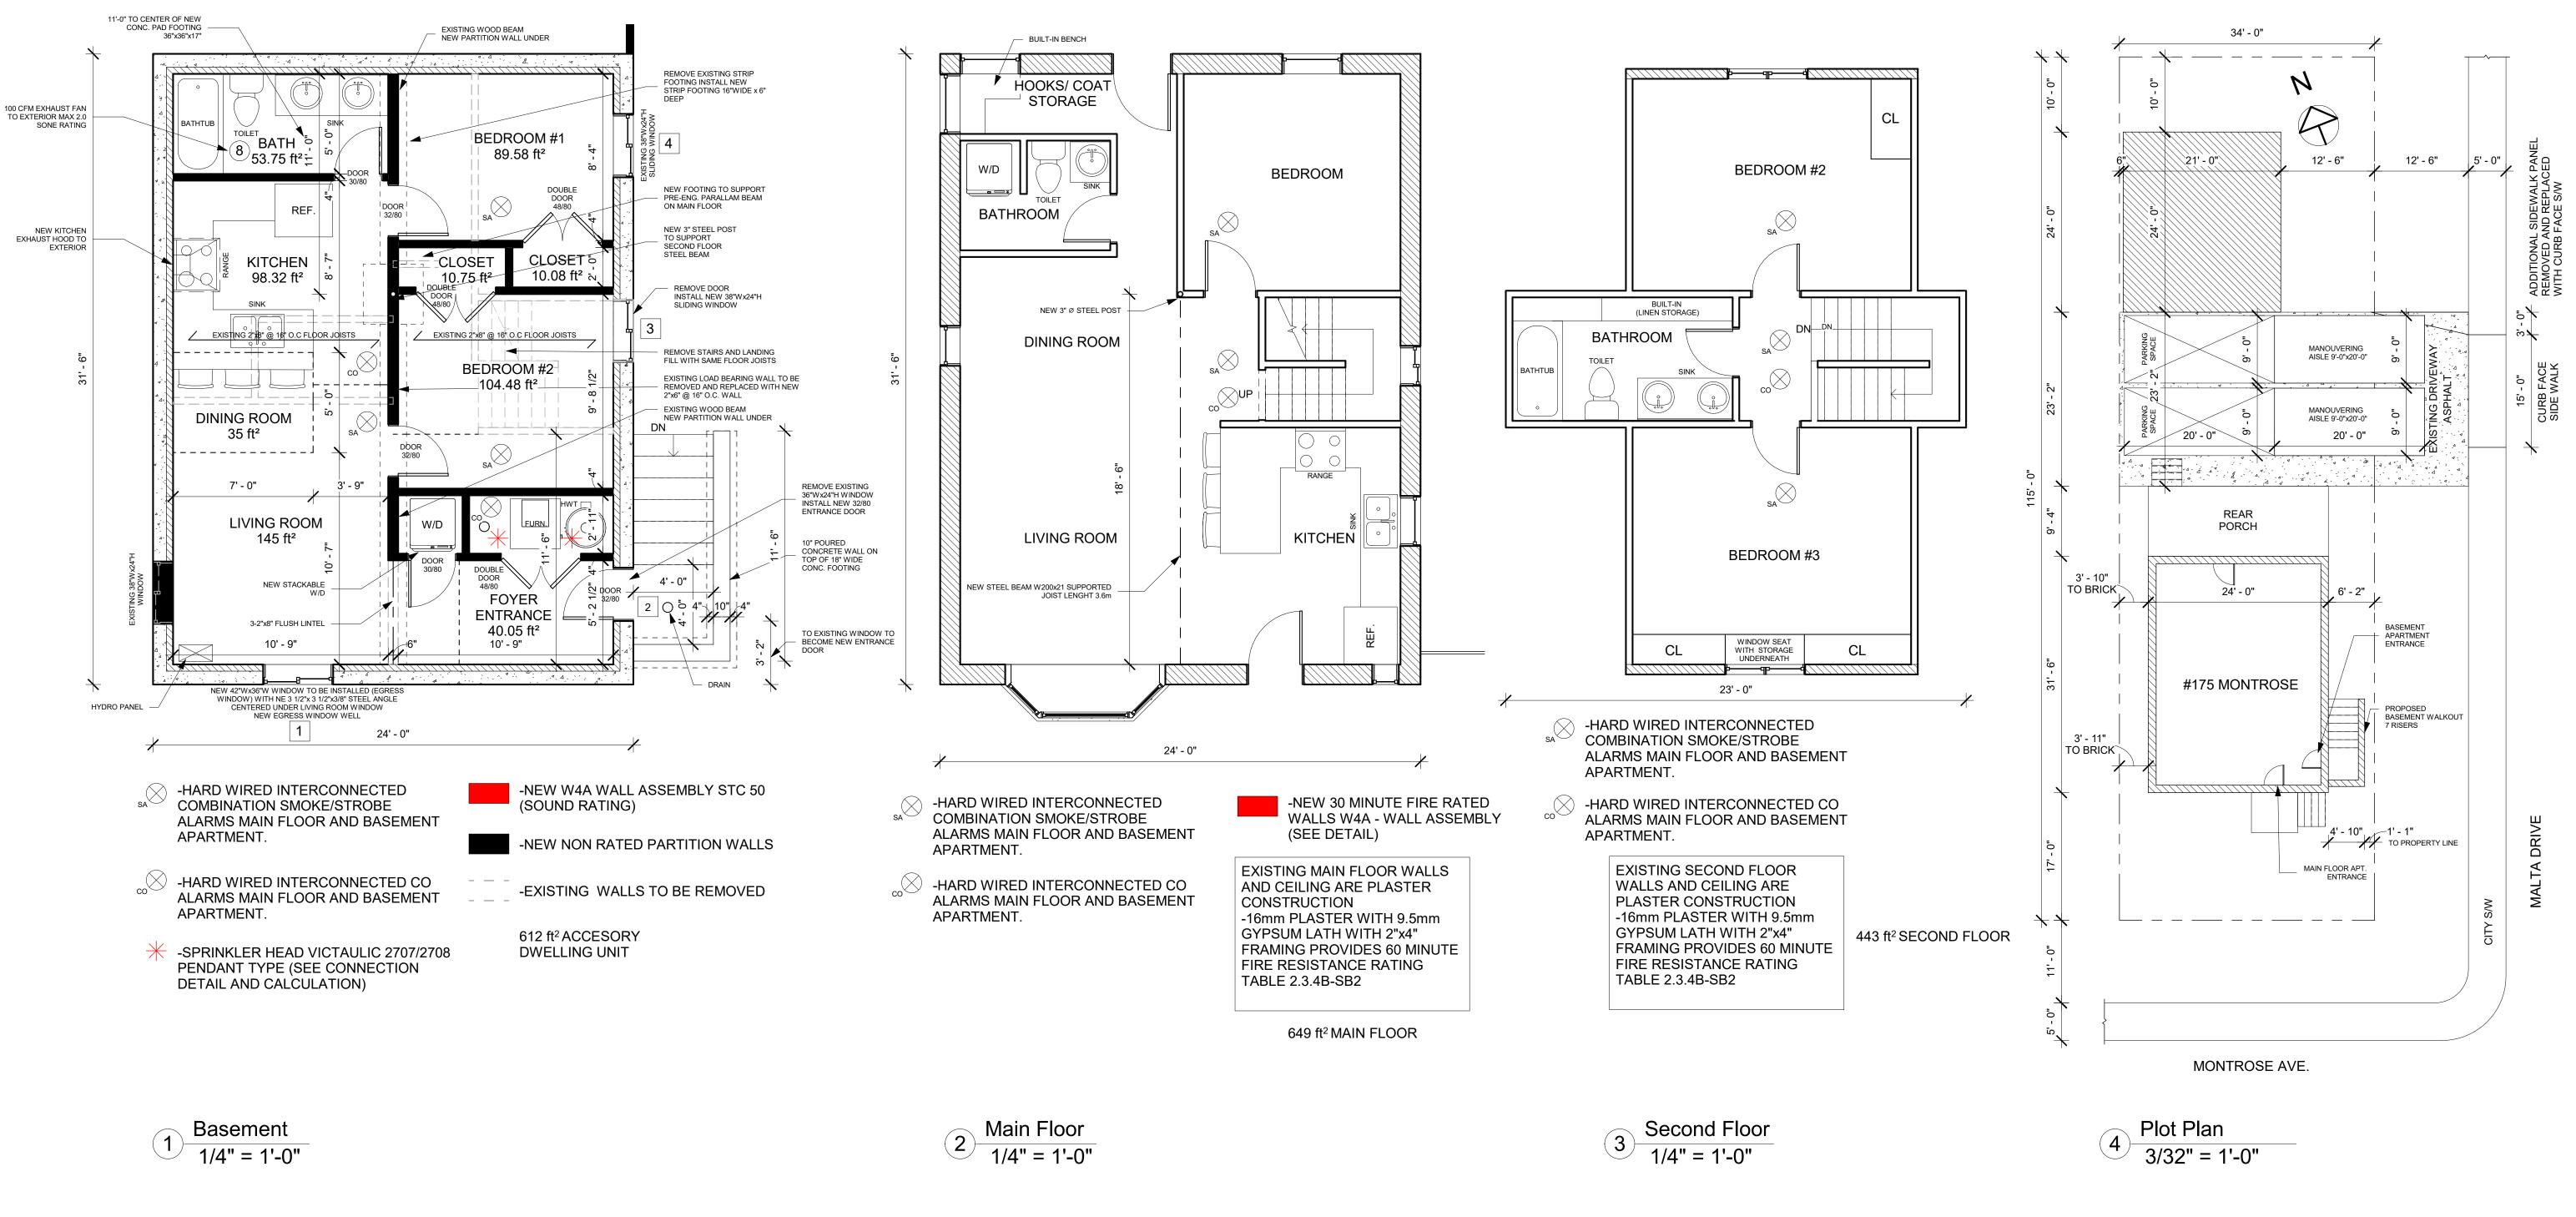

NATURAL LIGHT 9.7.2.3. (PART II COMPLIANCE ALTERNATIVE) / NATURAL VENTILATION WINDOW SIZES / (WINDOW GLASS AREA) (F.S) BASEMENT APT. WINDOW COMPLIANCE NATURAL VENT / ROOMS WINDOW MACHANICAL VENT IN COMPLY WINDOW SIZE MIN. NAT. REQ'D % WINDOW **ROOM AREAS** FRAME SIZE *TYPE LIGHT REQ'D SQFT **ACCORDANCE 9.32.3** (GLASS AREA) 5% COMBINATION NEW SLIDING EGRESS ROOM L.R./+D.R. WINDOW WITH NEW WINDOWS 1/2 9.0 ft² REQ'D 3 1/2"x3 1/2"x3/8" STEEL OPENABLE FS- 42"Wx36"H 9.44 ft² YES ANGLE OVER FOR BRICK 35 ft² 4.72 ft² PROVIDED PROVIDED (GA- 40"Wx34"H) TOTAL TYPE 1, 9.32.3 **EXISTING EXISTING SLIDING WINDOW** 180 ft² TO BE REPLACED WITH FS- 38"Wx24"H NEW ENTRANCE DOOR (GA- 36"Wx22"H) WINDOWS 1/2 EXISTING DOOR TO BE BEDROOM #2 REMOVED. INSTALL NEW 2.61 ft² REQ'D OPENABLE YES 2.5% NEW 2.75 ft² PROVIDED 38"Wx24"H SLIDING 5.5 ft² 104.48 ft² FS- 38"Wx24"H WINDOW PROVIDED TYPE 1, 9.32.3 (GA- 36"Wx22"H) NEW 3 1/2"x3 1/2"x3/8" STEEL ANGLE OVER FOR BRICK WINDOW 1/2 EXISTING SLIDING WINDOW | 2.24 ft² REQ'D 2.5% BEDROOM #1 OPENABLE YES 89.58 ft² 5.5 ft² TO BE REPLACED WITH FS- 38"Wx24"H 2.75 ft² PROVIDED (GA- 36"Wx22"H) **NEW SAME SIZE** PROVIDED TYPE 1, 9.32.3

CONTRACTOR MUST VERIFY AND ACCEPT RESPONSIBILITY FOR ALL DIMENSIONS AND CONDITIONS ON THE JOB AND MUST REPORT ANY DISCREPANCIES TO THE DESIGNER BEFORE PROCEEDING WITH WORK. ALL CHANGES MUST BE AUTHORIZED & APPROVED BY THE DESIGNER.

jk Home & Commercial Inspection Services
www.jkinspectionservices.ca
25Yrs Experience as a City Building Inspector
BCIN # 21234 (Building Code Identification Number)

John Kedzierski (Owner)
113 Windward St., St.Catharine's ON L2M 4C4

Call: 905-325-INSP(4677)

jkhomeinspections@gmail.com

(MMAH) BGIN #21234 (Building Colfd Identification Numbe



175 Montrose Av., Hamilton, ON

Revision Schedule

No. Description Date

1 Totally Revised Sept. 2,2020

9/3/2020 12:24:13 PM
PROJECT NAME:

PROPOSED
BASEMENT
APARTMENT

FOR PERMIT BUILDING

SHEET TITLE:

FLOOR PLANS / WINDOW CHART

 JOB:
 00000

 SCALE:
 As indicated

 SHEET No.
 1-3

PROPOSED BASEMENT APT. - 175 MONTROSE AVE., HAMILTON

- 612 ft2 BASEMENT APARTMENT PROPOSED
- Current use Single Family Dwelling
- Building approx. 60 years old.
- 1.1.2.6. Application of Part 11(1)Part 11 of Division B applies to the design and construction of existing buildings, or parts of existing buildings, that have been in existence for at least five years.
- PROPOSED LOWEST CEILING HEIGHT IN BASEMENT TO DRYWALL UNDER DUCTWORK IS 6'-5"

OBC REVIEW- PART 9 SFD WITH BASEMENT APARTMENT

SEPARATE ENTRANCES PROVIDED FOR MAIN FLOOR AND BASEMENT DWELLING UNIT – upper and lower units separated with a 30 Minute Fire Separation (W4A Assembly – see details), at side door entrance.

9.9.10.1.(1) EGRESS WINDOW PROVIDED FOR BASEMENT APT. – NEW Dining Room Window 42"wide x 36" high – no opening less than 15", min. open area of 3.8ft2

PROPOSED FIRE SEPARATION/ FIRE RESISTANCE RATING NOTES

Ontario Building Code Review

- **9.10.8.1 Fire Resistance Ratings for Floors** Table 9.10.8.1 45 minutes required, using Part 11 Compliance Alternative 15 Minutes Permitted
- Propose 15 Minute Fire Resistance Rating For Horizontal Fire Separation in accordance with Part 11 Compliance Alternative C147 (page 49, Division B) Sentence (b) – In detached houses, semi-detached houses....containing not more than two dwelling units, 15 min horizontal fire separation is acceptable where.
- Smoke alarms are installed in every dwelling unit and in common areas in conformance with Subsection 9.10.19., and

Smoke alarms are interconnected

FIRE SEPARATION/ FIRE RESISTANCE RATINGS AND NOTES:

PROPOSE TO INSTALL SMOKE ALARMS AS PER ABOVE.

2) PROPOSED HORIZONTAL FIRE SEPARATION ON BASEMENT CEILING - REQ'D. TO PROVIDE MIN. 15 MINUTE FRR (FIRE **RESISTANCE RATING)- STC (SOUND TRANSMISSION) OF 50)**

PROPOSING TO USE SUPPLEMENTARY STANDARD SB-3 -ASSEMBLY - F8D (PROVIDES 30 MINUTE FRR AND 50 STC RATING) - FLOOR JOIST CAVITY FILLED WITH ABSORPTIVE MATERIAL - RESILIENT METAL CHANNEL SPACED AT 24" OC – 1 LAYER 5/8" TYPE X – FIRE RATED DRYWALL. (SEE CEILING SECTION - DETAILS)

VERTICAL FIRE SEPARATION OF 45 MINUTES IS REQUIRED BETWEEN SEPARATE DWELLING UNITS AS PER SECTION 9.10.9.14 AND 9.10.9.15 - PROPOSING TO USE PART 11 COMPLIANCE ALTERNATIVE C 152 - 30 MINUTE FRR (FIRE **RESISTANCE RATING) IS ACCEPTABLE.**

VERTICAL FIRE SEPARATION BETWEEN BASEMENT APARTMENT AND MAIN FLOOR APARTMENT - REQUIRED TO PROVIDE 30MINUTE FRR AND STC RATING OF 50.

PROPOSING TO USE SUPPLEMENTARY STANDARD SB-3 - W4A WALL ASSEMBLY - PROVIDES 1 HOUR FRR. STC50 -2X4 STUDS AT 16" OC, STUD CAVITY FILLED WITH ABSORPTIVE MATERIAL, 2 LAYERS 5/8" TYPE X FIRE RATED DRYWALL ON RESILIENT METAL CHANNEL SIDE, ONE LAYER OF 5/8" TYPE X FIRE RATED DRYWALL ON OTHER SIDE

SERVICE ROOM IS TO BE SPRINKLERED (see sprinkler calculations)— NO FIRE SEPARATION ON CEILING. - W4A WALL ASSEMBLY PROPOSED TO SATISFY SOUND TRANSMISSION RATING OF 50, SINCE A FRR RATING ON SERVICE ROOM WALLS NOT REQUIRED WITH SPRINKLER PROTECTION (CONSTRUCTED IN ACCORDANCE WITH NOTE #3 ABOVE FROM CONCRETE TO FLOOR SHEATHING ABOVE). SERVICE ROOM DOOR NOT RATED.

VERTICAL WALLS ADJACENT TO FOUNDATION TO BE CONSTRUCTED IN ACCORDANCE WITH WALL ASSEMBLY W1C-SB3 – PROVIDING FIRE RESISTANCE RATING OF 30 MINUTES – (SEE FOUNDATION WALL SECTION)

9.10.13.13. Fire Dampers (Ducts Penetrating Fire Separations) – Part 11 Compliance Alternative C167/C168 (Division B – page

4) 9.10.13.1 Doors, Dampers and Other Closures in Fire Separations – Table 9.10.13.1. Fire Protection Rating for Closures (in fire

- Non Required for a 15 minute Fire Separation Chart requires Closures for Fire Separations requiring a FRR rating beginning with 30 minutes.
- C167-in a building containing not more than 4 dwelling units, the existing heating or air-conditioning system may be altered to serve more than one dwelling unit, provided smoke alarms are installed in each dwelling unit and provided a smoke detector is installed in the supply or return air duct system serving the entire building which would turn off the fuel supply and

electrical power to the heating system upon activation of such detector. Proposing to install the above requirements, therefore fire dampers will not be required.

5) 9.10.18.5 - SMOKE DETECTOR REQUIRED IN RECIRCULATING AIR HANDLING SYSTEM - SMOKE DETECTOR INSTALLED IN RETURN AIR PLENUM, UPON DETECTION OF SMOKE FURNACE IS SHUT DOWN

- 6) 9.10.19. SMOKE ALARMS SHALL BE HARD WIRED AND INTERCONNECTED (BASEMENT AND MAIN FLOOR), INSTALLED IN EVERY SLEEPING ROOM, EVERY HALLWAY ADJACENT TO SLEEPING ROOMS, EVERY LEVEL, MUST BE AUDIBLE AND VISUAL.
- 7) 9.33.4. CARBON MONOXIDE ALARMS SHALL BE HARD WIRED/ INTERCONNECTED/ INSTALLED IN EACH SUITE OF RESIDENTIAL OCCUPANCY ADJACENT TO EACH SLEEPING AREA IN SUITE, IN SERVICE ROOM WITH FUEL BURNING APPLIANCE.
- 8) PROTECTION OF WOOD/ STEEL BEAMS AND COLUMNS

- 9.10.8.3 Fire Resistance Ratings for Walls, Columns and Arches – (1) Except as otherwise........all loadbearing walls, steel/wood beams, columns.... in the storey immediately below a floor or roof assembly shall have a fire-resistance rating of not less than that required for the supported floor or roof assembly.- TO BE FRAMED WITH 2X4 STUDS AND CLAD WITH 5/8" TYPE X DRYWALL TO PROVIDE 15 MINUTE FRR(MINIMUM REQUIRED), USING SB-2 METHOD OF CALCULATION 2.3.4. (60 MINUTE ACTUAL FRR. ACHIEVED


9) WINDOWS (See Window Chart for Window Compliance)

9.7.2.3. Minimum Window Areas – Basement Window Areas – Part 11 Compliance Alternative C107....windows may be reduced


Proposed Combination Dining Room/Living Room- 9.5.1.4. Combination Rooms(1) Two or more areas may be considered as a combination room......Kitchen does not require Natural Lighting

NEW CEILING ENTIRE BASEMENT NOT INCLUDING SERVICE ROOM

F8D - CEILING ASSEMBLY

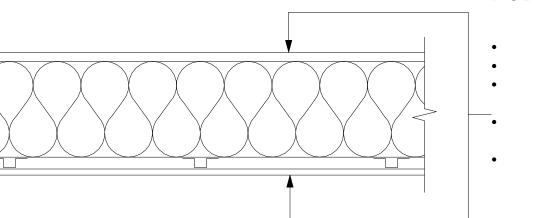


EX. PLYWOOD SHEATHING

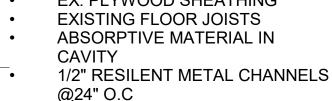

1 LAYER OF 5/8" TYPE X GYPSUM

HORIZONTAL FIRE SEPARATION 15 MIN. REQ'D / STC RATING OF 50 REQ'D / 30 MINUTES PROVIDED

1 1/2" = 1'-0"

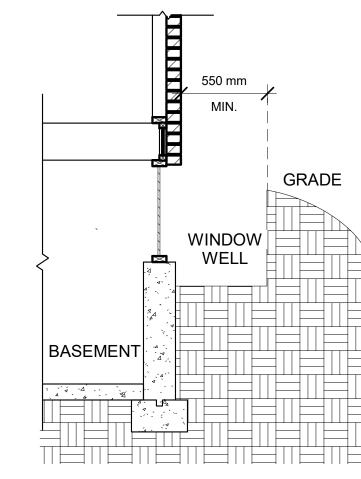

9.9.10. Egress from Bedrooms

9.9.10.1. Egress Windows or Doors for Bedrooms (1) Except where a door on the same floor level as the bedroom provides direct access to the exterior, every floor level containing a bedroom in a suite shall be provided with at least

one outside window that, (a) is openable from the inside without the use of tools, (b) provides an individual, unobstructed open portion having a minimum area of 0.35 m² with no dimension less than 380 mm.

(c) maintains the required opening described in Clause (b) without the need for additional support.

(2) Except for basement areas, the window required in Sentence (1) shall have a maximum sill height of 1 000 mm


(3) When sliding windows are used, the minimum dimension described in Sentence (1) shall apply to the openable portion of

(5) Where a window required in Sentence (1) opens into a window well, a clearance of not less than 550 mm shall be provided in front of the window.

(6) Where the sash of a window referred to in Sentence (5) swings towards the window well, the operation of the sash shall not reduce the clearance in a manner that would restrict escape in an emergency.

(7) Where a protective enclosure is installed over the window well referred to in Sentence (5), such enclosure shall be openable from the inside without the use of keys, tools or special knowledge of the opening mechanism

W4A – WALL ASSEMBLY:

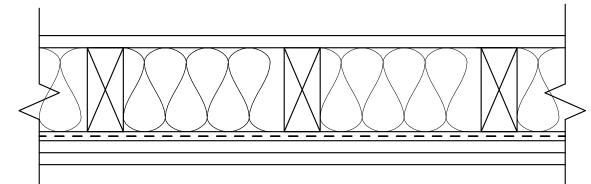

2"x4"STUDS SPACED 16" O.C 4" THICK ABSORPTIVE MATERIAL

1/2" RESILIENT METAL CHANNELS ON ONE SIDE SPACED 16" O.C. 2 LAYERS OF 5/8" TYPE X

GYPSUM BOARD ON RESILIENT METAL CHANNEL SIDE 1 LAYER OF 5/8" TYPE X GYPSUM **BOARD ON OTHER SIDE**

SERVICE ROOM - REQUIRES STC **RATING OF 50 - ROOM SPRINKLERED** FIRE SEPARATION NOT REQ'D

VERTICAL FIRE SEPARATION OF 30 MIN. REQ'D, STC RATING OF 50 REQ'D 2 3" = 1'-0" - 1 HOUR PROVIDED


W1C WALL ASSEMBLY AROUND FOUNDATION WALLS

EXTERIOR BASEMENT FOUNDATION

30 MIN. FIRE RESISTANCE RATING PROVIDED

WALL DETAIL W1C

WINDOW EGRESS DETAIL

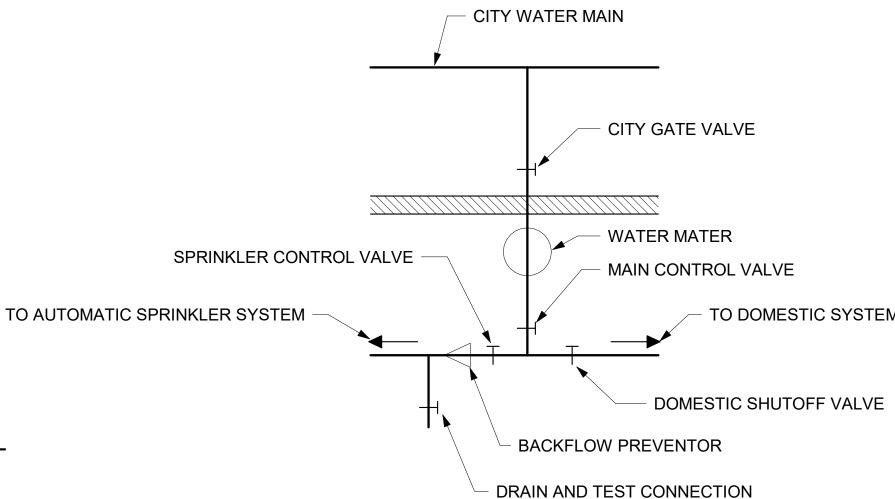

FOUNDATION WALL W1C - WALL ASSEMBLY

- 8" FOUNDATION WALL -LAYER TYVEC AGAINST FOUNDATION -1" AIRSPACE -4" THICK ABSORPTIVE MATERIAL **6 MILL VAPOUR BARRIER** -1/2" REGULAR GYPSUM BOARD

TYPICAL BASEMENT

30 MIN. FIRE RESISTANCE RATING PROVIDED

DETAIL NFPA 13D-20

NEW SPRINKLER CONNECTION

CONTRACTOR MUST VERIFY AND ACCEPT RESPONSIBILITY FOR ALL **DIMENSIONS AND CONDITIONS ON** THE JOB AND MUST REPORT ANY DISCREPANCIES TO THE DESIGNER BEFORE PROCEEDING WITH WORK. ALL CHANGES MUST BE AUTHORIZED & APPROVED BY THE DESIGNER.

> jk Home & Commercial Inspection Services www.jkinspectionservices.ca 25Yrs Experience as a City Building Inspecto BCIN # 21234 (Building Code Identification Numb John Kedzierski (Owner) Call: 905-325-INSP(4677)

> > (MMAH) BGIN #21234 ilding Codd den lification Number



175 Montrose Av., Hamilton, ON

Revision Schedule				
No.	Description	Date		
1	Totally Revised	Sept. 2,2020		
	FOR PERMIT B	UILDING		

9/3/2020 12:24:14 PM PROJECT NAME:


PROPOSED **BASEMENT APARTMENT**


SHEET TITLE:


SECTIONS **DETAILS / NOTES**


As indicated SHEET No. 2-3



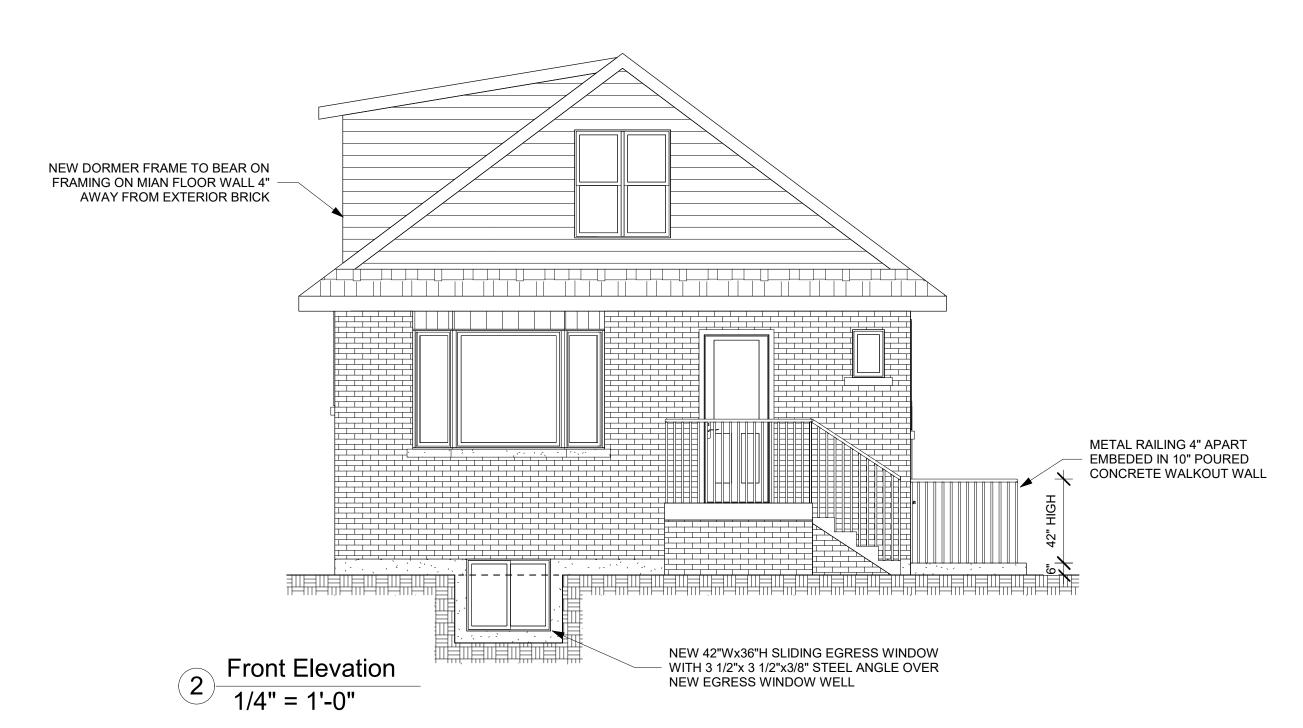

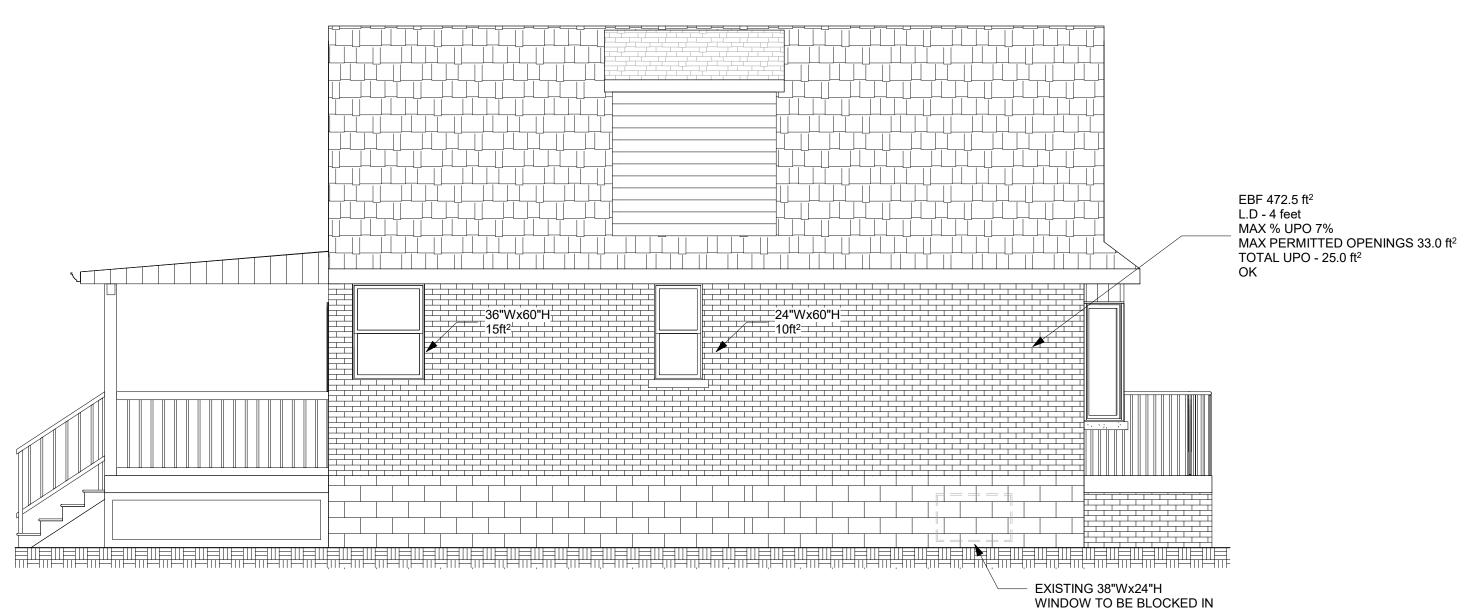

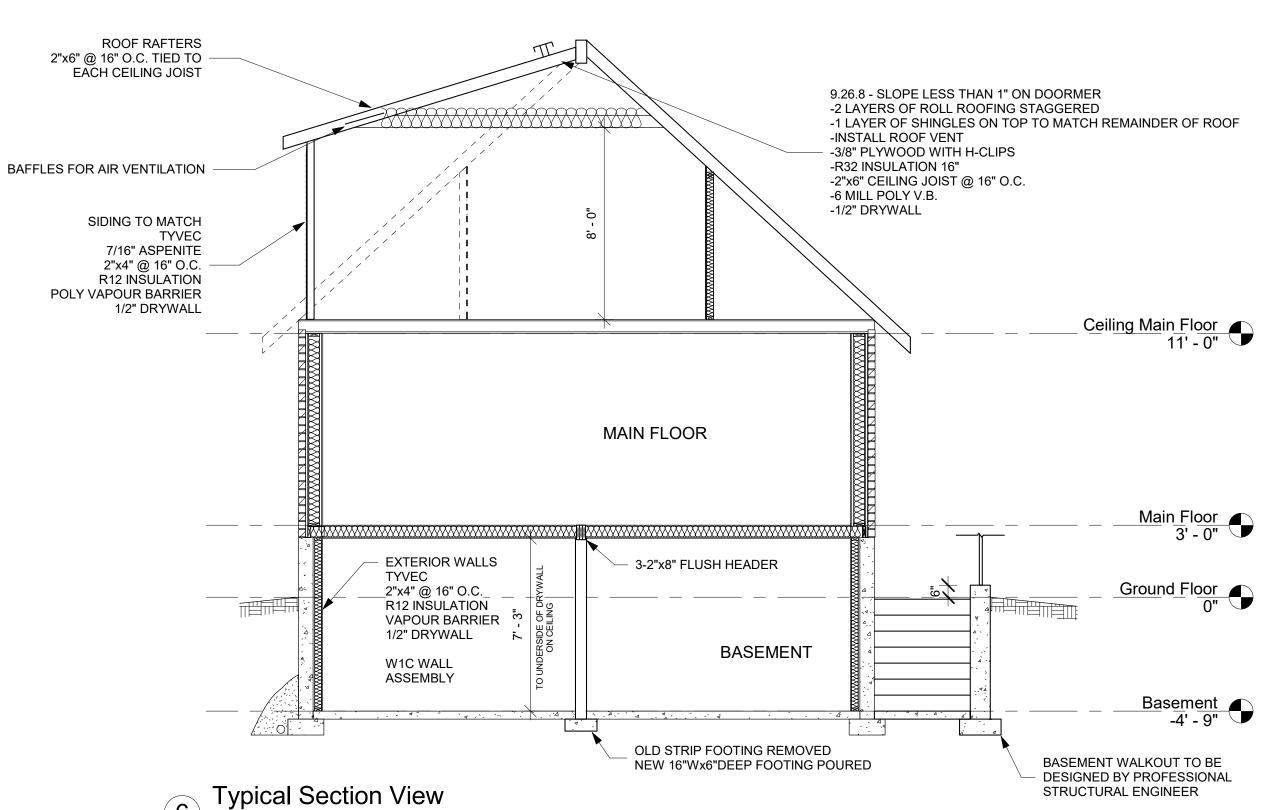

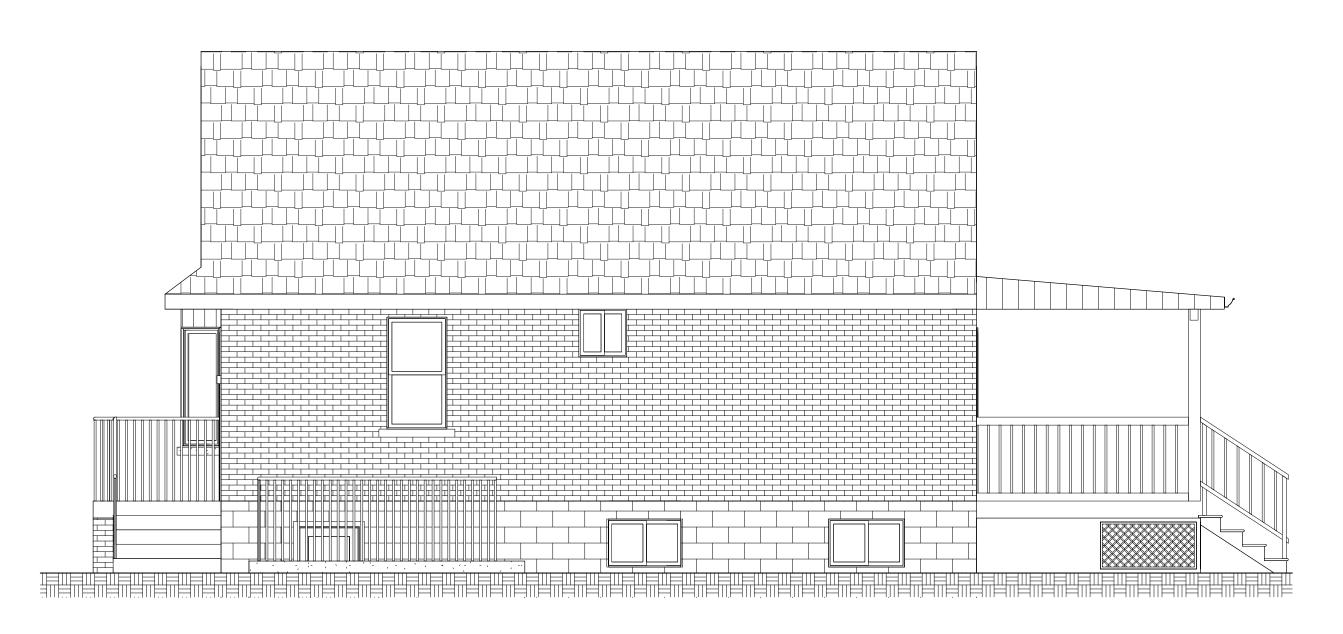



CONTRACTOR MUST VERIFY AND ACCEPT RESPONSIBILITY FOR ALL DIMENSIONS AND CONDITIONS ON THE JOB AND MUST REPORT ANY DISCREPANCIES TO THE DESIGNER BEFORE PROCEEDING WITH WORK. ALL CHANGES MUST BE AUTHORIZED & APPROVED BY THE DESIGNER.

> jk Home & Commercial Inspection Services www.jkinspectionservices.ca 25Yrs Experience as a City Building Inspector BCIN # 21234 (Building Code Identification Number) John Kedzierski (Owner) 113 Windward St., St. Catharine's ON L2M 4C4 Call: 905-325-INSP(4677)



175 Montrose Av., Hamilton, ON

Revision Schedule Sept. 2,2020 Totally Revised

FOR PERMIT BUILDING 9/3/2020 12:24:22 PM


PROJECT NAME:

PROPOSED BASEMENT **APARTMENT**

SHEET TITLE:

SECTION AND **ELEVATIONS**

JOB: 00000 SCALE: As indicated SHEET No. 3-3

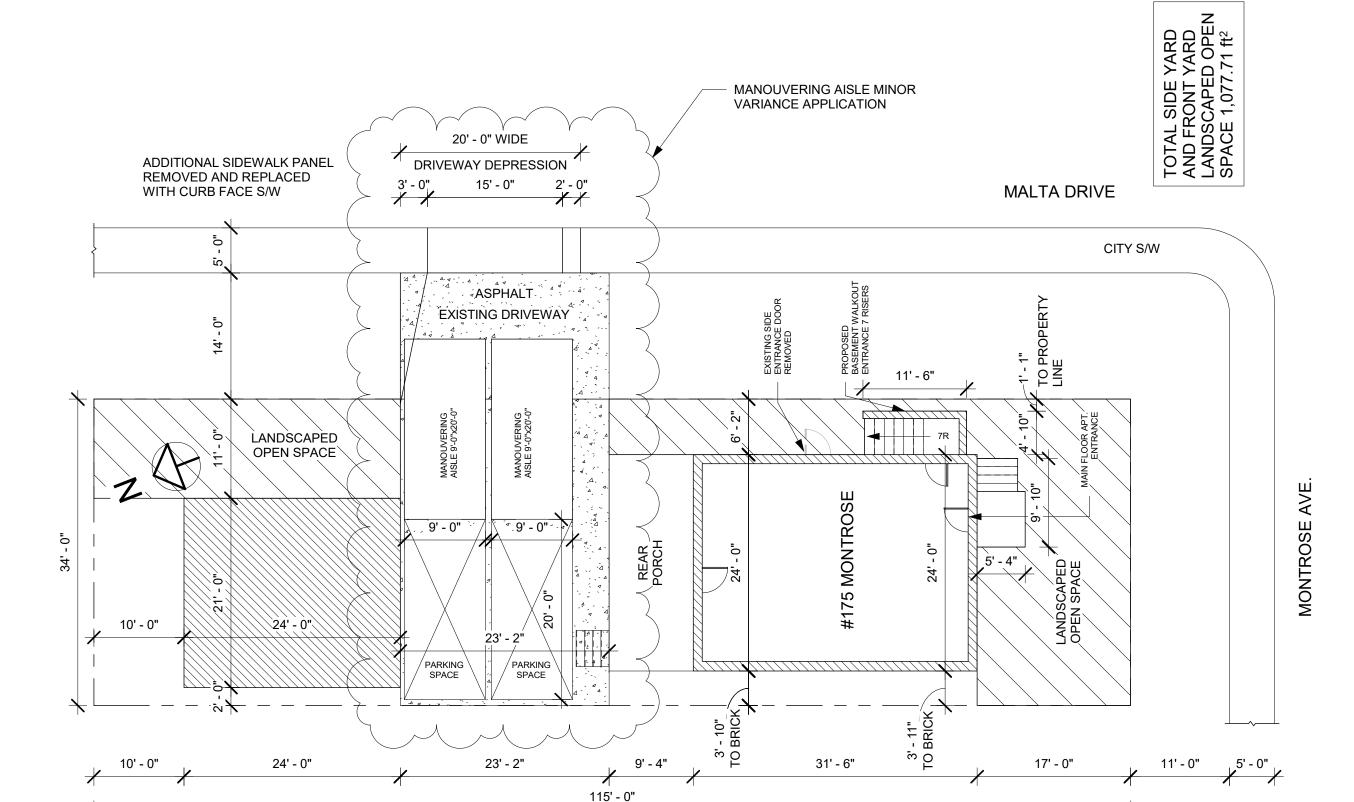

1 Plot Plan 3/32" = 1'-0"







J		_
DATE	SEPT.2, 2020	
REV.#	_	
Drawn by D.C.	Date Issue Date	