COMMITTEE OF ADJUSTMENT



City Hall, 5th floor, 71 Main Street West, Hamilton, ON L8P 4Y5 Telephone (905) 546-2424, ext. 4221, 3935 Fax (905) 546-4202

E-mail: cofa@hamilton.ca

NOTICE OF PUBLIC HEARING Minor Variance

You are receiving this notice because you are either:

- Assessed owner of a property located within 60 metres of the subject property
- Applicant/agent on file, or
- Person likely to be interested in this application

APPLICATION NO.: AN/A-21:42

APPLICANTS: Zoltan Engineering on behalf of the owner George Varga

SUBJECT PROPERTY: Municipal address 193 Colleen Cres., Ancaster

ZONING BY-LAW: Zoning By-law 87-57, as Amended

ZONING: "ER' (Existing Residential) district

PROPOSAL: To permit the construction of a new 5.0m² addition and a new 53.4m²

attached garage in the front yard of the existing detached dwelling

notwithstanding that:

1. A front yard setback of 18.7m shall be provided instead of the maximum permitted front yard setback of 15.8m.

This application will be heard by the Committee as shown below:

DATE: Thursday, March 4th, 2021

TIME: 3:25 p.m.

PLACE: Via video link or call in (see attached sheet for details)

To be streamed at

www.hamilton.ca/committeeofadjustment

for viewing purposes only

PUBLIC INPUT

Written: If you would like to submit written comments to the Committee of Adjustment you may do so via email or hardcopy. Please see attached page for complete instructions, including deadlines for submitting to be seen by the Committee.

Orally: If you would like to speak to this item at the hearing you may do so via video link or by calling in. Please see attached page for complete instructions, including deadlines for registering to participate.

MORE INFORMATION

For more information on this matter, including access to drawings illustrating this request:

- Visit www.hamilton.ca/committeeofadjustment
- Call 905-546-CITY (2489) or 905-546-2424 extension 4221, 4130, or 3935

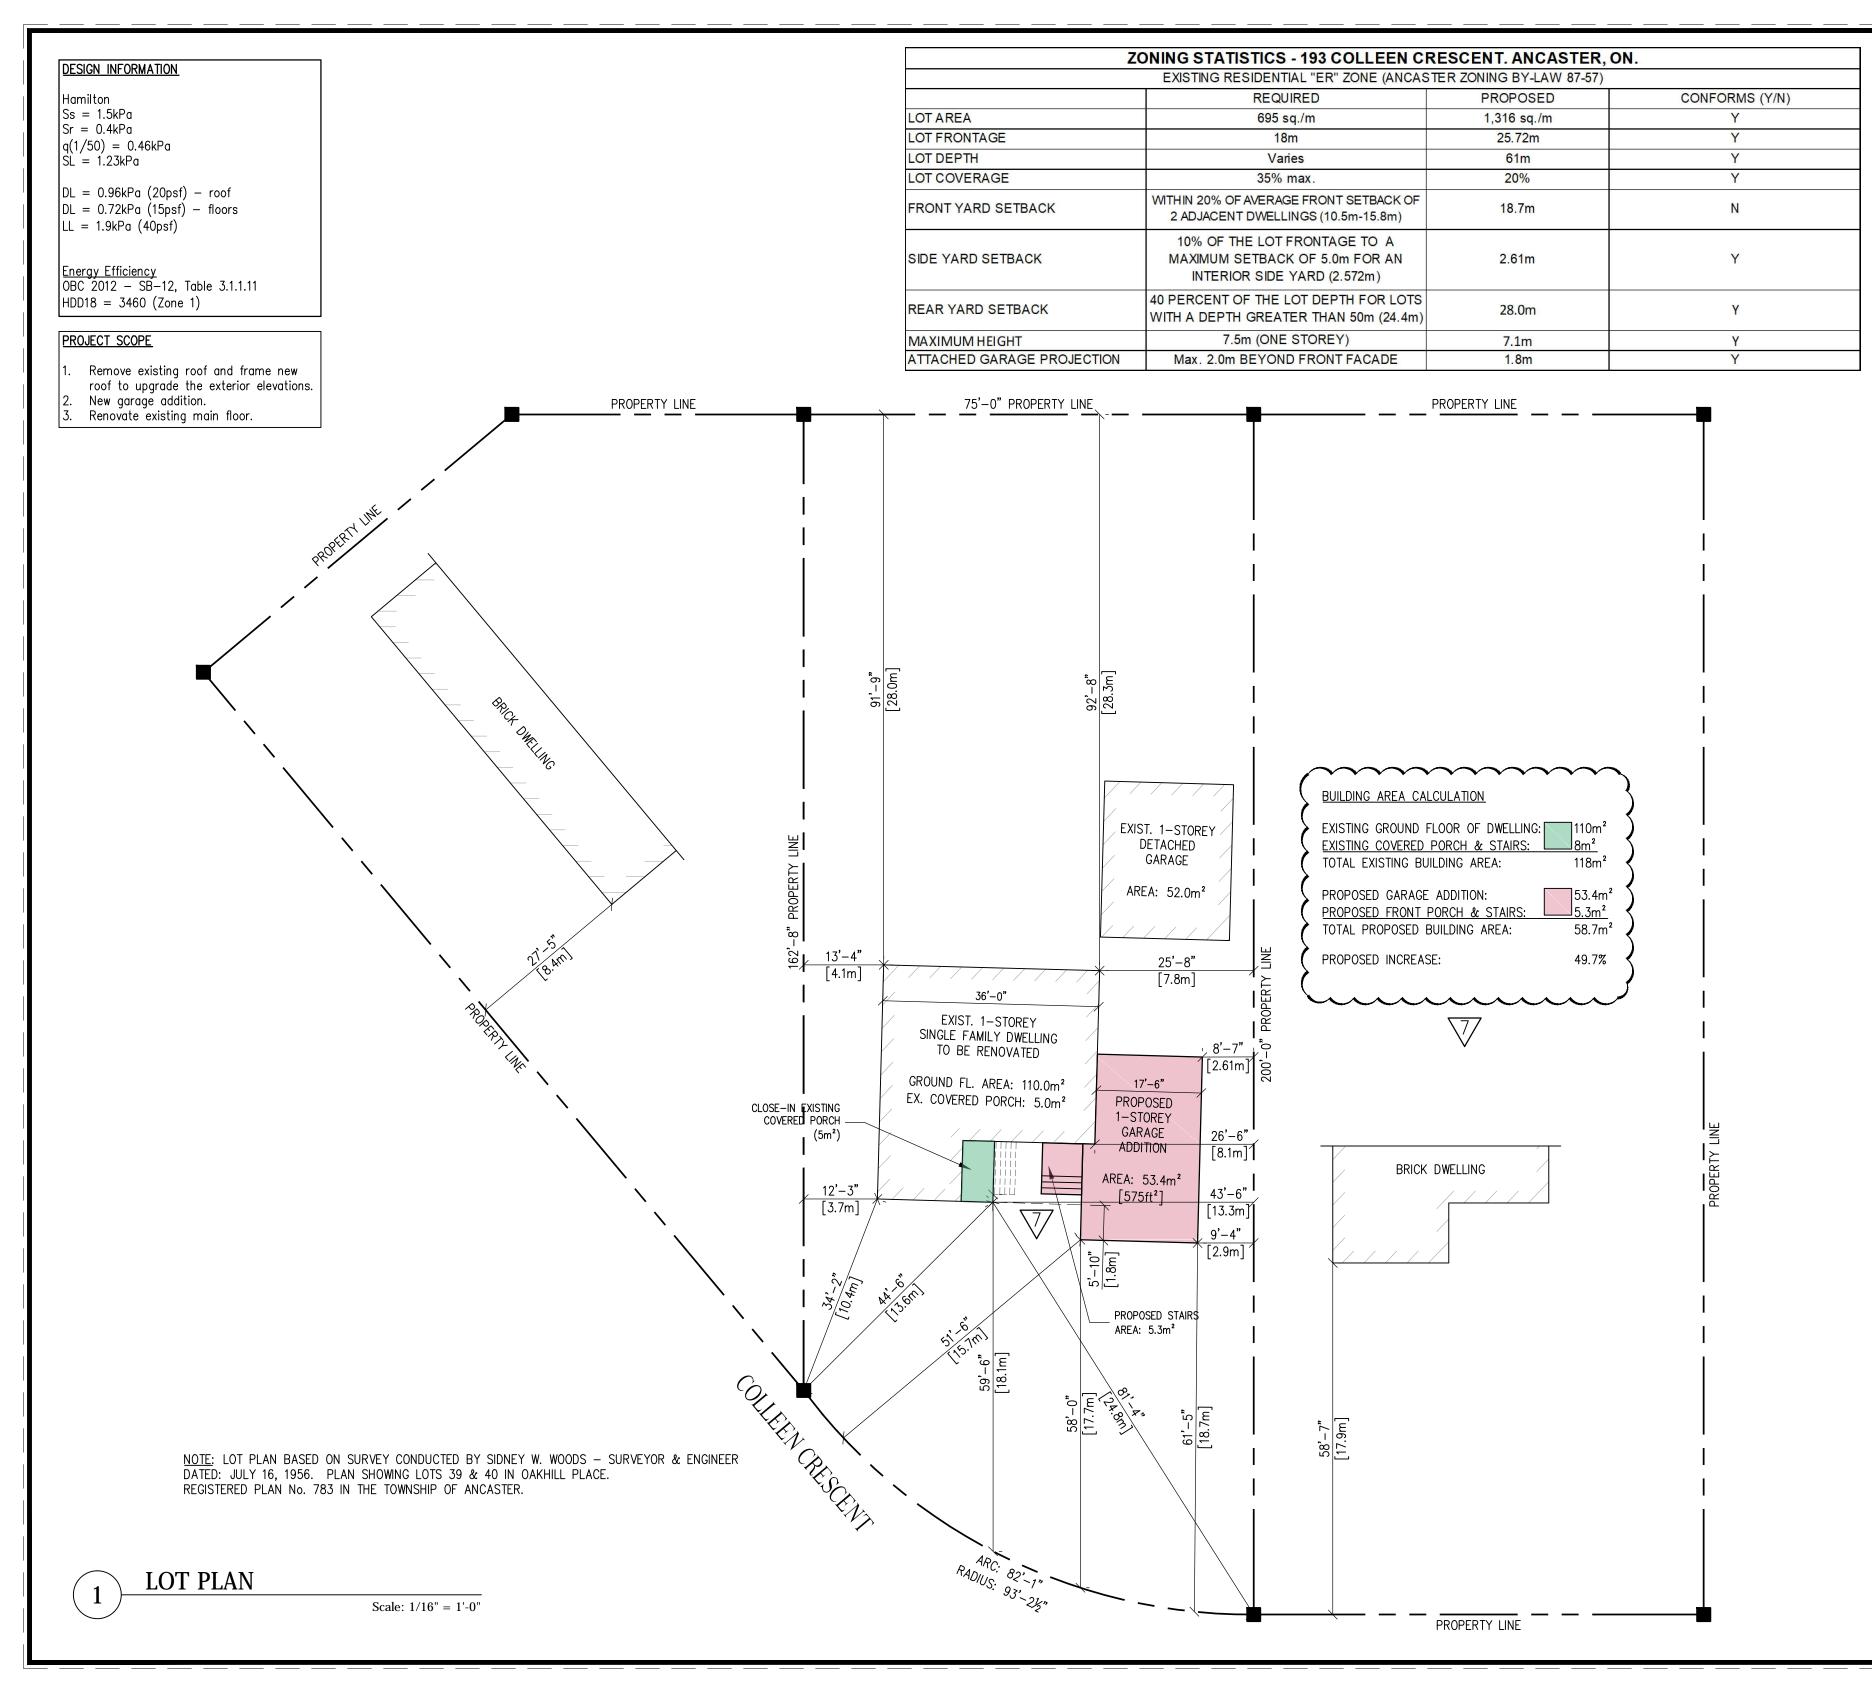
AN/A-21: 42 Page 2

• Email Committee of Adjustment staff at cofa@hamilton.ca

DATED: February 16th, 2021.

Jamila Sheffield, Secretary-Treasurer Committee of Adjustment

Information respecting this application is being collected under the authority of the Planning Act, R.S.O., 1990, c. P. 13. All comments and opinions submitted to the City of Hamilton on this matter, including the name, address, and contact information of persons submitting comments and/or opinions, will become part of the public record and will be made available to the Applicant and the general public.



DO NOT SCALE DRAWINGS. THE CONTRACTOR SHALL CHECK AND VERIFY ALL DIMENSIONS AND REPORT ANY ERRORS AND OMISSIONS TO THE ENGINEER. THIS DRAWING IS NOT TO BE USED FOR CONSTRUCTION UNLESS MARKED AS "ISSUED FOR CONSTRUCTION", CERTIFIED AND DATED.

7	11JAN21	REVISED PER COMMENTS
6	03DEC20	REVISED LOT PLAN
5	16NOV20	REVISED LOT PLAN
REV.	DATE	REMARKS

ZOLTAN ENGINEERING

25-4380 SOUTH SERVICE ROAD BURLINGTON, ON L7L 5Y6 (905) 331 - 8307 WWW.ZOLTANENGINEERING.COM

PROJECT TITLE

VARGA RESIDENCE ADDITION & RENOVATION

193 COLLEEN CRESCENT ANCASTER, ON, L9G 1J2

DRAWING TITLE

LOT PLAN

SCALE AS NOTED

DATE 11JAN21

DRAWN TV

DESIGNED ZL

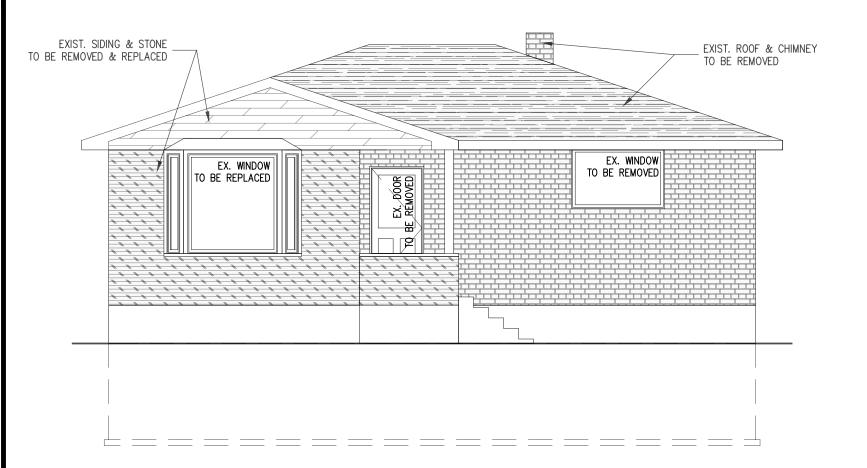
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PROJECT NO.

SHEET NO.

19-290



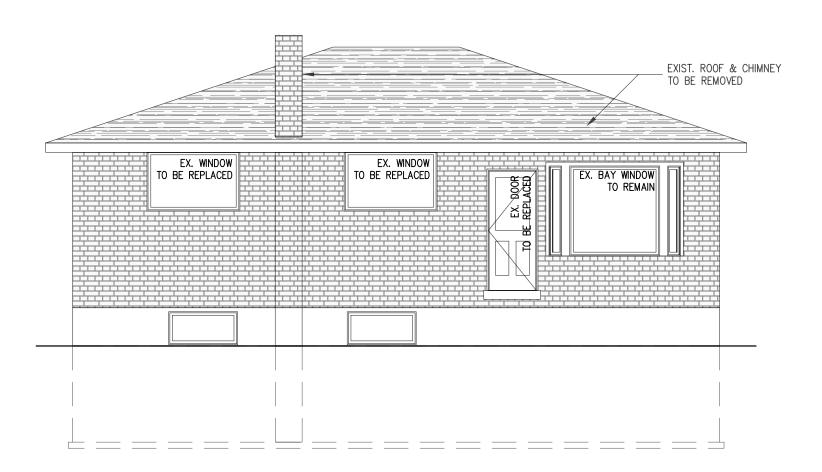
EXIST. ROOF & CHIMNEY TO BE REMOVED

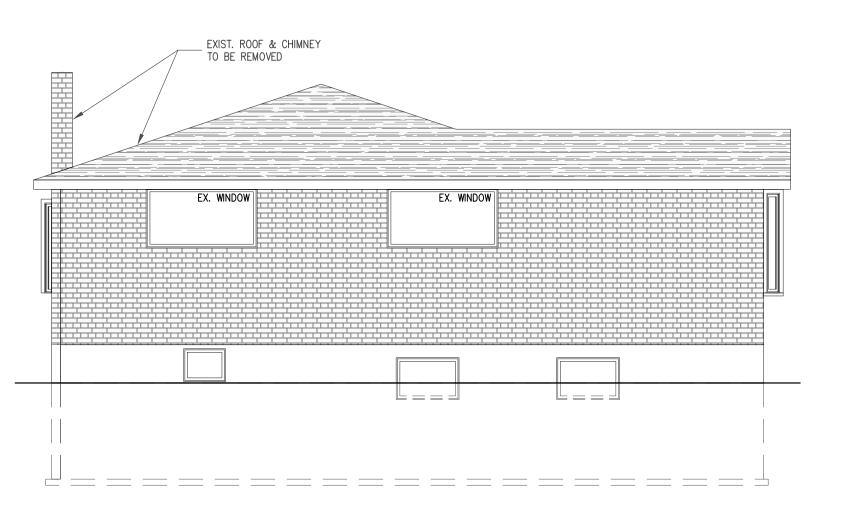
EX. FRONT ELEVATION

Scale: 3/16" = 1'-0"

EX. SIDE ELEVATION

Scale: 3/16" = 1'-0"





3 EX. REAR ELEVATION
Scale: 3/16"

EX. SIDE ELEVATION

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DRAWING TITLE

EXISTING ELEVATIONS

SCALE AS NOTED

DATE 11JAN21

DRAWN TV

DESIGNED ZL

CHECKED ZL

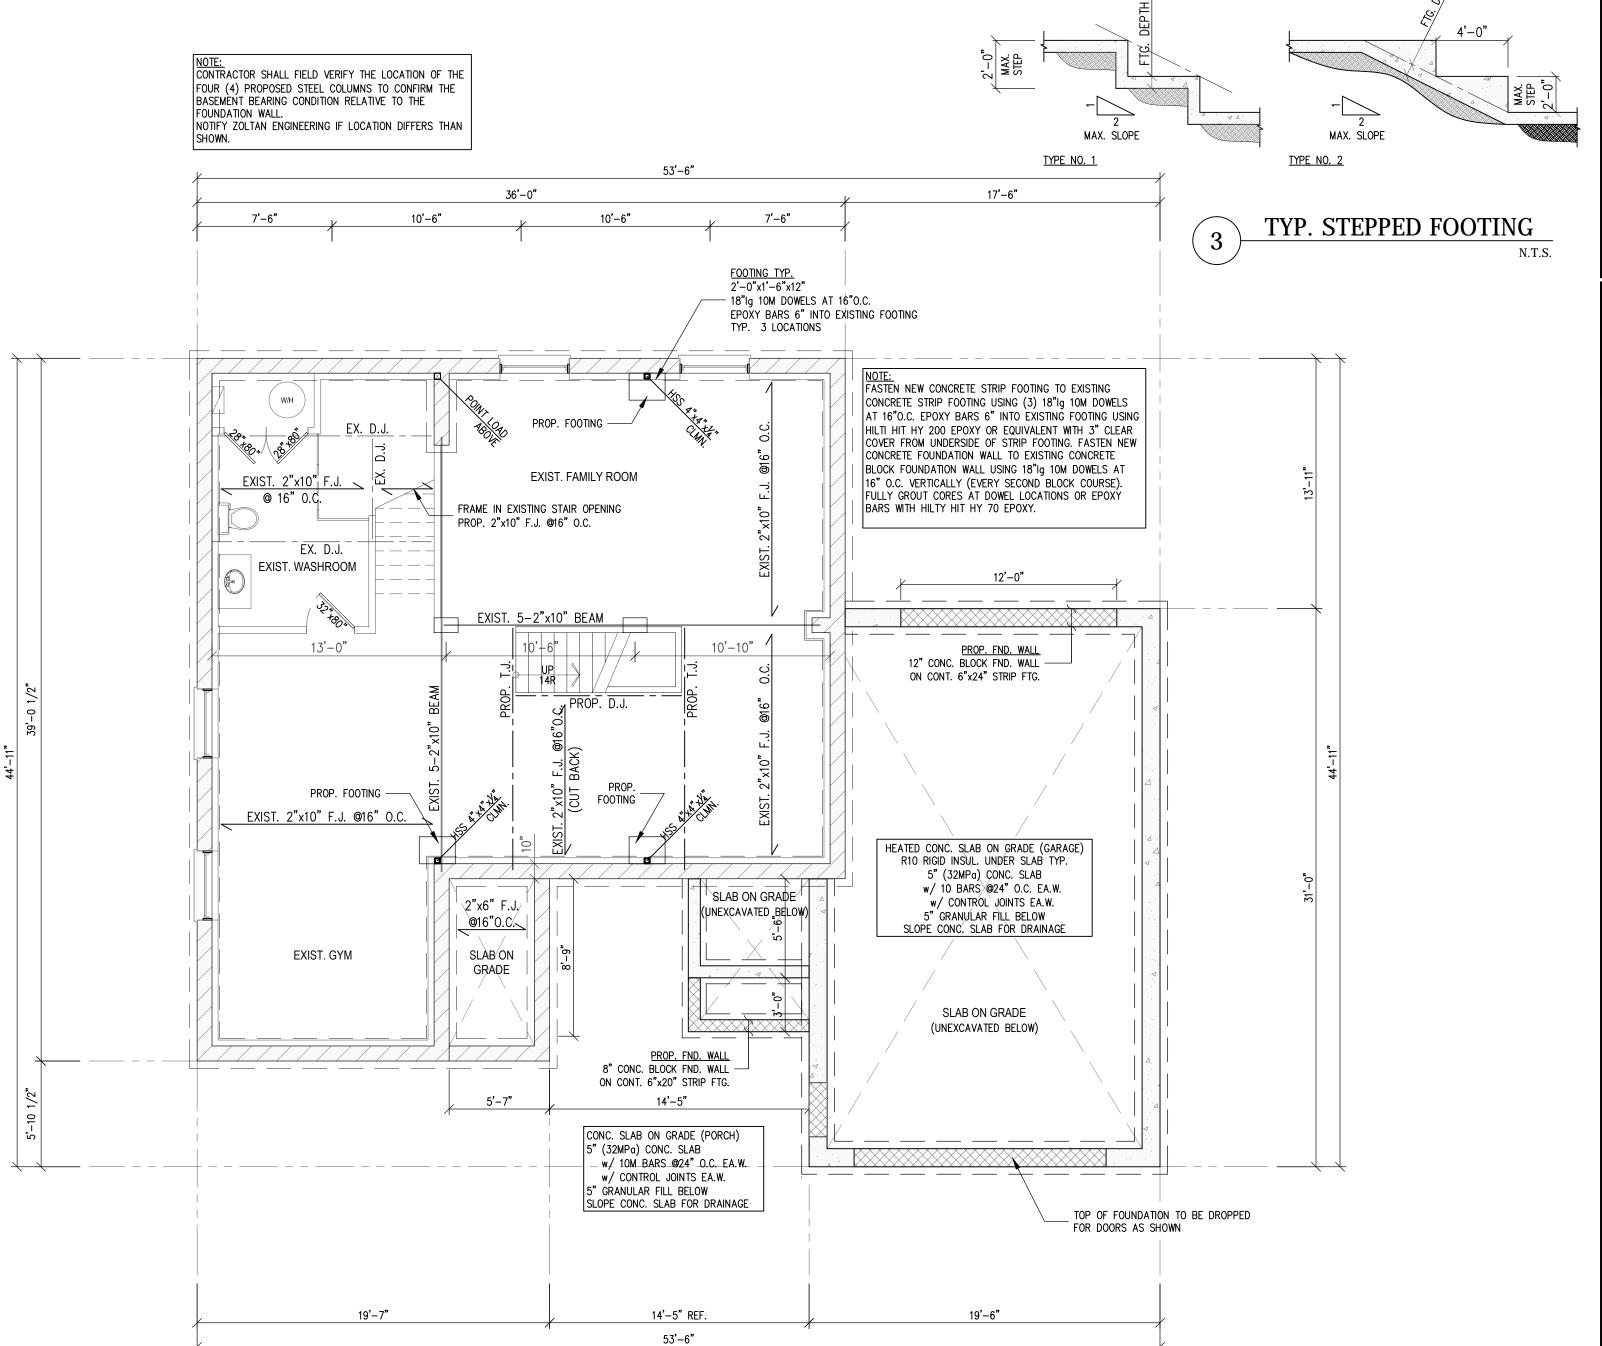


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193 COLLEEN CRESCENT ANCASTER, ON, L9G 1J2

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PROP. FOUNDATION PLAN

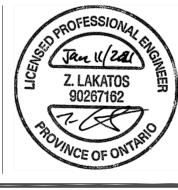
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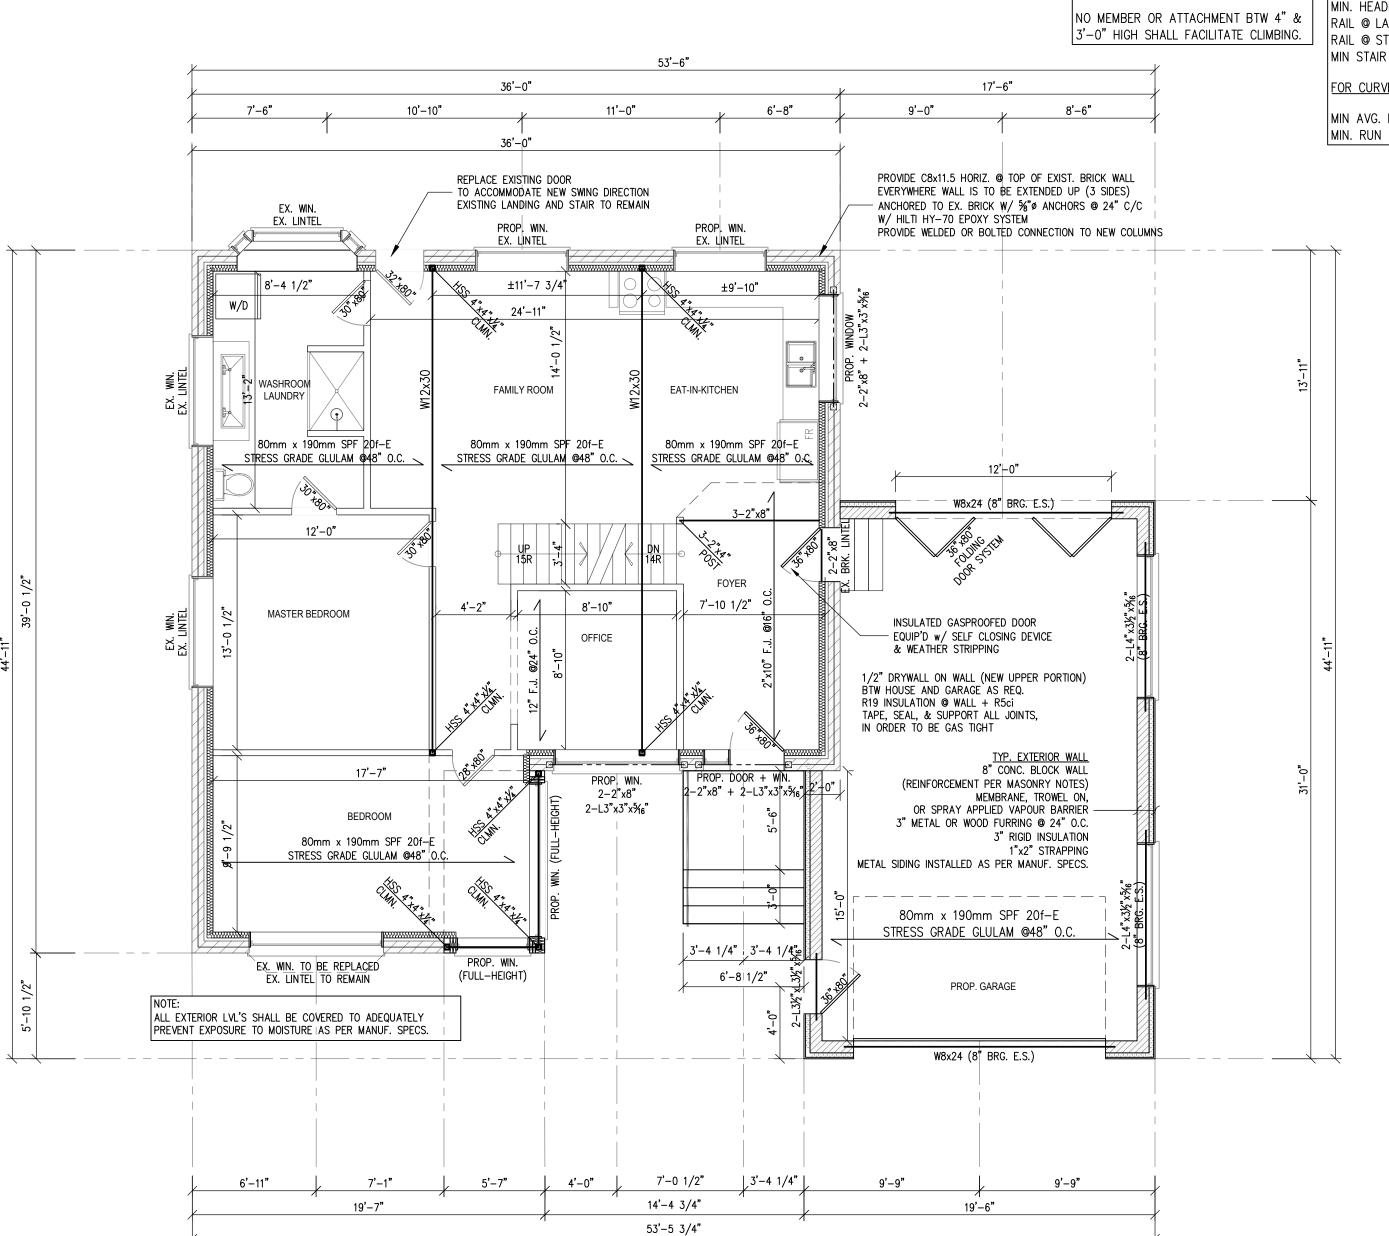
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-7½" -8¼" MAX RISE MIN. RUN -9¼" -1" MIN. TREAD MAX. NOSING MIN. HEADROOM -6'-5"RAIL @ LANDING -2'-11" RAIL @ STAIR -2'-8" MIN STAIR WIDTH -2**'**-10**"**

FOR CURVED STAIRS

GUARDS - 0.B.C. 9.8.8.

FINISHED RAILING PICKETS SPACED

MAXIMUM 4" BETWEEN PICKETS

INTERIOR GUARDS:

EXTERIOR GUARDS:

3'-0" MIN.

3'-6" MIN.

-6" MIN AVG. RUN -8"

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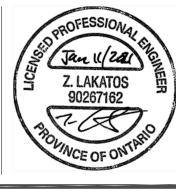
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193 COLLEEN CRESCENT ANCASTER, ON, L9G 1J2

DRAWING TITLE

PROP. GROUND FLOOR PLAN

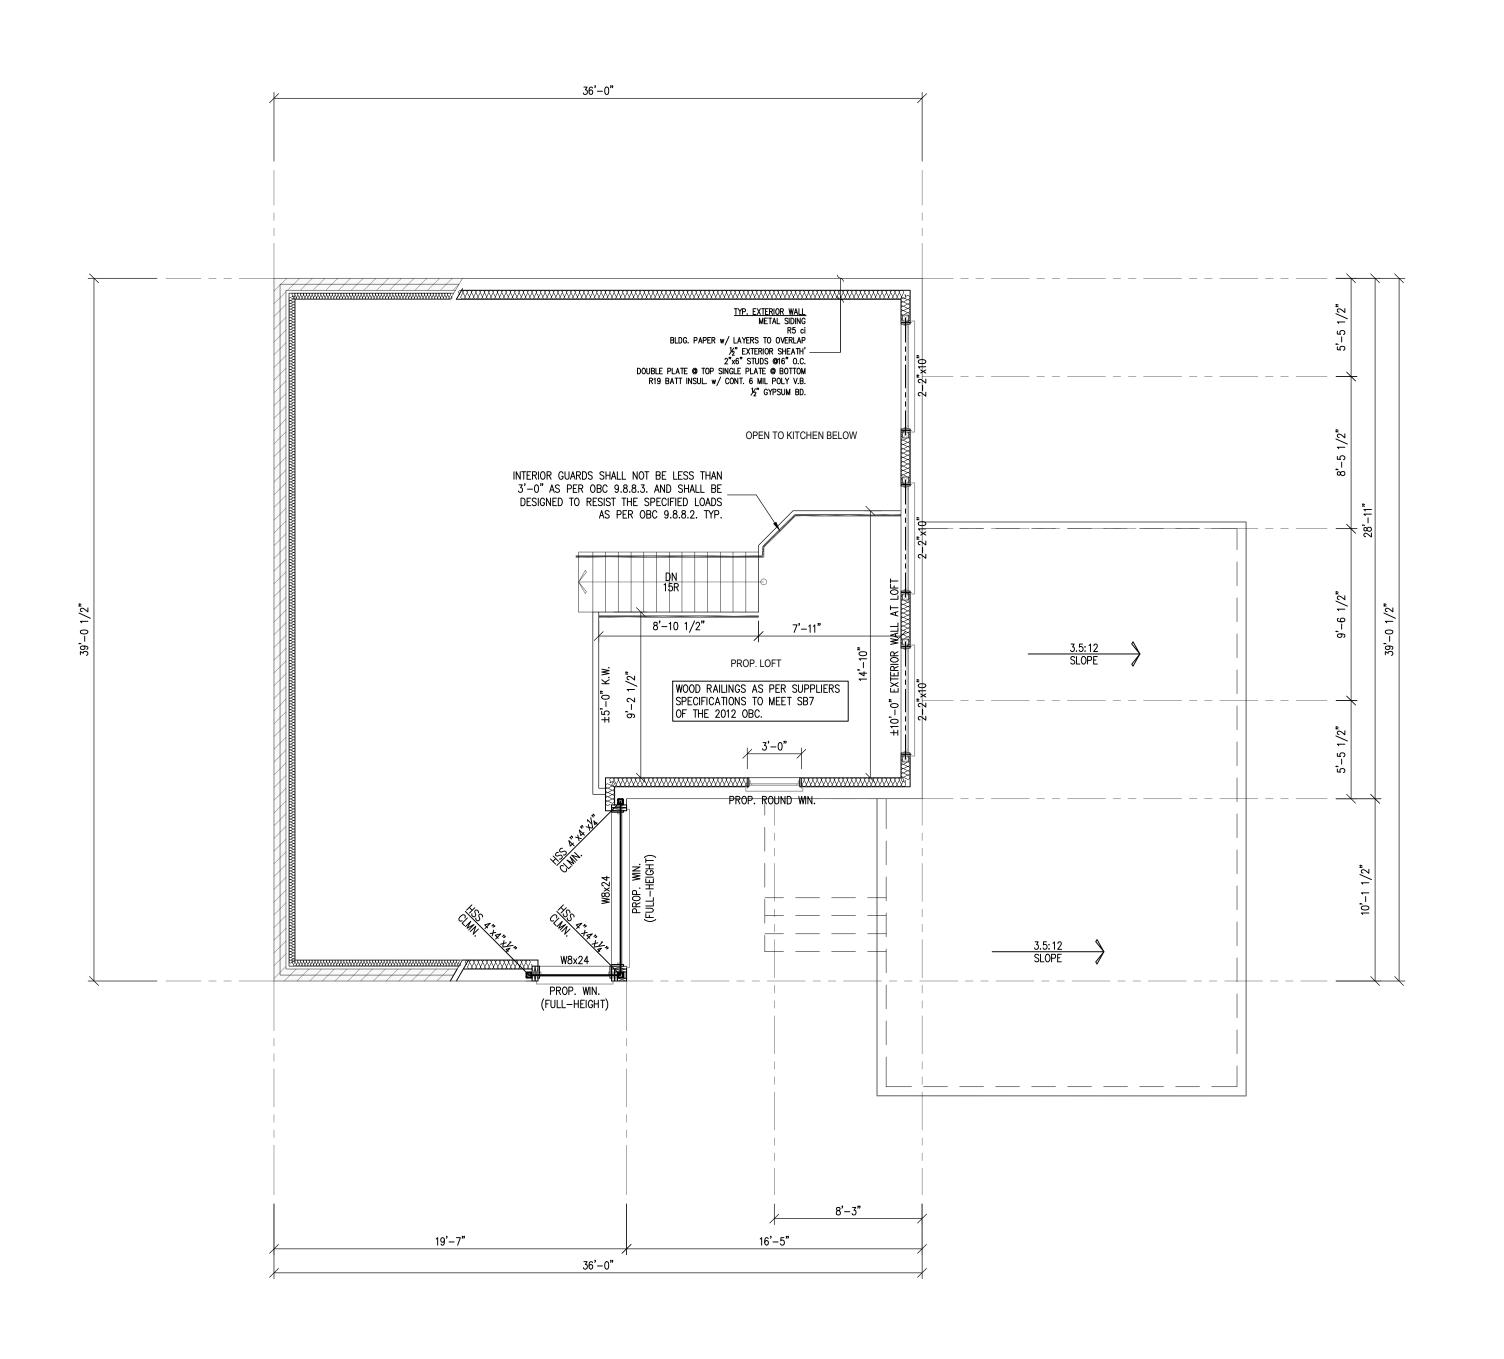
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PROP. LOFT PLAN

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DATE 11JAN21

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DESIGNED ZL

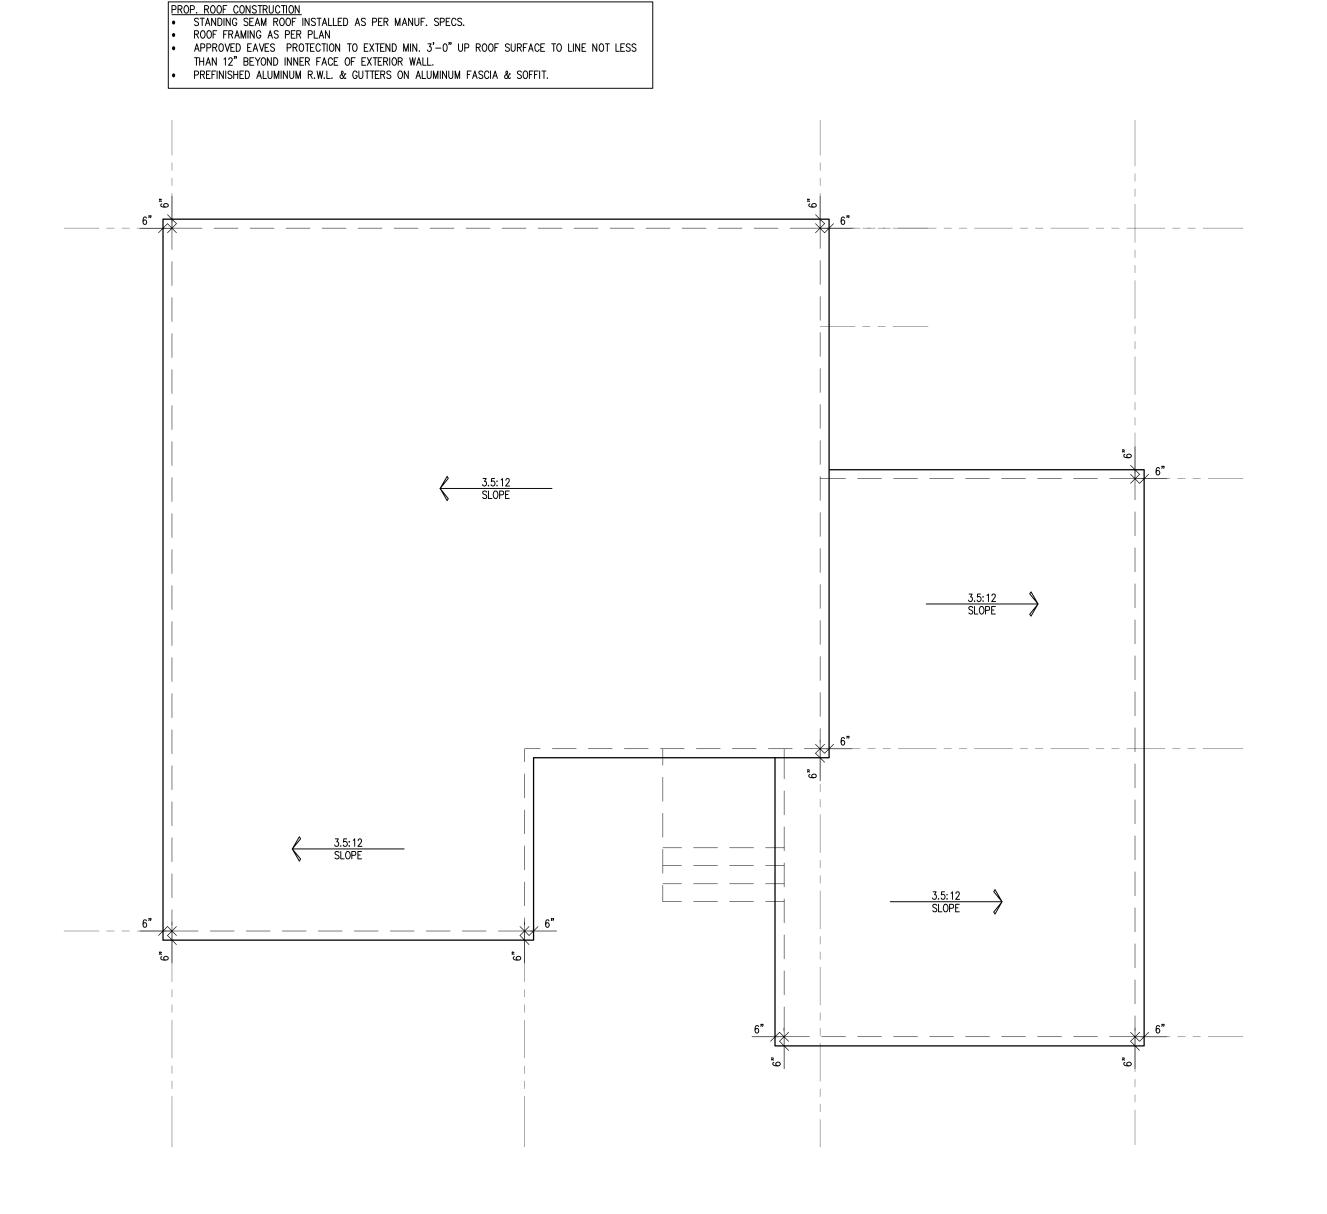
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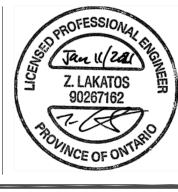
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193 COLLEEN CRESCENT ANCASTER, ON, L9G 1J2

DRAWING TITLE

PROP. ROOF PLAN

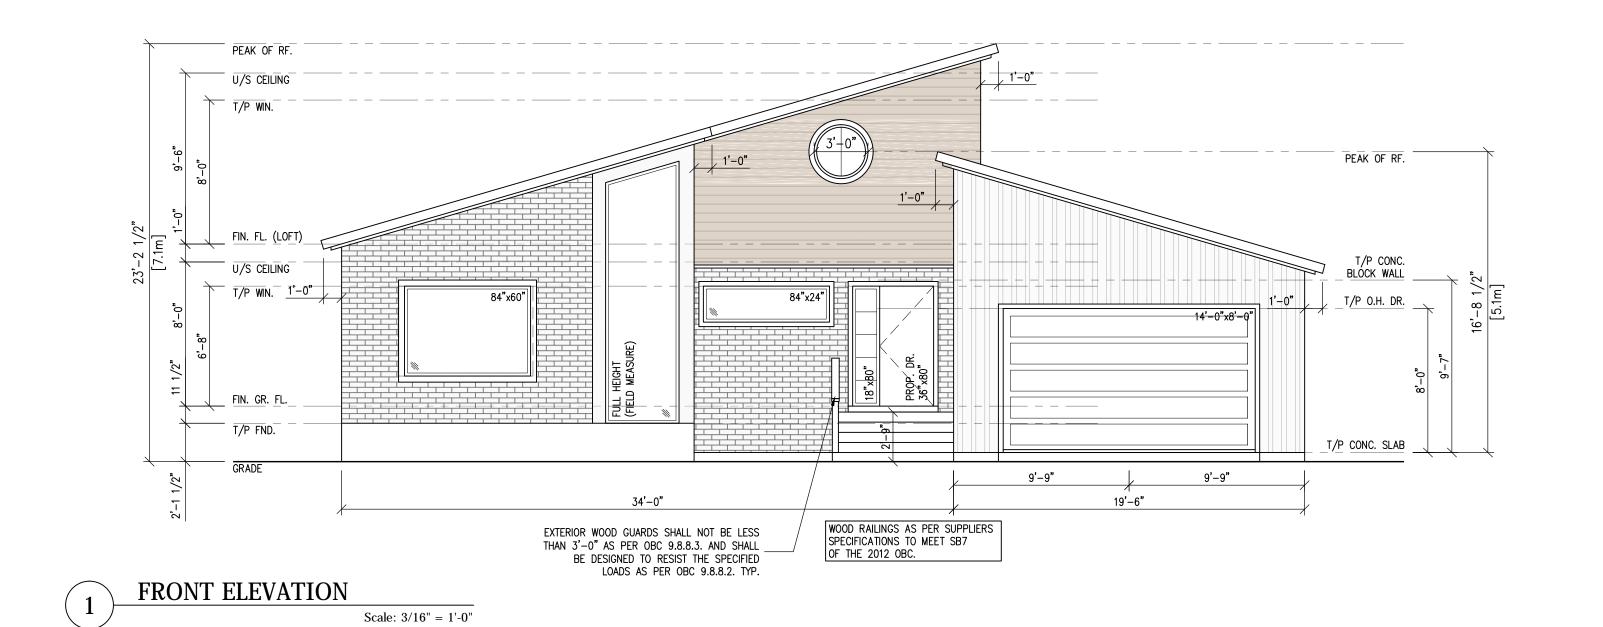
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REAR ELEVATION

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193 COLLEEN CRESCENT ANCASTER, ON, L9G 1J2

DRAWING TITLE

FRONT & REAR ELEVATIONS

SCALE AS NOTED

DATE 11JAN21

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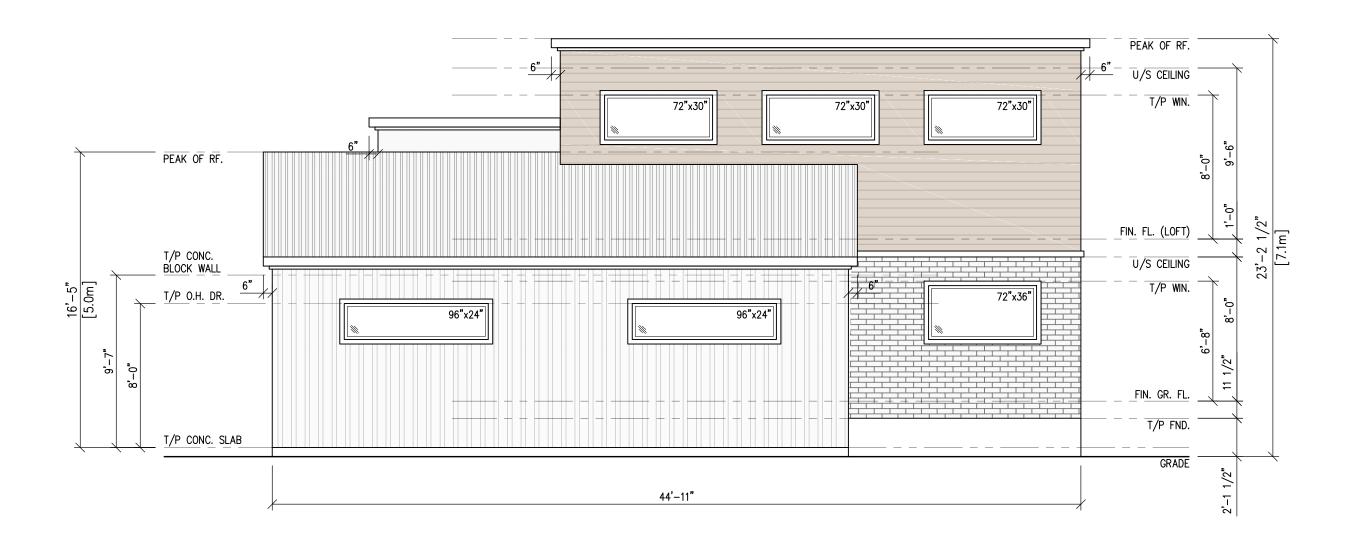
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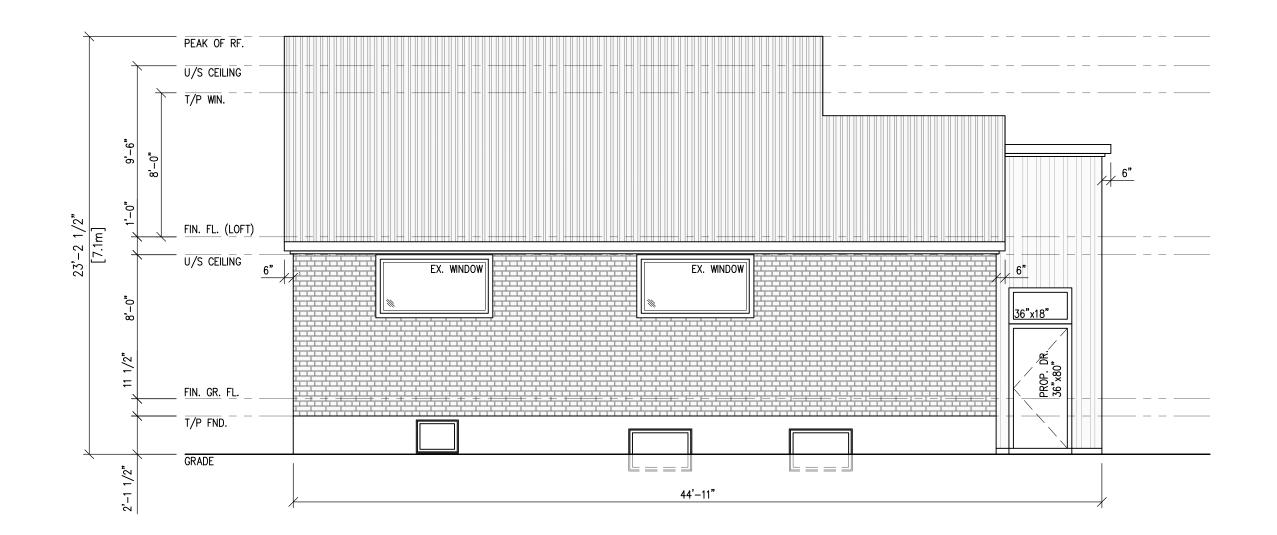
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SIDE ELEVATION

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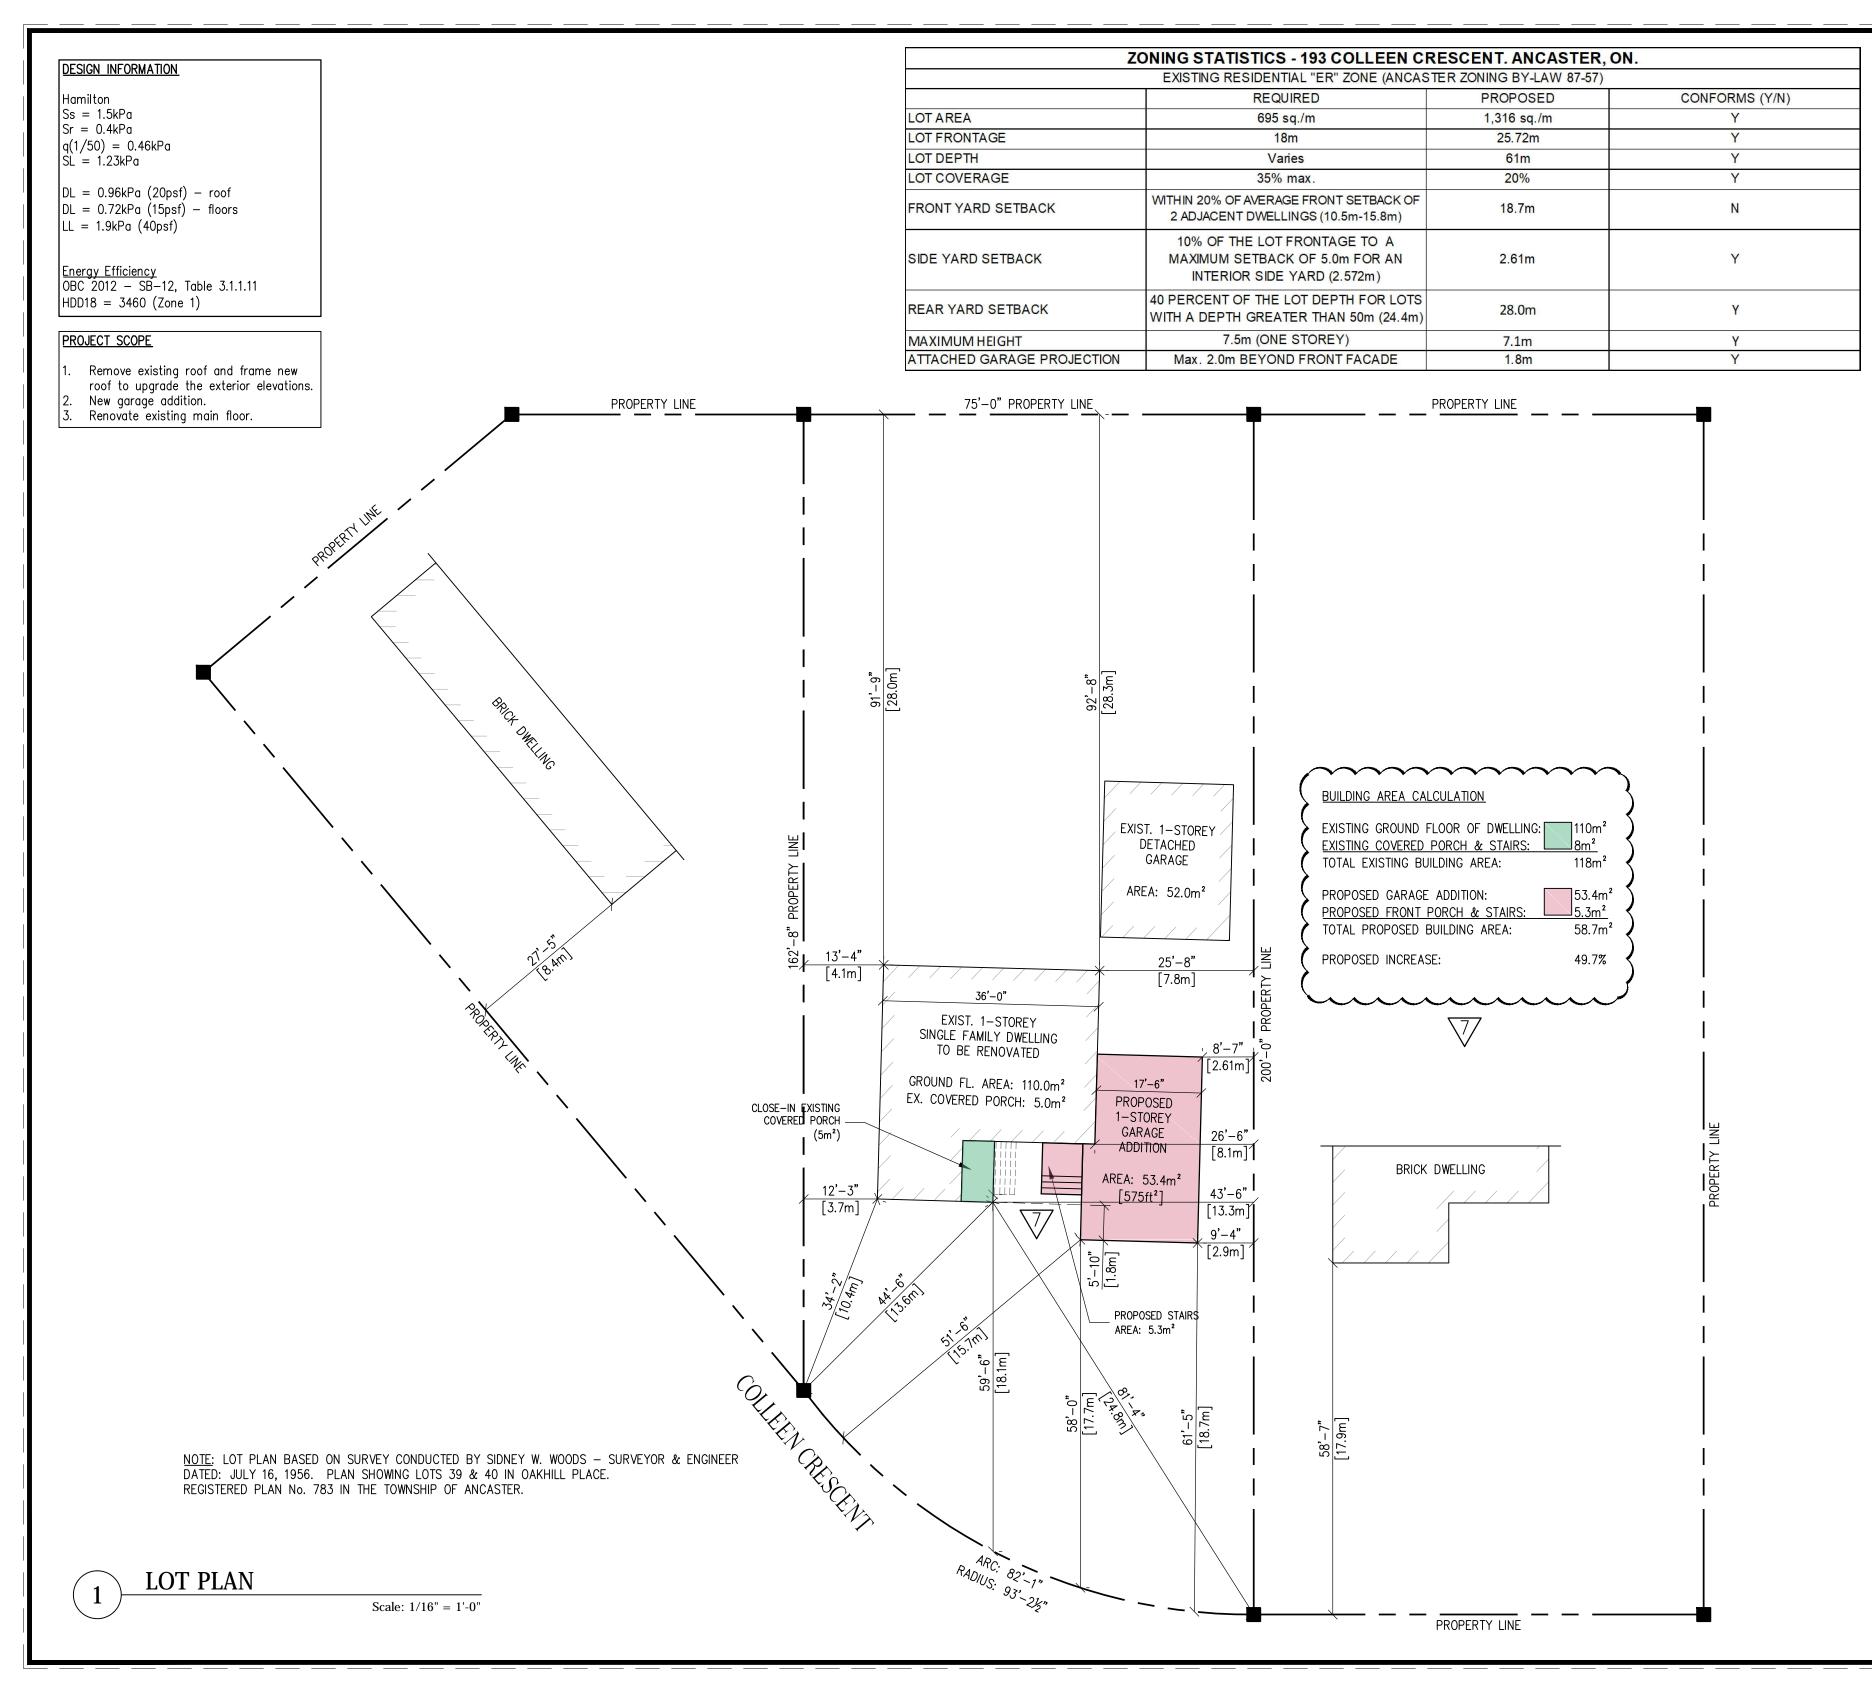
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193 COLLEEN CRESCENT ANCASTER, ON, L9G 1J2

DRAWING TITLE

LOT PLAN

SCALE AS NOTED

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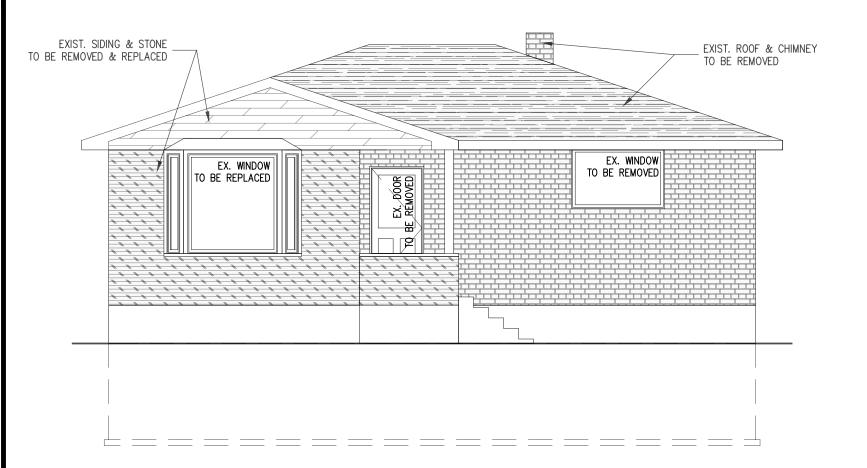
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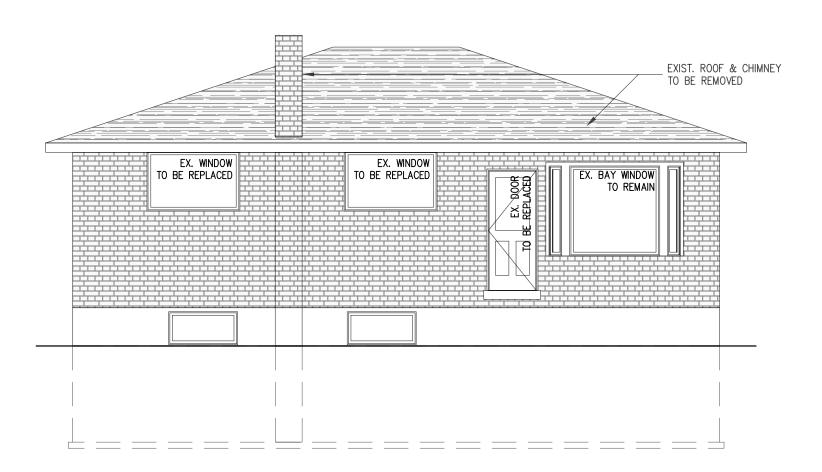
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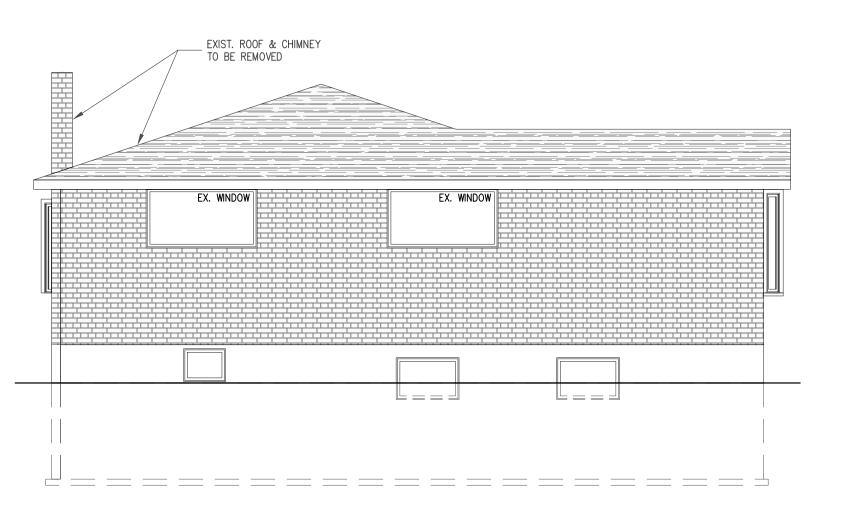
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193 COLLEEN CRESCENT ANCASTER, ON, L9G 1J2

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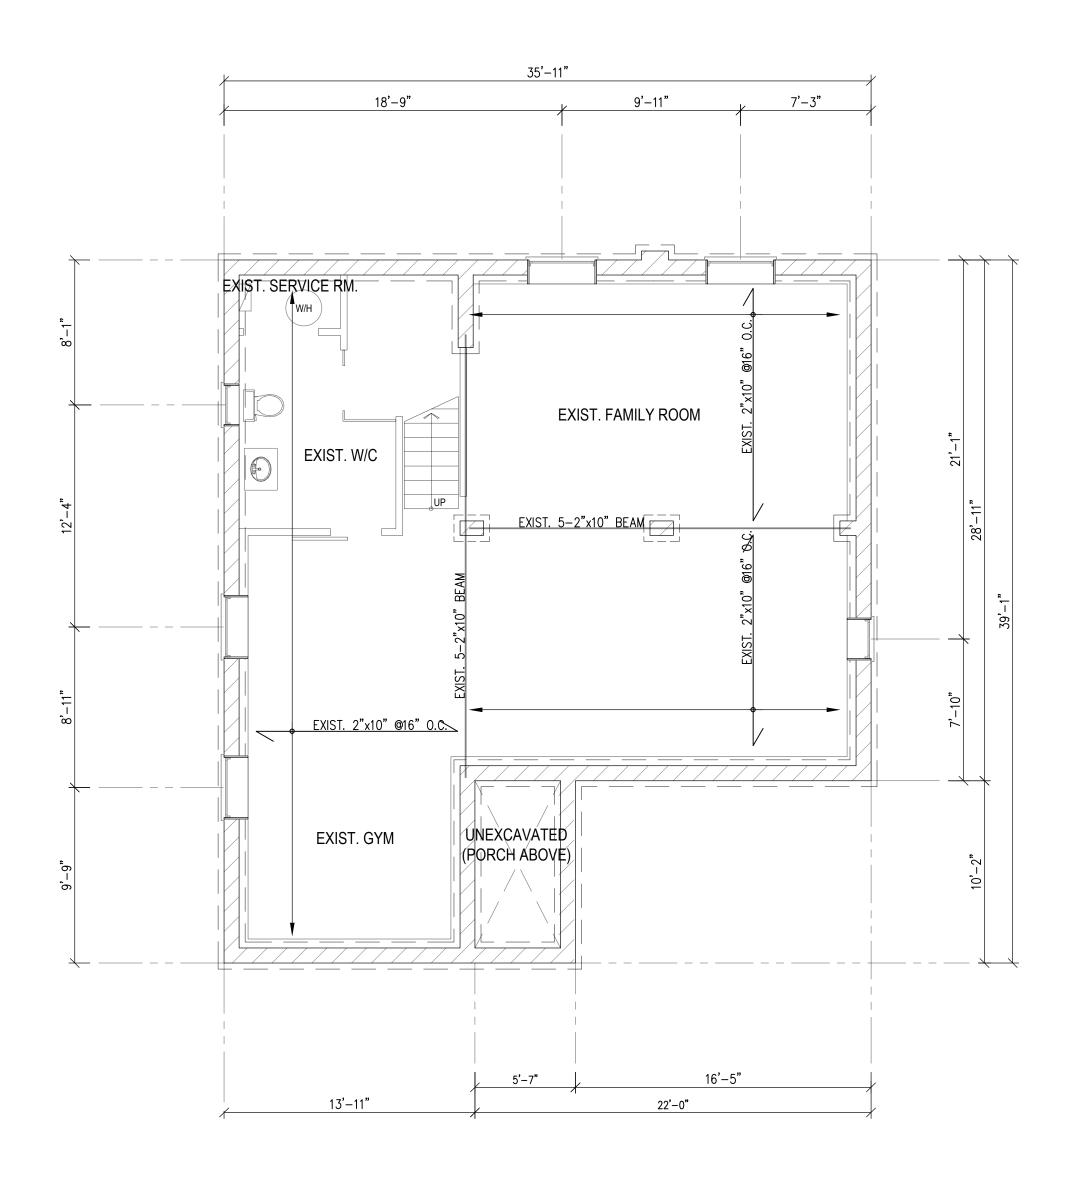


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193 COLLEEN CRESCENT ANCASTER, ON, L9G 1J2

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EXISTING BASEMENT PLAN

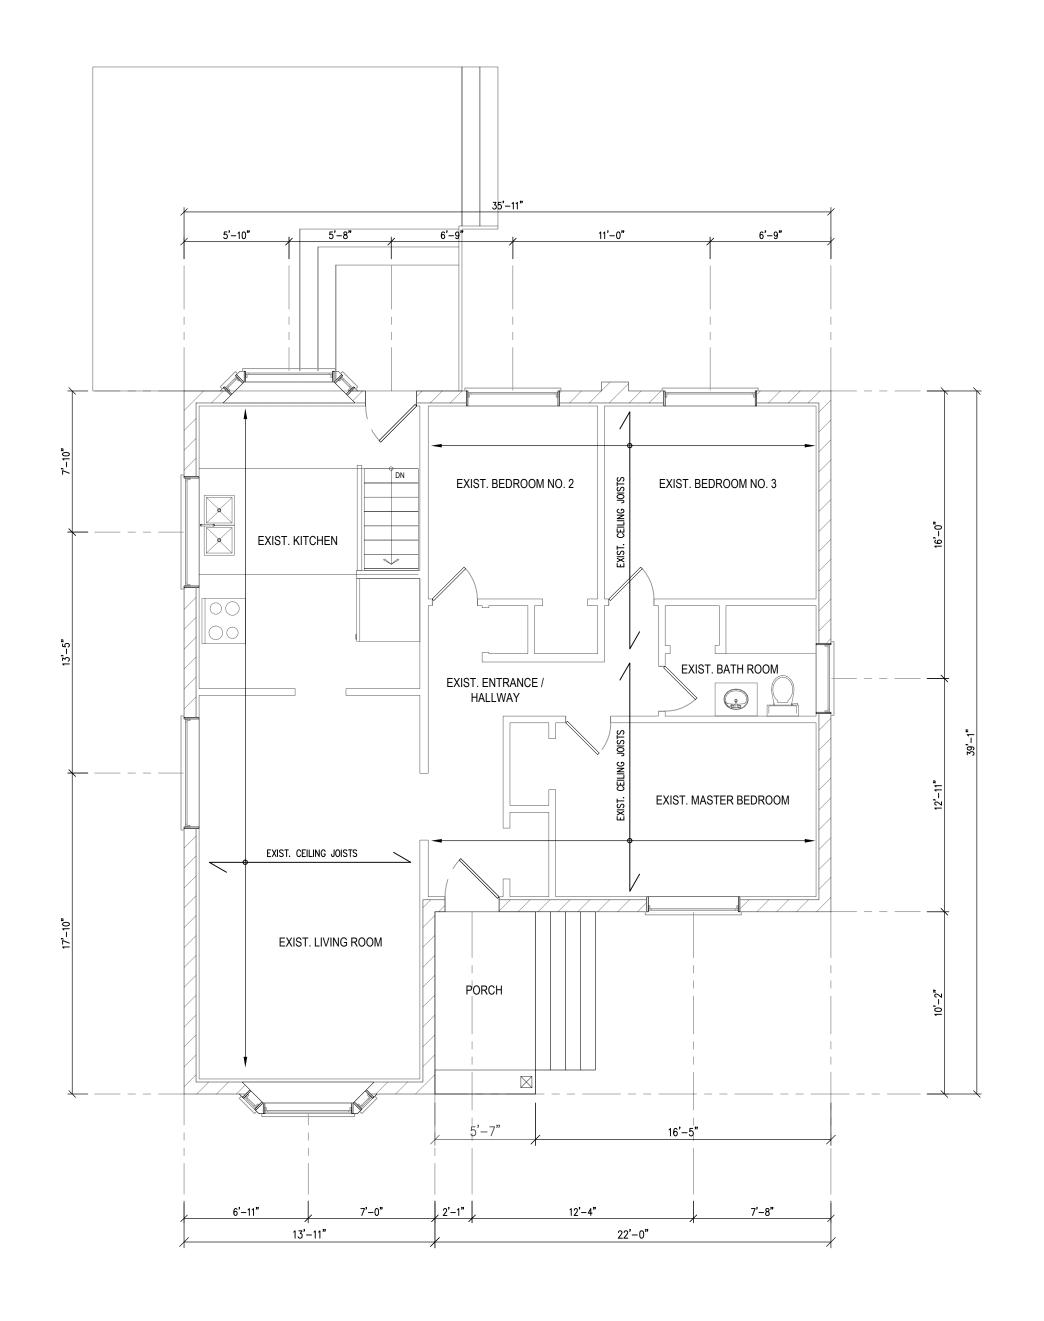
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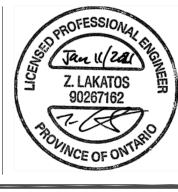
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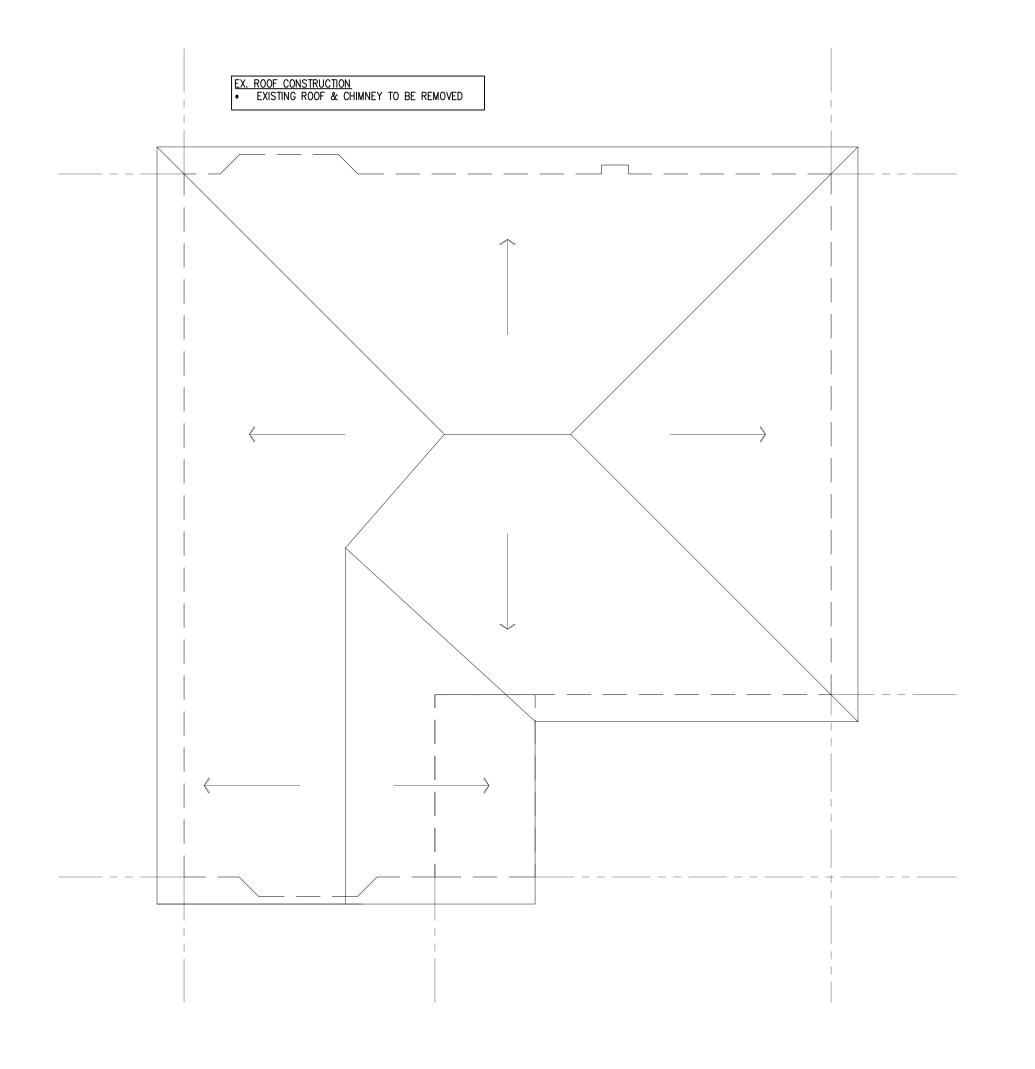
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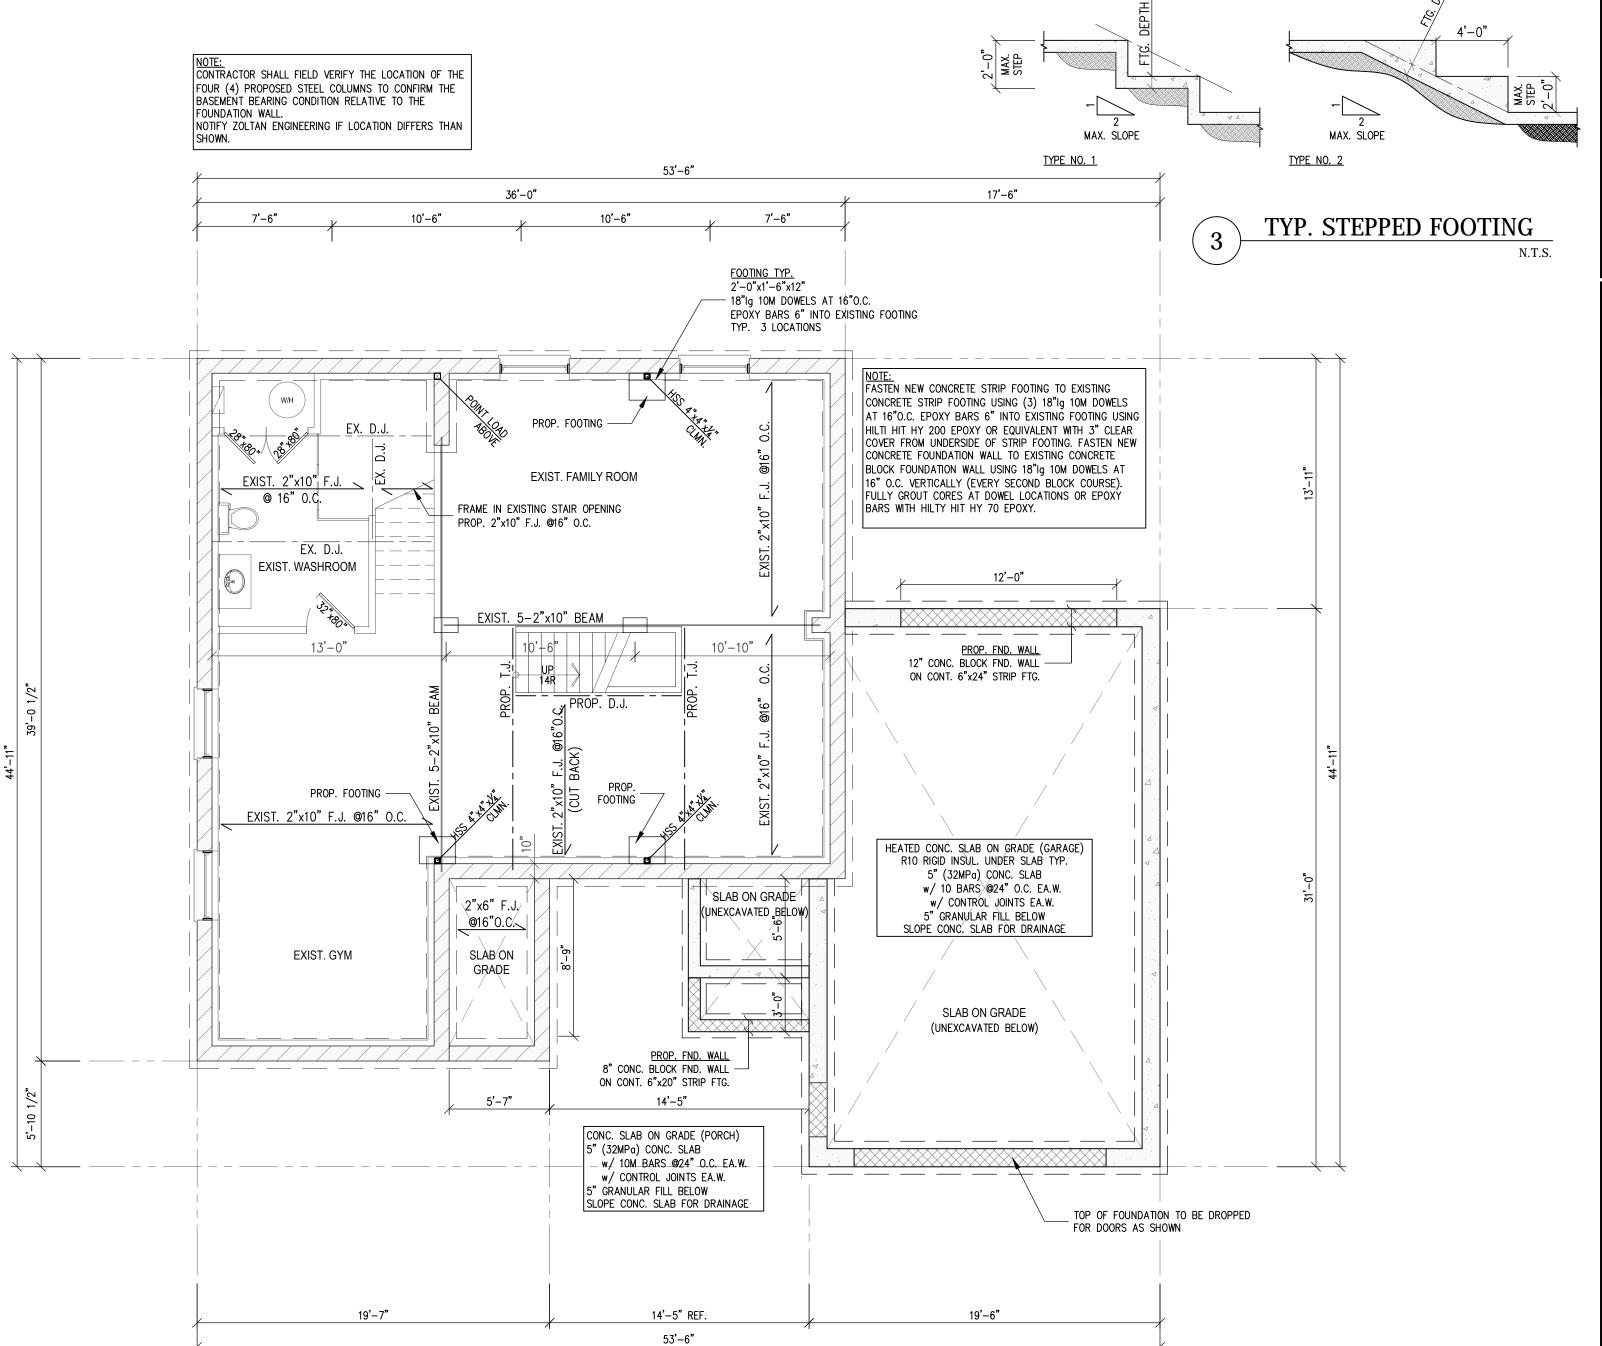
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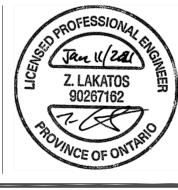
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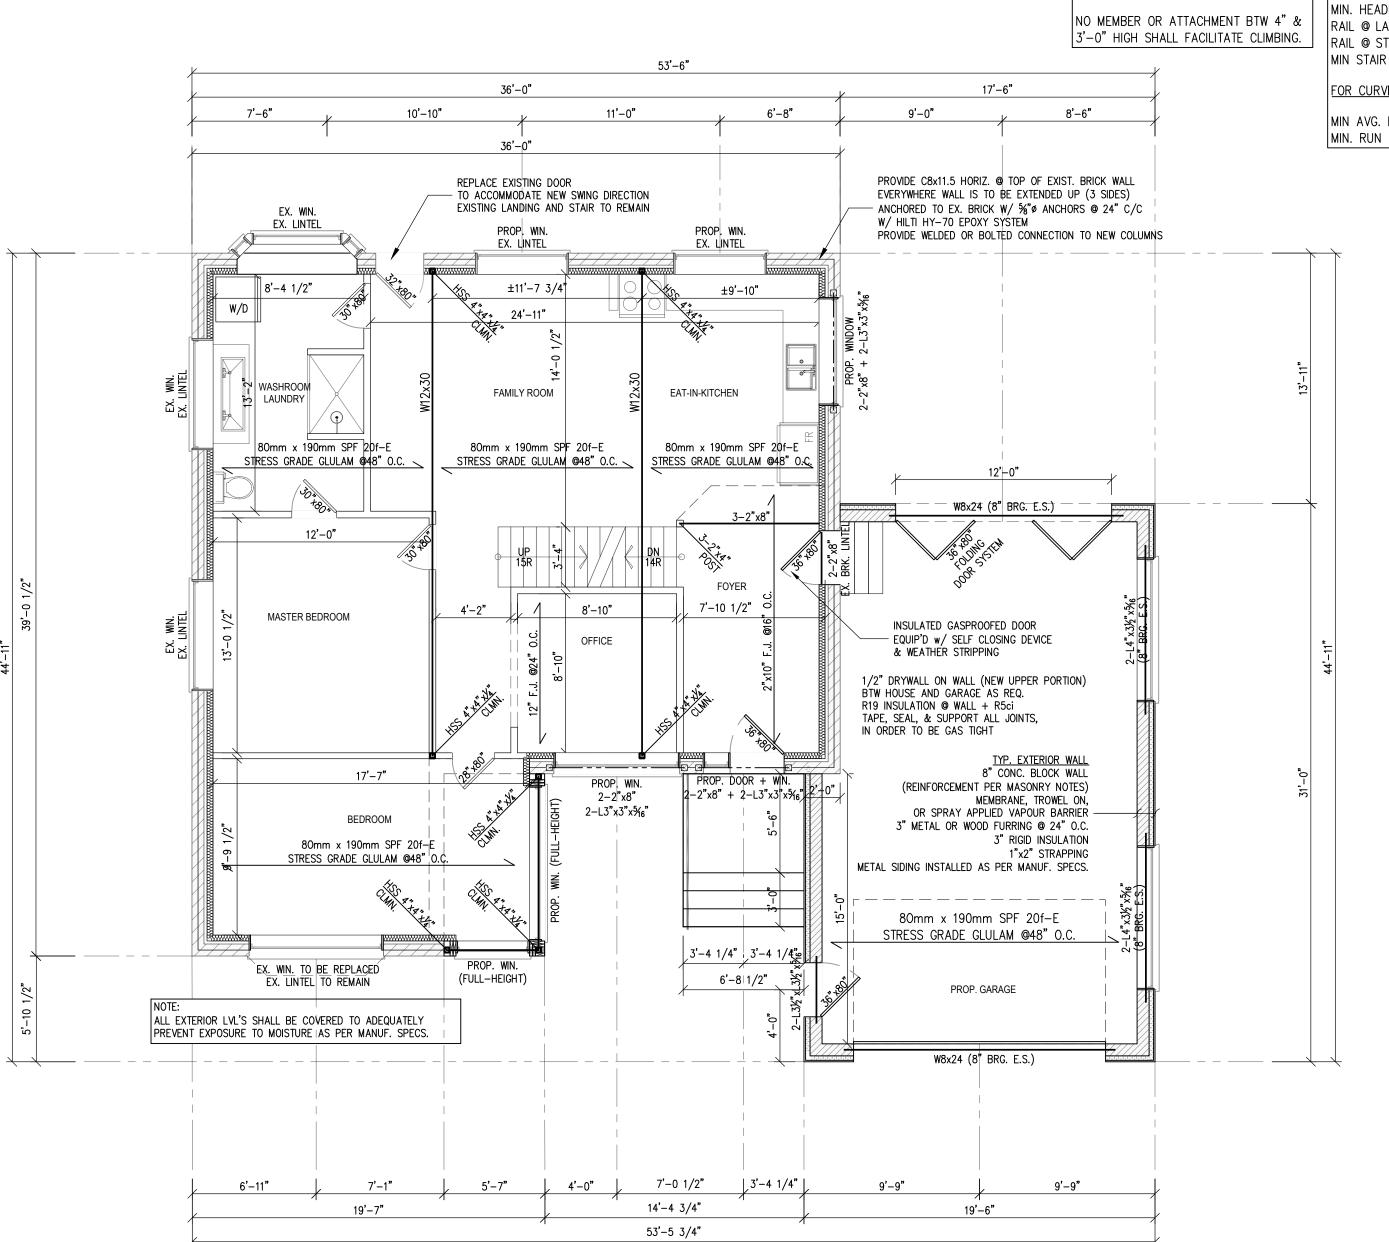
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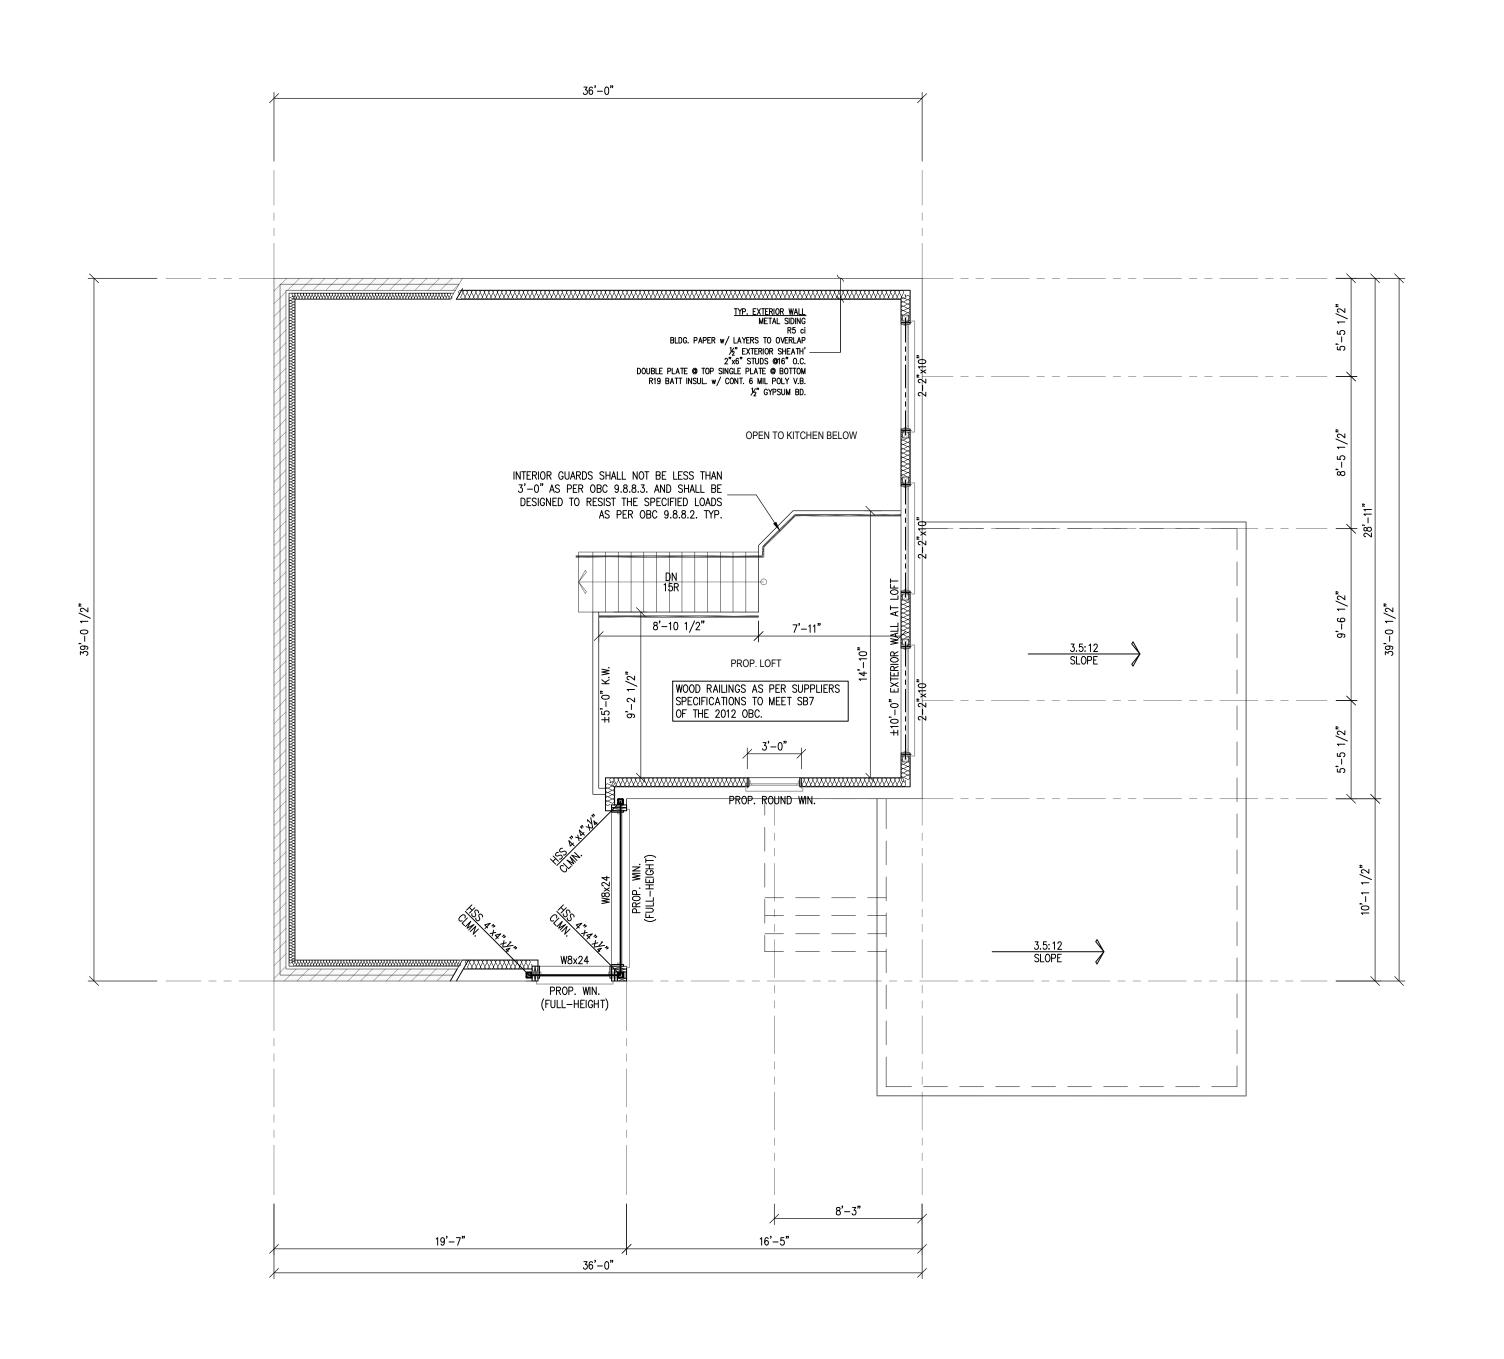
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REV.	DATE	REMARKS

ZOLTAN ENGINEERING

25-4380 SOUTH SERVICE ROAD BURLINGTON, ON L7L 5Y6 (905) 331 - 8307 WWW.ZOLTANENGINEERING.COM

PROJECT TITLE

VARGA RESIDENCE ADDITION & RENOVATION

193 COLLEEN CRESCENT ANCASTER, ON, L9G 1J2

DRAWING TITLE

PROP. LOFT PLAN

SCALE AS NOTED

DATE 11JAN21

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DESIGNED ZL

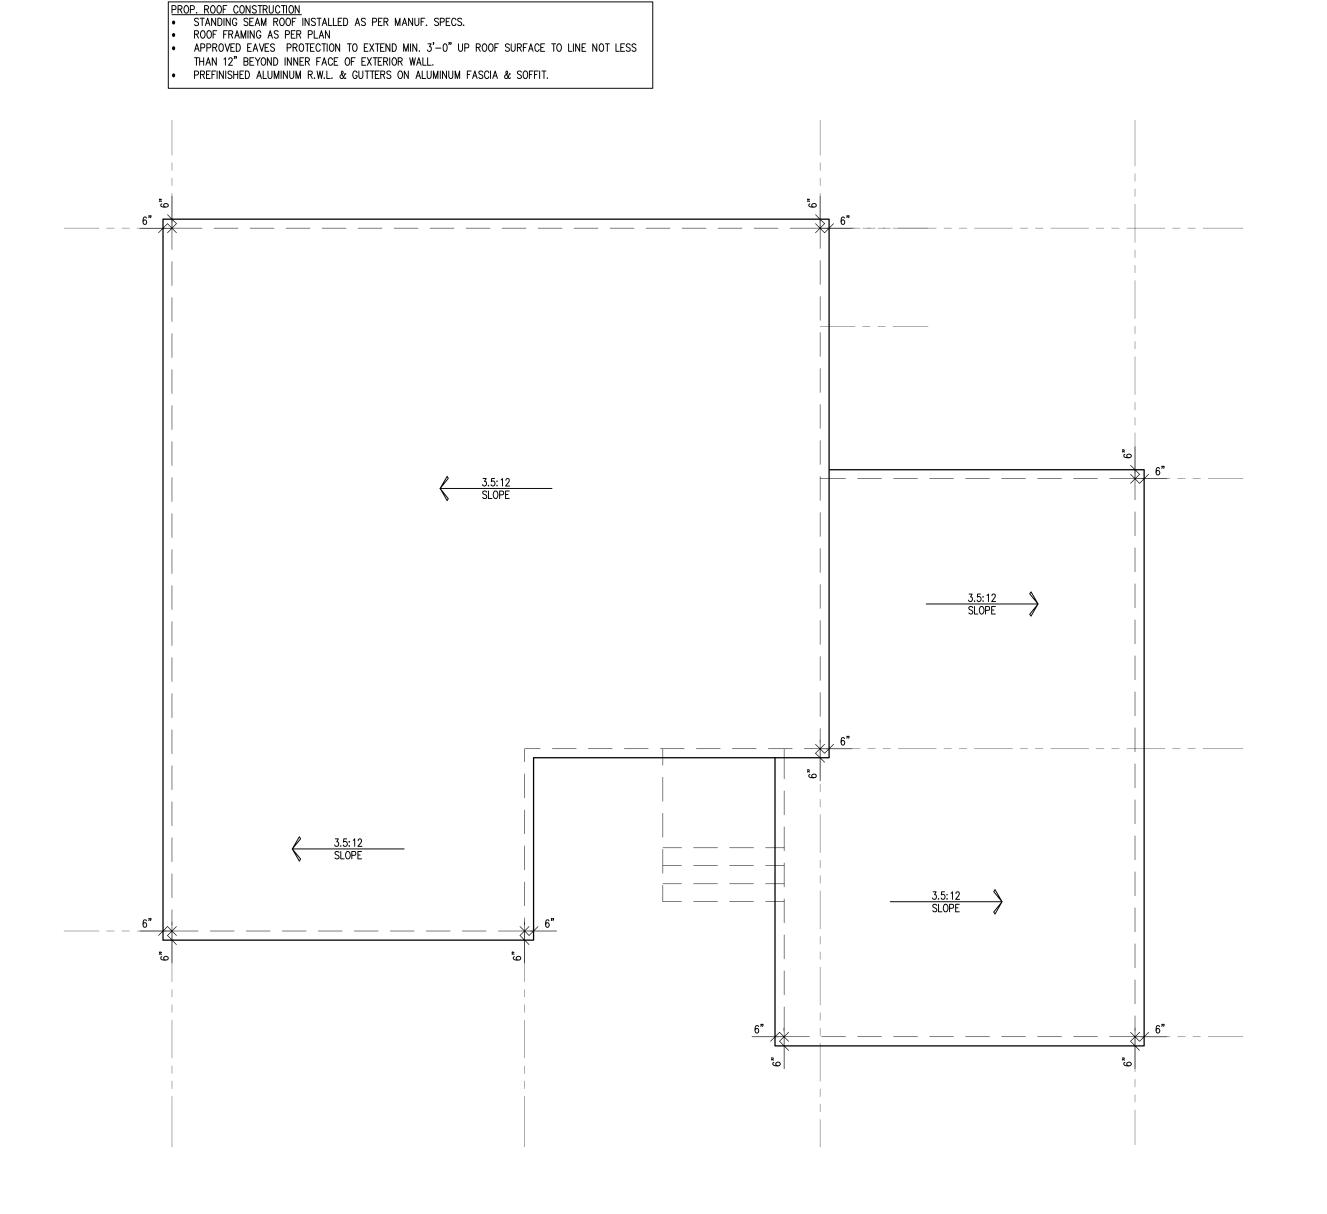
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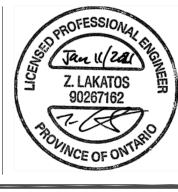
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PROP. ROOF PLAN

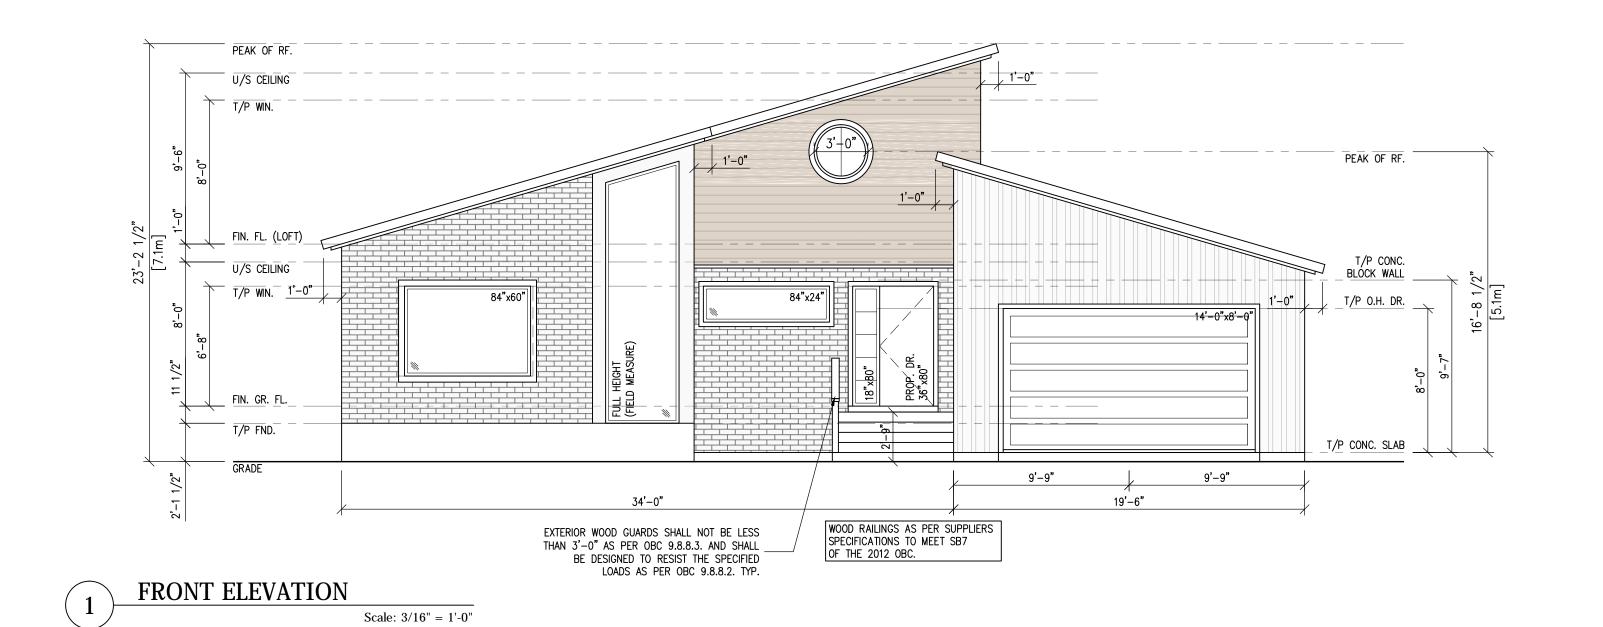
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REAR ELEVATION

Scale: 3/16" = 1'-0"

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193 COLLEEN CRESCENT ANCASTER, ON, L9G 1J2

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FRONT & REAR ELEVATIONS

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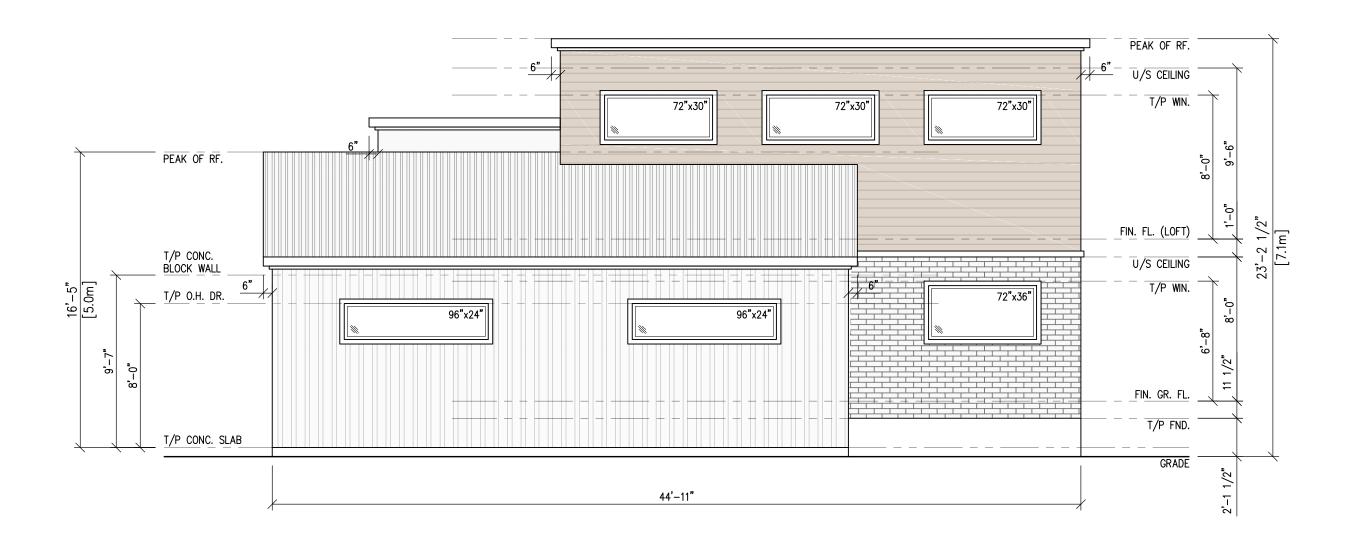
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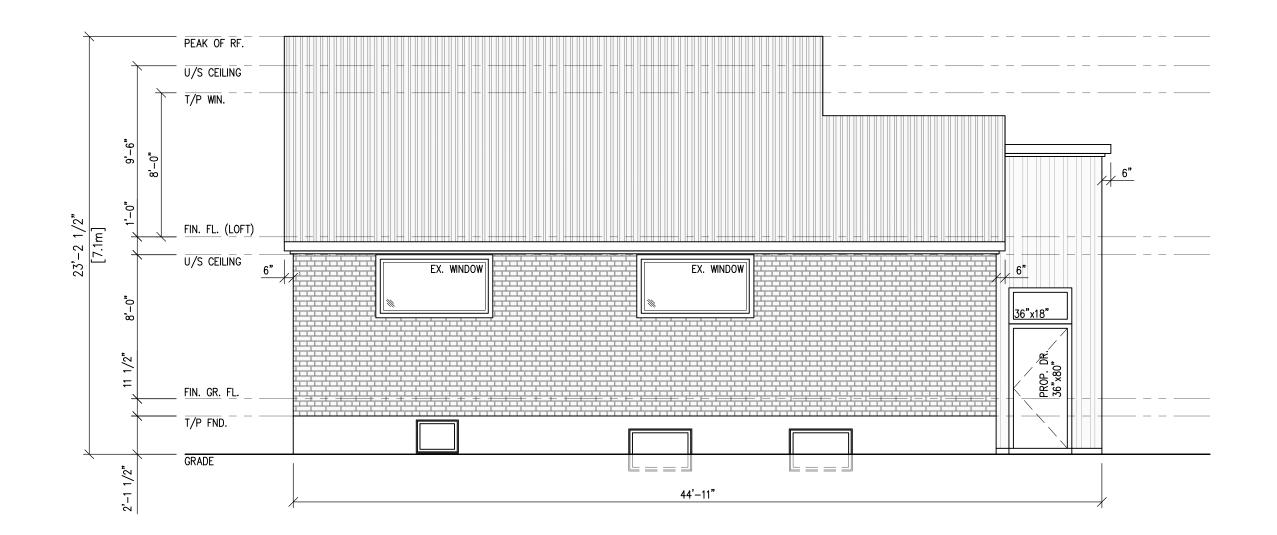
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SIDE ELEVATION

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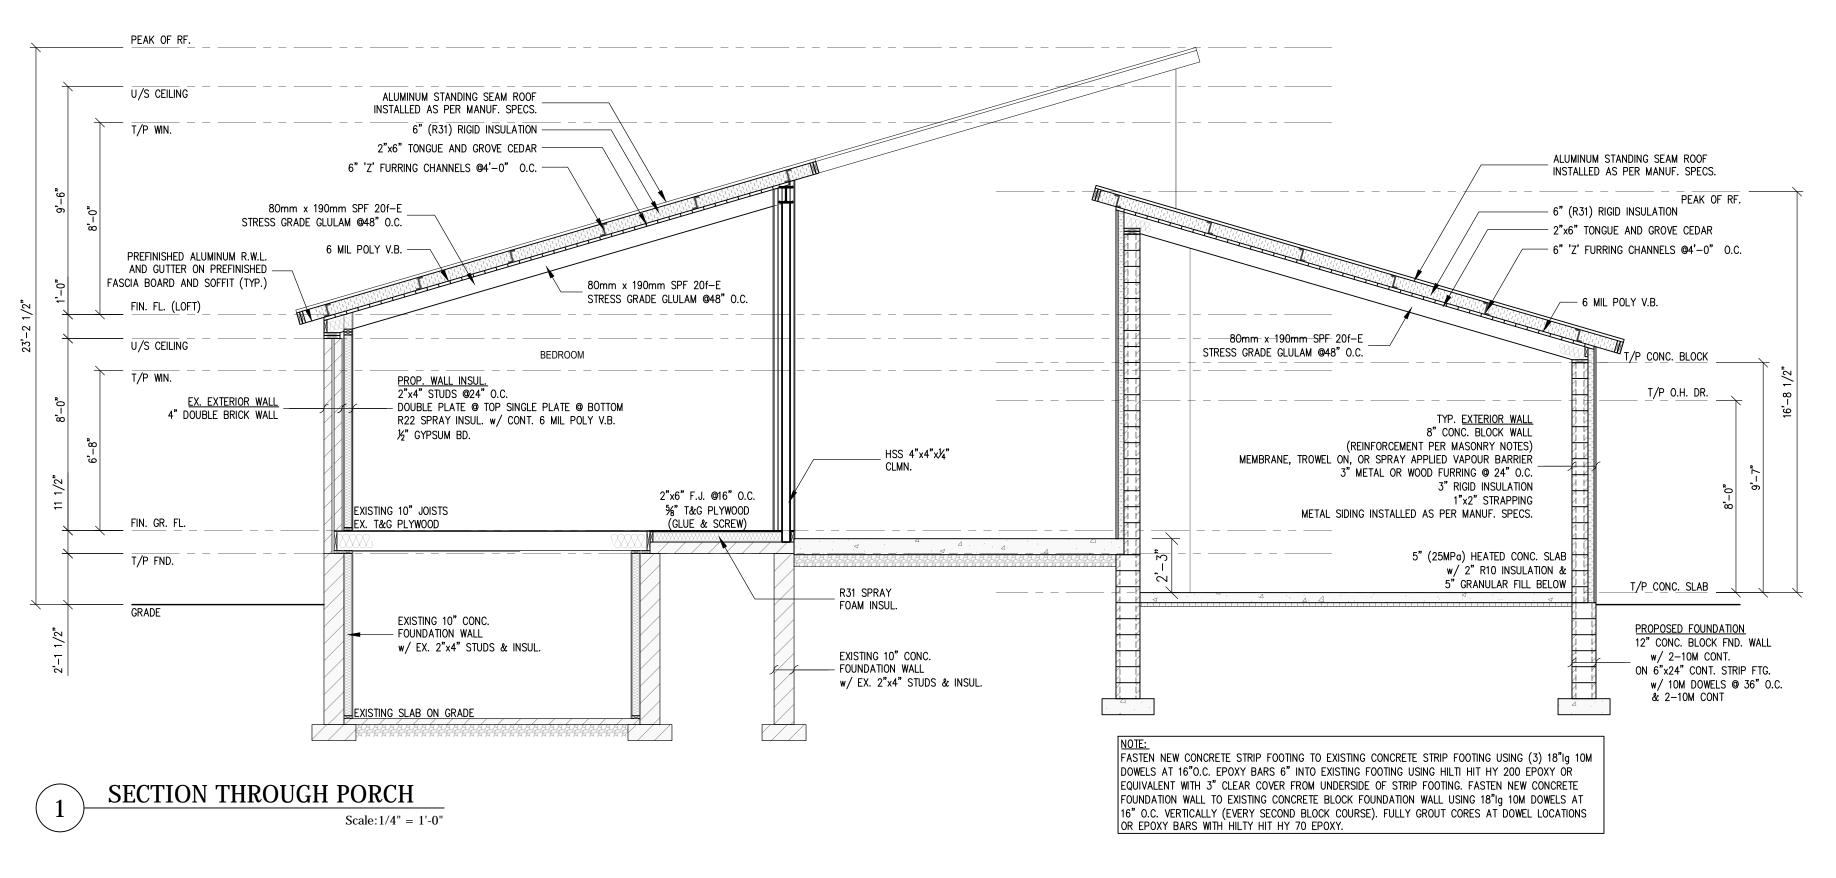
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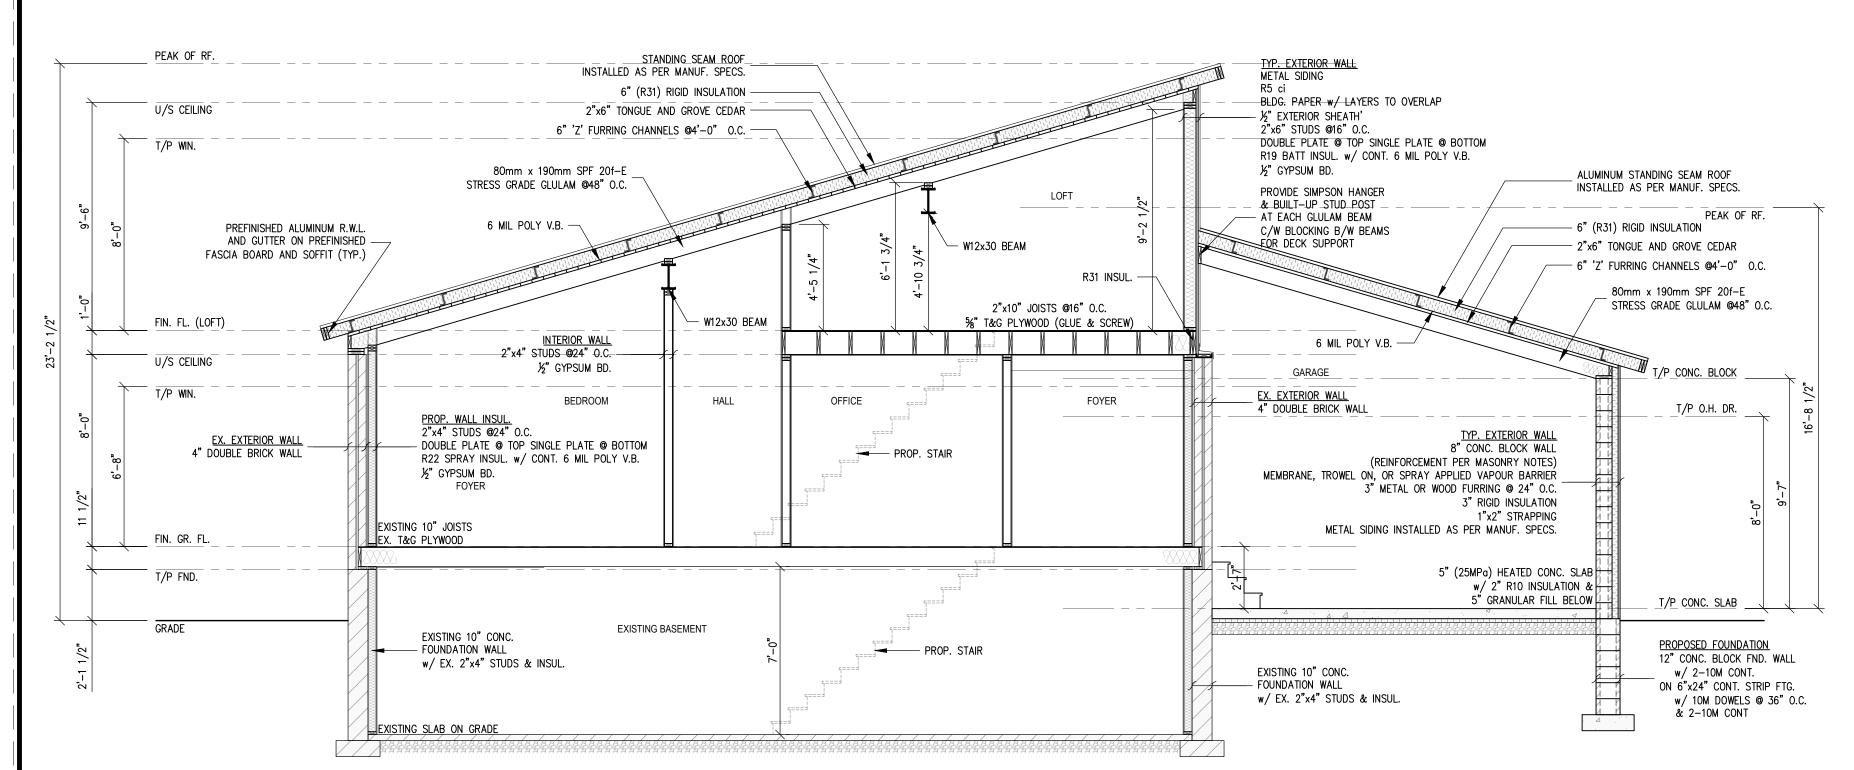
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SECTION THROUGH LOFT

TYP. EXTERIOR WALL METAL SIDING BLDG. PAPER w/ LAYERS TO OVERLAP 1/2" EXTERIOR SHEATH' 2"x6" STUDS @16" O.C. DOUBLE PLATE @ TOP SINGLE PLATE @ BOTTOM R19 BATT INSUL. w/ CONT. 6 MIL POLY V.B. ½"GYPSUM BD. FIN. FL. (LOFT) C8x11.5 HORIZ. ANCHORED TO EX. BRICK W/ %"ø ANCHORS @ 24" C/C U/S CEILING W/ HILTI HY-70 EPOXY SYSTEM 2"x4" STUDS @24" O.C. DOUBLE PLATE @ TOP SINGLE PLATE @ BOTTOM R22 SPRAY INSUL. w/ CONT. 6 MIL POLY V.B. ½" GYPSUM BD. EX. EXTERIOR WALL 4" DOUBLE BRICK WALL FIN. GR. FL. GRADE EXISTING 10" CONC. FND. WALL w/ EX. 2"x4" STUDS & INSUL.

Scale: 1/4" = 1'-0"

SECTIONScale: 1/4" = 1'-0"

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GENERAL

- THE DESIGN AND CONSTRUCTION OF ALL WORK ON THIS PROJECT IS TO CONFORM TO THE ONTARIO BUILDING CODE - 2012 INCLUDING ALL AMENDMENTS, AND THE RELEVANT LISTED CSA STANDARDS INCLUDING THE LATEST REVISIONS.
- READ STRUCTURAL DRAWINGS IN CONJUNCTION WITH ALL RELEVANT ARCHITECTURAL AND SERVICES DRAWINGS AND OTHER CONTRACT DOCUMENTS.
- THE CONTRACTOR SHALL VERIFY ALL DIMENSIONED DRAWINGS AND REPORT ANY DISCREPANCIES TO THE ENGINEER BEFORE PROCEEDING WITH THE WORK.
- DO NOT EXCEED DESIGN LIVE LOAD DURING CONSTRUCTION.
- ALL WORK IS TO BE PERFORMED IN ACCORDANCE WITH THE OCCUPATIONAL HEALTH AND SAFETY ACT AND REGULATIONS FOR CONSTRUCTION PROJECTS -O.REG. 213/91.
- SITE VISITS AND REVIEWS BY THE DESIGN ENGINEER OR REPRESENTATIVE ARE INTENDED FOR THE PURPOSE OF ASCERTAINING GENERAL CONFORMANCE WITH THE DESIGN CONCEPT. THE SITE REVIEWS DO NOT MEAN THAT THE DESIGN ENGINEER HAS SEEN ALL OF THE CONSTRUCTION OR CONSTRUCTION PROCEDURES.
- REVIEW OF CONSTRUCTION BY THE DESIGN ENGINEER DOES NOT RELIEVE THE CONTRACTOR OF HIS RESPONSIBILITY FOR ERRORS AND OMISSIONS AND FOR MEETING ALL THE REQUIREMENTS OF THE CONSTRUCTION AND CONTRACT DOCUMENTS.
- THE CONTRACTOR IS RESPONSIBLE FOR ANY COSTS ASSOCIATED WITH THE REMOVAL OF FINISHES REQUIRED FOR INSPECTIONS OR TESTING THAT IS COVERED BEFORE INSPECTIONS ARE COMPLETED.
- SUBSTITUTIONS FROM SPECIFIED PRODUCTS AND MATERIALS MUST BE APPROVED BY THE ENGINEER PRIOR TO ORDERING OF MATERIALS. THE CONTRACTOR SHALL REIMBURSE ALL CONSULTANT FOR ADDITIONAL COSTS INCURRED AS A RESULT OF REVIEWING ANY CHANGES MADE TO THE CONTRACT DOCUMENTS.
- IT IS THE SOLE RESPONSIBILITY OF THE CONTRACTOR TO DESIGN ALL SHORING AND TEMPORARY BRACING PER O.REG 213/91 AND THE CONTRACTOR SHALL RETAIN AN ENGINEER AS REQUIRED.

FOUNDATIONS

- ALL FOOTINGS SHALL BE FOUNDED ON NATURALLY CONSOLIDATED UNDISTURBED SOIL CAPABLE OF SUSTAINING A LOAD (SEE PLAN) AT LEAST 2'-6" (750 MM) BELOW ORIGINAL (NOT FILL) GRADE.
- FOOTING ELEVATIONS ARE BASED ON ESTIMATE ONLY. IF UPON EXCAVATING TO THE SPECIFIED ELEVATIONS IT IS FOUND THAT THE ABOVE CONDITIONS ARE NOT MET OR THAT THEY HAVE BEEN MET AT HIGHER ELEVATIONS, THE FOOTING ELEVATION MAY BE ADJUSTED WITH THE ENGINEER'S PERMISSION.
- MINIMUM DEPTH FOR EXTERIOR FOOTINGS IS 4'-0" (1200 MM) BELOW FINISHED GRADE.
- CENTER ALL CAPS AND FOOTINGS UNDER COLUMNS EXCEPT AS NOTED OTHERWISE ON THE PLANS.
- DURING COLD WEATHER, PROTECT SOIL BENEATH AND ADJACENT TO FOOTINGS FROM FREEZING.
- UNLESS SPECIFIED BY THE ENGINEER, DO NOT EXCEED A RISE OF 7" IN A RUN OF 10" IN THE LINE OF SLOPE BETWEEN ADJACENT FOOTINGS EXCAVATIONS OR ALONG STEPPED FOOTINGS. USE STEPS NOT EXCEEDING 500MM (24") IN HEIGHT AND NOT LESS THAN 1200 MM (48") IN LENGTH.
- WHERE NECESSARY, THE CONTRACTOR SHALL LOWER FOOTINGS TO ACCOMMODATE DRAIN LINES, ETC.
- DO NOT PLACE BACKFILL AGAINST WALLS RETAINING EARTH (UNLESS DESIGNED FOR CANTILEVER) UNTIL FLOOR CONSTRUCTION AT TOP AND BOTTOM OF THE WALLS IS POURED AND SET.
- BACKFILLING AGAINST FOUNDATION WALLS TO BE DONE SO THAT THERE IS NEVER MORE THAN 1'-6" (450 MM) DIFFERENCE IN LEVEL, ONE SIDE TO THE OTHER, EXCEPT AS NOTED IN PARAGRAPH 8, ABOVE.
- WHERE SLAB ON GRADE IS USED TO TIE THE TOP OF THE WALL RETAINING EARTH. ADEQUATE SHORING AND BRACING MUST BE PROVIDED WHILE FILL IS BEING PLACED AND COMPACTED, AND MUST BE LEFT IN PLACE UNTIL SLAB IS POURED AND GAINED 75% OF ITS ULTIMATE STRENGTH.
- ANCHOR ALL CONCRETE BLOCK FOUNDATION WALLS TO CONCRETE PIERS WITH 2-10M X 4'-0" (1200MM) EVERY SECOND BLOCK COURSE. CAVITIES WITH BARS FILLED SOLID WITH GROUT.
- ALL WALL FOOTING 4" (100MM) PROJECTION AND 8" (200MM) DEPTH UNLESS NOTED OTHERWISE ON PLANS.

CLADDING

- ALL APPLICATIONS OF CLADDING SHALL CONFORM TO SECTION 9.27 OF THE ONTARIO BUILDING CODE (2012).
- INSTALLATION OF CLADDING SHALL CONFORM TO THE MANUFACTURERS SPECIFICATIONS. THESE INCLUDE, BUT ARE NOT LIMITED TO THE FOLLOWING;
- SEALING FASTENING
- 2.2.
- 2.3. AIR GAPS
- OVERLAPS 2.4. 2.5. PENETRATIONS

CONCRETE

- ALL CONCRETE WORK TO CONFORM TO CSA STANDARDS A23.1-14, A23.2-14, & A23.3-14
- CONCRETE FLOOR AND FOUNDATIONS SHALL HAVE A MINIMUM COMPRESSIVE STRENGTH OF 25 MPA AT 28 DAYS UNLESS NOTED OTHERWISE ON PLANS.
- ALL REINFORCING STEEL SHALL CONFORM TO CSA SPECIFICATION G30.18-M92 GRADE 400. FOR CONCRETE PROTECTION TO BARS SEE PLAN.
- SPACING AND CONCRETE COVER FOR REINFORCING STEEL SHALL CONFORM TO CSAA23.1 & CSA A23.2 UNLESS NOTED OTHERWISE:
- CONCRETE CAST AGAINST EARTH: 75MM (3")
- PIERS AND WALL: 40MM (1½") 4.2.
- EXPOSED TO DE-ICING CHEMICALS: 60MM (2½")
- INTERIOR SLABS AND BEAMS: (1½") 4.4.

- ALL CONCRETE SHALL HAVE A 28 DAY COMPRESSIVE STRENGTH OF 25 MPA MINIMUM UNLESS OTHERWISE SPECIFIED.
- EXTERIOR CONCRETE SLABS TO BE CLASS C-2 CONCRETE (28 DAY COMPRESSIVE STRENGTH OF 32 MPA) WITH AIR ENTRAINMENT.
- INTERIOR CONCRETE SLABS SHALL HAVE A 28 DAY COMPRESSIVE STRENGTH OF 25 MPA, 0.55 MAX. WATER-CEMENT RATIO.
- CONCRETE MIX DESIGN SHALL BE SUBMITTED TO THE ENGINEER FOR APPROVAL PRIOR TO USE AT JOB SITE.
- 6. LAP ALL REINFORCING BARS AT LEAST 20 DIAMETERS OR MINIMUM OF 1'-0" (300 MM) UNLESS NOTED OTHERWISE ON ALL PLANS.
- SLUMP OF CONCRETE TO BE 75 MM \pm 25 MM (3" \pm 1") OR AS OTHERWISE SPECIFIED. CONCRETE WITH 110 MM (4½") SLUMP OR MORE IS TO BE REJECTED.
- ALL OPENINGS IN CONCRETE SLAB OR WALLS SHALL BE TRIMMED WITH 2-15 BARS: HEAD, JAMBS, AND SILL, ALSO SEE DETAILS.
- ALL PRECAST CONCRETE SLAB DESIGN, FABRICATION AND ERECTION TO BE IN ACCORDANCE WITH CSA A23.4-16.
- 10. INSTALL ANCHOR BOLTS OR MISCELLANEOUS ITEMS SUPPLIED BY OTHERS FOR INSTALLATION IN THE CONCRETE WORK.
- CONTROL JOINTS: IN CONCRETE SLABS ON GRADE, MAXIMUM SPACING 25'-0" (7500MM) AREAS NOT TO EXCEED 625 FT2 IN FOUNDATION WALLS MORE THAN 82' (25M) LONG AT INTERVALS NOT TO EXCEED 49'-9" (15 M).

TIMBER

- ALL WOOD MATERIALS, FABRICATION, BRACING, AND ERECTION PROCEDURES TO BE IN ACCORDANCE WITH CSA 086-14. ALL TIMBER GRADING TO BE IN ACCORDANCE WITH NLGA.
- ALL TIMBER FOR RAFTERS, LINTELS, AND BEAMS TO BE SPF #2 UNLESS NOTED ON PLAN.
- ALL TIMBER SHALL CONFORM TO RECOGNIZE NOMINAL SIZES SHOWN ON PLAN AND STRESS RATINGS FOR APPROPRIATE SPECIES. NO TIMBER SHALL BE USED THAT DOES NOT CONFORM TO DIMENSIONS AND SPECIES.
- MINIMUM NUMBER OF FASTENERS PER OBC 9.23.3.4
- THE USE OF AIR NAILS ARE ACCEPTABLE TO SUBSTITUTING 2-3" COMMON WIRE NAILS WITH 3-3"X120 PROSTRIP TYPE AIR NAILS
- ALL JOIST HANGERS TO BE HUS BY SIMPSON STRONG TIE OR APPROVED EQUIVALENT. USE HOT-DIPPED GALVANIZED FINISH STEEL FOR EXTERIOR WORK.

SHEATHING

- 7.1. ROOF SHEATHING: %"PLYWOOD
- 7.2. EXTERIOR WALLS: ½" EXTERIOR TYPE PLYWOOD
- ALL SHEATHING SHALL BE FASTENED TO THE STUD FRAMING WITH MINIMUM 3" COMMON NAILS AT 12" O.C. IN THE FIELD, AND AT 6" O.C. AT SUPPORTED EDGES. REFER TO PLANS FOR ALL ADDITIONAL SHEAR WALL/DIAPHRAGM BLOCKING AND NAILING.
- BOLTS AND THREADED RODS TO BE A307 OR 300W GRADE
- 10. ALL WOOD TO BE PRESSURE TREATED MATERIAL PER CAN/CSA-080 "WOOD" PRESERVATION" INCLUDING BUT NOT LIMITED TO THE FOLLOWING LOCATIONS:
- INSTALLED EXTERIOR TO BUILDING
- INCORPORATED WITH ROOFING SYSTEMS 10.2.
- 10.3. INSTALLED AT EXTERIOR IN CONTACT WITH ROOFING SYSTEM
- 10.4. INSTALLED IN CONTACT WITH CONCRETE AND MASONRY.

STRUCTURAL STEEL

- CONFORM TO THE REQUIREMENTS ON CAN/CSA S16-14.
- G40.20-04 / G40.21-04 (R2009) GENERAL REQUIREMENTS FOR ROLLED OR WELDED STRUCTURAL QUALITY STEEL / STRUCTURAL QUALITY STEEL
- CISC CANADIAN INSTITUTE OF STEEL CONSTRUCTION HANDBOOK OF STEEL CONSTRUCTION, 11TH EDITION
- CODE OF STANDARD PRACTICE FOR STRUCTURAL STEEL
- W47.1-09 (R2014) CERTIFICATION OF COMPANIES FOR FUSION WELDING OF STEEL
- CSA W59.1-13 WELDED STEEL CONSTRUCTION (METAL ARC WELDING). ELECTRODES TO BE E49XX.

SLAB ON GRADE

- PRIOR TO CONSTRUCTION OF A SLAB-ON-GRADE, ALL TOPSOIL SOFT OR OTHERWISE COMPRESSIBLE MATERIAL MUST BE REMOVED FROM THE GROUND SURFACE. THE SLAB MUST BE CONSTRUCTED ON A MINIMUM THICKNESS OF 6 INCHES OF GRANULAR 'A' OR CRUSHED STONE FILL (34" MAX). THE GRANULAR BASE MUST BE COMPACTED TO AT LEAST 95% OF ITS MAXIMUM STANDARD PROCTOR DRY DENSITY TO PROVIDE A UNIFORM SUPPORT FOR THE SLAB.
- IF THERE IS EXISTING SILTY CLAY SUBSOIL, IT IS NOT CONSIDERED SUITABLE FOR RE-USE AS BACKFILL FOR INTERIOR FOOTING EXCAVATIONS, AND IT IS RECOMMENDED THAT APPROVED GRANULAR PIT-RUN MATERIAL BE USED FOR THIS PURPOSE. INTERIOR FOOTING BACKFILL MUST ALSO BE COMPACTED TO 95% OF ITS MAXIMUM STANDARD PROCTOR DRY DENSITY TO RECLUDE DIFFERENTIAL SETTLEMENT BELOW THE FLOOR SLABS.
- PLACE SLAB ON GRADE MATERIAL CAPABLE OF SUSTAINING 500 PSF (24KN/M2) WITHOUT SETTLEMENT RELATIVE TO THE BUILDING FOOTINGS.

MASONRY

- CONCRETE BLOCK: TYPE N/15/A/M WITH NOMINAL FACE DIMENSIONS 400MM X 200MM CONFORMING TO CSA SERIES-04 UNLESS NOTED OTHERWISE. ALL MASONRY CONSTRUCTION SHALL CONFORM TO CSA STANDARD A179-04, A370-04, & A371-04
- MORTAR: TYPE S TO CSA A179-04, FULL BLOCK BED.
- REINFORCING STEEL: GRADE 400 TO CSA-G30.18-M92.
- GROUT: $F'C = 2000 PSI (15 MPA), MAX SLUMP 7" (175MM), <math>\frac{3}{8}" (10MM)$ AGGREGATE TYPE S MORTAR AT 7" (175MM) SLUMP.
- HORIZONTAL REINFORCEMENT: TRUSS TYPE WITH 4MM (8 GA.) SIDE WIRES. PROVIDE AT EVERY SECOND COURSE & COURSE AT TOP AND BOTTOM OF OPENINGS. USE "CORNER-LOK" AT ALL WALL INTERSECTIONS.
 - VERTICAL REINFORCEMENT: 1-20M @ 4'-0" (1200MM) O.C. MAX INTO GROUTED CORES, U.N.O. PROVIDE VERTICAL REINFORCEMENT AT ALL CORNERS, WALL ENDS AND SIDES OF ALL OPENINGS. AND AT ALL BEAM AND LINTEL BEARING ENDS.
 - LAP 15M 24" (600MM), 20M 32" (800MM). PROVIDE FERRO SHEAR TIES @ EXTERIOR BRICK VENEER WALLS WHERE SHOWN ON PLANS WITH SPACING'S AS SHOWN ON PLANS.
- INTERLOCK ALTERNATE BLOCKS AT CORNERS AND WALL SECTIONS OR PLACE 1½"X¼"X24" (38X6X6X610MM) DOUBLE HOOK GALVANIZED STEEL TIES AT 16" (400MM) O.C. VERTICALLY.
- LINTELS (UNLESS NOTED OTHERWISE U.N.O) MINIMUM BEARING LENGTH 300MM. 7.1. 2 COURSES WITH BLACK VOIDS FILLED SOLID BY CONCRETE GROUT. SEE PLANS, CO-ORDINATE WITH HVAC DRAWINGS AND USE MIN. AT ALL WALL OPENINGS.
- VENEER TIES AT 32" (800MM) O.C. AT EVERY SECOND COURSE AND BE HOT DIP GALVANIZED.
- PROVIDE KEYED CONTROL JOINTS TO MATCH CONTROL JOINTS IN CONCRETE FOUNDATION WALLS OR AS INDICATED ON ARCHITECTURAL DRAWINGS. MAXIMUM SPACING 23'-0" (7M) O.C. RUN ALL REINFORCING THROUGH JOINT. CAULK VERTICAL EXTERIOR JOINT, FULL HEIGHT FOR BRICK, STONE AND BLOCK.
- PROVIDE STEEL STRAP PLATE 15/8"X1/4"X20" WITH 2" HOOKS @ 16" C/C WHERE MASONRY BUTTS AGAINST CONCRETE OR STRUCTURAL STEEL.
- PROVIDE KNOCK—OUT TYPE BOND BEAMS AT LOCATIONS SHOWN ON DRAWINGS, REINFORCE 1-20M REINFORCING BAR, UNLESS DETAILED OTHERWISE. CONCRETE GROUT THE FULL DEPTH OF BOND COURSES.
- 12. CONTINUE BOND BEAM REINFORCING THROUGH CONTROL JOINTS AND AROUND CORNERS.
- 13. CONTINUE ALL VERTICAL REINFORCING THROUGH BOND BEAMS, LINTELS, ETC. TO WITHIN 2" (50 MM) FROM THE TOP OF WALL.
- 14. PROVIDE CONTINUOUS L3"X3"X1/4" (L76X76X6.4) TO U/S OF DECK AT TOP OF
- 15. UNLESS OTHERWISE NOTED, MINIMUM BEARING PLATE FOR BEAMS 10X5.5X9MM AND 2-15M WELDED RODS 400X50MM HOOK TO BLOCK VOIDS.
- 16. CELLS TO BE REINFORCED SHALL BE KEPT CLEAN OF MORTAR.
- 17. PROVIDE REINFORCING DOWELS INTO FOUNDATIONS (WHERE INDICATED) TO MATCH VERTICAL REINFORCING IN BLOCK WALLS.
- 17.1. LAPS:
- 17.1.1. 12" WIRE REINFORCING
- 17.1.2. 24" - 10M 17.1.3.
- 30" 15M 17.1.4. 35" - 20M
- 17.1.5. 44" - 25M
- 18. FILL CELLS CONTAINING VERTICAL REINFORCING AND BOLTS WITH CONCRETE GROUT USING 36" AGGREGATE AND PROVIDE A 10" SLUMP, VIBRATE OR PUDDLE TO FILL CELLS COMPLETELY. FILL CELLS IN 5'-0" LIFTS.
- 19. REINFORCE LINTEL BLOCKS WITH 2-15M BARS U.N.O. AND FILL WITH GROUT.

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25-4380 SOUTH SERVICE ROAD BURLINGTON, ON L7L 5Y6 (905) 331 - 8307 WWW.ZOLTANENGINEERING.COM

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VARGA RESIDENCE ADDITION & RENOVATION

193 COLLEEN CRESCENT ANCASTER, ON, L9G 1J2

DRAWING TITLE

NOTES

AS NOTED SCALE 11JAN21 DATE DRAWN TV ZL DESIGNED CHECKED



PROJECT NO.

SHEET NO.

19 - 290



Committee of Adjustment

City Hall, 5th Floor, 71 Main St. W., Hamilton, ON L8P4Y5

Phone: (905) 546-2424 ext. 4221

Email: cofa@hamilton.ca

APPLICATION FOR A MINOR VARIANCE

FOR OFFICE USE ONLY	ſ.
APPLICATION NO	DATE APPLICATION RECEIVED
PAID	DATE APPLICATION DEEMED COMPLETE
SECRETARY'S SIGNATURE	

The Planning Act

Application for Minor Variance or for Permission

The undersigned hereby applies to the Committee of Adjustment for the City of Hamilton under Section 45 of the *Planning Act*, R.S.O. 1990, Chapter P.13 for relief, as described in this application, from the Zoning By-law.

1, 2	NAME	ADDRESS	
Registered Owners(s)	GEORGE VARGA		
Applicant(s)*	THOMAS LUKACS ZOLTAN ENGINEERING INC.		
Agent or Solicitor	Gerrit Vander Meulen ZOLTAN ENGINEERING INC.		

Note: Unless otherwise requested all communications will be sent to the agent, if

Please mail the sign directly to the owner for them to post. Please direct all email communication to gerrit@zoltanengineering.com

3. Names and addresses of any mortgagees, holders of charges or other encumbrances:

Additional sheets can be submitted if there is not sufficient room to answer the following questions. Additional sheets must be clearly labelled

	Nature and extent of relief applied for:			
	Garage addition to existing building does not meet maximum setback of 15.8m. Proposed maximum setback is 18.7m.			
E	Why it is not possible to comply with the provisions of the By law?			
5.	Why it is not possible to comply with the provisions of the By-law?			
	Different by-law requirements conflicting each other. Our proposed front yard setback is 18.7m, 2.9m over this requirement. If garage was extended by the 2.9m in order to meet this requirement, then we are conflicting another requirement: "attached garage projection max. 2.0m beyond front facade" which is currently taken into consideration (1.8m).			
6.	Legal description and Address of subject lands (registered plan number and lot number or			
	other legal description and where applicable, street and street number):			
	193 COLLEEN CRESCENT, ANCASTER, ON, L9G 1J2			
7.	PREVIOUS USE OF PROPERTY			
	Residential Industrial Commercial			
	Agricultural Vacant			
	Other			
8.1	If Industrial or Commercial, specify use			
8.1 8.2	If Industrial or Commercial, specify use Has the grading of the subject land been changed by adding earth or other material, i.e.			
	Has the grading of the subject land been changed by adding earth or other material, i.e. has filling occurred?			
8.2	Has the grading of the subject land been changed by adding earth or other material, i.e. has filling occurred? Yes No Unknown			
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8.2	Has the grading of the subject land been changed by adding earth or other material, i.e. has filling occurred? Yes No Unknown Has a gas station been located on the subject land or adjacent lands at any time?			
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8.2 8.3 8.4 8.5	Has the grading of the subject land been changed by adding earth or other material, i.e. has filling occurred? Yes No Unknown Has a gas station been located on the subject land or adjacent lands at any time? Yes No Unknown Has there been petroleum or other fuel stored on the subject land or adjacent lands? Yes No Unknown Has there or have there ever been underground storage tanks or buried waste on the subject land or adjacent lands? Yes No Unknown Has there or have there ever been underground storage tanks or buried waste on the subject land or adjacent lands? Yes No Unknown Has there ever been underground storage tanks or buried waste on the subject land or adjacent lands?			
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8.2 8.3 8.4 8.5	Has the grading of the subject land been changed by adding earth or other material, i.e. has filling occurred? Yes			
8.28.38.48.58.6	Has the grading of the subject land been changed by adding earth or other material, i.e. has filling occurred? Yes			
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8.10	Is there any reason to believe the subject land may have been contaminated by former uses on the site or adjacent sites? Yes No Unknown			r	
8.11	What information of	did you use to dete	ermine the answers to 9.1 to 9.10 above?		
	Information provi	ded by owner			
8.12	If previous use of property is industrial or commercial or if YES to any of 9.2 to 9.10, a previous use inventory showing all former uses of the subject land, or if appropriate, the land adjacent to the subject land, is needed.				
	Is the previous us	e inventory attache	ed? Yes		
9.	VCKNOMI EDGE	EMENT OLAUSE			
3.	ACKNOWLEDGEMENT CLAUSE I acknowledge that the City of Hamilton is not responsible for the identification and remediation of contamination on the property which is the subject of this Application – reason of its approval to this Application.				
	2021 Jan 2 Date	.2	Ocorge Varga Signature Property Owner		
	Date	West 200	Signature Property Owner		
			GEORGE VARGA		
			Print Name of Owner		
10.	Dimensions of lands affected: Frontage 25.72 m				
	Depth	61m			
	Area	1316 m2			
	Width of street	6 m			
11.		-	ures on or proposed for the subject lands: (Specif number of stories, width, length, height, etc.)	y	
	Dwelling: 10.4m	•	7.8m to side, 28m to rear. 1m and 15.1m to side, 18.6m to rear.		
	Proposed Dwelling with atta and 32.6m to rea		7m to front (garage), 2.6m to side (garage),		
12.		ldings and structure e, rear and front lot	es on or proposed for the subject lands; (Specify lines)		
	Dwelling: 10.4m		7.8m to side, 28m to rear. 1m and 15.1m to side, 18.6m to rear.		
	Proposed:				
	Dwelling with att		7m to front (garage), 2.6m to side (garage),		

Date of acquisition of subject lands: 2002 Dec 14			
Date of construction of all buildings a	and structures on subject lands:		
Existing uses of the subject property	•		
Residential dwelling			
Existing uses of abutting properties:			
Residential dwellings			
Length of time the existing uses of the subject property have continued:			
Since construction of the house.			
Municipal services available: (check the appropriate space or spaces)			
Water Yes	Connected		
Sanitary Sewer Yes	Connected		
Storm Sewers Yes			
Present Official Plan/Secondary Pla	n provisions applying to the land:		
Has the owner previously applied fo Yes If the answer is yes, describe briefly	r relief in respect of the subject property? No		
the Planning Act?	f a current application for consent under Section 53 of		
	● No		
Additional Information			
Minor variance required as part of #20-168415-000-00-R9	building permit application		
• •	opy of this application a plan showing the dimensions ng lands and showing the location, size and type of all		