

## COMMITTEE OF ADJUSTMENT

City Hall, 5<sup>th</sup> floor, 71 Main Street West, Hamilton, ON L8P 4Y5 Telephone (905) 546-2424, ext. 4221, 3935 Fax (905) 546-4202 E-mail: <u>cofa@hamilton.ca</u>

# NOTICE OF PUBLIC HEARING Minor Variance

### You are receiving this notice because you are either:

- Assessed owner of a property located within 60 metres of the subject property
- Applicant/agent on file, or
- Person likely to be interested in this application

APPLICATION NO.	:	AN/A-21:176
APPLICANTS:		Agent Graham Day Owners A. & S. Hall
SUBJECT PROPER	RTY:	Municipal address 189 Fiddlers Green Rd., Ancaster
ZONING BY-LAW:		Zoning By-law 87-57, as Amended 18-105
ZONING:		"ER" (Existing Residential) district
PROPOSAL:		rmit the construction of a new single family dwelling and a one orey accessory building in the rear yard, notwithstanding that;

1. An accessory building shall be permitted to be located in the required minimum northerly interior side yard, instead of the requirement that an accessory building shall not be located in any required minimum side yard.

2. An accessory building, in excess of 12 square metres ground floor area, shall be permitted to be located in the required minimum rear yard, and 1.52 metres from the rear lot line, instead of the requirement that an accessory building, in excess of 12 square metres ground floor area, shall not be located in any required minimum rear yard, and shall not be less than 7.5 metres from the rear lot line.

3. An eave or gutter for an accessory building shall be permitted to extend 0.94 metres into the required minimum northerly interior side yard, and 25.36 metres into the required minimum rear yard, instead of the requirement that in no case shall any eave or gutter for an accessory building extend more than 0.3 metres into a required minimum setback area.

#### NOTE:

1. The proposed development is subject to the issuance of a building permit in the normal manner. Be advised that Ontario Building Code regulations may require specific setbacks and construction types.

This application will be heard by the Committee as shown below:

DATE: TIME:	Thursday, June 17th, 2021 1:15 p.m.
PLACE:	Via video link or call in (see attached sheet for details) To be streamed at
	www.hamilton.ca/committeeofadjustment
_	for viewing purposes only

AN/A-21: 176 Page 2

### **PUBLIC INPUT**

**Written:** If you would like to submit written comments to the Committee of Adjustment you may do so via email or hardcopy. Please see attached page for complete instructions, including deadlines for submitting to be seen by the Committee.

**Orally:** If you would like to speak to this item at the hearing you may do so via video link or by calling in. Please see attached page for complete instructions, including deadlines for registering to participate.

### MORE INFORMATION

For more information on this matter, including access to drawings illustrating this request:

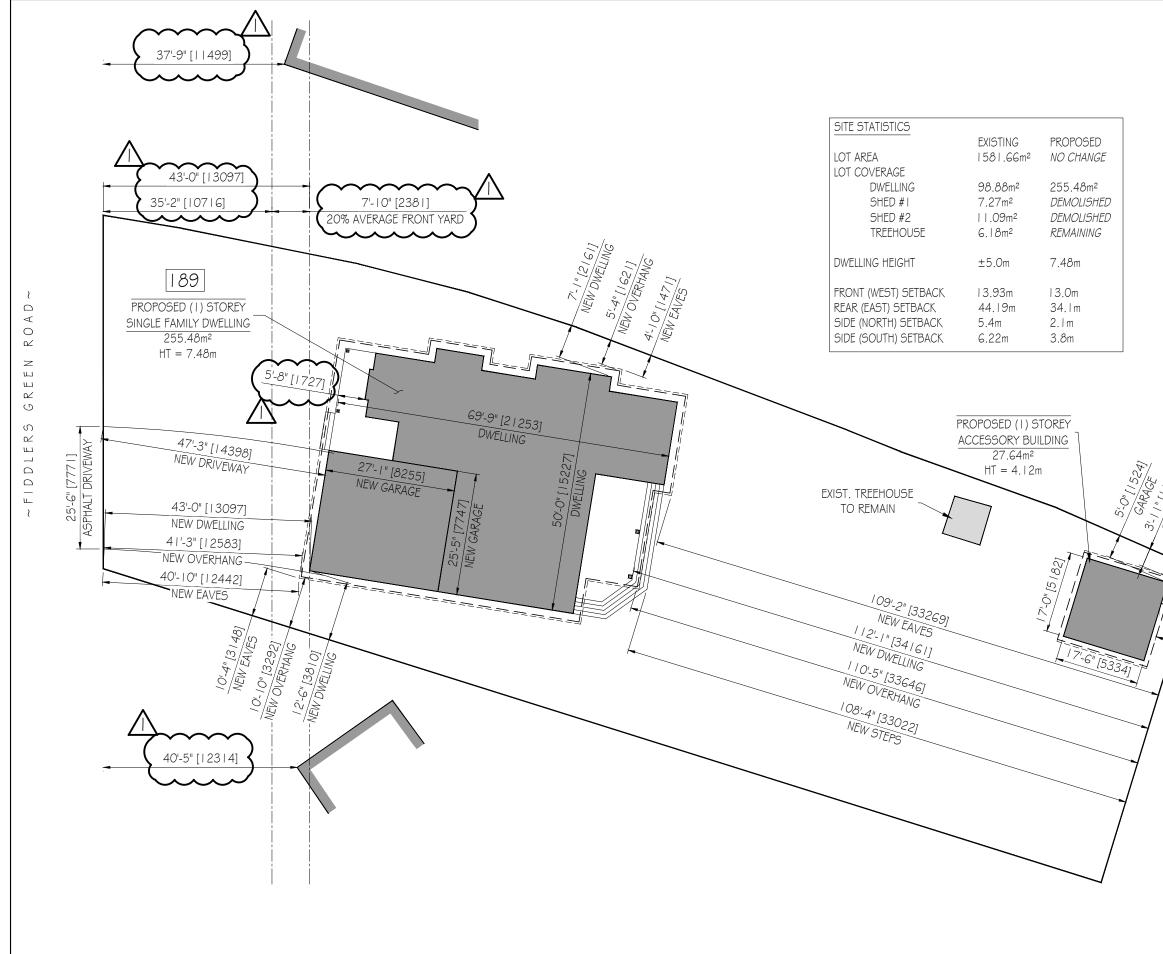
- Visit <u>www.hamilton.ca/committeeofadjustment</u>
- Call 905-546-CITY (2489) or 905-546-2424 extension 4221, 4130, or 3935
- Email Committee of Adjustment staff at <u>cofa@hamilton.ca</u>

DATED: June 1st, 2021.

Jamila Sheffield, Secretary-Treasurer Committee of Adjustment

Information respecting this application is being collected under the authority of the Planning Act, R.S.O., 1990, c. P. 13. All comments and opinions submitted to the City of Hamilton on this matter, including the name, address, and contact information of persons submitting comments and/or opinions, will become part of the public record and will be made available to the Applicant and the general public.

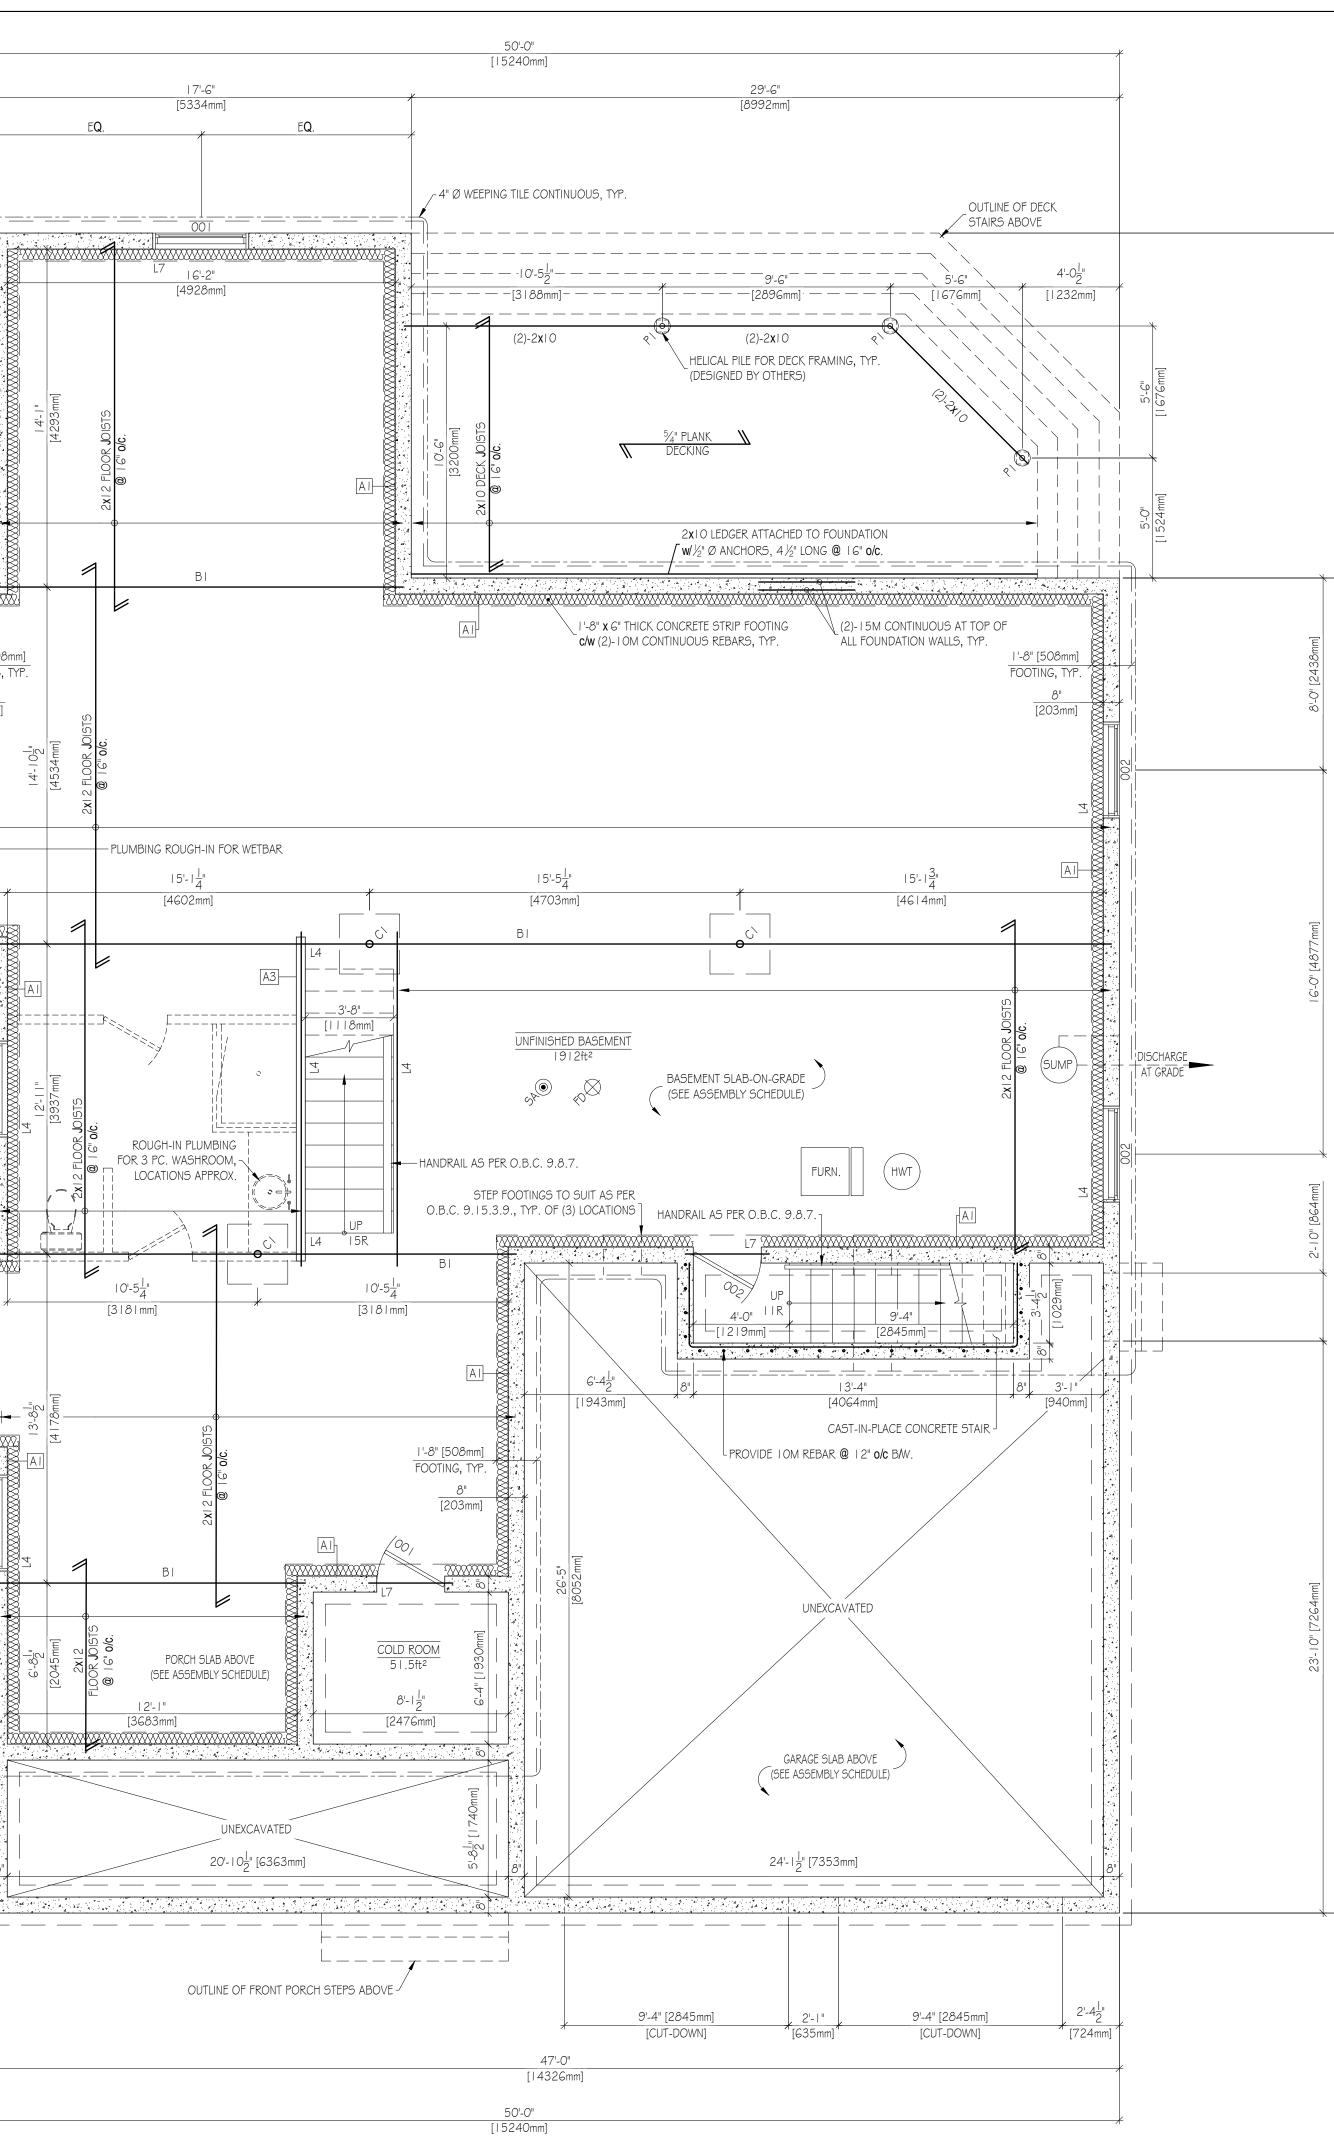
## DRAWING SCALED FOR 11"x17" (ANSI B)



TRUE					
		ARCHITECTURAL DESIGNER GRAHAMALEXANDER.CA INFO@GRAHAMALEXANDER.CA 1 905 864 5305			
EAVES 4110591	THIS DRAWING IS NOT TO BE USED AS PART OF A BUILDING PERMIT APPLICATION THIS DRAWING IS FOR DISCUSSION PURPOSES ONLY				
5'-0" [1524] GARAGE	REV. DESCRIPTION				
GARAGE 4'-0" [1219] OVERHANG	0 FOR MINOR VARIANCE 1 REVISED AS PER COM				
/	HOMEC	) WNER			
	project 189 FIDDLERS ANCASTER	R, ONTARIO			
	PROJECT	No. 21-001			
	title PROPOSED	SITE PLAN			
	drawn G.D.	checked -			
	date MARCH 2021	scale 1" = 20'-0"			
	revision number 1	drawing number SP0.01			

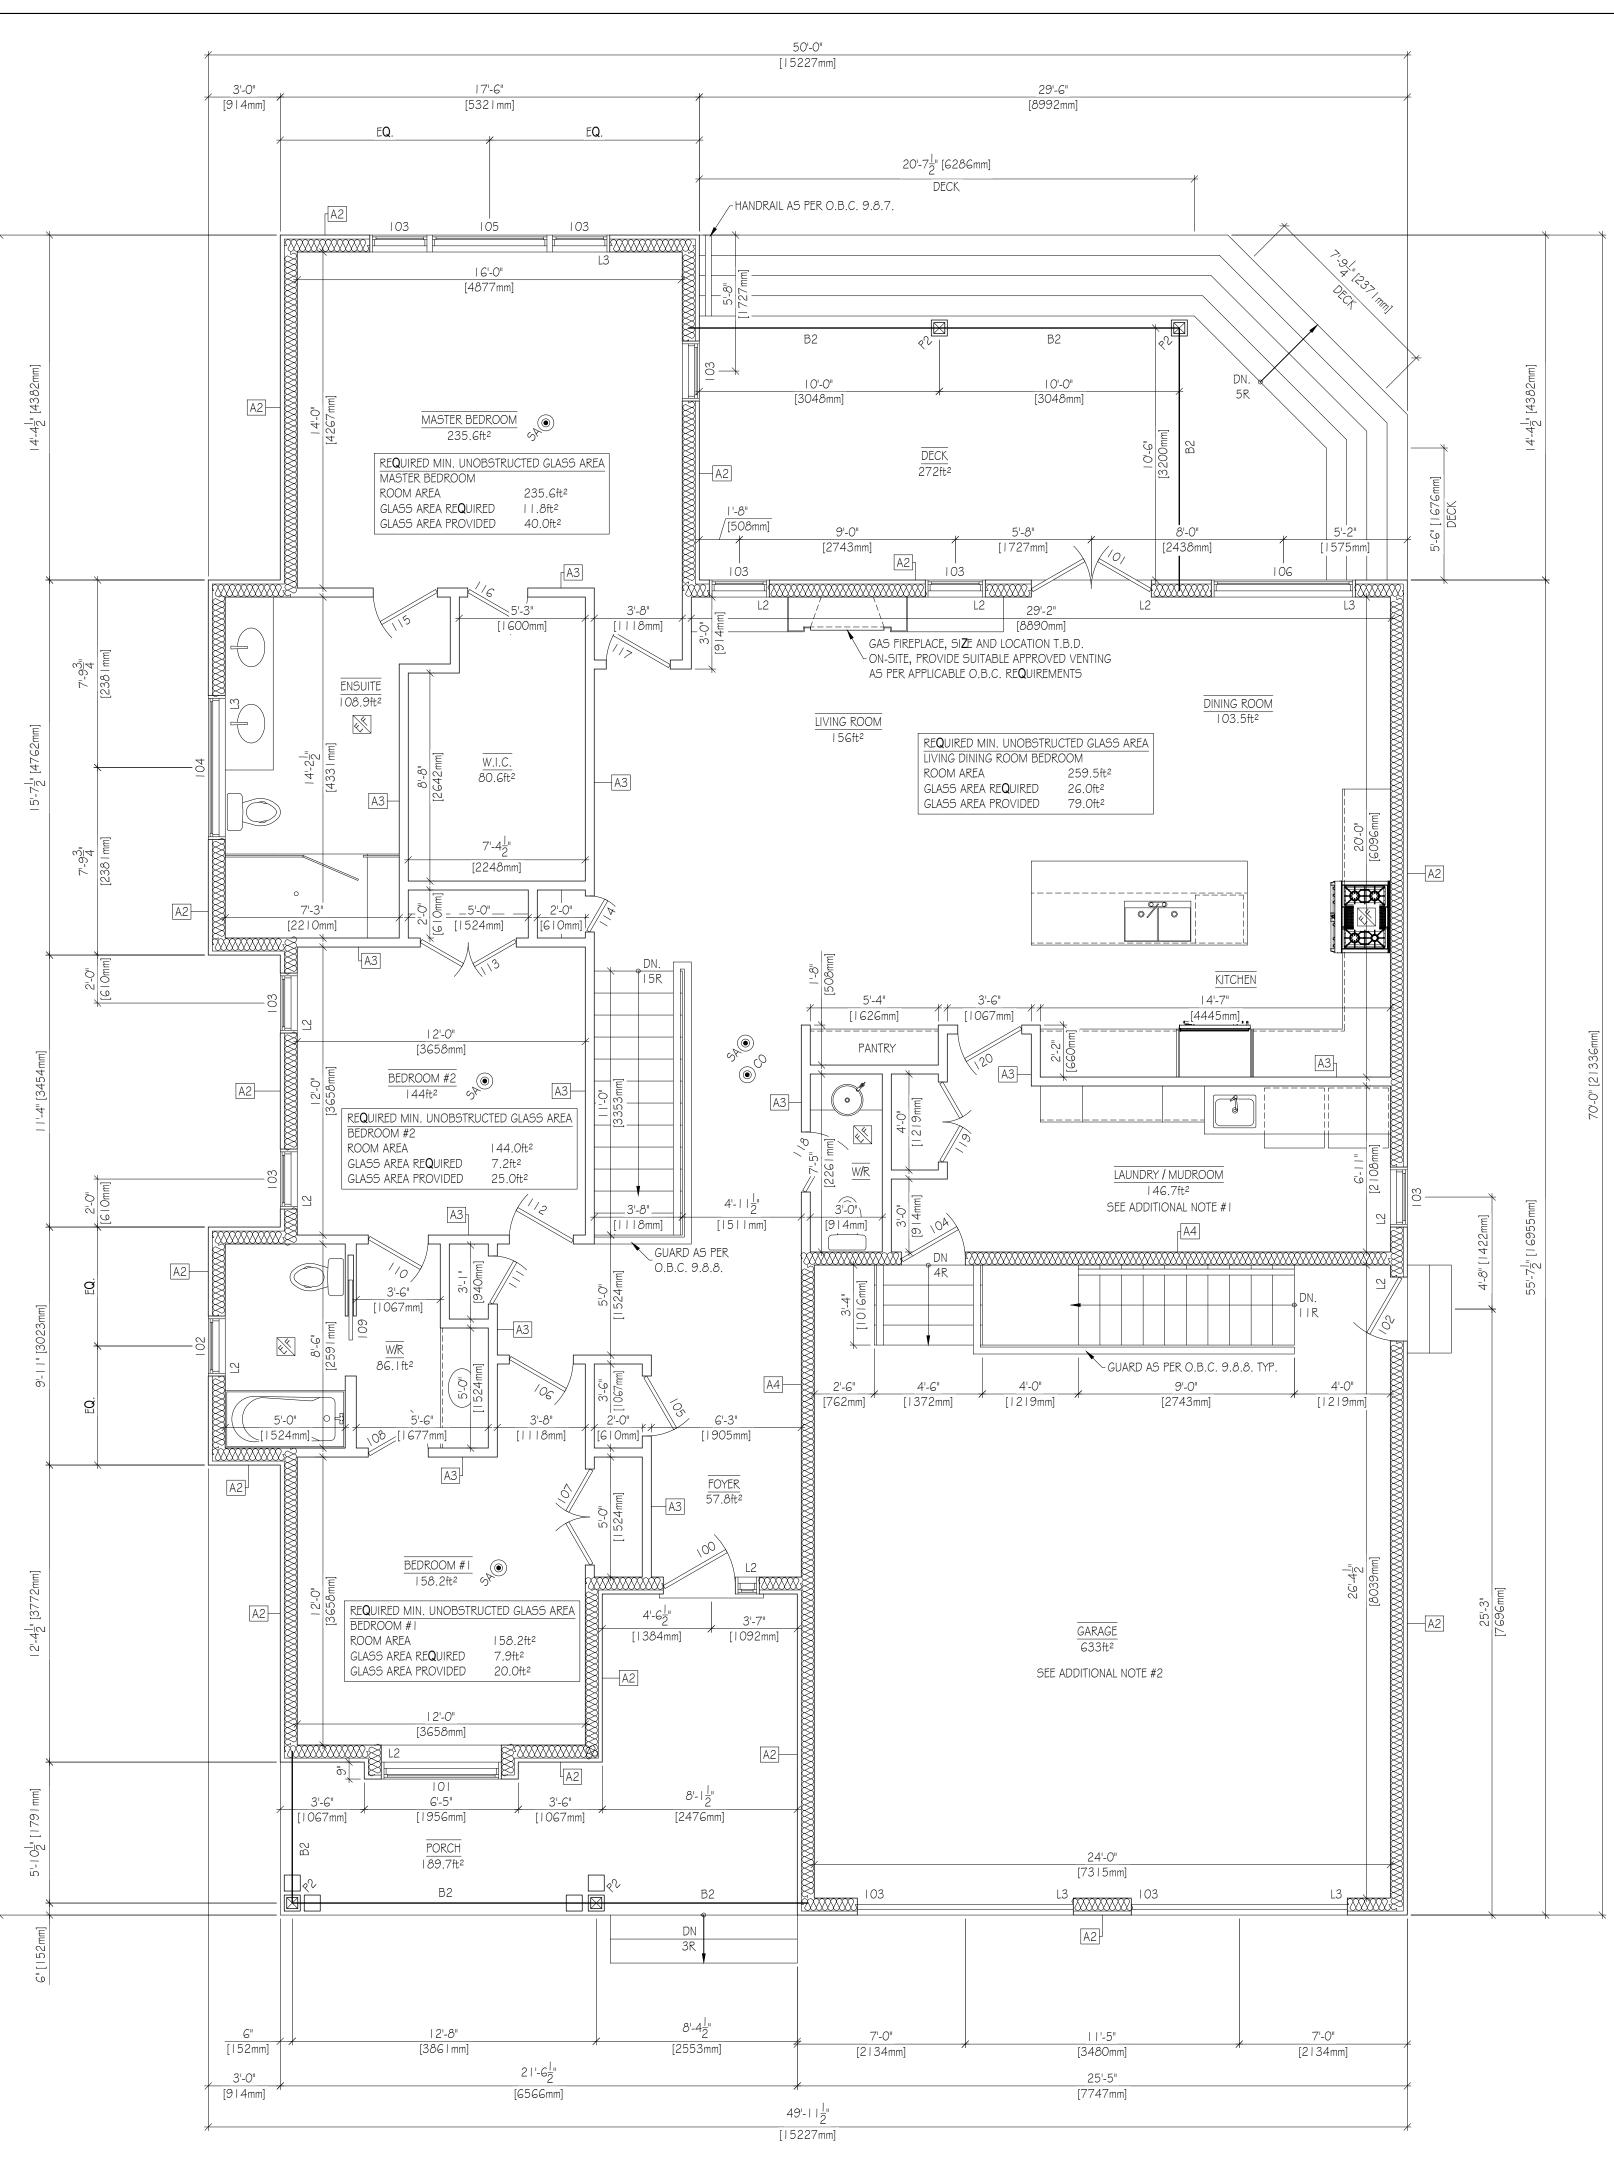
DRAWING SCALED FOR 24"x36" (ARCH D)		
AI       FOUNDATION WALL         Gmil. POLY VAPOUR BARRIER         MIN. R20 CONTINUOUS BATT INSULATION         8" CAST-IN-PLACE CONCRETE FOUNDATION WALLS         APPROVED DAMPPROOFING & DRAINAGE LAYER		3'-0" [9   4mm] EQ.
A2 EXTERIOR SIDING WALL SIDING BUILDING PAPER I" (R-5 XPS ci.) [LAP & TAPE ALL SEAMS]		
½" PLYWOOD SHEATHING         2x6 WOOD STUDS @ I G" o/c.         c/w R22 BATT INSULATION         Gmil. POLY VAPOUR BARRIER         ½" GYPSUM BOARD		
A3       INTERIOR PARTITION WALL         2x4 WOOD STUDS @ I 6" o/c. (U.N.O.)         ½" GYPSUM BOARD B/S         A4         GARAGE PARTITION WALL	Ē	
Image:	4'-4 <mark> </mark> " [4382mm]	2x12 FLOOR JOISTS
A5 BASEMENT SLAB MIN. 4" CONCRETE SLAB-ON-GRADE [25MP <b>a</b> ] 2" (R-I O XPS) 6" COARSE CLEAR STONE FILL 'A'		2XI 2 FLO
AG       GARAGE SLAB         MIN. 5" CONCRETE SLAB-ON-GRADE [25MPa]         c/w. 6 x 6, 6/6 WWM         6" COARSE CLEAR STONE FILL 'A'		
A7 PORCH SLAB MIN. 5" CONCRETE SLAB-ON-GRADE [25MP <b>a</b> ] <b>c/w</b> I OM REBARS <b>@</b> 8" <b>o/c e/w</b> 24" <b>x</b> 24" BENT I OM DOWELS <b>@</b> 24" <b>o/c @</b> PERIMETER PROVIDE MINIMUM 3" EDGE BEARING FOR SLAB 6" COARSE CLEAR STONE FILL 'A' [WHERE UNEXCAVATED]		I'-8" [508mm] FOOTING, TYP. 8" [203mm]
AB FLOOR ASSEMBLY <sup>3</sup> / <sub>4</sub> " PLYWOOD SHEATHING JOISTS AS NOTED ON PLANS c/w X-BRIDGING @ 1/3 POINTS	5'-7 <mark>1</mark> " [4762mm]	[]]     []]       []]     []]
A9 ROOF ASSEMBLY ASPHALT SHINGLES UNDERLAYMENT (ICE & WATER SHIELD) ½" PLYWOOD SHEATHING PRE-ENGINEERED TRUSSES BY OTHERS MIN. RGO BLOWN-IN INSULATION Gmil. POLY VAPOUR BARRIER		I'-8" [508mm]         FOOTING, TYP.         8"         [203mm]         [203mm]         [203mm]         [203mm]         [1-8" [508 mm]         [203mm]         [203mm]
/2" GYPSUM BOARD       AIO       PORCH & DECK ROOF ASSEMBLY       ASPHALT SHINGLES       UNDERLAYMENT (ICE & WATER SHIELD)		
1-3/4" PLYWOOD SHEATHING PRE-ENGINEERED TRUSSES BY OTHERS	[2 336mm] [54mm]	g
	70'-0" [21336	001

---- $\square$ 2'-6" 762m 44 14 2 \_\_\_\_\_3'-0" [9|4mm]



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						TRUE	
	<u> </u>	*				CONSTRUCTION	
14-42 [4302mm]							ARCHITECTURAL DESIGNER GRAHAMALEXANDER.CA INFO@GRAHAMALEXANDER.CA 1 905 864 5305
X	2						THIS DRAWING IS NOT TO BE USED AS PART OF A BUILDING PERMIT APPLICATION THIS DRAWING IS FOR DISCUSSION PURPOSES ONLY
							DRAWING LIST AO KEY PLAN, SCOPE OF WORK, GENERAL & CONSTRUCTION NOTES, & SITE PLAN A I ELEVATIONS
							A2 ELEVATIONS A3 BASEMENT FLOOR PLAN A4 MAIN FLOOR PLAN A5 ROOF PLANS AG SECTION, DETAILS, AND SCHEDULES LEGEND
	[						SMOKE ALARM, SEE CONST. NOTES
	70-0" [21336mm]						FLOOR DRAIN
ſmmcc							**LINTEL & BEAM SCHEDULE T.B.D.**         LI       (2) - 2" x 6" S-P-F         L2       (2) - 2" x 8" S-P-F         L3       (2) - 2" x 10" S-P-F
00 - /2 [1 6000mm]							L4 (2) - 2" x   2" S-P-F L5 (3) - 2" x 8" S-P-F L6 (3) - 2" x $ 0"$ S-P-F L7 (3) - 2" x   2" S-P-F L8 3ply 2.0E $ \frac{3}{4}"$ x $ \frac{1}{4}"$ LVL B1 W8x2   STEEL BEAM
			DOOR S	GCHEDULE SI <b>Z</b> E	HARDWARE	NOTES	**COLUMN LEGEND T.B.D.**         NEW SUITABLE ADJUSTABLE STEEL COLUMN ON         C       NEW 2'-0" x 2'-0" x 9" THICK CONCRETE FOOTING         C/w. 8-10M REBARS E/W.
			001 002 100	34x80 34x80 36x84	PASSAGE SET PRIVACY SET PRIVACY SET	EXTERIOR GRADE EXTERIOR GRADE <b>c/w</b> GAS SEAL & SELF-CLOSING DEVICE FRONT DOOR <b>c/w</b> I 2 <b>x</b> 84 SIDELIGHT	<ul> <li>HELICAL PIER TO BE DESIGNED BY OTHERS</li> <li>NEW 6x6 POST w/ SUITABLE SADDLE BEARING ON FOUNDATION BELOW</li> <li>PROVIDE NEW MINIMUM 3 ½" SOLID LEVEL</li> </ul>
			101 102 103	(2)-30 <b>x</b> 84 32 <b>x</b> 80 108 <b>x</b> 96	PRIVACY SET PRIVACY SET N/A	EXTERIOR GRADE EXTERIOR GRADE GARAGE DOOR <b>W</b> / ARCHED FRAME, SEE ELEVATION	<ul> <li>PROVIDE NEW MINIMUM 3 ½" SOLID LEVEL</li> <li>BEARING FOR NEW BEAM / LINTEL</li> <li><u>TYPICAL NOTES</u></li> <li>STAIRS (AS PER O.B.C. 9.8)</li> </ul>
			104 105 106 107	32x80 30x80 32x80 (2)-30x80	PRIVACY SET DUMMY SET PASSAGE SET DUMMY SET	EXTERIOR GRADE <b>c/w</b> GAS SEAL & SELF-CLOSING DEVICE	• RISE - MIN. $4_{8}^{7"}$ , MAX. $7_{8}^{7"}$ • RUN - MIN. $8_{4}^{1"}$ , MAX. 14" HANDRAILS (AS PER O.B.C. 9.8.7)
			108 109 110	30x80 30x80 30x80 30x80	PRIVACY SET PRIVACY SET PRIVACY SET	POCKET DOOR	<ul> <li>MIN. 2'-10" HIGH, MAX. 3'-2" HIGH</li> <li>OPENINGS BETWEEN PICKETS TO BE LESS THAN 4"</li> <li>GUARDS (AS PER O.B.C. 9.8.8)</li> <li>MIN. 2'-11" HIGH, U.N.O.</li> </ul>
			   2   3   4		DUMMY SET PASSAGE SET DUMMY SET DUMMY SET		OPENINGS BETWEEN PICKETS TO BE LESS THAN 4"
			114 115 116 117	32x80 30x80 32x80	PRIVACY SET PASSAGE SET PASSAGE SET		REV. DESCRIPTION     DATE       0     FOR MINOR VARIANCE APPLICATION     MAR. 29/21
	<u>,                                     </u>	×	8   9  20	30x80 (2)-20x80 32x80	PRIVACY SET DUMMY SET PASSAGE SET		client HOME OWNER
	WINDO' NUMBER	COUNT	SI <b>Z</b> E	TYPE FRAM		NOTES	Project 189 FIDDLERS GREEN ROAD ANCASTER, ONTARIO PROJECT No. 21-001
	001 002 101 102	3 2 I I	48 <b>x</b> 20 48 <b>x</b> 20 60 <b>x</b> 48 30 <b>x</b> 42	AWNING ALUM CASEMENT ALUM	INUM DOUBLE INUM DOUBLE INUM DOUBLE INUM DOUBLE	EGRESS WINDOW SEE ELEVATION FOR OPERATION	BASEMENT FLOOR PLAN
	103 104	8 I	30 <b>x</b> 60 72 <b>x</b> 18	CASEMENT ALUM		SEE ELEVATIONS FOR OPERATION & ORIENTATION SILL TO BE 6'-6" ABOVE FLOOR	drawn G.D
	105 106		48 <b>x</b> 60 72 <b>x</b> 60	FIXED ALUM CASEMENT ALUM	INUM DOUBLE	SEE ELEVATION FOR OPERATION	date     scale       MARCH 2021     1/4" = 1'-0"       revision number     drawing number       0     41,01
L							0 A1.01

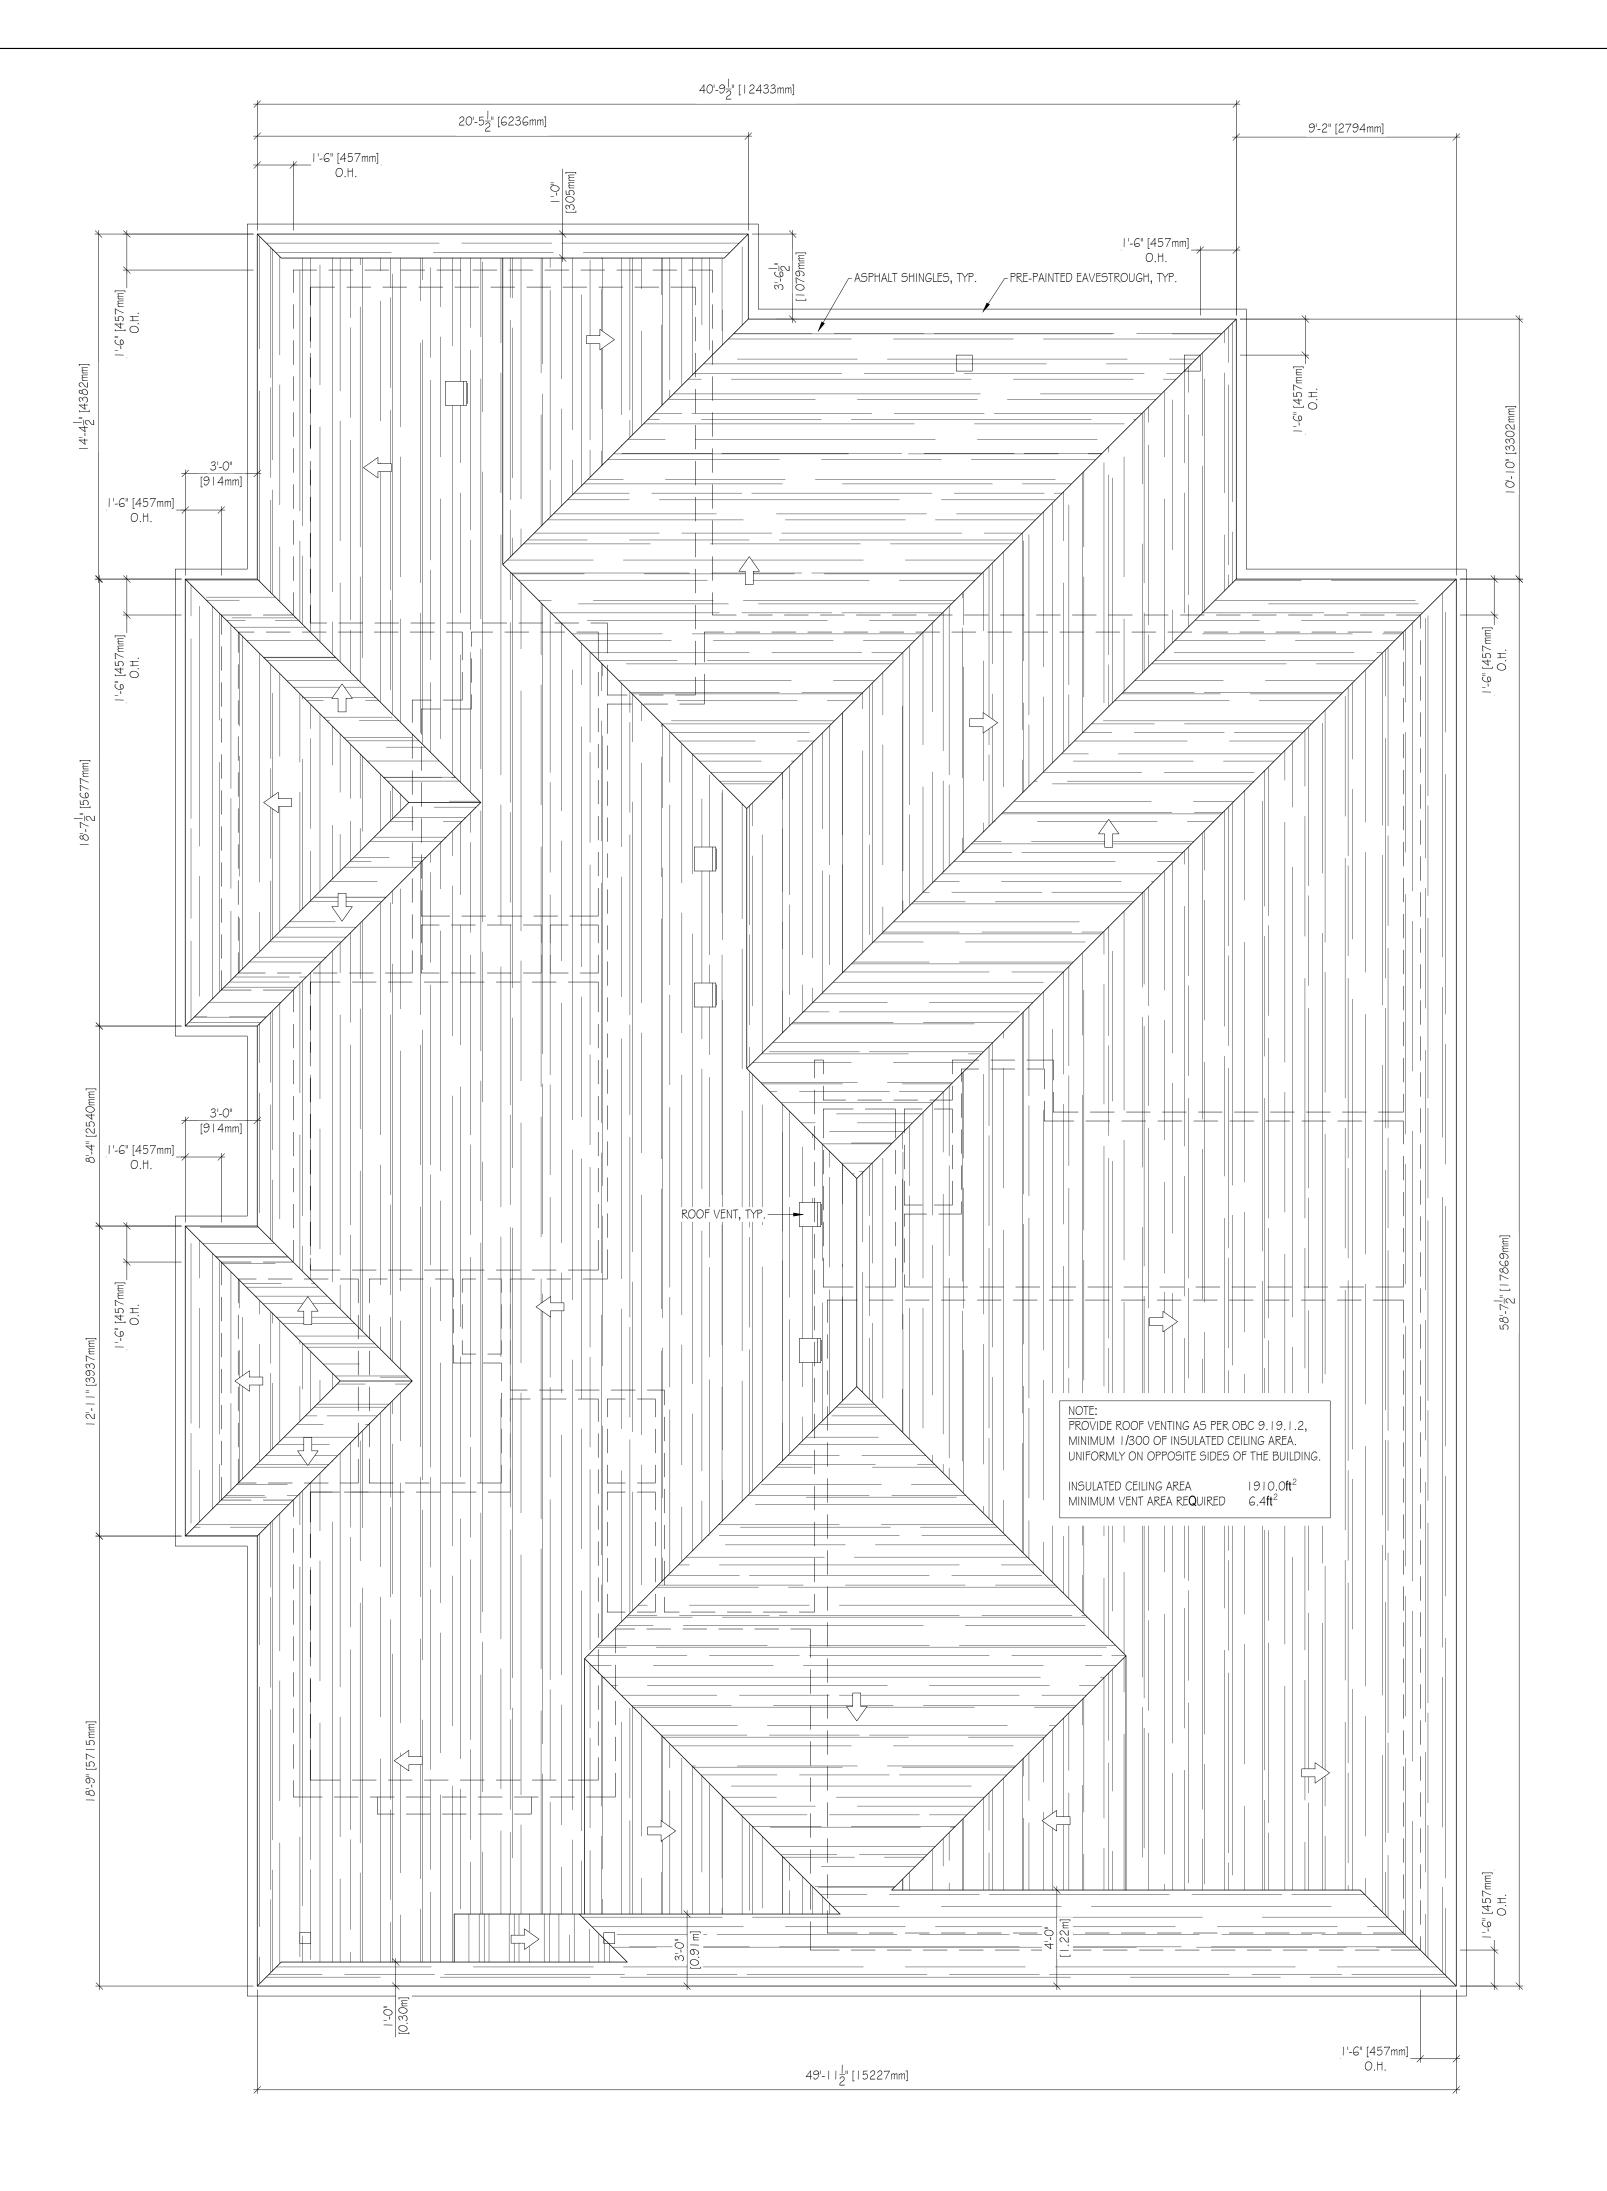
ASSEMBLIES SCHEDULE AI	-			
APPROVED DAMPPROOFING & DRAINAGE LAYER          [A2]       EXTERIOR SIDING WALL         SIDING       BUILDING PAPER	-			
I" (R-5 XPS ci.) [LAP & TAPE ALL SEAMS] ½" PLYWOOD SHEATHING 2xg WOOD STUDS @ I G" o/c. c/w R22 BATT INSULATION Gmil. POLY VAPOUR BARRIER				×
½" GYPSUM BOARD         A3         INTERIOR PARTITION WALL         2x4 WOOD STUDS @ 16" o/c. (U.N.O.)         ½" GYPSUM BOARD B/S	-			
A4 — GARAGE PARTITION WALL ½" GYPSUM BOARD 2x6 WOOD STUDS @ I 6" o/c. c/w R22 BATT INSULATION Gmil POLY VAPOUR BARRIER [HEATED SIDE] ½" GYPSUM BOARD	-			
A5 BASEMENT SLAB MIN. 4" CONCRETE SLAB-ON-GRADE [25MP <b>a</b> ] 2" (R-10 XPS) 6" COARSE CLEAR STONE FILL 'A'	-			
AG GARAGE SLAB MIN. 5" CONCRETE SLAB-ON-GRADE [25MP <b>a</b> ] <b>c/w</b> . 6 <b>x</b> 6, 6/6 WWM G" COARSE CLEAR STONE FILL 'A'	-			
A7 PORCH SLAB MIN. 5" CONCRETE SLAB-ON-GRADE [25MPa] c/w 10M REBARS @ 8" o/c e/w 24" x 24" BENT 10M DOWELS @ 24" o/c @ PERIMET PROVIDE MINIMUM 3" EDGE BEARING FOR SLAB 6" COARSE CLEAR STONE FILL 'A' [WHERE UNEXCAV/				
A8 FLOOR ASSEMBLY <sup>3</sup> / <sub>4</sub> " PLYWOOD SHEATHING JOISTS AS NOTED ON PLANS c/w X-BRIDGING @ 1/3 POINTS	-			
A9 ROOF ASSEMBLY ASPHALT SHINGLES UNDERLAYMENT (ICE & WATER SHIELD) 1/2" PLYWOOD SHEATHING PRE-ENGINEERED TRUSSES BY OTHERS MIN. RGO BLOWN-IN INSULATION Gmil. POLY VAPOUR BARRIER 1/3" GYPSUM BOARD	-			
AIO PORCH & DECK ROOF ASSEMBLY ASPHALT SHINGLES UNDERLAYMENT (ICE & WATER SHIELD) ½" PLYWOOD SHEATHING PRE-ENGINEERED TRUSSES BY OTHERS I-¾" PLANKING FINISH	-			[Jum
ADDITIONAL NOTES:				70'-0" [21336mm]
<ul> <li>PROVIDE MINIMUM 4"Ø CLEAN UNOBSTRUC DRYERS. FLEXIBLE TRANSITION HOSE BETW EITHER FOIL OR ALUMINUM TYPE FLEXIBLE D VINYL. CONCEALED DUCTING TO BE RIGID I DUCT. DUCT JOINTS TO BE INSTALLED SO POINTS IN THE DIRECTION OF AIRFLOW. JC TAPE (NOT DUCT TAPE). DO NOT USE RIVET ANYWHERE ELSE IN THE DUCT. LENGTH OF SHALL NOT EXCEED 35 FEET. DEDUCT 5 FEI FOR EVERY 90 DEGREE ELBOW AND TWO A DEGREE FITTING. THESE LENGTHS MAY VAR MANUFACTURERS RECOMMENDATIONS. DI INDEPENDENT OF ANY OTHER SYSTEMS (CH TERMINATION OF DRYER VENTING MUST BE HOOD OR ROOF CAP EQUIPPED WITH A BAY METAL SCREENING SHOULD NOT BE PART OF HOOD OPENING SHOULD POINT DOWN AND THE BOTTOM OF THE HOOD AND THE GROUPS</li> </ul>	VEEN DRYER DUCT. DO N METAL (GAI THAT THE N DINTS TO BI 'S OR SCRE CONCEALE ET FROM TI ND A HALF Y PER LOCA RYER VENTI HIMNEYS OR E TO THE EX CKDRAFT D DF THE HOC D HAVE 12"	R WALL OUTLET TO IOT USE PLASTIC VANIZED OR ALU MALE END OF THE E SECURED WITH EWS IN THE JOINT D RIGID METAL D HE ALLOWABLE LE FEET FOR EVERY AL CODES AND DI NG SHALL BE R EXHAUST VENTS (TERIOR WITH A P VAMPER. SMALL O D OR ROOF CAF OF CLEARANCE E	) BE OR MINUM) DUCT METAL S OR UCTING NGTH 45 RYER DRIFICE C. THE BETWEEN	1 <sub>"</sub> 0-0"
2. ELECTRIC VEHICLE CHARGING OBC 9.34.4.				
WHERE A HOUSE IS SERVED BY A GARAGE, FOLLOWING SHALL BE INSTALLED TO PERMI ELECTRIC VEHICLE SUPPLY EQUIPMENT THA THE ELECTRICAL SAFETY CODE:	T THE FUTL	JRE INSTALLATION	I OF	
<ul> <li>(A) A MINIMUM 200 AMP PANEL BOAH</li> <li>(B) A CONDUIT THAT IS NOT LESS THAT</li> <li>(C) A SQUARE 4-11/16 IN. TRADE SIZ</li> </ul>	AN 27 MM DW CABLES	TO BE PULLED IN		
THE ELECTRICAL OUTLET BOX DESCRIBED IN THE GARAGE OR CARPORT OR AD <b>J</b> ACENT T	,	,	ALLED IN	
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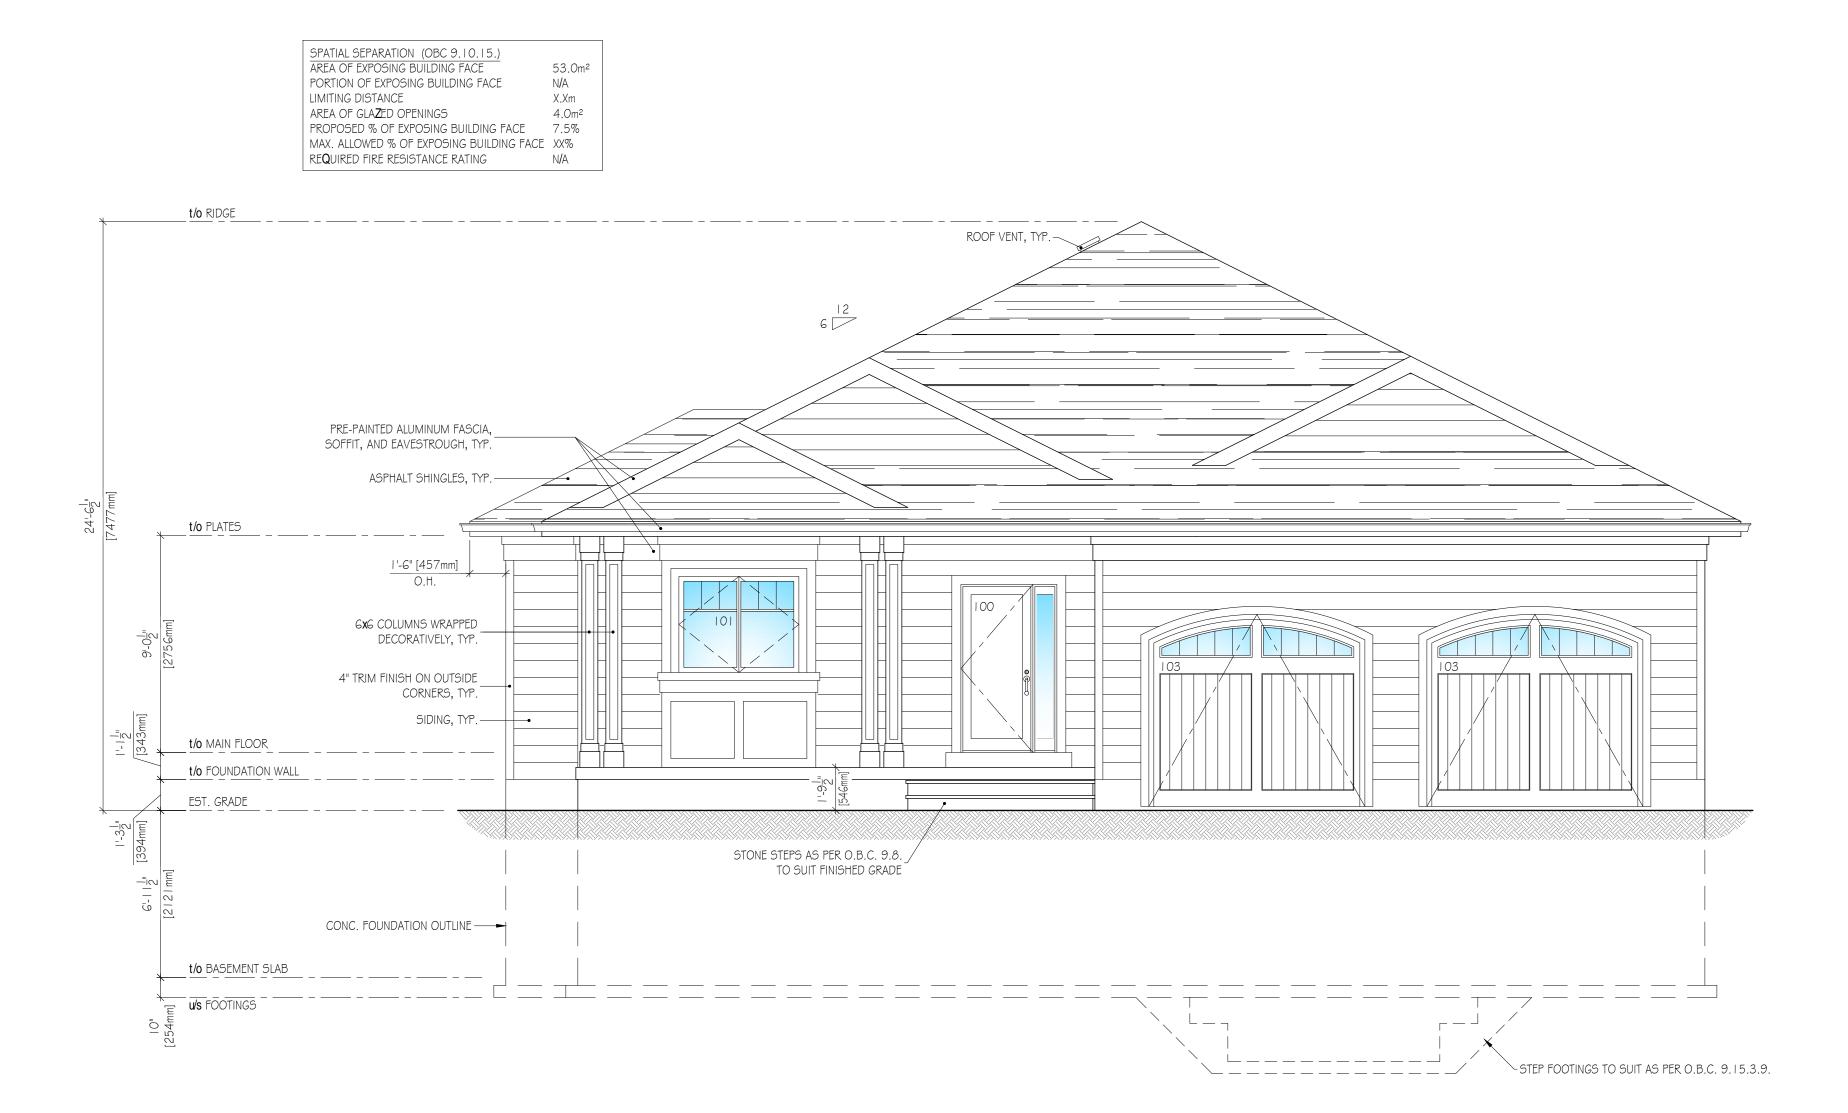
		TRE   CONSTRUCTION	<image/> <image/> <image/> <image/> <image/> <image/> <section-header><section-header><section-header><section-header><section-header><text><text><text><text></text></text></text></text></section-header></section-header></section-header></section-header></section-header>
DOOR 3 NUMBER 001 002 100 101 102 103 104 105 106 107 108 109 110	SCHEDULE         SIZE         MARDWARE         34x80         PASSAGE SET         34x80         PRIVACY SET         36x84         PRIVACY SET         36x84         PRIVACY SET         32x80         PRIVACY SET         32x80         PRIVACY SET         30x80         PRIVACY SET          30x80	NOTES EXTERIOR GRADE EXTERIOR GRADE EXTERIOR GRADE CIW GAS SEAL & SELF-CLOSING DEVICE FRONT DOOR CIW 12X84 SIDELIGHT EXTERIOR GRADE EXTERIOR GRADE EXTERIOR GRADE GARAGE DOOR W/ ARCHED FRAME, SEE ELEVATION EXTERIOR GRADE GARAGE DOOR W/ ARCHED FRAME, SEE ELEVATION EXTERIOR GRADE CON GRADE CIW GAS SEAL & SELF-CLOSING DEVICE	DRAWING LISTA0KEY PLAN, SCOPE OF WORK, GENERAL & CONSTRUCTION NOTES, & SITE PLANA1ELEVATIONSA2ELEVATIONSA3BASEMENT FLOOR PLANA4MAIN FLOOR PLANA5ROOF PLANSA6SECTION, DETAILS, AND SCHEDULESLEGENDSMOKE ALARM, SEE CONST. NOTES(a)CARBON MONOXIDE ALARM(b)SMOKE ALARM, SEE CONST. NOTES(c)CARBON MONOXIDE ALARM(c)CARBON MONOXIDE ALARM(c)FLOOR DRAIN(c)DOOR & ASSOCIATED SCHEDULE NUMBER(c)WINDOW & ASSOCIATED SCHEDULE NUMBER(c)Y & 10° SP-F(c)(c) 2° X 10° SP-F(c)
2   3   4   5   6   7   8   9  20	32x80       PASSAGE SET         (2)-30x80       DUMMY SET         18x80       DUMMY SET         32x80       PRIVACY SET         30x80       PASSAGE SET         30x80       PASSAGE SET         30x80       PRIVACY SET         30x80       PASSAGE SET		REV. DESCRIPTION     DATE       0     FOR MINOR VARIANCE APPLICATION     MAR. 29/21
WINDOW SCHEDULE           NUMBER         COUNT         SIZE           001         3         48x20           002         2         48x20           101         I         60x48           102         I         30x42           103         8         30x60           104         I         72x18           105         I         48x60           106         I         72x60	TYPE         FRAME         GLAZING           AWNING         ALUMINUM         DOUBLE           FIXED         ALUMINUM         DOUBLE           CASEMENT         ALUMINUM         DOUBLE	NOTES EGRESS WINDOW SEE ELEVATION FOR OPERATION SEE ELEVATIONS FOR OPERATION & ORIENTATION SILL TO BE G'-G" ABOVE FLOOR SEE ELEVATION FOR OPERATION	189 FIDDLERS GREEN ROAD ANCASTER, ONTARIO         PROJECT No. 21-001         title         MAIN FLOOR PLAN         drawn         G.D.         date         MARCH 2021         1/4" = 1'-0"         drawing number         0

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	ASSEMBLIES SCHEDULE	
	AI-FOUNDATION WALL	
	Gmil. POLY VAPOUR BARRIER	
	MIN. R20 CONTINUOUS BATT INSULATION	
	8" CAST-IN-PLACE CONCRETE FOUNDATION WALLS	
	APPROVED DAMPPROOFING & DRAINAGE LAYER	
	A2 EXTERIOR SIDING WALL	
	SIDING	
	BUILDING PAPER	
	" (R-5 XPS <b>ci</b> .) [LAP <b>&amp;</b> TAPE ALL SEAMS] //" PLYWOOD SHEATHING	
	2 <b>x</b> 6 WOOD STILATTING 2 <b>x</b> 6 WOOD STUDS <b>@</b> 16" <b>o/c</b> .	
	C/W R22 BATT INSULATION	
	Gmil. POLY VAPOUR BARRIER	
	1/2" GYPSUM BOARD	
	A3	
	2x4 WOOD STUDS @ IG" o/c. (U.N.O.)	
	1/2" GYPSUM BOARD B/S	
	A4 GARAGE PARTITION WALL	
	المعنى المراقة	
	2x6 WOOD STUDS @ I 6" o/c.	
	C/W R22 BATT INSULATION	
	Gmil POLY VAPOUR BARRIER [HEATED SIDE]	
	1/2" GYPSUM BOARD	
	A5 BASEMENT SLAB	
	MIN. 4" CONCRETE SLAB-ON-GRADE [25MPa]	
	2" (R-10 XPS) 6" COARSE CLEAR STONE FILL 'A'	
	6 COARDE CELAR STONE FILE A	
	AG GARAGE SLAB	
	MIN. 5" CONCRETE SLAB-ON-GRADE [25MPa]	
	C/W. G X G, G/G WWM G" COARSE CLEAR STONE FILL 'A'	
	6 COARDE CLEAR DIONE FILE A	
	A7-PORCH SLAB	
	MIN. 5" CONCRETE SLAB-ON-GRADE [25MPa]	
	c/w I OM REBARS @ 8" o/c e/w 24" x 24" BENTI OM DOWELS @ 24" o/c @ PERIMETER	
	PROVIDE MINIMUM 3" EDGE BEARING FOR SLAB	
	6" COARSE CLEAR STONE FILL 'A' [WHERE UNEXCAVATED]	
	A8 FI OOR ASSEMBLY	
	AB     FLOOR ASSEMBLY       3/4" PLYWOOD SHEATHING	
	JOISTS AS NOTED ON PLANS	
	c/w X-BRIDGING @ 1/3 POINTS	
	A9 ROOF ASSEMBLY	
	UNDERLAYMENT (ICE & WATER SHIELD)	
	1/2" PLYWOOD SHEATHING	
	PRE-ENGINEERED TRUSSES BY OTHERS	
	MIN. RGO BLOWN-IN INSULATION Gm <b>il</b> . POLY VAPOUR BARRIER	
	Smill, FOLT VAFOUR DARNILK //" GYPSUM BOARD	
	AIO PORCH & DECK ROOF ASSEMBLY ASPHALT SHINGLES	
	UNDERLAYMENT (ICE & WATER SHIELD)	
1		

ASPHALT SHINGLES UNDERLAYMENT (ICE & WATER SHIELD) 1/2" PLYWOOD SHEATHING PRE-ENGINEERED TRUSSES BY OTHERS I -3/4" PLANKING FINISH



	1
C.S.	
TRUE	
CONSTRUCTION	
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	ARCHITECTURAL
	DESIGNER GRAHAMALEXANDER.CA INFO@GRAHAMALEXANDER.CA 1 905 864 5305
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	<ul><li>A4 MAIN FLOOR PLAN</li><li>A5 ROOF PLANS</li><li>A6 SECTION, DETAILS, AND SCHEDULES</li></ul>
	LEGEND
	SMOKE ALARM, SEE CONST. NOTES
	FLOOR DRAIN
	001 WINDOW & ASSOCIATED SCHEDULE NUMBER
	**LINTEL & BEAM SCHEDULE T.B.D.**
	$ \begin{array}{c} \text{L1} & (2) - 2 & \mathbf{x} & 0 & 0 - 1 \\ \text{L2} & (2) - 2^{\text{H}} & \mathbf{x} & 0 & 5 - \mathbf{P} - \mathbf{F} \\ \text{L3} & (2) - 2^{\text{H}} & \mathbf{x} & 1 & 0 & 5 - \mathbf{P} - \mathbf{F} \\ \text{L4} & (2) - 2^{\text{H}} & \mathbf{x} & 1 & 2^{\text{H}} & 5 - \mathbf{P} - \mathbf{F} \end{array} $
	L5 (3) - 2" x 8" S-P-F L6 (3) - 2" x 10" S-P-F
	L7 (3) - 2" x   2" S-P-F L8 3ply 2.0E   3/4" x   1/4" LVL B1 W8x21 STEEL BEAM
	**COLUMN LEGEND T.B.D.** NEW SUITABLE ADJUSTABLE STEEL COLUMN ON
	S NEW 2'-0" x 2'-0" x 9" THICK CONCRETE FOOTING C/W. 8-10M REBARS E/W.
	<ul> <li>HELICAL PIER TO BE DESIGNED BY OTHERS</li> <li>NEW GXG POST W/ SUITABLE SADDLE</li> <li>BEARING ON FOUNDATION BELOW</li> </ul>
	<ul> <li>BEARING ON FOUNDATION BELOW</li> <li>PROVIDE NEW MINIMUM 3 ½" SOLID LEVEL</li> <li>BEARING FOR NEW BEAM / LINTEL</li> </ul>
	TYPICAL NOTES
	STAIRS (AS PER O.B.C. 9.8) • RISE - MIN. $4\frac{7}{8}$ , MAX. $7\frac{7}{8}$
	• RUN - MIN. 8 <sup>1</sup> / <sub>4</sub> , MAX. 14" HANDRAILS (AS PER O.B.C. 9.8.7)
	MIN. 2'-10" HIGH, MAX. 3'-2" HIGH     OPENINGS BETWEEN PICKETS TO BE LESS THAN 4"
	GUARDS (AS PER O.B.C. 9.8.8) • MIN. 2'-1 I " HIGH, U.N.O. • OPENINGS BETWEEN PICKETS TO BE LESS THAN 4"
	REV. DESCRIPTION     DATE       0     FOR MINOR VARIANCE APPLICATION     MAR. 29/21
	client
	HOME OWNER
	189 FIDDLERS GREEN ROAD
	ANCASTER, ONTARIO PROJECT No. 21-001
	drawn checked
	G.D date scale
	MARCH 2021     1/4" = 1'-0"       revision number     drawing number       0     A1.03

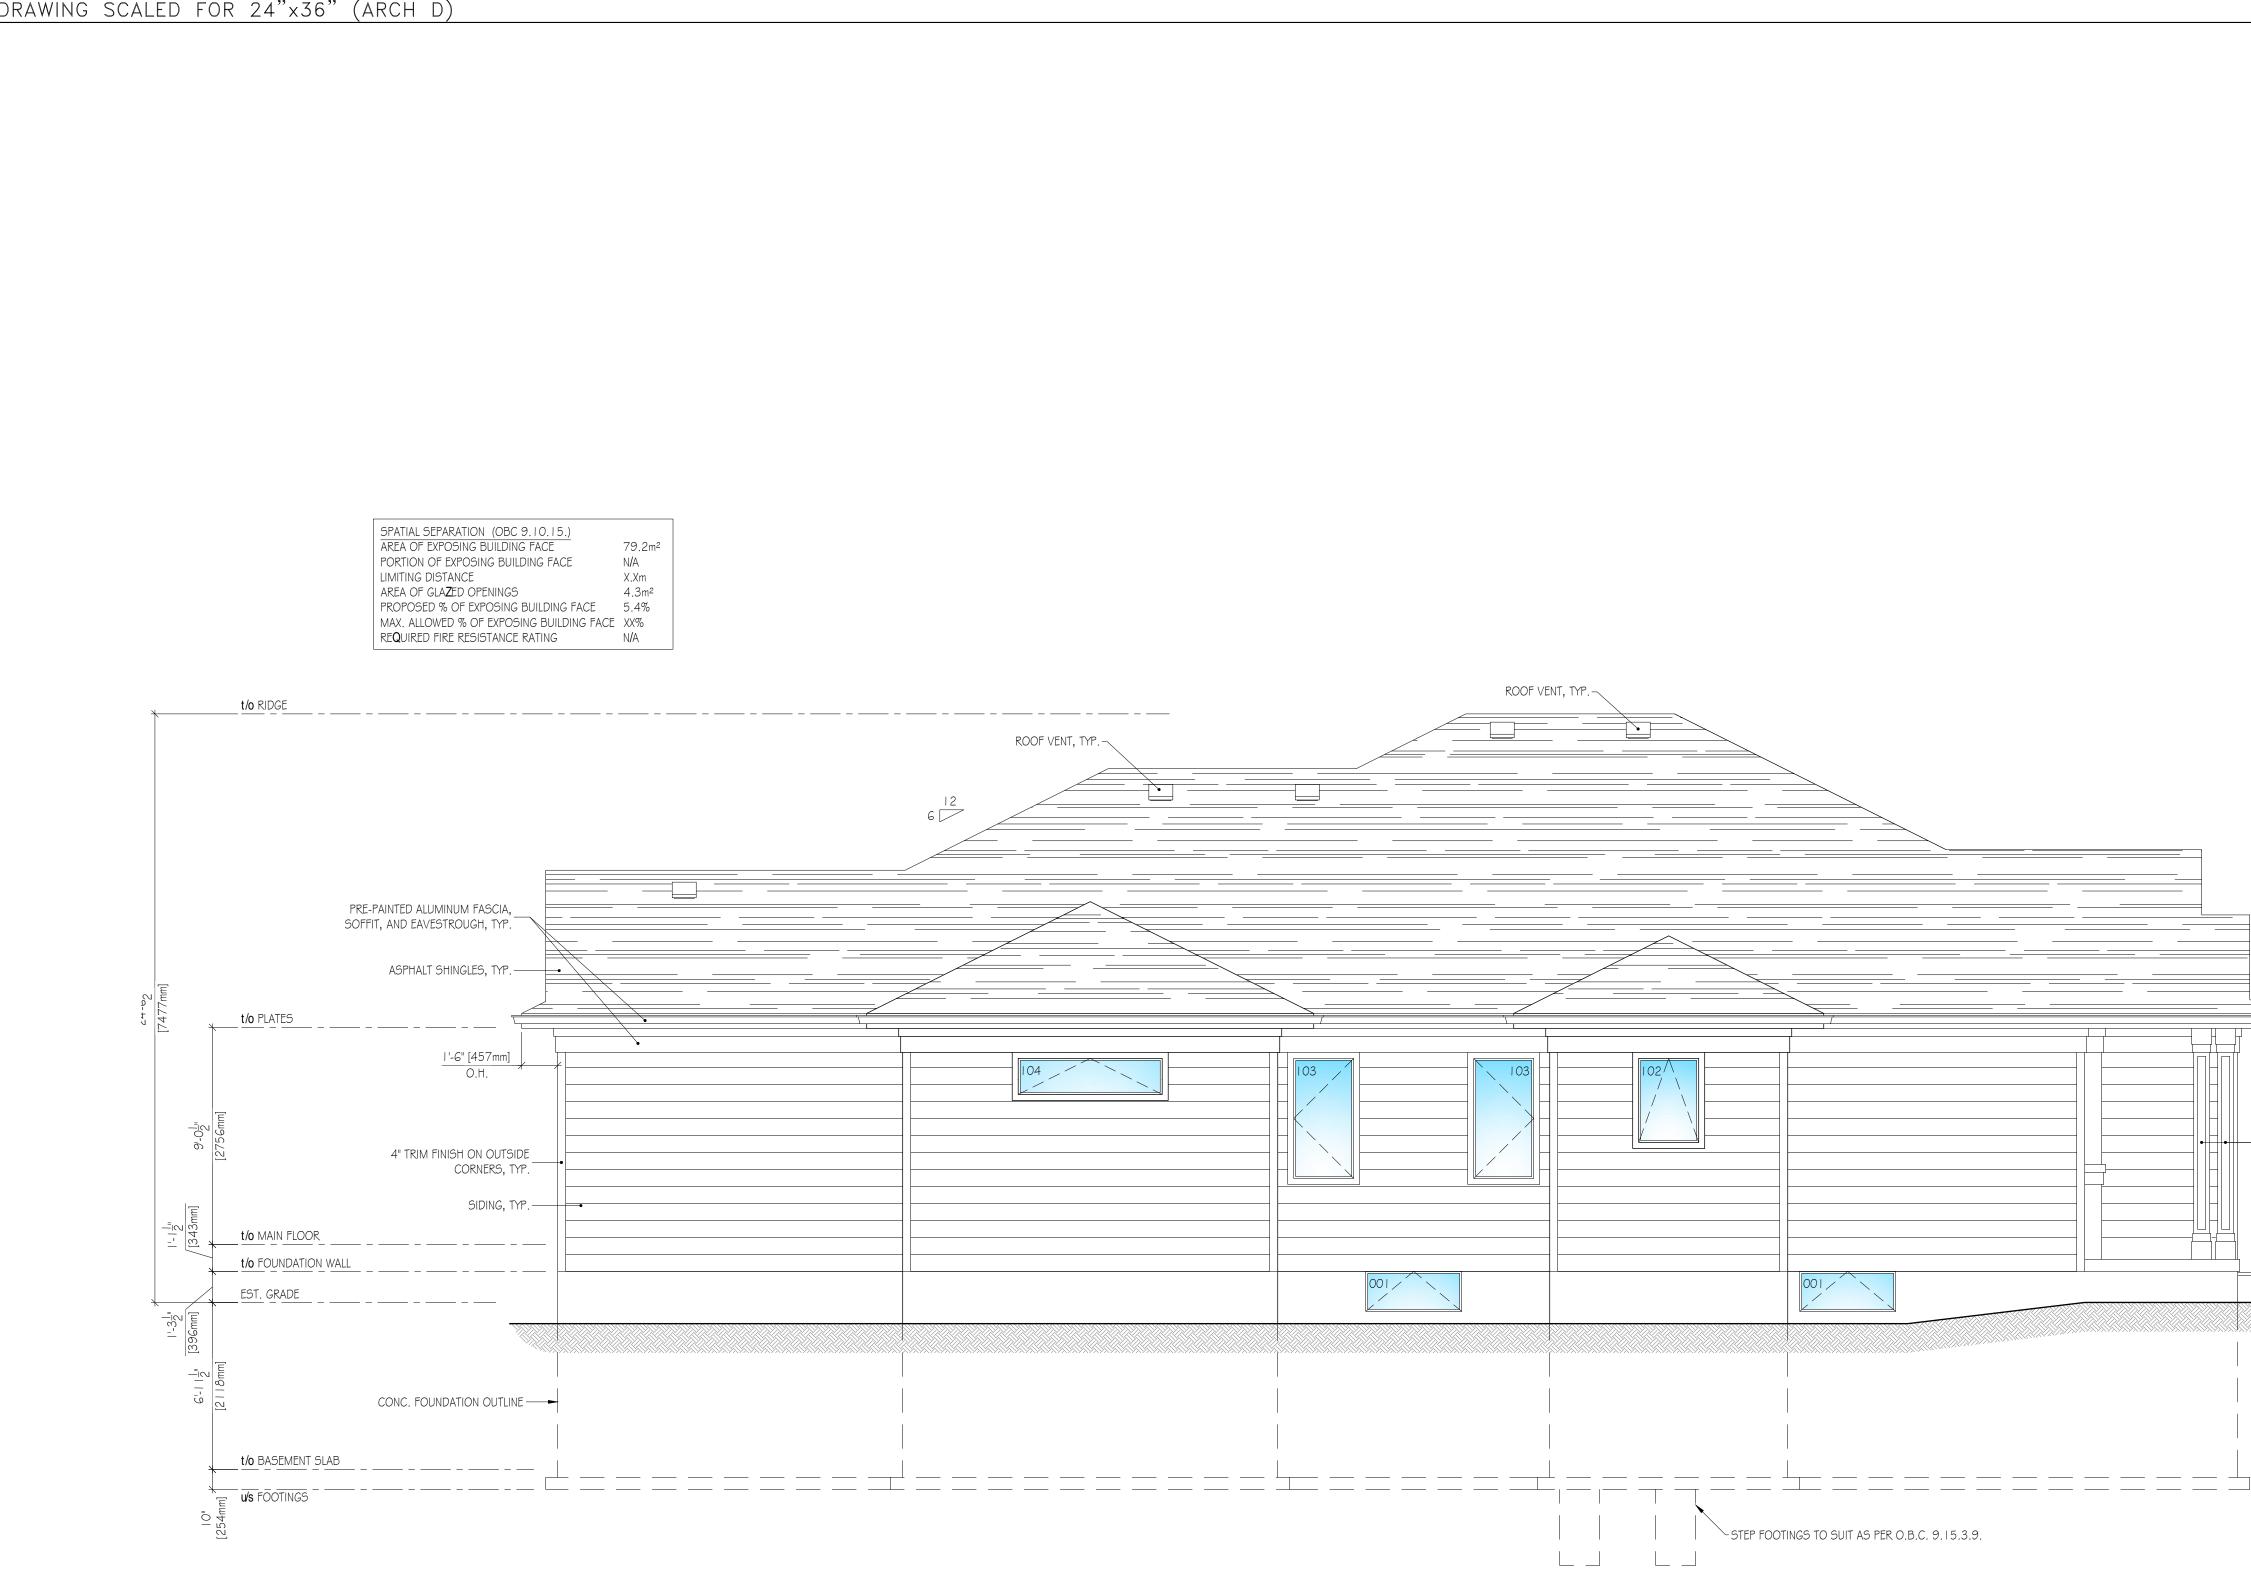


					AI ELEVATIONS A2 ELEVATIONS A3 BASEMENT FLO A4 MAIN FLOOR PLANS A6 SECTION, DETA LEGEND © SMOKE ALARM, © CARBON MONO EXHAUST FAN © FLOOR DRAIN 001	STRUCTION NOTES, & SITE PLA OOR PLAN AN MILS, AND SCHEDULES SEE CONST. NOTES EXIDE ALARM CIATED SCHEDULE NUMBER OCIATED SCHEDULE NUMBER
	DOOR S	<u>SCHEDULE</u> SI <b>Z</b> E	HARDWARE	NOTES	C NEW 2'-0" x 2'-0" C/w. 8-10M REBA	:
	001	34 <b>x</b> 80	PASSAGE SET	EXTERIOR GRADE		BE DESIGNED BY OTHERS
	002	34 <b>x</b> 80	PRIVACY SET	EXTERIOR GRADE C/W GAS SEAL & SELF-CLOSING DEVICE	NEW G <b>x</b> G POST W BEARING ON FOU	SUITABLE SADDLE
	100	36 <b>x</b> 84	PRIVACY SET	FRONT DOOR <b>c/w</b> 1 2x84 SIDELIGHT		NIMUM 3 1/2" SOLID LEVEL
	101	(2)-30 <b>x</b> 84	PRIVACY SET	EXTERIOR GRADE	BEARING FOR NEV	V BEAM / LINTEL
	102	32 <b>x</b> 80	PRIVACY SET	EXTERIOR GRADE	TYPICAL NOTES	
	103	108 <b>x</b> 96	N/A	GARAGE DOOR W/ ARCHED FRAME, SEE ELEVATION		
	104	32 <b>x</b> 80	PRIVACY SET	EXTERIOR GRADE C/W GAS SEAL & SELF-CLOSING DEVICE	STAIRS (AS PER O.B.C.	
	105	30 <b>x</b> 80	DUMMY SET		• RISE - MIN. 4 <sup>7</sup> / <sub>8</sub> , MAX.	•
	106	32 <b>x</b> 80	PASSAGE SET		• RUN - MIN. $8\frac{1}{4}$ , MAX.	4"
	107				HANDRAILS (AS PER O.E	.C. 9.8.7)
		(2)-30 <b>x</b> 80			• MIN. 2'-10" HIGH, MAX	(, 3'-2" HIGH
	108	30 <b>x</b> 80	PRIVACY SET		OPENINGS BETWEEN P	ICKETS TO BE LESS THAN 4"
	109	30 <b>x</b> 80	PRIVACY SET	POCKET DOOR	GUARDS (AS PER O.B.C	. 9.8.8)
	110	30 <b>x</b> 80	PRIVACY SET		• MIN. 2'-11" HIGH, U.N	0.
	111	24 <b>x</b> 80	DUMMY SET		OPENINGS BETWEEN P	ICKETS TO BE LESS THAN 4"
	112	32 <b>x</b> 80	PASSAGE SET			
	113	(2)-30 <b>x</b> 80	DUMMY SET			
	4	8 <b>x</b> 80	DUMMY SET			DATE
	115	32 <b>x</b> 80	PRIVACY SET			NCE APPLICATION MAR. 2
	116	30 <b>x</b> 80	PASSAGE SET			
	7	32 <b>x</b> 80	PASSAGE SET			
	118	30 <b>x</b> 80	PRIVACY SET		client	
	119	(2)-20 <b>x</b> 80	DUMMY SET			IE OWNER
	120	32 <b>x</b> 80	PASSAGE SET			
VINDOW SCH		TYPE FRAM	1E GLA <b>Z</b> ING	NOTES		RS GREEN ROAD FER, ONTARIO
01 3	48 <b>x</b> 20		INUM DOUBLE	EGRESS WINDOW	PROJ	ECT No. 21-001
02 2	48 <b>x</b> 20		AINUM DOUBLE		title	
01 1	40 <b>x</b> 20	CASEMENT ALUN		SEE ELEVATION FOR OPERATION		
				JEE ELEVATION FOR OF ENATION	FRONT (W	EST) ELEVATION
02	30 <b>x</b> 42		INUM DOUBLE			
Q	30 <b>x</b> 60	CASEMENT ALUN		SEE ELEVATIONS FOR OPERATION & ORIENTATION	drawn	checked
	72 <b>x</b>  8	AWNING ALUN	IINUM DOUBLE	SILL TO BE 6'-6" ABOVE FLOOR	G.D.	- scale
04 I						Jodic
	48 <b>x</b> 60	FIXED ALUN	IINUM DOUBLE		MARCH 2021	1/4" = 1'-0"
04 I		FIXED ALUN CASEMENT ALUN		SEE ELEVATION FOR OPERATION	MARCH 2021 revision number	1/4" = 1'-0" drawing number A2.01

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				LEGEND
				SMOKE ALARM, SEE CONST. NOTES
				© CARBON MONOXIDE ALARM
				EXHAUST FAN
				FLOOR DRAIN
				DOOR & ASSOCIATED SCHEDULE NUMB
				001
LUMNS WRAPPED TIVELY, TYP.				WINDOW & ASSOCIATED SCHEDULE NUN
				**LINTEL & BEAM SCHEDULE T.B.D.**
				LI (2) - 2" <b>x</b> 6" S-P-F
				L2 (2) - 2" x 8" S-P-F L3 (2) - 2" x 10" S-P-F
				L4 (2) - 2" <b>x</b>   2" S-P-F
				L5 (3) - 2" <b>x</b> 8" S-P-F L6 (3) - 2" <b>x</b> 10" S-P-F
				$L^{(3)} = 2 \times 10^{-3-1-1}$ L7 (3) = 2" x   2" S-P-F
				L8 3ply 2.0E 13/4" x1 11/4" LVL
				BI W8x2I STEEL BEAM
				**COLUMN LEGEND T.B.D.**
	DOORS	SCHEDULE		NEW SUITABLE ADJUSTABLE STEEL COLUM NEW 2'-0" x 2'-0" x 9" THICK CONCRETE FO
	NUMBER	SI <b>Z</b> E HARDWARE	NOTES	c/w. 8-10M REBARS E/W.
	001	34 <b>x</b> 80 PASSAGE SET	EXTERIOR GRADE	
	002 100	34 <b>x</b> 80 PRIVACY SET 36 <b>x</b> 84 PRIVACY SET	EXTERIOR GRADE <b>c/w</b> GAS SEAL & SELF-CLOSING DEVICE FRONT DOOR <b>c/w</b> I 2 <b>x</b> 84 SIDELIGHT	NEW 6x6 POST ₩/ SUITABLE SADDLE BEARING ON FOUNDATION BELOW
	100	36 <b>x</b> 84 PRIVACY SET (2)-30 <b>x</b> 84 PRIVACY SET	EXTERIOR GRADE	SPROVIDE NEW MINIMUM 3½" SOLID LEVEL ■ BEARING FOR NEW BEAM / LINTEL
	102	32x80 PRIVACY SET	EXTERIOR GRADE	BEARING FOR NEW BEAM / LINIEL
	103	108 <b>x</b> 96 N/A	GARAGE DOOR W/ ARCHED FRAME, SEE ELEVATION	TYPICAL NOTES
	104	32x80 PRIVACY SET	EXTERIOR GRADE C/W GAS SEAL & SELF-CLOSING DEVICE	STAIRS (AS PER O.B.C. 9.8)
	105	30x80 DUMMY SET		• RISE - MIN. $4\frac{7}{8}$ , MAX. $7\frac{7}{8}$
	106	32 <b>x</b> 80 PASSAGE SET		• RUN - MIN. 8¼, MAX. 14"
	107	(2)-30 <b>x</b> 80 DUMMY SET		HANDRAILS (AS PER O.B.C. 9.8.7)
	108	30x80 PRIVACY SET		MIN. 2'-10" HIGH, MAX. 3'-2" HIGH     OPENINGS BETWEEN PICKETS TO BE LESS THAP
	109	30x80 PRIVACY SET	POCKET DOOR	
	110	30x80 PRIVACY SET		GUARDS (AS PER O.B.C. 9.8.8) • MIN. 2'-1 I " HIGH, U.N.O.
		24 <b>x</b> 80 DUMMY SET		OPENINGS BETWEEN PICKETS TO BE LESS THAT
	112	32 <b>x</b> 80 PASSAGE SET		
	113	(2)-30 <b>x</b> 80 DUMMY SET		
	114	18 <b>x</b> 80 DUMMY SET		REV. DESCRIPTION DAT
	115	32 <b>x</b> 80 PRIVACY SET		0 FOR MINOR VARIANCE APPLICATION MAR
	116	30x80 PASSAGE SET		
	117	32x80 PASSAGE SET		
	118	30x80 PRIVACY SET		
	119	(2)-20 <b>x</b> 80 DUMMY SET		client
	120	32 <b>x</b> 80 PASSAGE SET		HOME OWNER
				project
WINDOW SCHE				189 FIDDLERS GREEN ROAD ANCASTER, ONTARIO
NUMBER COUNT	SIZE	TYPE FRAME GLAZING	NOTES	PROJECT No. 21-001
001 3	48 <b>x</b> 20	AWNING ALUMINUM DOUBLE	EGRESS WINDOW	
002 2	48 <b>x</b> 20	AWNING ALUMINUM DOUBLE		title
101 1	60 <b>x</b> 48	CASEMENT ALUMINUM DOUBLE	SEE ELEVATION FOR OPERATION	SIDE (NORTH) ELEVATION
102 1	30 <b>x</b> 42	AWNING ALUMINUM DOUBLE	CEE ELEVATIONS EOD OPERATION & OPERATION	
103 8 104 I	30 <b>x</b> 60	CASEMENT ALUMINUM DOUBLE	SEE ELEVATIONS FOR OPERATION & ORIENTATION	drawn checked - G.D
1 1/1/1	72 <b>x</b>  8 48 <b>x</b> 60	AWNING ALUMINUM DOUBLE	SILL TO BE 6'-6" ABOVE FLOOR	date scale
	(L≻Y(-())	FIXED ALUMINUM DOUBLE		MARCH 2021 1/4" = 1'-0"
105 I 106 I	72 <b>x</b> 60	CASEMENT ALUMINUM DOUBLE	SEE ELEVATION FOR OPERATION	revision number drawing number

6**x**6

DEC

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DRAWING LIST

ELEVATIONS

A4 MAIN FLOOR PLAN

A5 ROOF PLANS

A2 ELEVATIONS A3 BASEMENT FLOOR PLAN

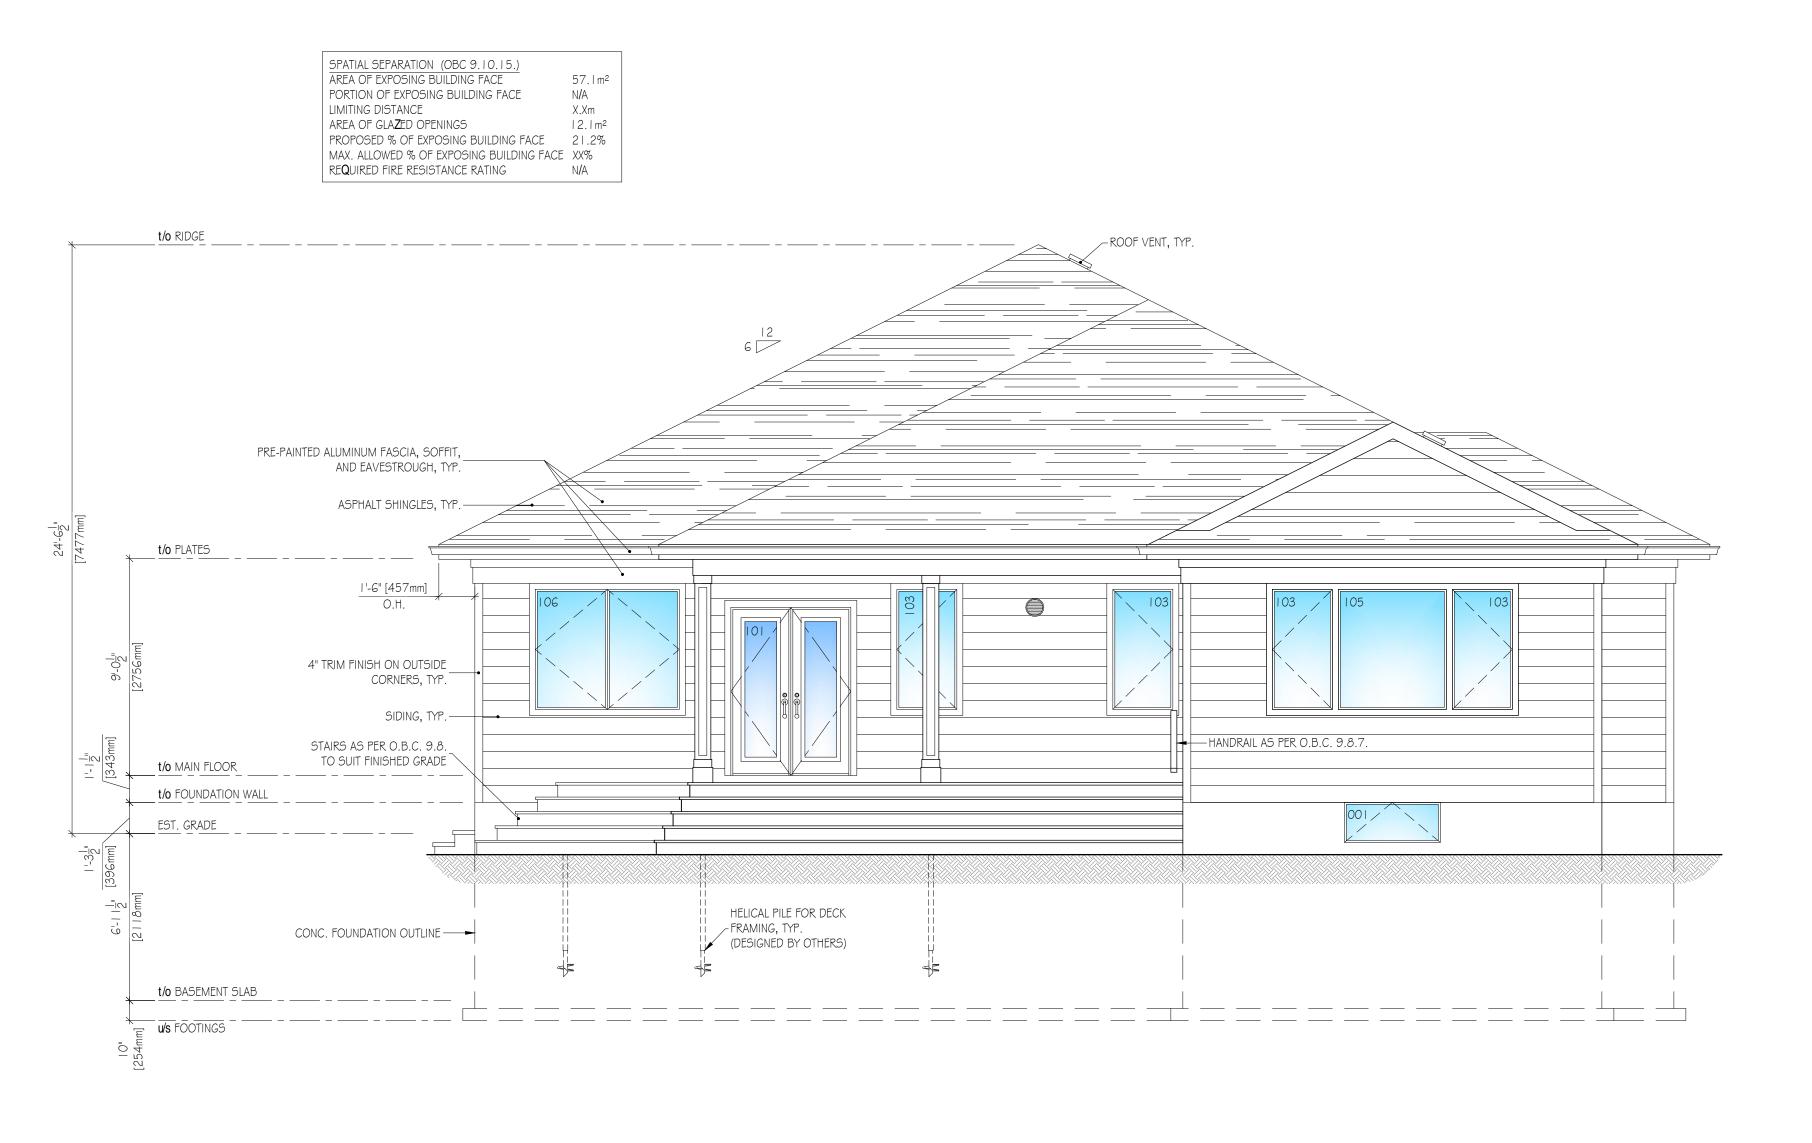
AG SECTION, DETAILS, AND SCHEDULES

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AO KEY PLAN, SCOPE OF WORK, GENERAL & CONSTRUCTION NOTES, & SITE PLAN



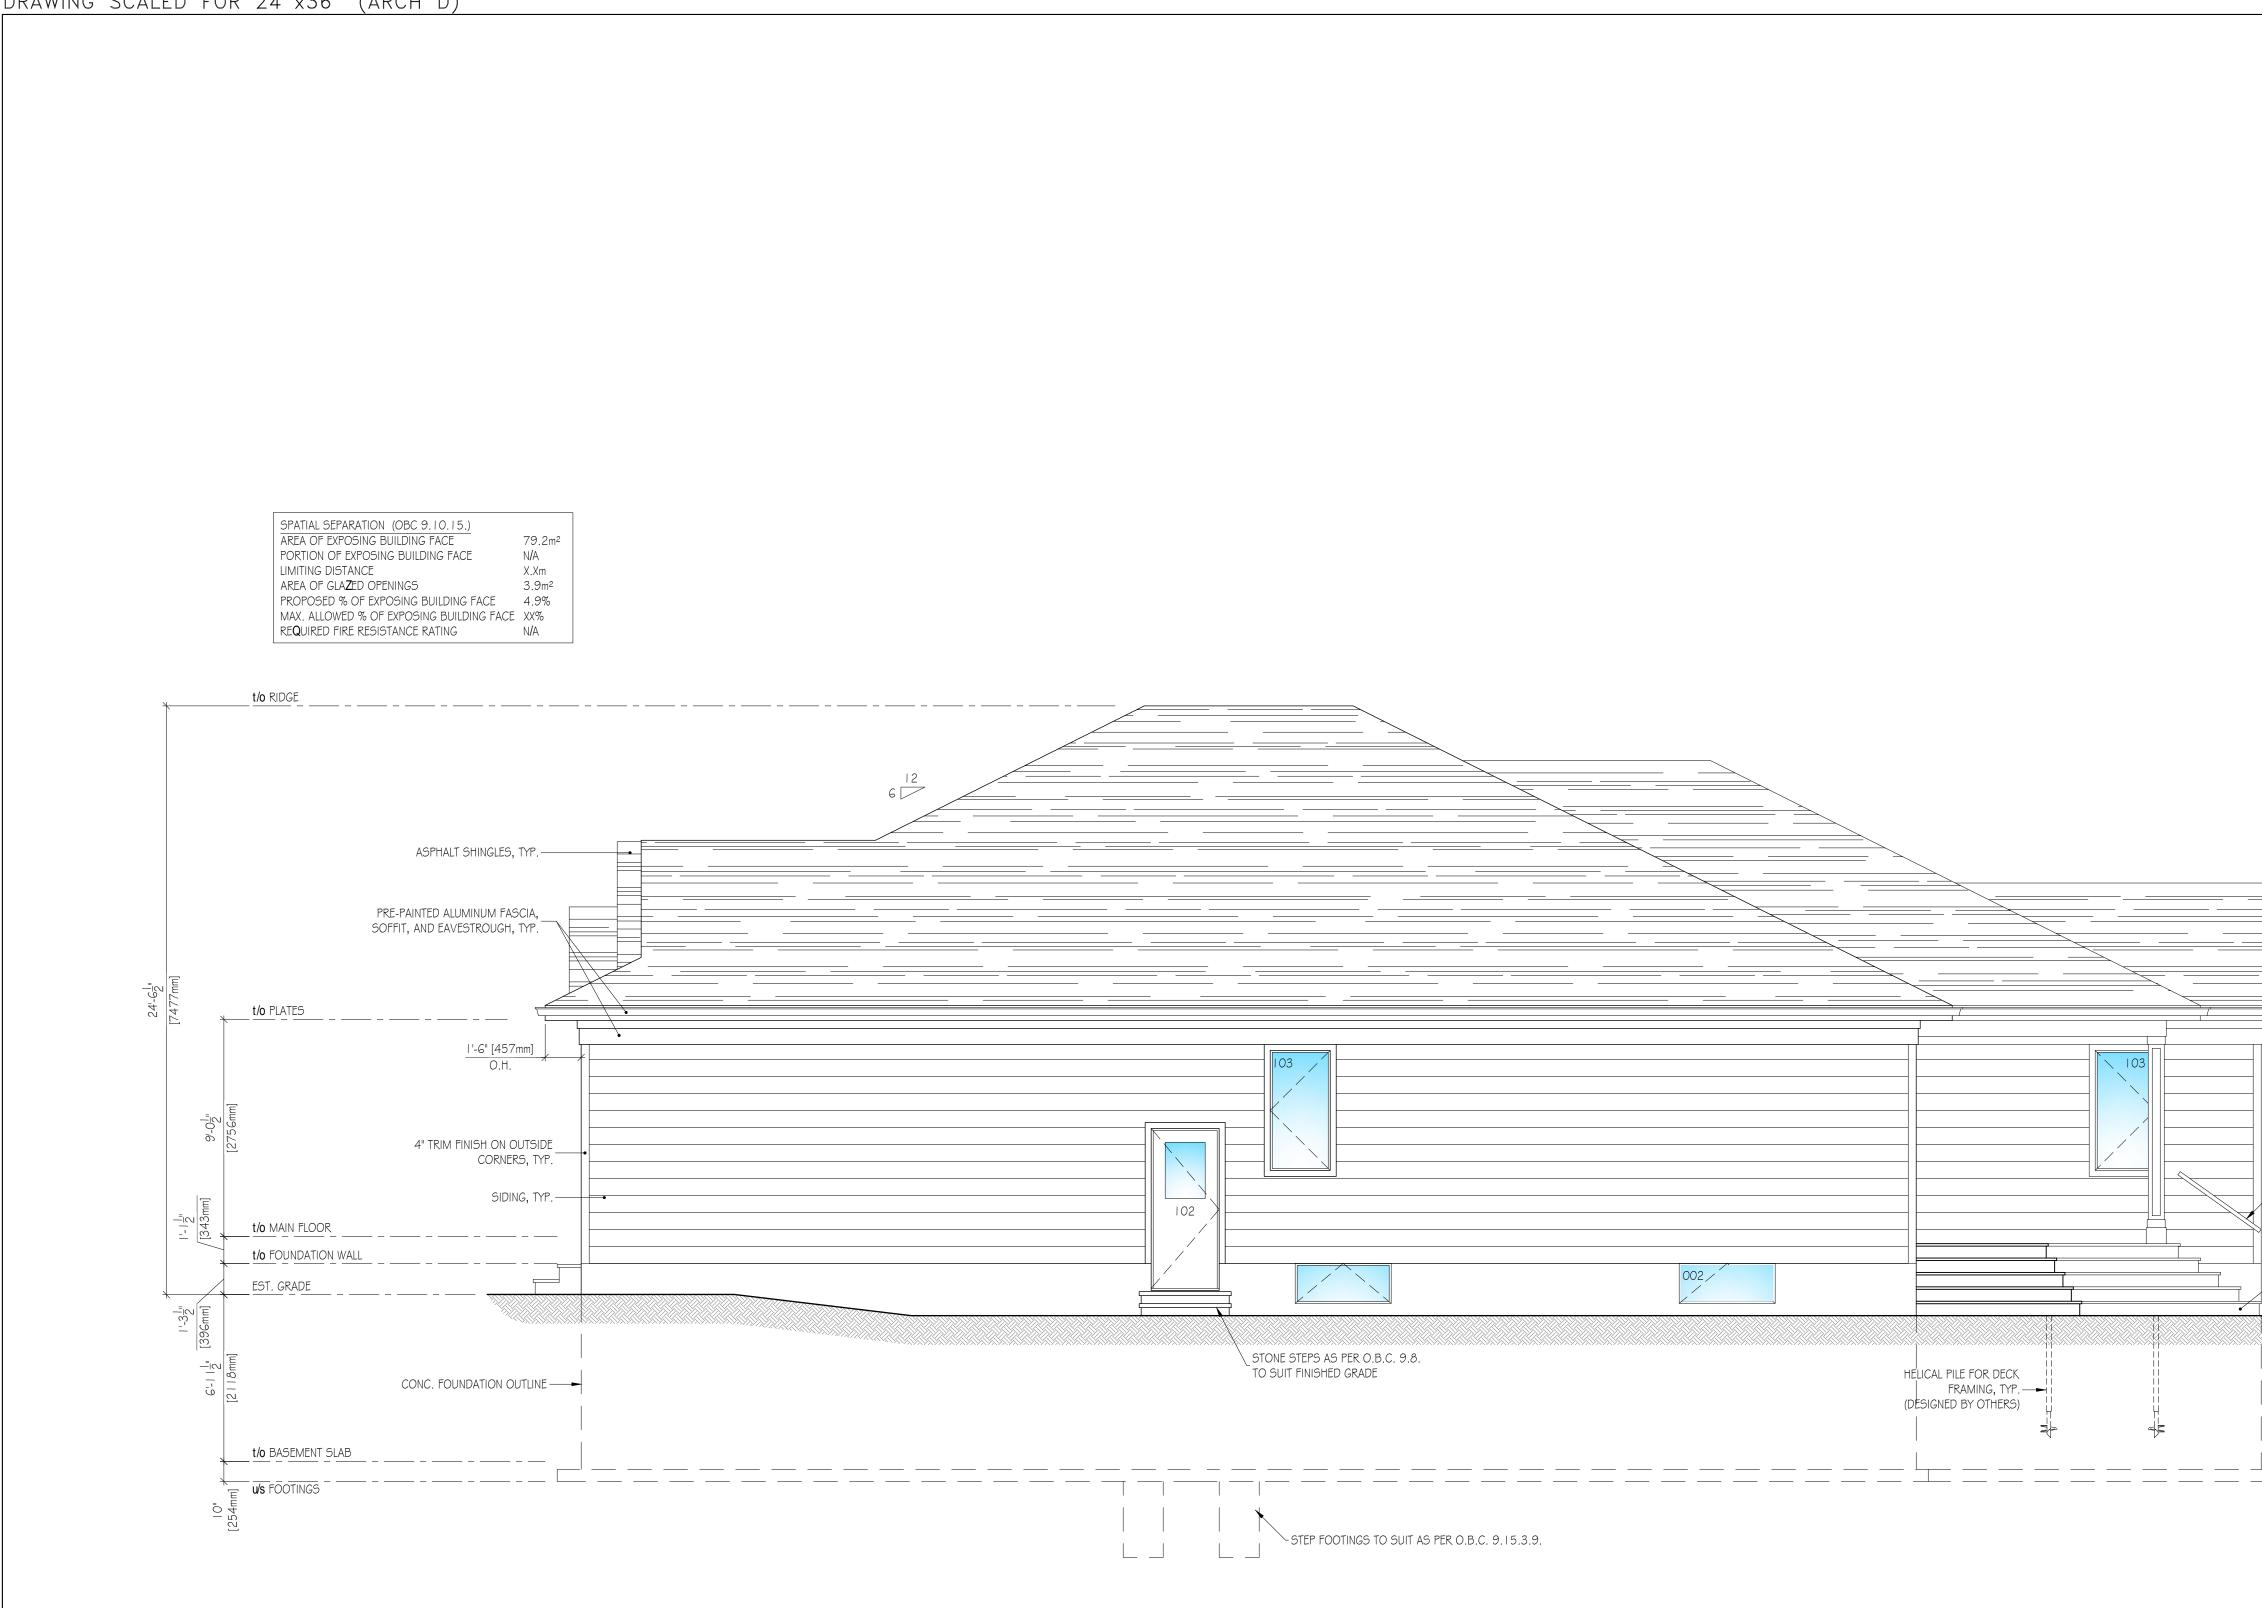
	DOOR SCH				GENERAL & CO         A1       ELEVATIONS         A2       ELEVATIONS         A3       BASEMENT FL         A4       MAIN FLOOR F         A5       ROOF PLANS         A6       SECTION, DET         LEGEND <ul> <li>CARBON MON</li> <li>EXHAUST FAN</li> <li>FLOOR DRAIN</li> <li>DOOR &amp; ASSO</li> <li>WINDOW &amp; ASS</li> </ul> **LINTEL & BEAM S         L1       (2) - 2" x 6" S-P-F         L2       (2) - 2" x 8" S-P-F         L3       (2) - 2" x 10" S-P-F         L4       (2) - 2" x 8" S-P-F         L3       (2) - 2" x 10" S-P-F         L6       (3) - 2" x 10" S-P-F         L8       3ply 2.0E 13/4" x1         B1       W8x21 STEEL BEA         **COLUMN LEGEN       NEW SUITABLE A	PLAN AILS, AND SCHEDULES A, SEE CONST. NOTES OXIDE ALARM CIATED SCHEDULE NUMBER BOCIATED SCHEDULE NUMBER BCHEDULE T.B.D.** F F F F F I J4" LVL M D T.B.D.** DJUSTABLE STEEL COLUMN OI Y 9" THICK CONCRETE FOOTIN
	NUMBER	SIZE	HARDWARE	NOTES		ARS E/W. BE DESIGNED BY OTHERS
	001 002	34 <b>x</b> 80 34 <b>x</b> 80	PASSAGE SET PRIVACY SET	EXTERIOR GRADE EXTERIOR GRADE <b>c/w</b> GAS SEAL & SELF-CLOSING DEVICE	NEW 6x6 POST N	<b>V</b> SUITABLE SADDLE
	100	36 <b>x</b> 84	PRIVACY SET	FRONT DOOR <b>c/w</b>   2 <b>x</b> 84 SIDELIGHT	DLARING ON TO	
	101		PRIVACY SET	EXTERIOR GRADE	BEARING FOR NE	INIMUM 3 ½" SOLID LEVEL EW BEAM / LINTEL
	102	32 <b>x</b> 80	PRIVACY SET	EXTERIOR GRADE	TYPICAL NOTES	
	103	108 <b>x</b> 96	N/A PRIVACY SET	GARAGE DOOR W/ ARCHED FRAME, SEE ELEVATION	STAIRS (AS PER O.B.C.	9.8)
	104 105	32 <b>x</b> 80 30 <b>x</b> 80	PRIVACY SET DUMMY SET	EXTERIOR GRADE <b>c/w</b> GAS SEAL & SELF-CLOSING DEVICE	• RISE - MIN. 4 <sup>7</sup> / <sub>8</sub> , MAX.	$7\frac{7}{8}^{-1}$
	105	30 <b>x</b> 80	PASSAGE SET		• RUN - MIN. $\mathcal{S}_{4}^{\perp_{\parallel}}$ , MAX.	4 <sup>n</sup>
	107		DUMMY SET		HANDRAILS (AS PER O.	
	108	30 <b>x</b> 80	PRIVACY SET			X. 3'-2" HIGH PICKETS TO BE LESS THAN 4"
	109	30 <b>x</b> 80	PRIVACY SET	POCKET DOOR	GUARDS (AS PER O.B.C	
	110	30 <b>x</b> 80	PRIVACY SET		MIN. 2'-1 I" HIGH, U.N     OPENINGS BETWEEN	N.O. PICKETS TO BE LESS THAN 4"
		24 <b>x</b> 80 32 <b>x</b> 80	DUMMY SET PASSAGE SET			
	3		DUMMY SET			
	4	18 <b>x</b> 80	DUMMY SET		REV. DESCRIPTION	DATE
	115	32 <b>x</b> 80	PRIVACY SET		0 FOR MINOR VARIA	ANCE APPLICATION MAR. 29
	116	30 <b>x</b> 80	PASSAGE SET			
	7	32 <b>x</b> 80	PASSAGE SET			
	118	30 <b>x</b> 80	PRIVACY SET		client	I
	9   20	(2)-20 <b>x</b> 80 32 <b>x</b> 80	DUMMY SET PASSAGE SET		HO	MEOWNER
L VINDOW SCHE UMBER COUNT	SI <b>Z</b> E TYI			NOTES	ANCAS	ERS GREEN ROAD TER, ONTARIO JECT No. 21-001
01 3			INUM DOUBLE	EGRESS WINDOW		JEOT NO. 21-001
02 2 DI I	60 <b>x</b> 48 CA	SEMENT ALUN	IINUM DOUBLE	SEE ELEVATION FOR OPERATION	titte REAR (E	AST) ELEVATION
02			INUM DOUBLE	CEE ELEVATIONIC EOD ODERATION & ODIEUTITION		
03 8 04 I			IINUM DOUBLE	SEE ELEVATIONS FOR OPERATION & ORIENTATION SILL TO BE 6'-6" ABOVE FLOOR	drawn G.D.	checked -
04 I 05 I	72 <b>x</b> 18 AW 48 <b>x</b> 60 FIX		INUM DOUBLE	JILL IU UL 6-6 AUUVLILUUN	date	scale
06 1			INUM DOUBLE	SEE ELEVATION FOR OPERATION	MARCH 2021	1/4" = 1'-0"
		/				ulawing numero

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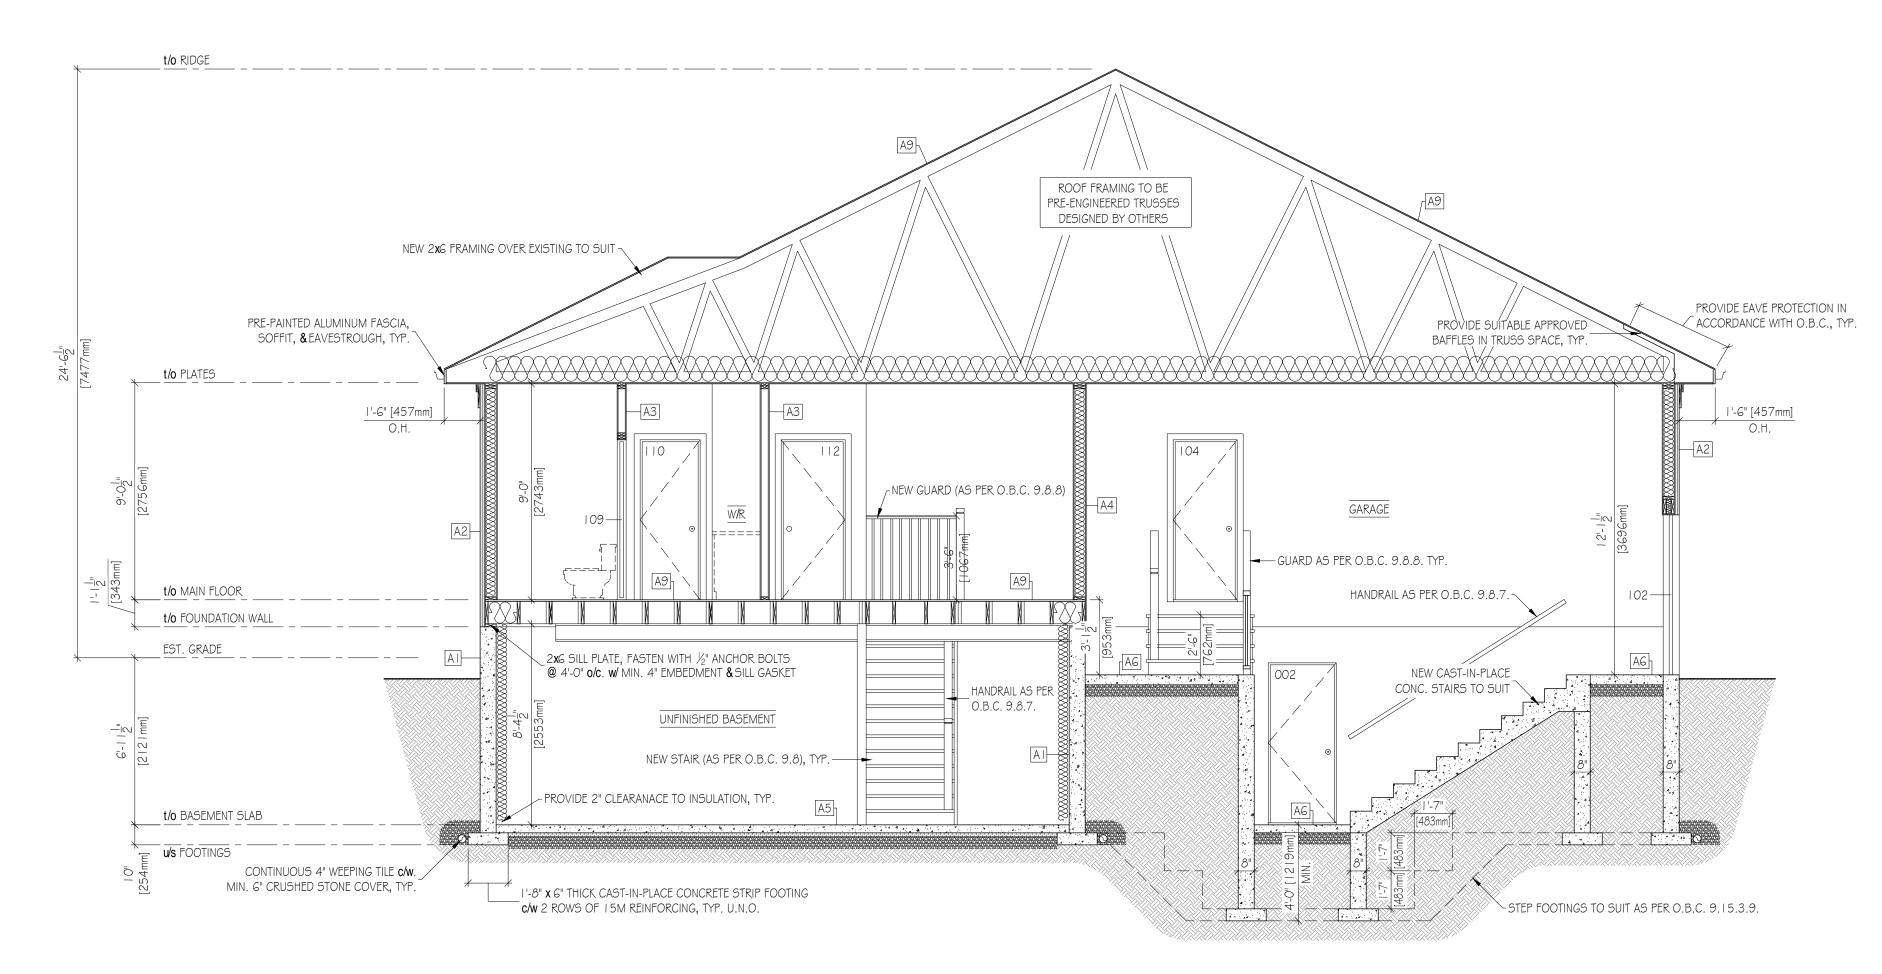
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					THIS DRAWING IS NOT TO BE USED AS PART OF A BUILDING PERMIT APPLICATION THIS DRAWING IS FOR DISCUSSION PURPOSES ONLY
					DRAWING LIST         A0       KEY PLAN, SCOPE OF WORK, GENERAL & CONSTRUCTION NOTES, & SITE PLAN         A1       ELEVATIONS         A2       ELEVATIONS         A3       BASEMENT FLOOR PLAN         A4       MAIN FLOOR PLAN         A5       ROOF PLANS         A6       SECTION, DETAILS, AND SCHEDULES         LEGEND       SMOKE ALARM, SEE CONST. NOTES         Image: Complexity of the section of the secti
HANDRAIL AS PER O.B.C. 9 STAIRS AS PER O.B.C. 9.8 TO SUIT FINISHED GRADE					FLOOR DRAIN DOOR & ASSOCIATED SCHEDULE NUMBER OOI WINDOW & ASSOCIATED SCHEDULE NUMBER **LINTEL & BEAM SCHEDULE T.B.D.** L1 (2) - 2" x 6" S-P-F L2 (2) - 2" x 8" S-P-F L3 (2) - 2" x 10" S-P-F L4 (2) - 2" x 10" S-P-F L5 (3) - 2" x 8" S-P-F L6 (3) - 2" x 10" S-P-F L7 (3) - 2" x 12" S-P-F L8 3ply 2.0E 1 <sup>3</sup> / <sub>4</sub> " x 11/ <sub>4</sub> " LVL B1 W8x21 STEEL BEAM
~	DOOR SC	CHEDULE SI <b>Z</b> E	HARDWARI	E NOTES	**COLUMN LEGEND T.B.D.** NEW SUITABLE ADJUSTABLE STEEL COLUMN ON CNEW 2'-O" x 2'-O" x 9" THICK CONCRETE FOOTING C/W. 8-1 OM REBARS EW.
	001 002 100 101 102 103 104 105	34x80 34x80 36x84 (2)-30x84 32x80 108x96 32x80 30x80	PASSAGE S PRIVACY S PRIVACY S PRIVACY S PRIVACY S N/A PRIVACY S DUMMY SE	ETEXTERIOR GRADE c/w GAS SEAL & SELF-CLOSING DETFRONT DOOR c/w I 2x84 SIDELIGHTETEXTERIOR GRADEETEXTERIOR GRADEGARAGE DOOR w/ ARCHED FRAME, SEE ELEVATIONETEXTERIOR GRADE c/w GAS SEAL & SELF-CLOSING D	N BEARING ON FOUNDATION BELOW BEARING FOR NEW MINIMUM 3 ½" SOLID LEVEL BEARING FOR NEW BEAM / LINTEL TYPICAL NOTES
	106 107 108 109 110 111 112	32x80 (2)-30x80 30x80 30x80 30x80 24x80 32x80	PASSAGE :	GET IT ET ET POCKET DOOR ET IT	<ul> <li>RUN - MIN. 8<sup>1</sup>/<sub>4</sub>", MAX. 14"</li> <li>HANDRAILS (AS PER O.B.C. 9.8.7)</li> <li>MIN. 2'-10" HIGH, MAX. 3'-2" HIGH</li> <li>OPENINGS BETWEEN PICKETS TO BE LESS THAN 4"</li> <li>GUARDS (AS PER O.B.C. 9.8.8)</li> <li>MIN. 2'-11" HIGH, U.N.O.</li> <li>OPENINGS BETWEEN PICKETS TO BE LESS THAN 4"</li> </ul>
	3   4   5   6   7   8   9   20	(2)-30x8(   8x80 32x80 30x80 32x80 30x80 (2)-20x8( 32x80	DUMMY SE PRIVACY S PASSAGE S PASSAGE S PRIVACY S	т ЕТ БЕТ ЕТ Т	REV. DESCRIPTION     DATE       0     FOR MINOR VARIANCE APPLICATION     MAR. 29,       0     Image: Second
					189 FIDDLERS GREEN ROAD ANCASTER, ONTARIO
WINDOW SCH		TYPE ED *	ME GLAZ		PROJECT No. 21-001
NUMBER         COUNT           001         3           002         2	51 <b>Z</b> E 48 <b>x</b> 20 48 <b>x</b> 20	AWNING ALL	IMINUM DOU	BLE	title
NUMBER COUNT	51 <b>Z</b> E 1 48 <b>x</b> 20 4 48 <b>x</b> 20 4 60 <b>x</b> 48 ( 30 <b>x</b> 42 4 30 <b>x</b> 60 (	AWNING ALL AWNING ALL CASEMENT ALL AWNING ALL CASEMENT ALL	IMINUM DOU IMINUM DOU IMINUM DOU	BLE SEE ELEVATION FOR OPERATION BLE SEE ELEVATIONS FOR OPERATION & ORIENTATION	SIDE (SOUTH) ELEVATION

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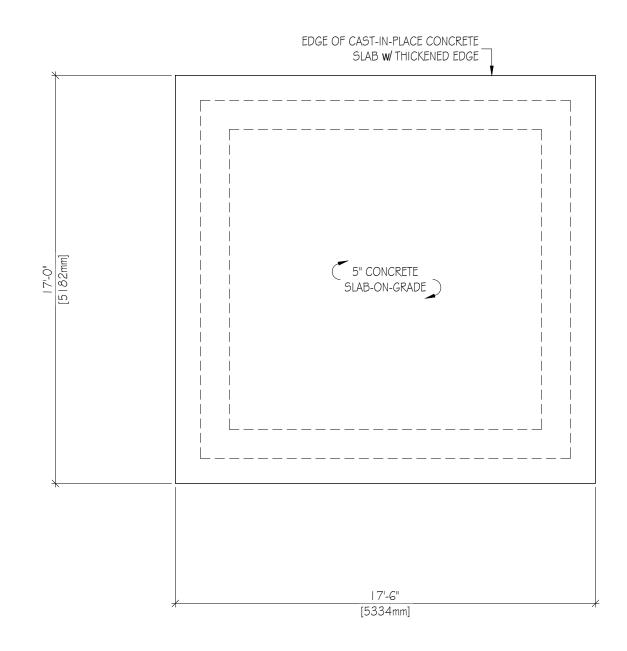
<u>ر</u>	RAWING	SCALED	FUR	Ζ4	XSC	<u>) (</u>
	ASSEMBLIES	SCHEDULE				
	AI FOUNDATIO	R BARRIER				
	8" CAST-IN-PLACE APPROVED DAMPF	CONCRETE FOU ROOFING & DRA	NDATION W			
	A2 EXTERIOR S SIDING BUILDING PAPER					
	I" (R-5 XPS ci.) [LA ½" PLYWOOD SHEA 2xG WOOD STUDE	THING @  6" <b>o/c</b> .	AMS]			
	C/W R22 BATT INSI Gmil. POLY VAPOU ½" GYPSUM BOARI	R BARRIER				
	A3 INTERIOR P 2x4 WOOD STUDE 1/2" GYPSUM BOAR	0 @ 16" <b>o/c</b> . (U.N	1.0.)			
	A4 GARAGE PA	D				
	2xG WOOD STUDE c/w R22 BATT INSI Gmil POLY VAPOUR //" GYPSUM BOAR	ULATION BARRIER [HEAT	ED SIDE]			
	A5 BASEMENT MIN. 4" CONCRETE	SLAB	e [25MP <b>a</b> ]			
	2" (R-10 XPS) 6" COARSE CLEAR					
	[AG]—GARAGE SL MIN. 5" CONCRETE c/w. 6 x 6, 6/6 WV 6" COARSE CLEAR	SLAB-ON-GRAD	e [25MP <b>a</b> ]			
	A7 PORCH SLA MIN. 5" CONCRETE c/w 10M REBARS 24" x 24" BENT10	SLAB-ON-GRAD @ 8" <b>0/c e/w</b>		RIMFTFR		
	PROVIDE MINIMUN 6" COARSE CLEAR	1 3" EDGE BEARI	NG FOR SLA	λВ		
	A8 FLOOR ASS 3/4" PLYWOOD SHE JOISTS AS NOTED ( c/w X-BRIDGING @	ATHING DN PLANS				
	A9 ROOF ASS ASPHALT SHINGLE	EMBLY				
	UNDERLAYMENT (IC 2" PLYWOOD SHEA PRE-ENGINEERED T	CE <b>&amp;</b> WATER SHIE ATHING	,			
	MIN. RGO BLOWN- Gmil. POLY VAPOU %" GYPSUM BOARI	IN INSULATION R BARRIER	ILNU			
	AIO PORCH &I ASPHALT SHINGLE	DECK ROOF ASS	EMBLY			
	UNDERLAYMENT (IC /2" PLYWOOD SHEA PRE-ENGINEERED T	THING				
	I -3/4" PLANKING FIN					



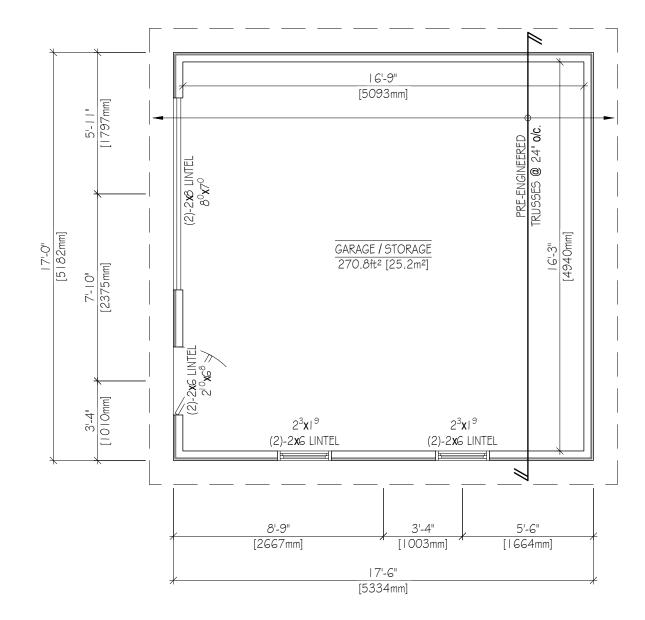
					TO BE USED AS PART OF A BUILDING PERMIT APPLICATION THIS DRAWING IS FOR DISCUSSION PURPOSES ONLY
	DOOR 5	CHEDULE			DRAWING LIST         A0       KEY PLAN, SCOPE OF WORK, GENERAL & CONSTRUCTION NOTES, & SITE PLAN         A1       ELEVATIONS         A2       ELEVATIONS         A3       BASEMENT FLOOR PLAN         A4       MAIN FLOOR PLAN         A5       ROOF PLANS         A6       SECTION, DETAILS, AND SCHEDULES         LEGEND       Image: Construction Monoxide Alarm         Image: Construction Monoxide Alarm       Image: Construction Monoxide Alarm         Image: Construction Monoxide Alarm<
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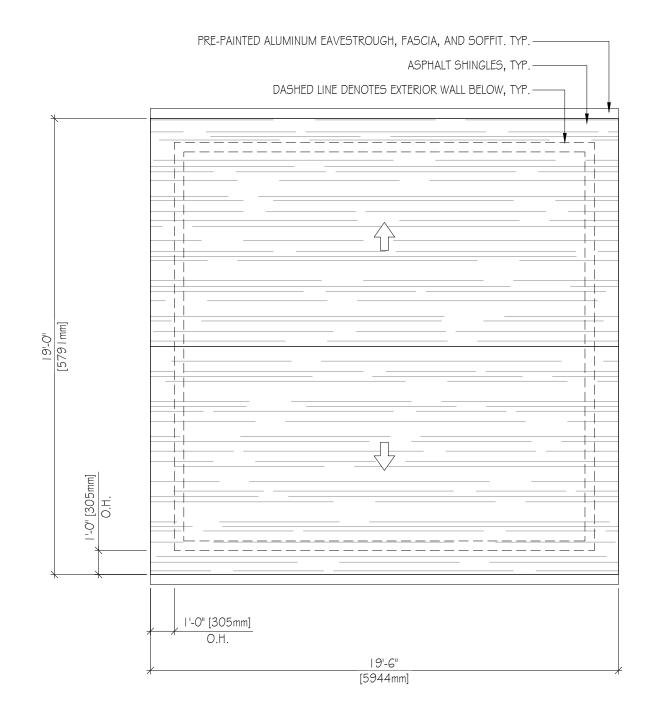
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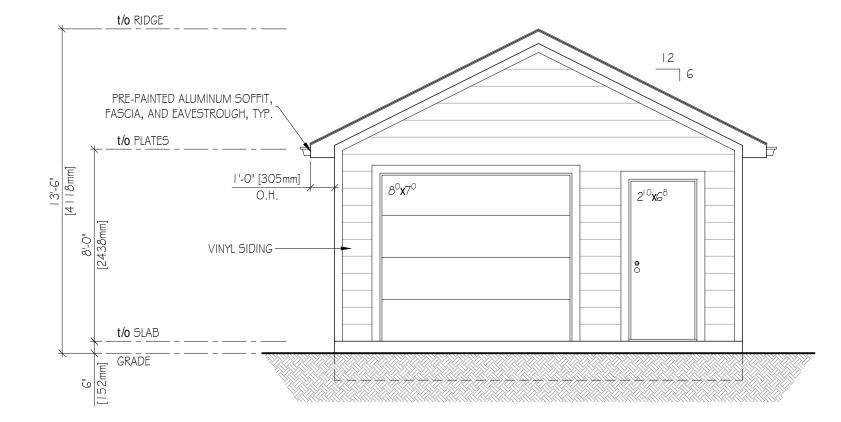
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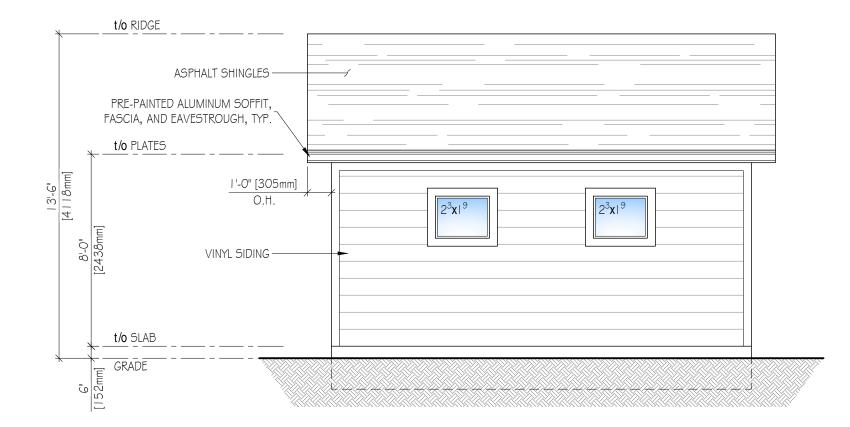


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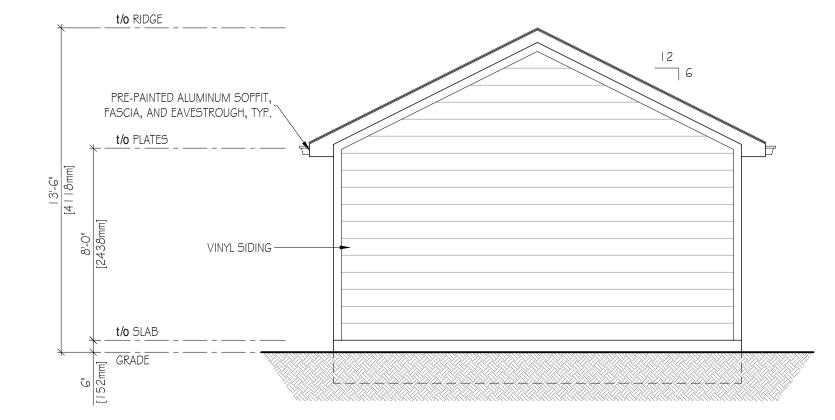
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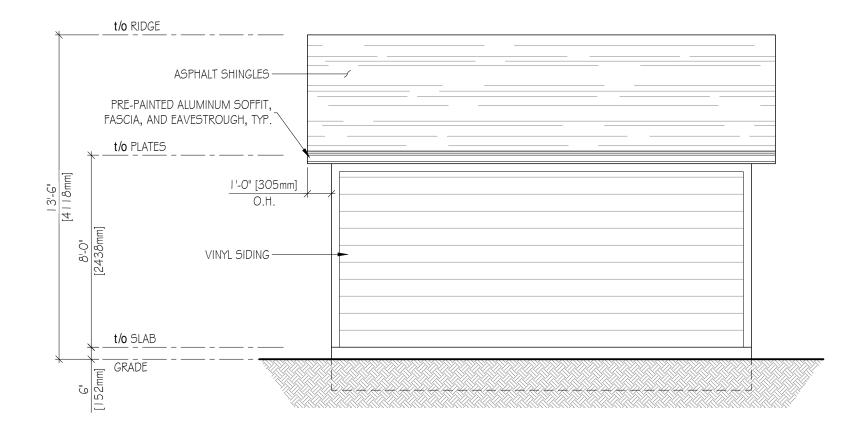
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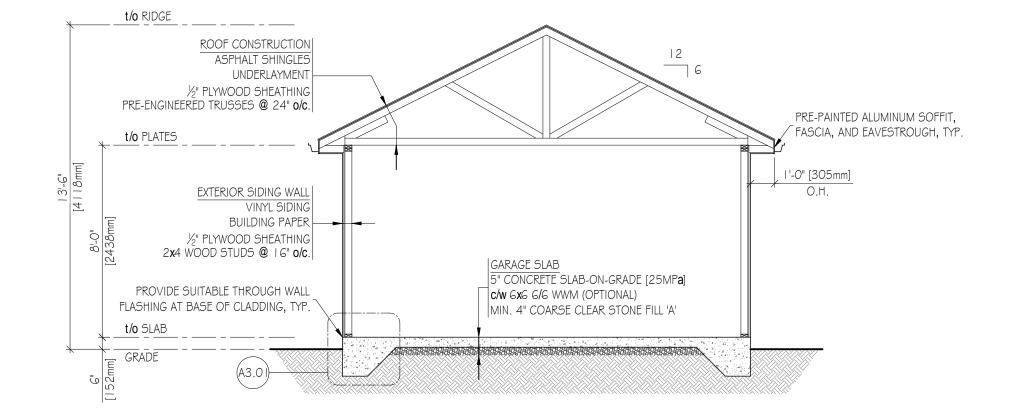


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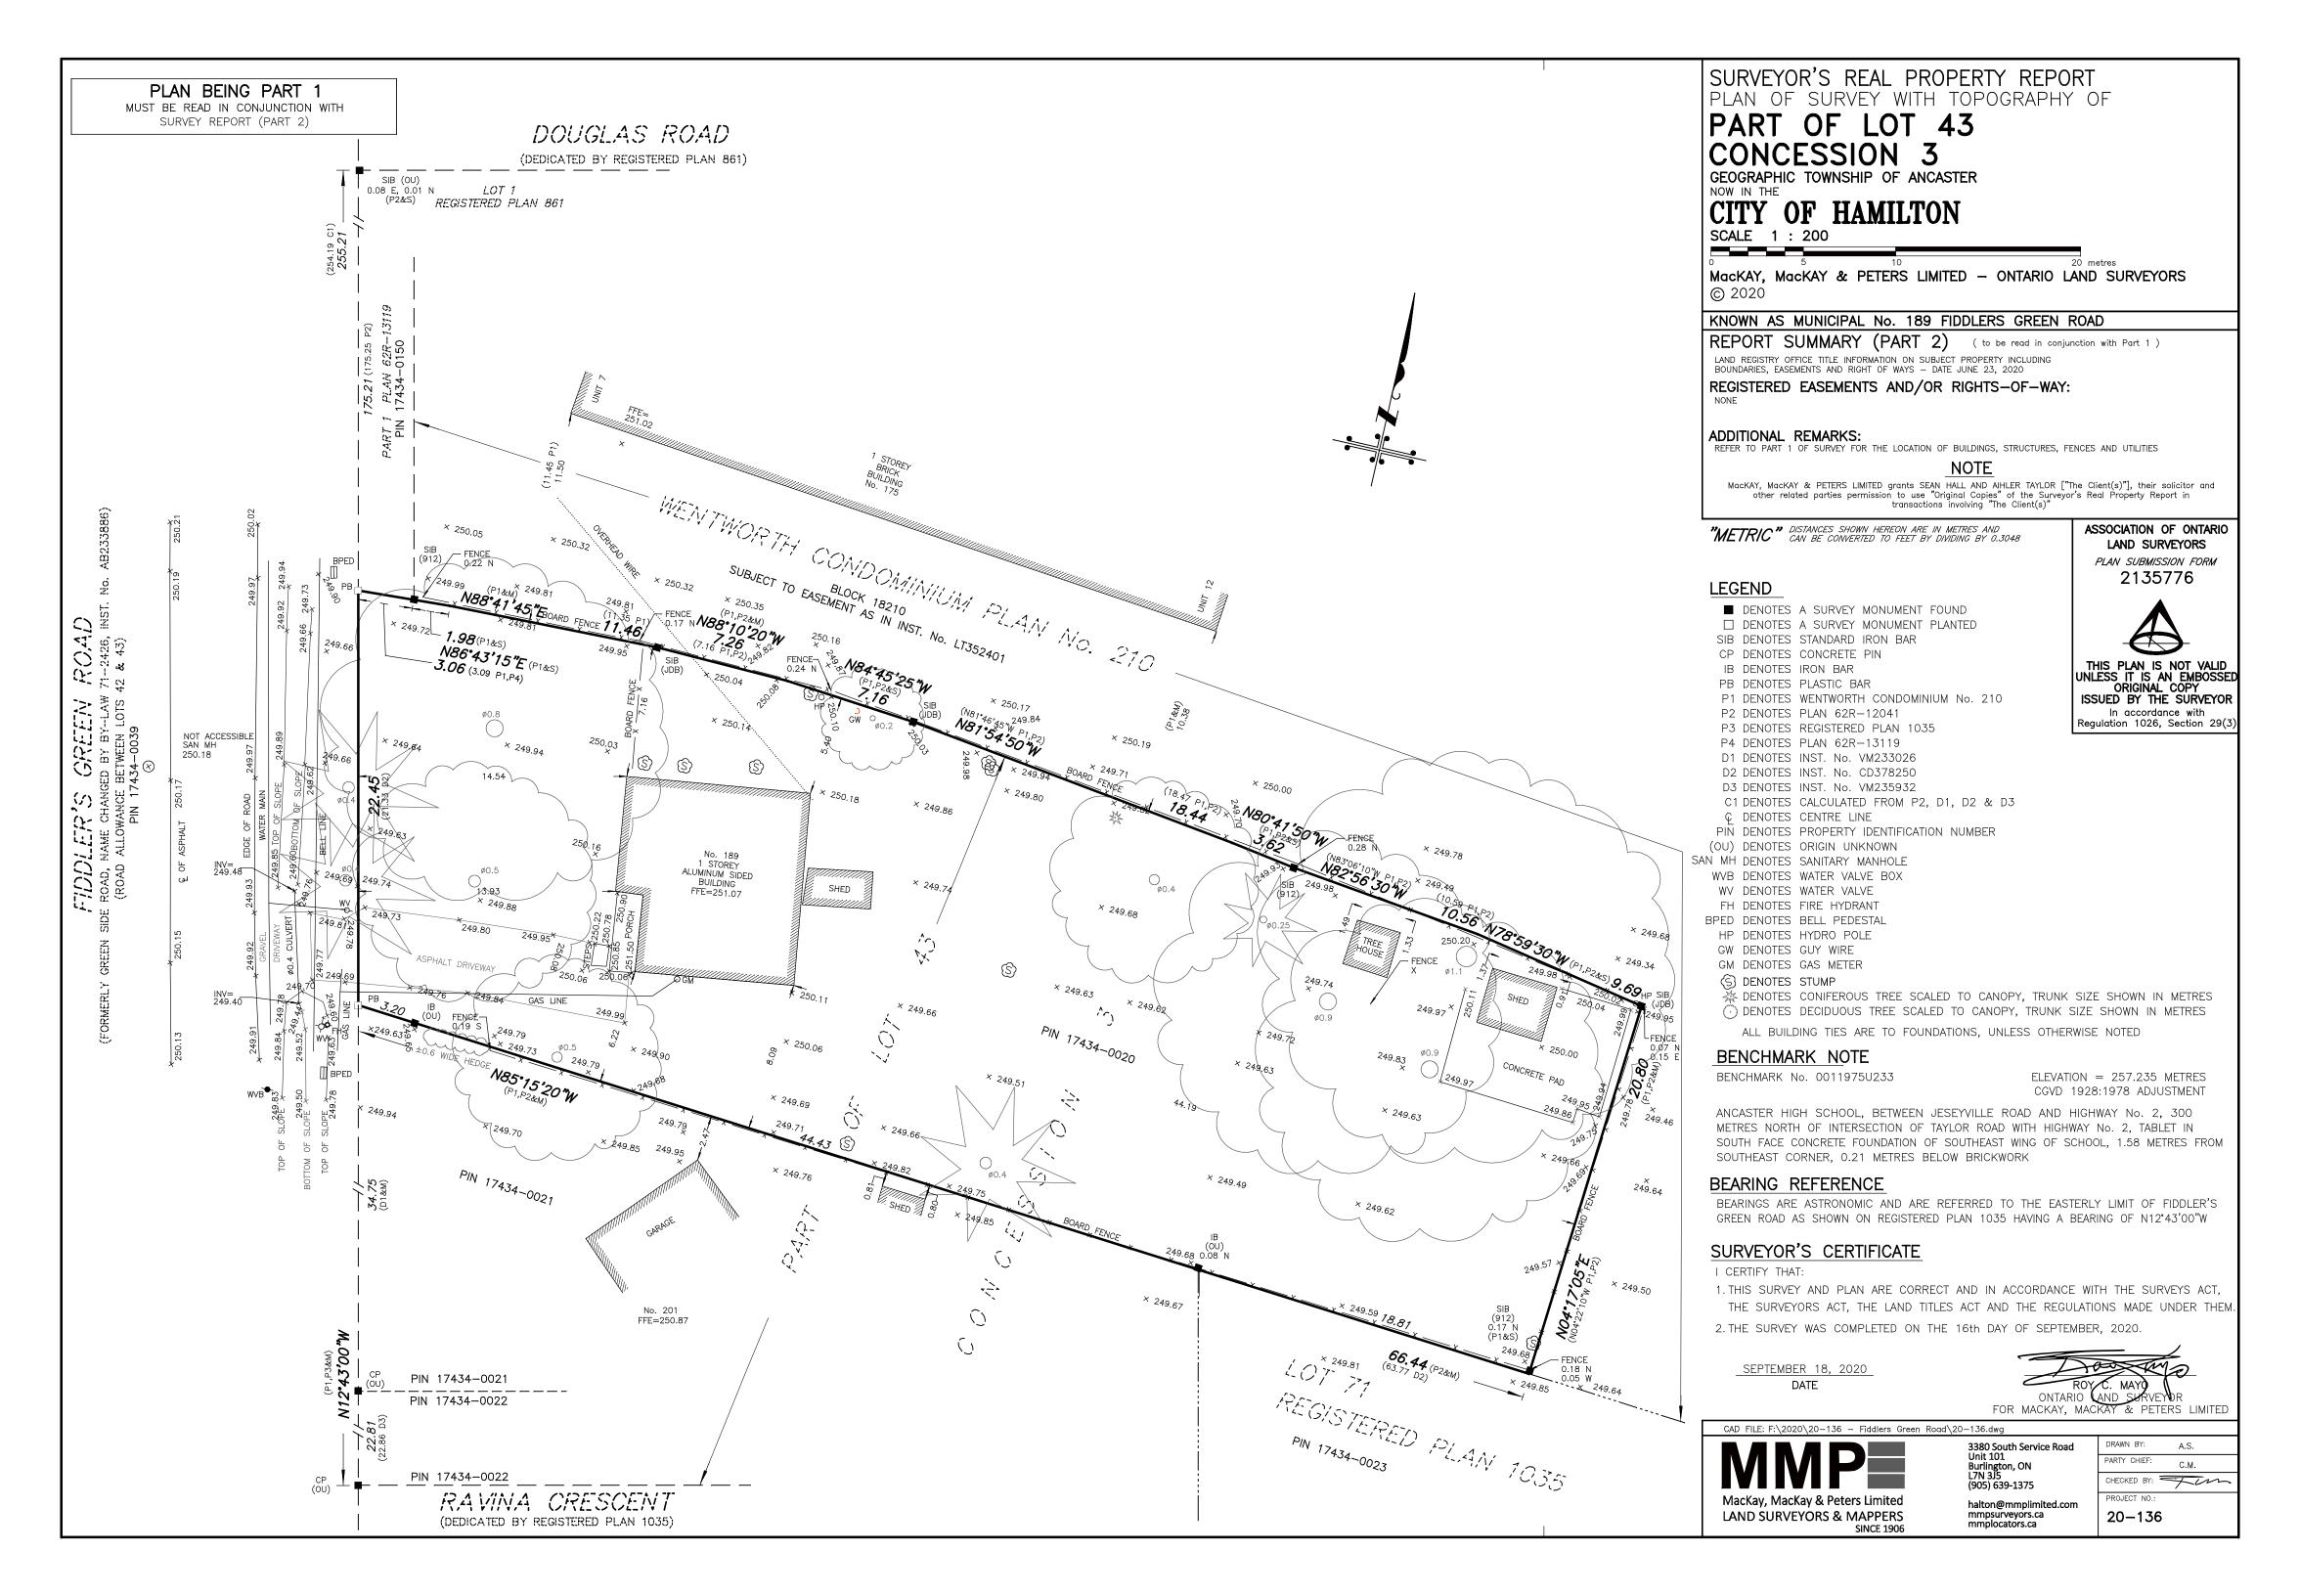
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Committee of Adjustment City Hall, 5<sup>th</sup> Floor, 71 Main St. W., Hamilton, ON L8P4Y5

Phone: (905) 546-2424 ext. 4221 Email: <u>cofa@hamilton.ca</u>

### APPLICATION FOR A MINOR VARIANCE

FOR OFFICE USE ONLY.	
APPLICATION NO.	DATE APPLICATION RECEIVED
PAID	DATE APPLICATION DEEMED COMPLETE
SECRETARY'S SIGNATURE	

The Planning Act

#### Application for Minor Variance or for Permission

The undersigned hereby applies to the Committee of Adjustment for the City of Hamilton under Section 45 of the *Planning Act*, R.S.O. 1990, Chapter P.13 for relief, as described in this application, from the Zoning By-law.

1, 2	NAME	ADDRESS		
Registered Owners(s)	ASHLEE HALL SEAN HALL			
Applicant(s)*	GRAHAM DAY			
Agent or Solicitor			E-mail:	

Note: Unless otherwise requested all communications will be sent to the agent, if any.

3. Names and addresses of any mortgagees, holders of charges or other encumbrances:

TD Canada Trust 830 Upper James St, Hamilton, ON L9C 3A4 Additional sheets can be submitted if there is not sufficient room to answer the following questions. Additional sheets must be clearly labelled

- Nature and extent of relief applied for: PROPOSED ACCESSORY BUILDING REAR YARD SETBACK OF 1.5m
- 5. Why it is not possible to comply with the provisions of the By-law?

BY-LAW STATES 7.5m REAR SETBACK FOR ACC BLDGS. GREATER THAN 12m<sup>2</sup> HOMEOWNER WISHES TO HAVE THE ACC. BLDG. IN THE BACK CORNER TO ALLOW FOR MORE LANDSCAPED REAR YARD. A 7.5m SETBACK WOULD ENCROACH SUBSTANTIALLY INTO THE EXISTING YARD AND WOULD REQUIRE REMOVAL OF EXISTING MATURE TREES THEY WANT TO KEEP.

6. Legal description and Address of subject lands (registered plan number and lot number or other legal description and where applicable, **street and street number**):

189 FIDDLERS GREEN ROAD, ANCASTER EXISTING RESIDENTIAL PART OF LOT 43, CONESSION 3

#### 7. PREVIOUS USE OF PROPERTY

· ·	
	Residential Commercial
	Agricultural Vacant
	Other
8.1	If Industrial or Commercial, specify use
8.2	Has the grading of the subject land been changed by adding earth or other material, i.e. has filling occurred?
	Yes 🚫 No 💽 Unknown 🔘
8.3	Has a gas station been located on the subject land or adjacent lands at any time? Yes No Unknown
8.4	Has there been petroleum or other fuel stored on the subject land or adjacent lands? Yes <u>No</u> No Unknown <u>O</u>
8.5	Are there or have there ever been underground storage tanks or buried waste on the subject land or adjacent lands? Yes O No O Unknown O
8.6	Have the lands or adjacent lands ever been used as an agricultural operation where cyanide products may have been used as pesticides and/or sewage sludge was applied to the lands? Yes O No O Unknown O
8.7	Have the lands or adjacent lands ever been used as a weapon firing range? Yes No Unknown
8.8	Is the nearest boundary line of the application within 500 metres (1,640 feet) of the fill area of an operational/non-operational landfill or dump? Yes O No O Unknown O
8.9	If there are existing or previously existing buildings, are there any building materials remaining on site which are potentially hazardous to public health (eg. asbestos, PCB's)? Yes O No O Unknown O

8.10	Is there any reason	to believe the	subject land	l may have	been contar	ninated by for	rmer
	uses on the site or a	adjacent sites?		~			
	Yes 🚺 No	o <u> </u>	Unknown	$\bigcirc$			

- 8.11 What information did you use to determine the answers to 9.1 to 9.10 above? HOMEOWNERS KNOWLEDGE, GOOGLE MAPS
- 8.12 If previous use of property is industrial or commercial or if YES to any of 9.2 to 9.10, a previous use inventory showing all former uses of the subject land, or if appropriate, the land adjacent to the subject land, is needed.

Is the previous use inventory attached?	Yes
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#### 9. ACKNOWLEDGEMENT CLAUSE

I acknowledge that the City of Hamilton is not responsible for the identification and remediation of contamination on the property which is the subject of this Application – by reason of its approval to this Application.

MARCH 17, 2021	Ashlee Taylor Utility and the taylor as the taylor of tayl
Date	Signature Property Owner
	ASHLEE & SEAN HALL

Print Name of Owner

No

10. Dimensions of lands affected:

Frontage	22.45m
Depth	66.44m
Area	1581.66m <sup>2</sup>
Width of street	10m

11. Particulars of all buildings and structures on or proposed for the subject lands: (Specify ground floor area, gross floor area, number of stories, width, length, height, etc.)

Existing:\_\_\_\_\_\_ DWELL. = 98.88m<sup>2</sup>, (1) STOREY, W = 10.47m, L = 10.02m, H = ±5m SHED 1 = 7.272m<sup>2</sup>, W = 2.03m, L = 3.52m, H = ±2m SHED 2 = 11.099m<sup>2</sup>, W = 3.05m, L = 3.64m, H = ±2m TREEHOUSE = 6.186m<sup>2</sup>, W = 2.55m, L = 2.49m, H = ±4.5m

Proposed

DWELL. - GFA = 255.48m<sup>2</sup>, (1) STOREY, W = 15.23m, L = 21.34m, H = 7.48m ACC BLDG. - GFA = 27.64m<sup>2</sup>, (1) STOREY, W = 5.18m, L = 5.33m, H = 4.12m

12. Location of all buildings and structures on or proposed for the subject lands; (Specify distance from side, rear and front lot lines)

Existing:

DWELL. = FRONT = 13.93m, REAR = 44.19m, SIDE = 5.4m, SIDE = 6.22m SHED 1 = REAR = 41.43m, SIDE = 8.36m, SIDE = 12.41m SHED 2 = REAR = 4.63m, SIDE = 0.91m, SIDE = 17.34m TREEHOUSE = REAR = 13.63m, SIDE = 1.33m, SIDE = 18.13m

#### Proposed:

DWELL. = FRONT 14m, REAR = 32.978m, SIDE = 2.133m, SIDE = 3.81m ACC. BLDG. = REAR = 1.524m, SIDE = 1.524m, SIDE = 14.25m

13.	Date of acquisition of subject lands: July, 2019
14.	Date of construction of all buildings and structures on subject lands: ~1950
15.	Existing uses of the subject property: SINGLE FAMILY RESIDENTIAL
16.	Existing uses of abutting properties: SINGLE FAMILY RESIDENTIAL, RESIDENTIAL MULTIPLE
17.	Length of time the existing uses of the subject property have continued: ~70 YEARS
18.	Municipal services available: (check the appropriate space or spaces)         Water YES       Connected YES         Sanitary Sewer YES       Connected YES         Storm Sewers YES       YES
19.	Present Official Plan/Secondary Plan provisions applying to the land: EXISTING RESIDENTIAL 87-57 ANCASTER, 18-105
20.	Present Restricted Area By-law (Zoning By-law) provisions applying to the land: EXISTING RESIDENTIAL 87-57 ANCASTER, 18-105
21.	Has the owner previously applied for relief in respect of the subject property? Yes  No If the answer is yes, describe briefly.
22.	Is the subject property the subject of a current application for consent under Section 53 of the <i>Planning Act</i> ?
23.	Additional Information

24. The applicant shall attach to each copy of this application a plan showing the dimensions of the subject lands and of all abutting lands and showing the location, size and type of all buildings and structures on the subject and abutting lands, and where required by the Committee of Adjustment such plan shall be signed by an Ontario Land Surveyor.