COMMITTEE OF ADJUSTMENT



City Hall, 5th floor, 71 Main Street West, Hamilton, ON L8P 4Y5 Telephone (905) 546-2424, ext. 4221, 3935 Fax (905) 546-4202

E-mail: cofa@hamilton.ca

NOTICE OF PUBLIC HEARING Minor Variance

You are receiving this notice because you are either:

- Assessed owner of a property located within 60 metres of the subject property
- Applicant/agent on file, or
- Person likely to be interested in this application

APPLICATION NO.: HM/A-21:174

APPLICANTS: Owner Steven Suggitt

Agent Shane Renovations

SUBJECT PROPERTY: Municipal address 20 Wood St. W., Hamilton

ZONING BY-LAW: Zoning By-law 6593, as Amended

ZONING: D district (Urban Protected Residential One and Two Family

Dwellings)

PROPOSAL: To permit the construction of a proposed 1 storey westerly side

addition and a 3rd storey addition to the existing single-family

dwelling notwithstanding that;

- 1. A minimum front yard depth of 3.0 m shall be provided instead of the minimum required 6.0 m front yard depth; and
- 2. A minimum side yard width of 0.6 m shall be provided on the easterly side lot line instead of the minimum required 2.7 m side yard width; and
- 3. A minimum side yard width of 0.5 m shall be provided on the westerly side lot line instead of the minimum required 2.7 m side yard width; and
- 4. No parking spaces shall be provided on site instead of the minimum required 3 parking spaces; and
- 5. The balcony shall be permitted to project a maximum of 1.2 m into the required front yard whereas the By-Law states that a balcony may project into a required front yard not more than 1.0 m, provided that no such projection shall be closer to a street line than 1.5 m; and
- 6. Eaves and gutters shall be permitted to encroach the entire width of the easterly and westerly side lot lines instead of the maximum permitted encroachment of one half of the required side yard or 1.0 m whichever is the lesser; and

Notes:

Please note that variance # 4 for parking has been written based on 10 habitable rooms.

This application will be heard by the Committee as shown below:

HM/A-21: 174

Page 2

DATE: Thursday, June 17th, 2021

TIME: 2:25 p.m.

PLACE: Via video link or call in (see attached sheet for details)

To be streamed at

www.hamilton.ca/committeeofadjustment

for viewing purposes only

PUBLIC INPUT

Written: If you would like to submit written comments to the Committee of Adjustment you may do so via email or hardcopy. Please see attached page for complete instructions, including deadlines for submitting to be seen by the Committee.

Orally: If you would like to speak to this item at the hearing you may do so via video link or by calling in. Please see attached page for complete instructions, including deadlines for registering to participate.

MORE INFORMATION


For more information on this matter, including access to drawings illustrating this request:

- Visit <u>www.hamilton.ca/committeeofadjustment</u>
- Call 905-546-CITY (2489) or 905-546-2424 extension 4221, 4130, or 3935
- Email Committee of Adjustment staff at cofa@hamilton.ca

DATED: June 1st, 2021.

Jamila Sheffield, Secretary-Treasurer Committee of Adjustment


Information respecting this application is being collected under the authority of the Planning Act, R.S.O., 1990, c. P. 13. All comments and opinions submitted to the City of Hamilton on this matter, including the name, address, and contact information of persons submitting comments and/or opinions, will become part of the public record and will be made available to the Applicant and the general public.

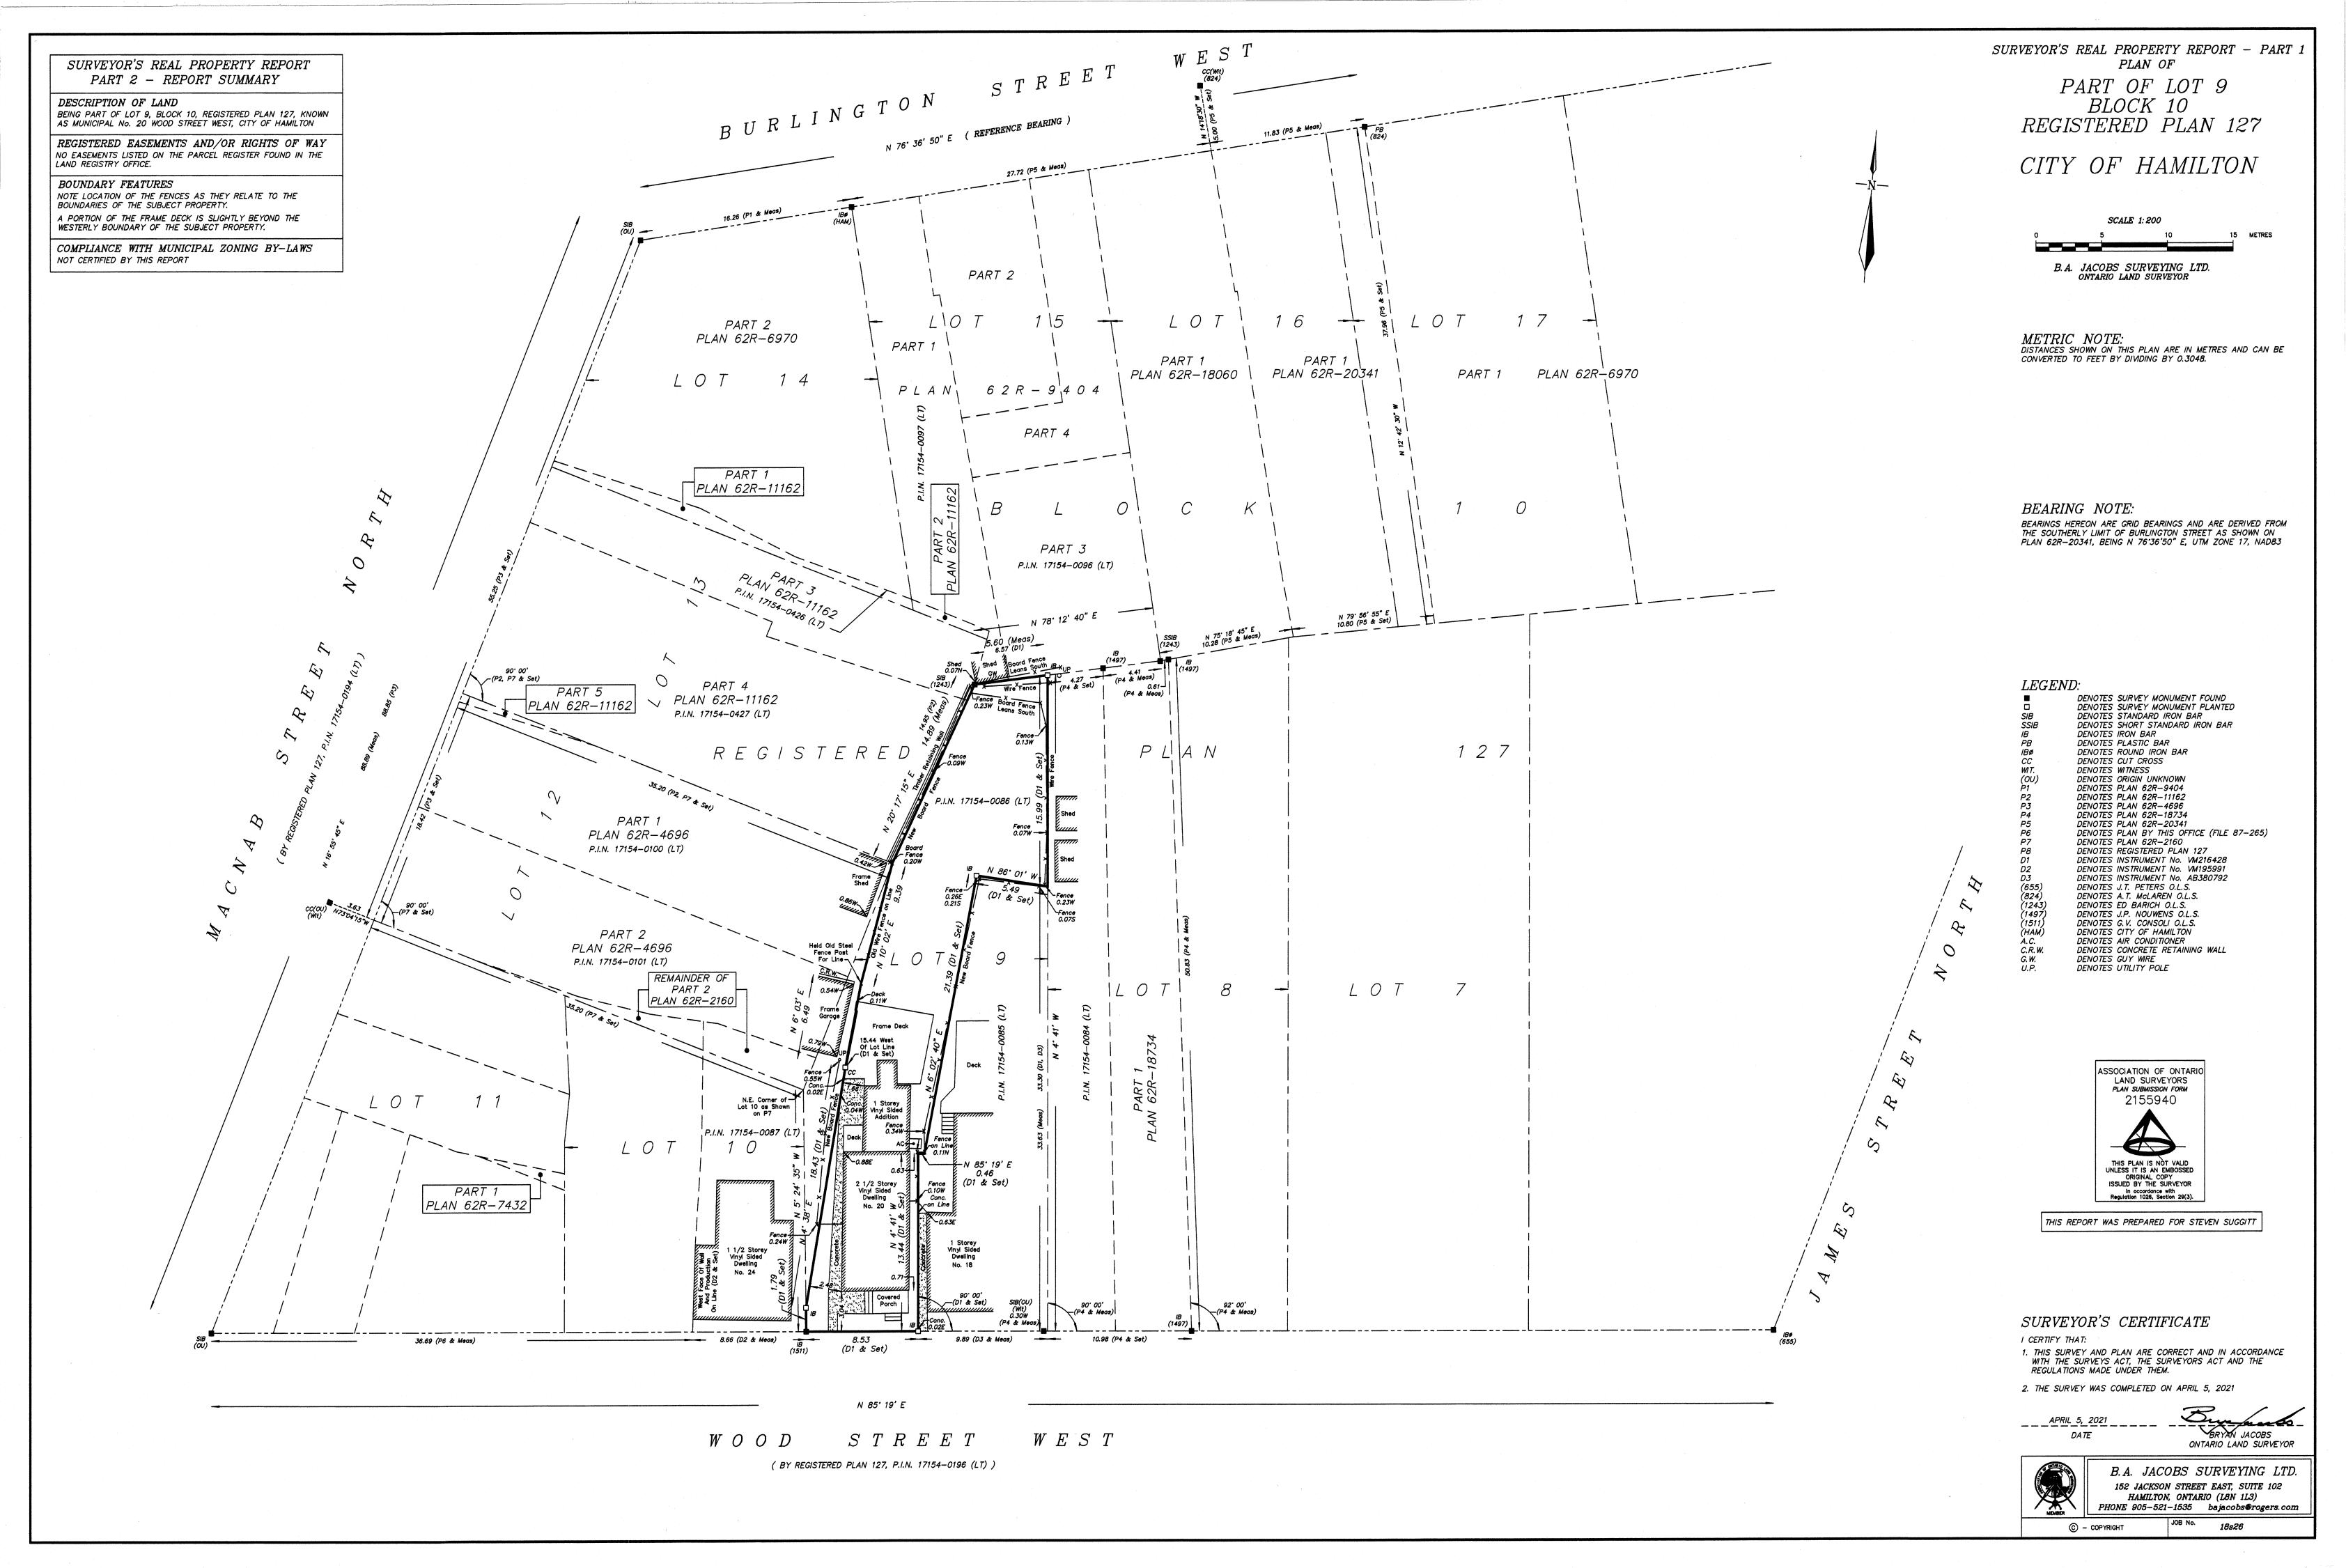

RENOVATION TO:

BURNEY-SUGGITT

20 WOOD ST W HAMILTON ON L8L 1E9

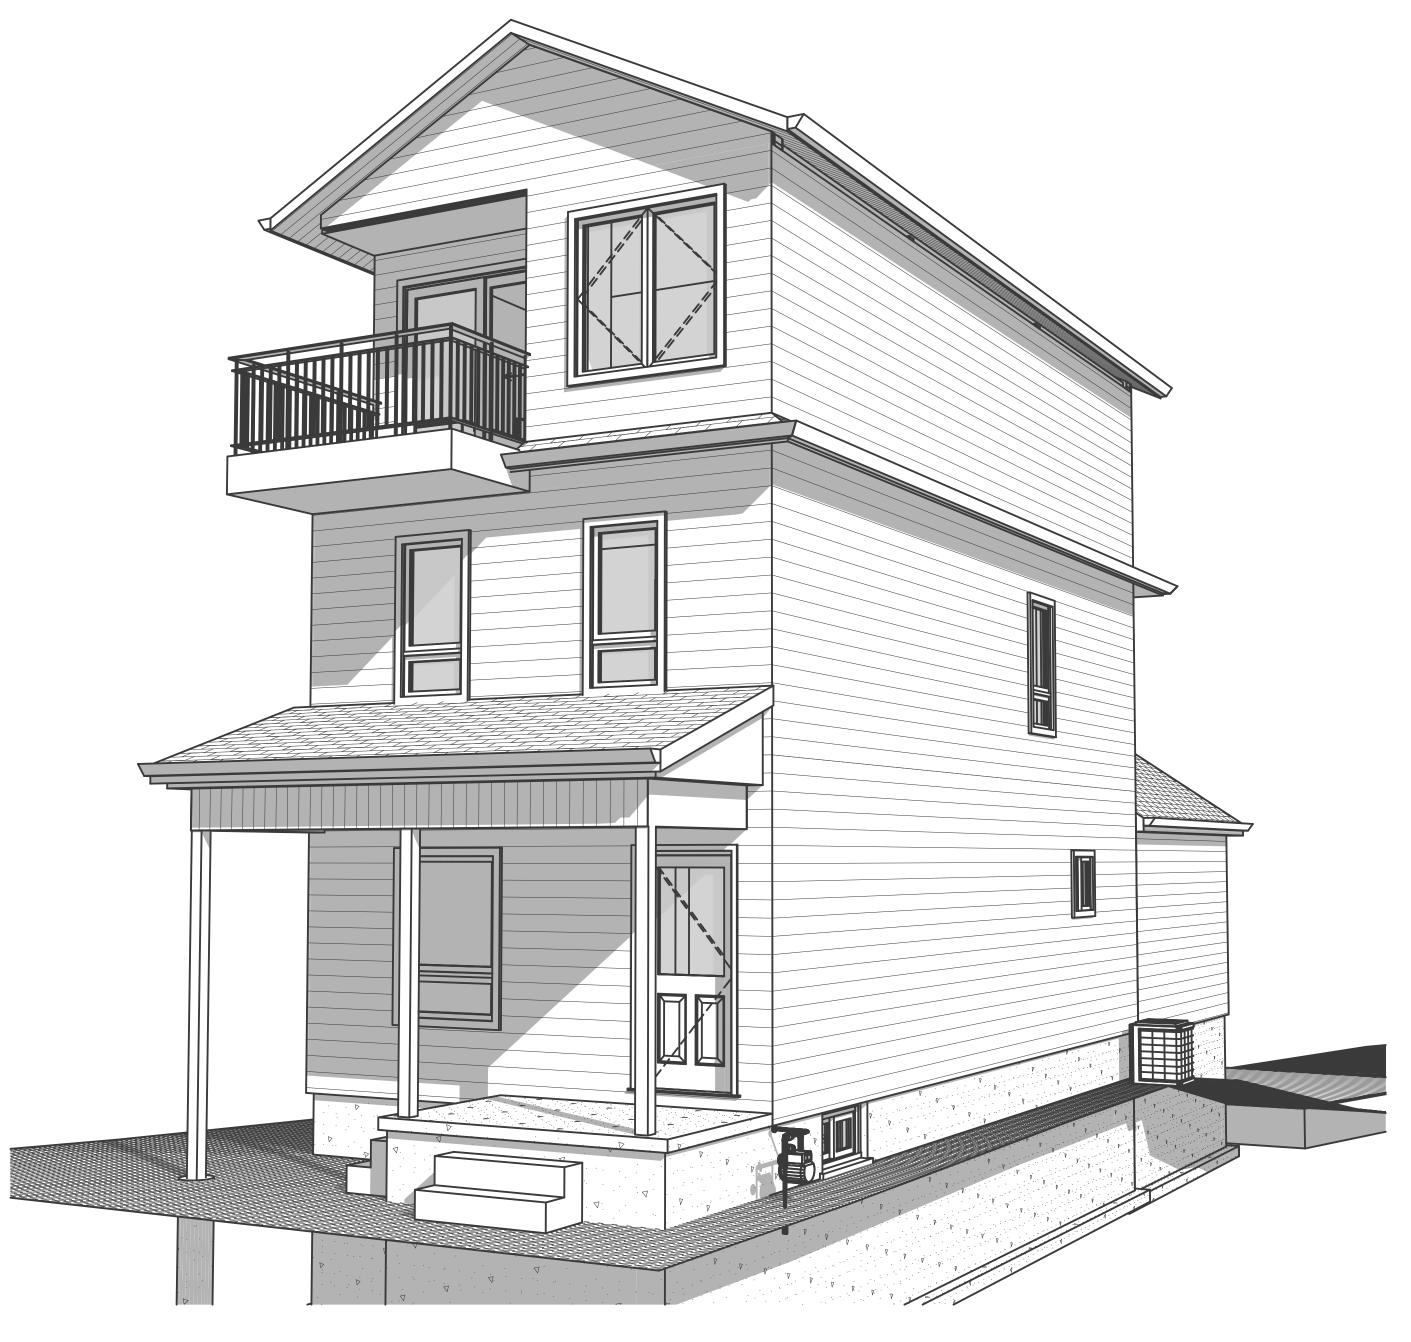

3D PERSPECTIVE
SCALE: 3/16" = 1'-0"



CONSTRUCTION

NO.	REVISION	DATE
1	ISSUED FOR DESIGN 1 REVIEW	2021.03.29
2	ISSUED FOR DESIGN 2 REVIEW	2021.04.08
3		
4		
5		

TITLE SHEET / GENERAL INFO

DRAWING:

PROJECT NAME: **BURNEY-SUGGITT**


PROJECT ADDRESS:
20 WOOD ST W HAMILTON ON L8L 1E9

DATE: 2021-04-16	
SCALE:	

SCALE: DRAWING NO:

AS NOTED

PROJECT NO: DRAWING NO:

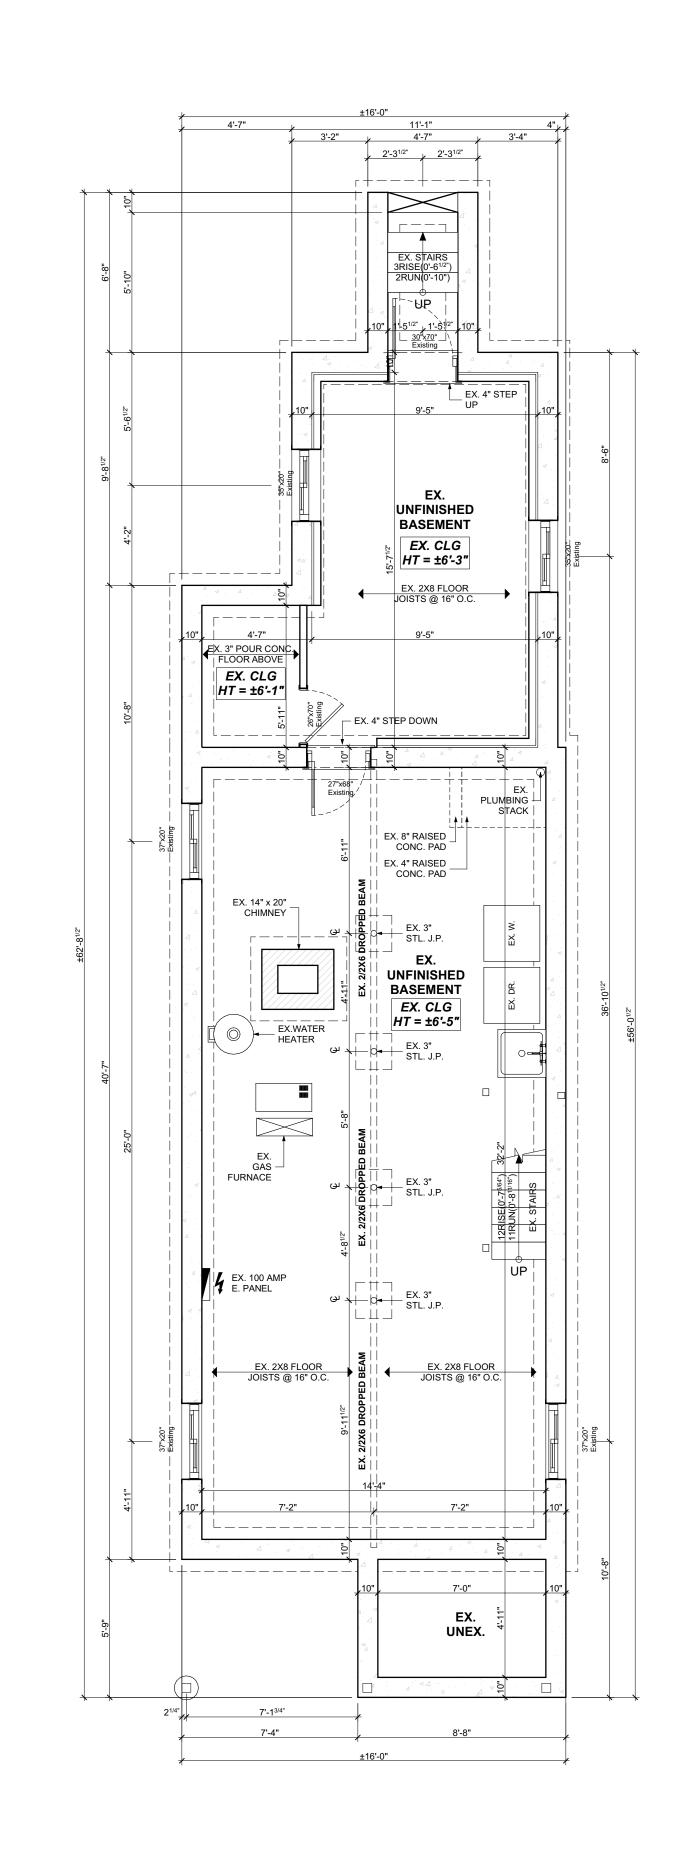



CONSTRUCTION

NO.	REVISION	DATE
1	ISSUED FOR DESIGN 1 REVIEW	2021.03.29
2	ISSUED FOR DESIGN 2 REVIEW	2021.04.08
3		
4		
5		

EXISTING BASEMENT PLAN

DRAWING:

PROJECT NAME: **BURNEY-SUGGITT**

PROJECT ADDRESS:
20 WOOD ST W HAMILTON ON L8L 1E9

DATE: 2021-04-16


SCALE: DRAWING NO:

AS NOTED

PROJECT NO: A1.01

1 EXISTING BASEMENT PLAN

SCALE: 1/4" = 1'-0"

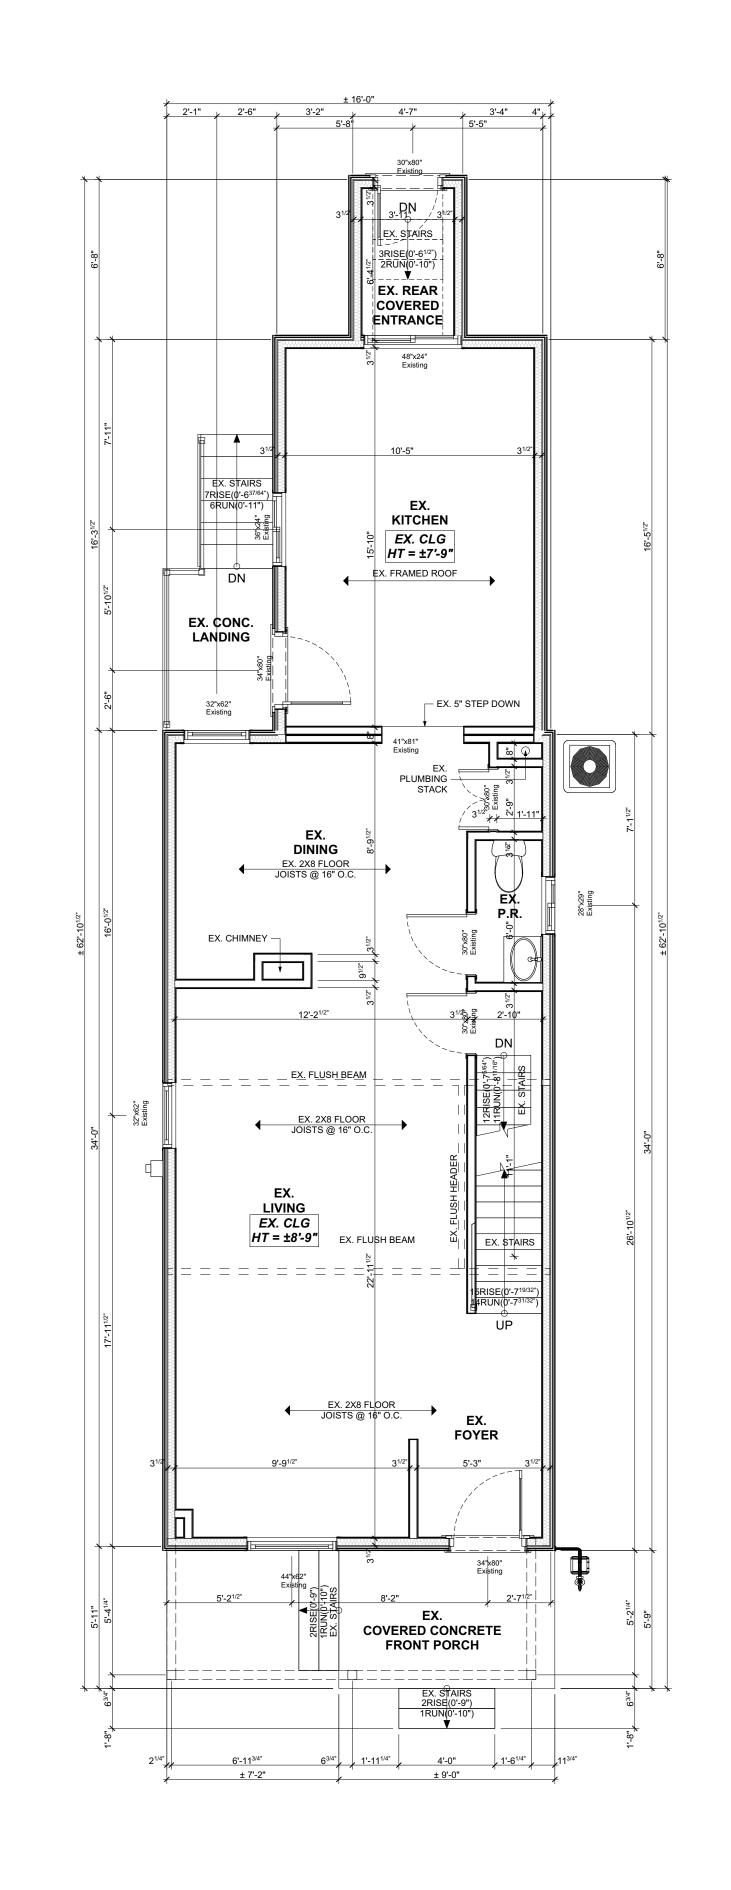



CONSTRUCTION

NO.	REVISION	DATE
1	ISSUED FOR DESIGN 1 REVIEW	2021.03.29
2	ISSUED FOR DESIGN 2 REVIEW	2021.04.08
3		
4		
5		

EXISTING MAIN FLOOR PLAN

DRAWING:

PROJECT NAME: BURNEY-SUGGITT


PROJECT ADDRESS:
20 WOOD ST W HAMILTON ON L8L 1E9

DATE: 2021-04-16

SCALE: DRAWING NO:

AS NOTED

PROJECT NO: A1.02

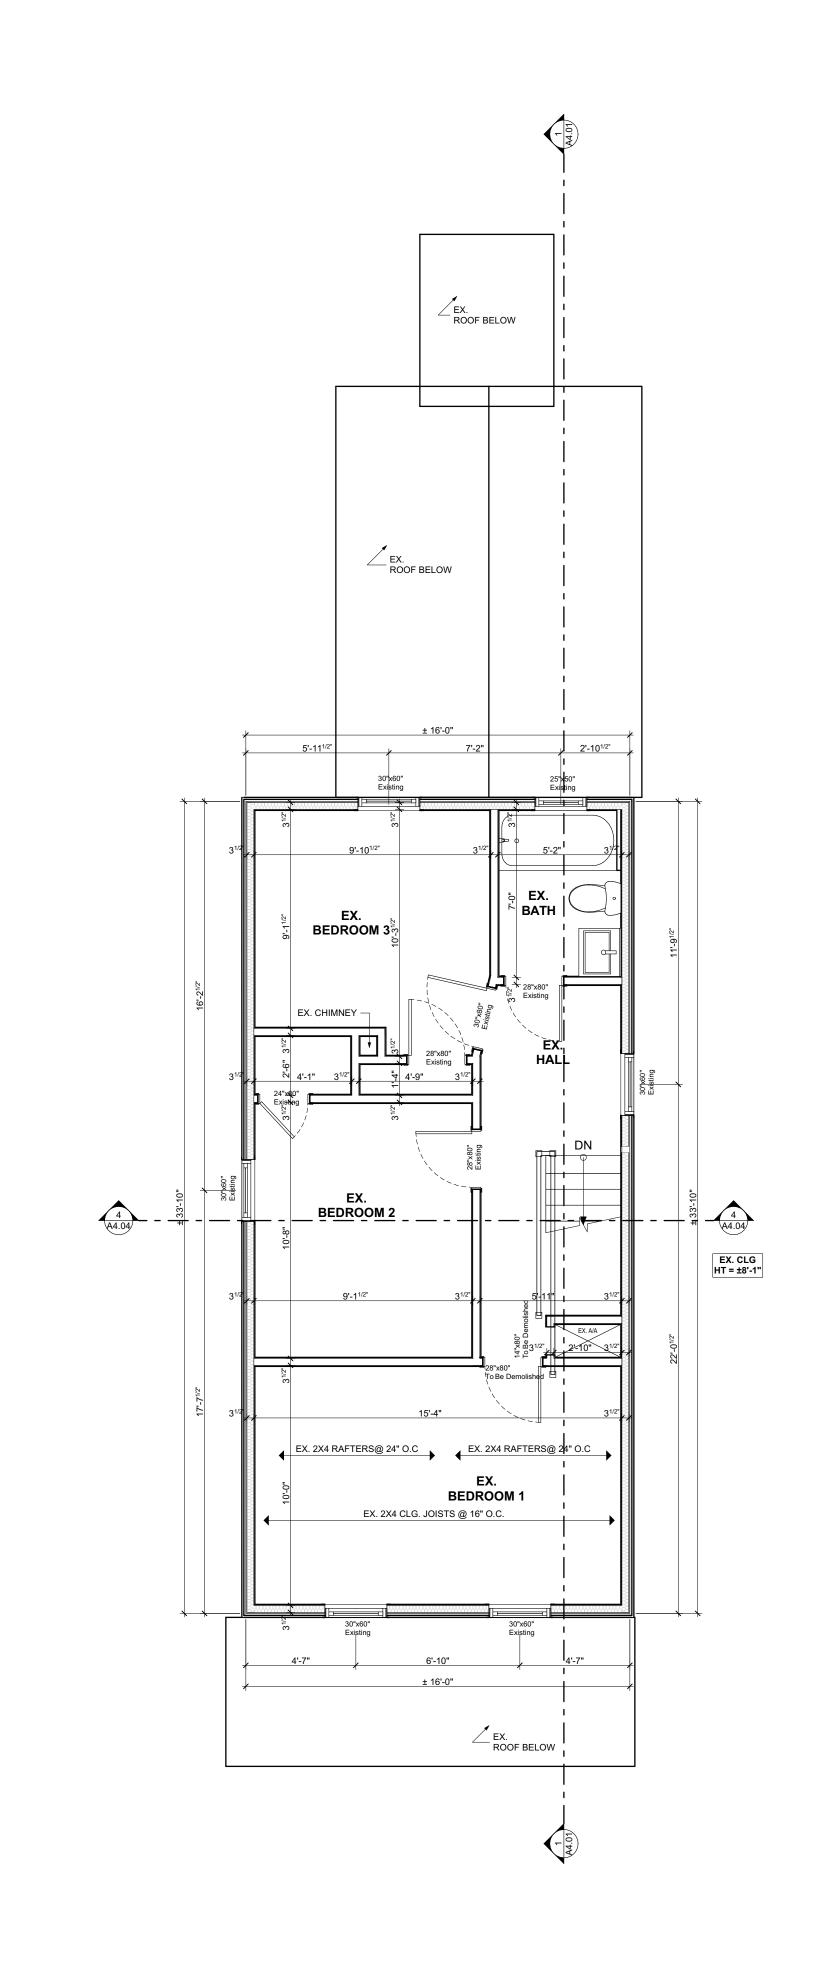



NOT FOR CONSTRUCTION

NO.	REVISION	DATE
1	ISSUED FOR DESIGN 1 REVIEW	2021.03.29
2	ISSUED FOR DESIGN 2 REVIEW	2021.04.08
3		
4		
5		

EXISTING SECOND FLOOR PLAN

DRAWING:

PROJECT NAME:

BURNEY-SUGGITT

PROJECT ADDRESS:
20 WOOD ST W HAMILTON ON L8L 1E9

DATE: 2021-04-16

scale: DRAWING NO:

AS NOTED

PROJECT NO:

AS NOTED

ALL CONSTRUCTION TO COMPLY WITH ONTARIO BUILDING CODE

DESIGN AND LAYOUT OF ALL PRE ENGINEERED STRUCTURAL MEMBERS FROM ROOF TRUSS SUPPLIER TO BE SUPPLIED BY MANUFACTURER PRIOR TO CONSTRUCTION

SOLID BLOCKING TO BEARING BELOW TO BE PROVIDED AT ALL GIRDER TRUSS AND BEAM LOCATIONS (MIN. WIDTH EQUAL TO WIDTH OF BEARING POINT OVER) VERIFY WITH TRUSS

TRUSS MEMBERS SHALL NEVER BE NOTCHED, DRILLED OR CUT UNLESS NOTCHING OR DRILLING HAS BEEN ACCOUNTED FORIN THE DESIGN OF THE TRUSS

WHEN RENOVATING. INSULATION TO BE EQUAL TO OR GREATER THAN EXISTING

BEAM BEARING = MIN. 3-1/2" LINTEL BEARING = MIN. 1-1/2" RAFTER BEARING = MIN. 1-1/2" JOISTS BEARING = MIN. 1-1/2"

CONTRACTOR TO CHECK AND VERIFY ALL SPECIFICATIONS AND DIMENSIONS PRIOR TO AND DURING CONSTRUCTION. ALL
DISCREPENCIES TO BE REPORTED TO DESIGNER (519) 339-1493

PROVIDE TEMPORARY BRACING/SHORING FOR ALL EXISTING FLOOR JOISTS & WALLS DURING CONSTRUCTION & INSTALLATION OF NEW BEAMS & FLOOR JOISTS AS REQ. (TYP.)

NOTE ABOUT MATCHING INSULATION IN OLDER HOMES

THE ENERGY EFFICIENCY OF EXISTING BUILDINGS SHALL COMPLY WITH PART 11 OF DIVISION B OF THE BUILDING CODE FOR RENOVATION. SB-12, 1.1.1.1. ENERGY EFFICIENCY

CONSTRUCTION MAY BE CARRIED OUT TO MAINTAIN THE EXISTING PERFORMANCE LEVEL OF ALL OR PART OF AN EXISTING BUILDING, BY THE REUSE, RELOCATION OR EXTENSION OF THE SAME OR SIMILAR MATERIALS OR COMPONENTS, TO RETAIN THE EXISTING CHARACTER, STRUCTURAL UNIQUENESS, HERITAGE VALUE, OR AESTHETIC APPEARANCE OF ALL OR PART OF THE BUILDING, IF THE CONSTRUCTION WILL NOT ADVERSELY AFFECT THE EARLY WARNING AND EVACUATION SYSTEMS, FIRE SEPARATIONS OR THE STRUCTURAL ADEQUACY OR WILL NOT CREATE AN UNHEALTHY ENVIRONMENT IN THE BUILDING. 11.3.3.1. BASIC RENOVATION (SEE APPENDIX A)

WHERE THE FRAMING SYSTEMS ARE BEING ALTERED TO MATCH EXISTING FRAMING, LESSER AMOUNTS AND EXTENT OF INSULATION AND VAPOR BARRIER IS ACCEPTABLE. PART 11 COMPLIANCE ALTERNATIVE, TABLE 11.5.1.1.C. (CONT'D), C199 - 12.2.1.1. (3)

SMOKE ALARMS

(1) Within dwelling units sufficient smoke alarms conforming to CAN/ULS-531 shall be installed so that (a) There is at least one smoke alarm on each storey, including basements, and

(b) On any storey of a dwelling unit containing sleeping rooms, a smoke (ii) in a location between the sleeping rooms and remainder of the storey, and if the sleeping rooms are served by a hallway, the smoke alarm shall


be located in the hallway (2) Smoke alarms shall have a visual signalling component conforming to the requirements in 18.5.3. of NFPA 72. The visual signalling component need not be integrated with the smoke alarm provided it is interconnected

Interconnect smoke alarms to be permantly connected and have a battery backup as per OBC 9.10.19.4

TABLE 3.1.1.21. (IP) Thermal Performance Requirements for Additions to Existing Buildings

CEILING WITH ATTIC SPACE CEILING WITHOUT ATTIC SPACE EXPOSED FLOOR WALLS ABOVE GRADE BASEMENT WALLS R19 + R5 c.i. R20 c.i. or R12 + R10 c.i. BELOW GRADE SLAB EDGE OF BELOW GRADE SLAB HEATED SLAB

WINDOWS AND SLIDING GLASS DOORS ENERGY RATING 0.28U 25 ELECTRICAL FACILITIES SHALL BE PROVIDED AS PER ONTARIO BUILDING CODE 2012 AS PER 9.34

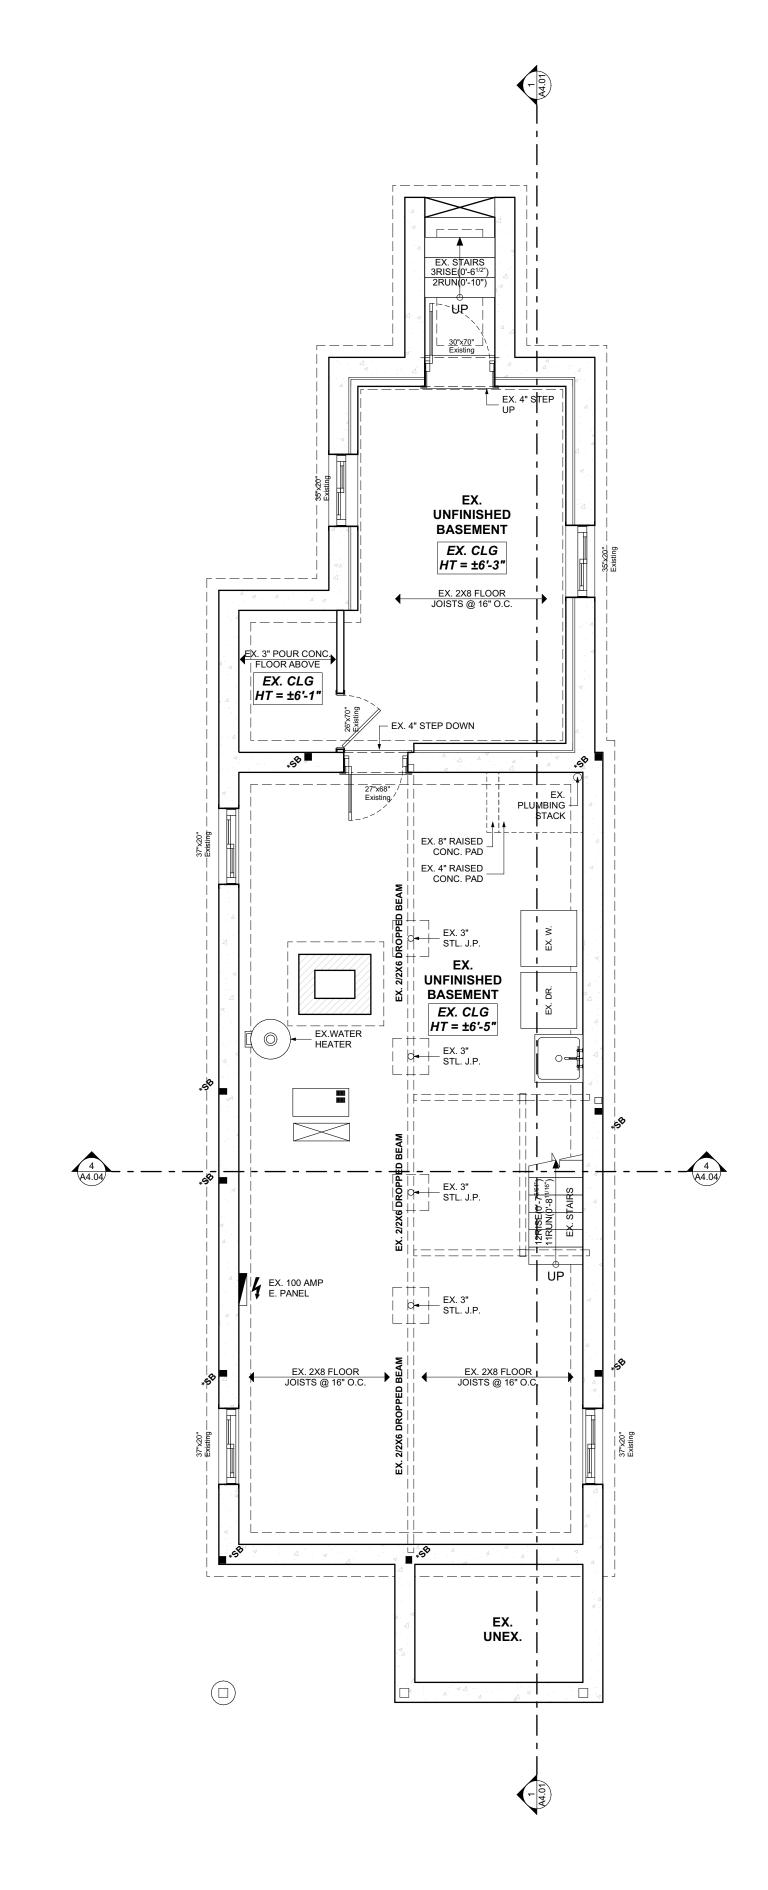



1 ISSUED FOR DESIGN 1 REVIEW 2021.03.29 2 ISSUED FOR DESIGN 2 REVIEW 2021.04.08

PROPOSED BASEMENT **PLAN**

DRAWING:

PROJECT NAME: **BURNEY-SUGGITT**

PROJECT ADDRESS: 20 WOOD ST W HAMILTON ON L8L 1E9

DATE: 2021-04-16

SCALE: DRAWING NO: AS NOTED PROJECT NO:

ALL CONSTRUCTION TO COMPLY WITH ONTARIO BUILDING CODE

GENERAL NOTES:

DESIGN AND LAYOUT OF ALL PRE ENGINEERED STRUCTURAL MEMBERS FROM ROOF TRUSS SUPPLIER TO BE SUPPLIED BY MANUFACTURER PRIOR TO CONSTRUCTION

SOLID BLOCKING TO BEARING BELOW TO BE PROVIDED AT ALL GIRDER TRUSS AND BEAM LOCATIONS (MIN. WIDTH EQUAL TO WIDTH OF BEARING POINT OVER) VERIFY WITH TRUSS

TRUSS MEMBERS SHALL NEVER BE NOTCHED, DRILLED OR CUT UNLESS NOTCHING OR DRILLING HAS BEEN ACCOUNTED FORIN THE DESIGN OF THE TRUSS

WHEN RENOVATING. INSULATION TO BE EQUAL TO OR GREATER THAN EXISTING

BEAM BEARING = MIN. 3-1/2" LINTEL BEARING = MIN. 1-1/2" RAFTER BEARING = MIN. 1-1/2" JOISTS BEARING = MIN. 1-1/2"

CONTRACTOR TO CHECK AND VERIFY ALL SPECIFICATIONS AND DIMENSIONS PRIOR TO AND DURING CONSTRUCTION. ALL DISCREPENCIES TO BE REPORTED TO DESIGNER (519) 339-1493

DISCREPENCIES TO BE REPORTED TO DESIGNER (519)
PROVIDE TEMPORARY BRACING/SHORING FOR

ALL EXISTING FLOOR JOISTS & WALLS DURING CONSTRUCTION & INSTALLATION OF NEW BEAMS & FLOOR JOISTS AS REQ. (TYP.)

NOTE ABOUT MATCHING INSULATION IN OLDER HOMES

THE ENERGY EFFICIENCY OF EXISTING BUILDINGS SHALL

COMPLY WITH PART 11 OF DIVISION B OF THE BUILDING CODE FOR RENOVATION. SB-12, 1.1.1.1. ENERGY EFFICIENCY

CONSTRUCTION MAY BE CARRIED OUT TO MAINTAIN THE EXISTING PERFORMANCE LEVEL OF ALL OR PART OF AN EXISTING BUILDING, BY THE REUSE, RELOCATION OR EXTENSION OF THE SAME OR SIMILAR MATERIALS OR COMPONENTS, TO RETAIN THE EXISTING CHARACTER, STRUCTURAL UNIQUENESS, HERITAGE VALUE, OR AESTHETIC APPEARANCE OF ALL OR PART OF THE BUILDING, IF THE CONSTRUCTION WILL NOT ADVERSELY AFFECT THE EARLY WARNING AND EVACUATION SYSTEMS, FIRE SEPARATIONS OR THE STRUCTURAL ADEQUACY OR WILL NOT CREATE AN UNHEALTHY ENVIRONMENT IN THE BUILDING. 11.3.3.1. BASIC RENOVATION (SEE APPENDIX A)

WHERE THE FRAMING SYSTEMS ARE BEING ALTERED TO MATCH EXISTING FRAMING, LESSER AMOUNTS AND EXTENT OF INSULATION AND VAPOR BARRIER IS ACCEPTABLE. PART 11 COMPLIANCE ALTERNATIVE, TABLE 11.5.1.1.C. (CONT'D), C199 - 12.2.1.1. (3)

SMOKE ALARMS

(1) Within dwelling units sufficient smoke alarms conforming to CAN/ULS-531 shall be installed so that
 (a) There is at least one smoke alarm on each storey, including basements, and

(b) On any storey of a dwelling unit containing sleeping rooms, a smoke alarm is installed,
(i) in each sleeping room, and
(ii) in a location between the sleeping rooms and remainder of the storey, and if the sleeping rooms are served by a hallway, the smoke alarm shall be located in the hallway

(2) Smoke alarms shall have a visual signalling component conforming to the requirements in 18.5.3. of NFPA 72. The visual signalling component need not be integrated with the smoke alarm provided it is interconnected

Interconnect smoke alarms to be permantly connected and have a battery backup as per OBC 9.10.19.4


TABLE 3.1.1.21. (IP) Thermal Performance Requirements for Additions to Existing Buildings

WINDOWS AND SLIDING GLASS DOORS ENERGY RATING

CEILING WITH ATTIC SPACE R60
CEILING WITHOUT ATTIC SPACE R31
EXPOSED FLOOR R31
WALLS ABOVE GRADE R19 + R5 c.i.
BASEMENT WALLS R20 c.i. or R12 + R10 c.i.
BELOW GRADE SLAB R5
EDGE OF BELOW GRADE SLAB R10
HEATED SLAB R10

ELECTRICAL FACILITIES SHALL BE PROVIDED AS PER ONTARIO BUILDING CODE 2012 AS PER 9.34

0.28U 25

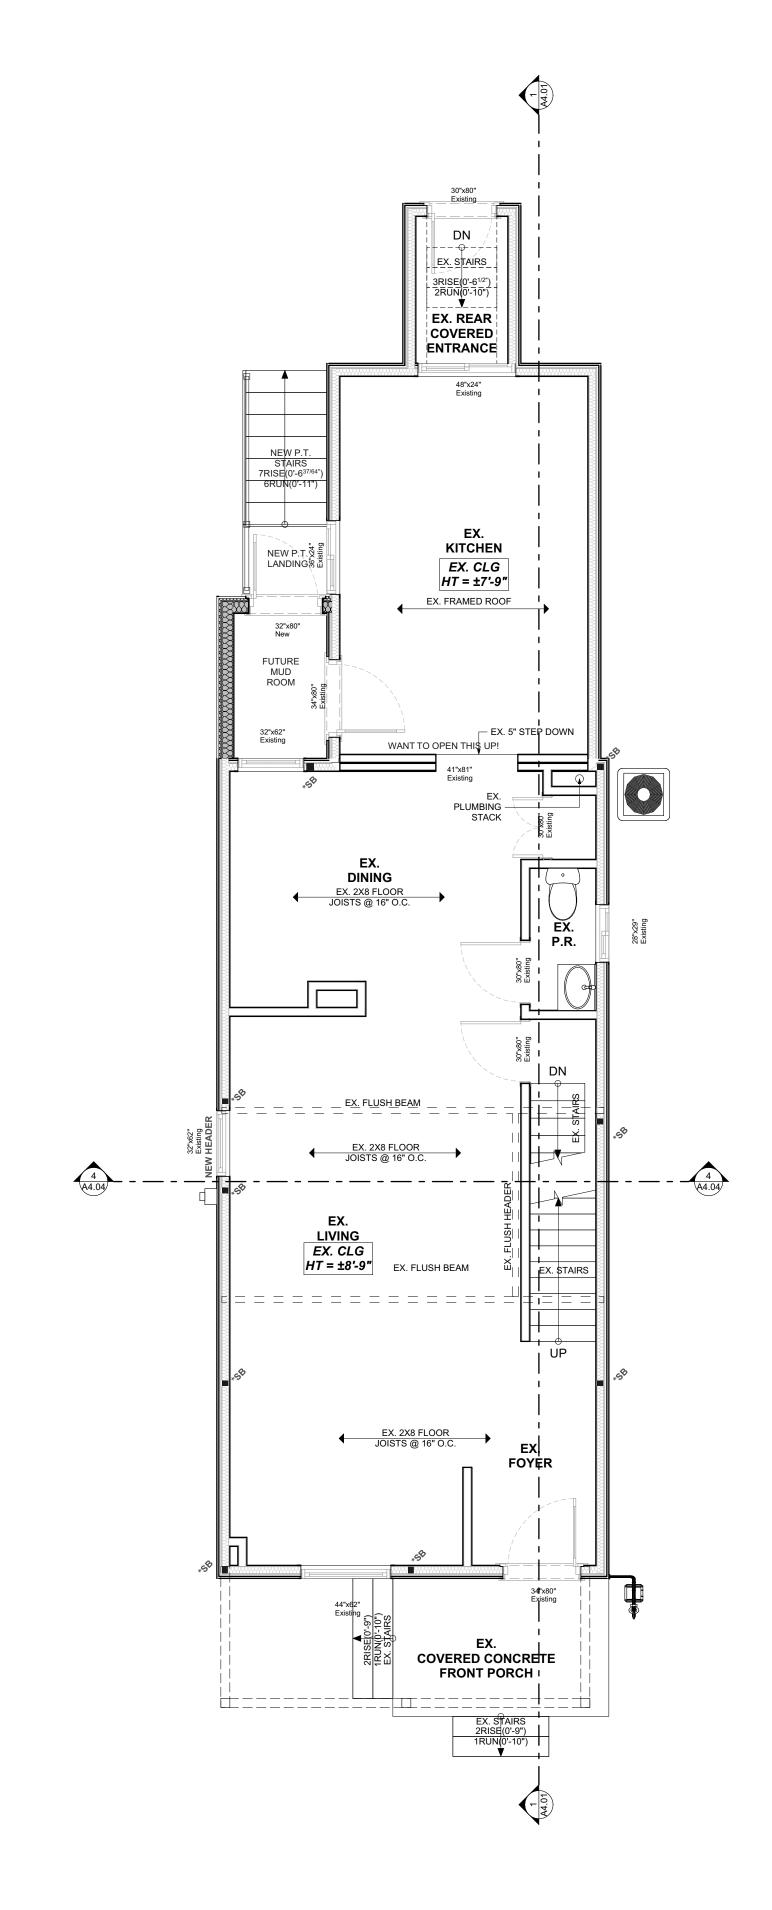



CONSTRUCTION

NO.	REVISION	DATE
1	ISSUED FOR DESIGN 1 REVIEW	2021.03.29
2	ISSUED FOR DESIGN 2 REVIEW	2021.04.08
3		
4		
5		

PROPOSED MAIN FLOOR PLAN

DRAWING:

PROJECT NAME:

BURNEY-SUGGITT

PROJECT ADDRESS:
20 WOOD ST W HAMILTON ON L8L 1E9

DATE: 2021-04-16

SCALE: DRAWING NO:

AS NOTED

PROJECT NO:

AS NOTED

ALL CONSTRUCTION TO COMPLY WITH ONTARIO BUILDING CODE DESIGN AND LAYOUT OF ALL PRE ENGINEERED STRUCTURAL MEMBERS FROM ROOF TRUSS SUPPLIER TO BE SUPPLIED BY MANUFACTURER PRIOR TO CONSTRUCTION

SOLID BLOCKING TO BEARING BELOW TO BE PROVIDED AT ALL GIRDER TRUSS AND BEAM LOCATIONS (MIN. WIDTH EQUAL TO WIDTH OF BEARING POINT OVER) VERIFY WITH TRUSS DRAWINGS

TRUSS MEMBERS SHALL NEVER BE NOTCHED, DRILLED OR CUT UNLESS NOTCHING OR DRILLING HAS BEEN ACCOUNTED FORIN THE DESIGN OF THE TRUSS

WHEN RENOVATING. INSULATION TO BE EQUAL TO OR GREATER THAN EXISTING

BEAM BEARING = MIN. 3-1/2" LINTEL BEARING = MIN. 1-1/2" RAFTER BEARING = MIN. 1-1/2" JOISTS BEARING = MIN. 1-1/2"

CONTRACTOR TO CHECK AND VERIFY ALL SPECIFICATIONS AND DIMENSIONS PRIOR TO AND DURING CONSTRUCTION. ALL DISCREPENCIES TO BE REPORTED TO DESIGNER (519) 339-1493

PROVIDE TEMPORARY BRACING/SHORING FOR ALL EXISTING FLOOR JOISTS & WALLS DURING CONSTRUCTION & INSTALLATION OF NEW BEAMS & FLOOR JOISTS AS REQ. (TYP.)

NOTE ABOUT MATCHING INSULATION IN OLDER HOMES THE ENERGY EFFICIENCY OF EXISTING BUILDINGS SHALL COMPLY WITH PART 11 OF DIVISION B OF THE BUILDING CODE

FOR RENOVATION. SB-12, 1.1.1.1. ENERGY EFFICIENCY CONSTRUCTION MAY BE CARRIED OUT TO MAINTAIN THE

EXISTING PERFORMANCE LEVEL OF ALL OR PART OF AN EXISTING BUILDING, BY THE REUSE, RELOCATION OR EXTENSION OF THE SAME OR SIMILAR MATERIALS OR COMPONENTS, TO RETAIN THE EXISTING CHARACTER, STRUCTURAL UNIQUENESS, HERITAGE VALUE, OR AESTHETIC APPEARANCE OF ALL OR PART OF THE BUILDING, IF THE CONSTRUCTION WILL NOT ADVERSELY AFFECT THE EARLY WARNING AND EVACUATION SYSTEMS, FIRE SEPARATIONS OR THE STRUCTURAL ADEQUACY OR WILL NOT CREATE AN UNHEALTHY ENVIRONMENT IN THE BUILDING. 11.3.3.1. BASIC RENOVATION (SEE APPENDIX A)

WHERE THE FRAMING SYSTEMS ARE BEING ALTERED TO MATCH EXISTING FRAMING, LESSER AMOUNTS AND EXTENT OF INSULATION AND VAPOR BARRIER IS ACCEPTABLE. PART 11 COMPLIANCE ALTERNATIVE, TABLE 11.5.1.1.C. (CONT'D), C199 - 12.2.1.1. (3)

SMOKE ALARMS

(1) Within dwelling units sufficient smoke alarms conforming to CAN/ULS-531 shall be installed so that (a) There is at least one smoke alarm on each storey, including basements, and

(b) On any storey of a dwelling unit containing sleeping rooms, a smoke alarm is installed,
(i) in each sleeping room, and
(ii) in a location between the sleeping rooms and remainder of the storey, and if the sleeping rooms are served by a hallway, the smoke alarm shall be located in the hallway


(2) Smoke alarms shall have a visual signalling component conforming to the requirements in 18.5.3. of NFPA 72. The visual signalling component need not be integrated with the smoke alarm provided it is interconnected

Interconnect smoke alarms to be permantly connected and have a battery backup as per OBC 9.10.19.4

TABLE 3.1.1.21. (IP) Thermal Performance Requirements for Additions to Existing Buildings ZONE 1

CEILING WITH ATTIC SPACE CEILING WITHOUT ATTIC SPACE CEILING WITHOUT ATTIC SPACE
EXPOSED FLOOR
WALLS ABOVE GRADE
BASEMENT WALLS
BELOW GRADE SLAB
EDGE OF BELOW GRADE SLAB
HEATED SLAB
WINDOWS AND SLIDING GLASS DOORS
ENERGY RATING R31 R19 + R5 c.i. R20 c.i. or R12 + R10 c.i. R10 0.28U 25

ELECTRICAL FACILITIES SHALL BE PROVIDED AS PER ONTARIO BUILDING CODE 2012 AS PER 9.34

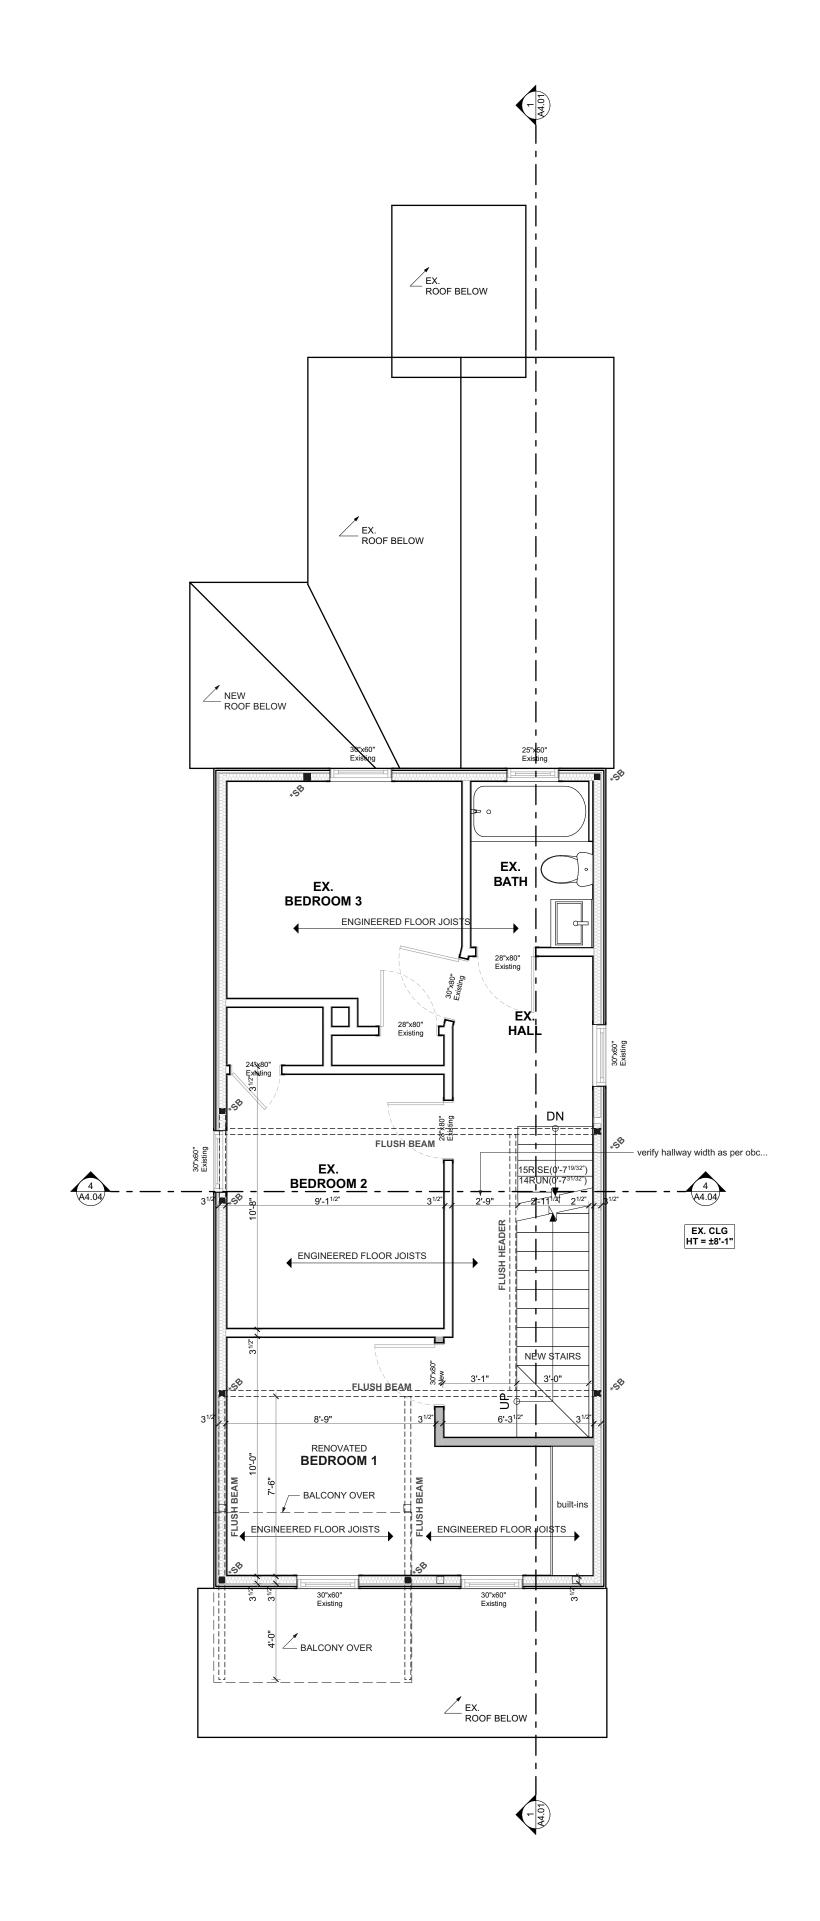



1 ISSUED FOR DESIGN 1 REVIEW 2021.03.29 2 ISSUED FOR DESIGN 2 REVIEW 2021.04.08

> PROPOSED SECOND **FLOOR PLAN**

DRAWING:

PROJECT NAME: **BURNEY-SUGGITT**

PROJECT ADDRESS: 20 WOOD ST W HAMILTON ON L8L 1E9

DATE: 2021-04-16

SCALE: DRAWING NO: AS NOTED PROJECT NO:

ALL CONSTRUCTION TO COMPLY WITH ONTARIO BUILDING CODE

DESIGN AND LAYOUT OF ALL PRE ENGINEERED STRUCTURAL MEMBERS FROM ROOF TRUSS SUPPLIER TO BE SUPPLIED BY MANUFACTURER PRIOR TO CONSTRUCTION

SOLID BLOCKING TO BEARING BELOW TO BE PROVIDED ATALL GIRDER TRUSS AND BEAM LOCATIONS (MIN. WIDTH EQUAL TO WIDTH OF BEARING POINT OVER) VERIFY WITH TRUSS DRAWINGS

TRUSS MEMBERS SHALL NEVER BE NOTCHED, DRILLED OR CUT UNLESS NOTCHING OR DRILLING HAS BEEN ACCOUNTED FORIN THE DESIGN OF THE TRUSS

WHEN RENOVATING. INSULATION TO BE EQUAL TO OR GREATER THAN EXISTING

BEAM BEARING = MIN. 3-1/2" LINTEL BEARING = MIN. 1-1/2" RAFTER BEARING = MIN. 1-1/2" JOISTS BEARING = MIN. 1-1/2"

CONTRACTOR TO CHECK AND VERIFY ALL SPECIFICATIONS AND DIMENSIONS PRIOR TO AND DURING CONSTRUCTION. ALL DISCREPENCIES TO BE REPORTED TO DESIGNER (519) 339-1493

PROVIDE TEMPORARY BRACING/SHORING FOR ALL EXISTING FLOOR JOISTS & WALLS DURING CONSTRUCTION & INSTALLATION OF NEW BEAMS & FLOOR JOISTS AS REQ. (TYP.)

NOTE ABOUT MATCHING INSULATION IN OLDER HOMES THE ENERGY EFFICIENCY OF EXISTING BUILDINGS SHALL COMPLY WITH PART 11 OF DIVISION B OF THE BUILDING CODE

FOR RENOVATION. SB-12, 1.1.1.1. ENERGY EFFICIENCY CONSTRUCTION MAY BE CARRIED OUT TO MAINTAIN THE

EXISTING PERFORMANCE LEVEL OF ALL OR PART OF AN EXISTING BUILDING, BY THE REUSE, RELOCATION OR EXTENSION OF THE SAME OR SIMILAR MATERIALS OR COMPONENTS, TO RETAIN THE EXISTING CHARACTER, STRUCTURAL UNIQUENESS, HERITAGE VALUE, OR AESTHETIC APPEARANCE OF ALL OR PART OF THE BUILDING, IF THE CONSTRUCTION WILL NOT ADVERSELY AFFECT THE EARLY WARNING AND EVACUATION SYSTEMS, FIRE SEPARATIONS OR THE STRUCTURAL ADEQUACY OR WILL NOT CREATE AN UNHEALTHY ENVIRONMENT IN THE BUILDING. 11.3.3.1. BASIC RENOVATION (SEE APPENDIX A)

WHERE THE FRAMING SYSTEMS ARE BEING ALTERED TO MATCH EXISTING FRAMING, LESSER AMOUNTS AND EXTENT OF INSULATION AND VAPOR BARRIER IS ACCEPTABLE. PART 11 COMPLIANCE ALTERNATIVE, TABLE 11.5.1.1.C. (CONT'D), C199 - 12.2.1.1. (3)

SMOKE ALARMS

(1) Within dwelling units sufficient smoke alarms conforming to CAN/ULS-531 shall be installed so that (a) There is at least one smoke alarm on each storey, including basements, and

(b) On any storey of a dwelling unit containing sleeping rooms, a smoke alarm is installed,
(i) in each sleeping room, and
(ii) in a location between the sleeping rooms and remainder of the storey, and if the sleeping rooms are served by a hallway, the smoke alarm shall be located in the hallway


(2) Smoke alarms shall have a visual signalling component conforming to the requirements in 18.5.3. of NFPA 72. The visual signalling component need not be integrated with the smoke alarm provided it is interconnected

Interconnect smoke alarms to be permantly connected and have a battery backup as per OBC 9.10.19.4

TABLE 3.1.1.21. (IP) Thermal Performance Requirements for Additions to Existing Buildings ZONE 1

CEILING WITH ATTIC SPACE CEILING WITHOUT ATTIC SPACE CEILING WITHOUT ATTIC SPACE
EXPOSED FLOOR
WALLS ABOVE GRADE
BASEMENT WALLS
BELOW GRADE SLAB
EDGE OF BELOW GRADE SLAB
HEATED SLAB
WINDOWS AND SLIDING GLASS DOORS
ENERGY RATING R31 R19 + R5 c.i. R20 c.i. or R12 + R10 c.i. R5 R10 R10 0.28U 25

ELECTRICAL FACILITIES SHALL BE PROVIDED AS PER ONTARIO BUILDING CODE 2012 AS PER 9.34

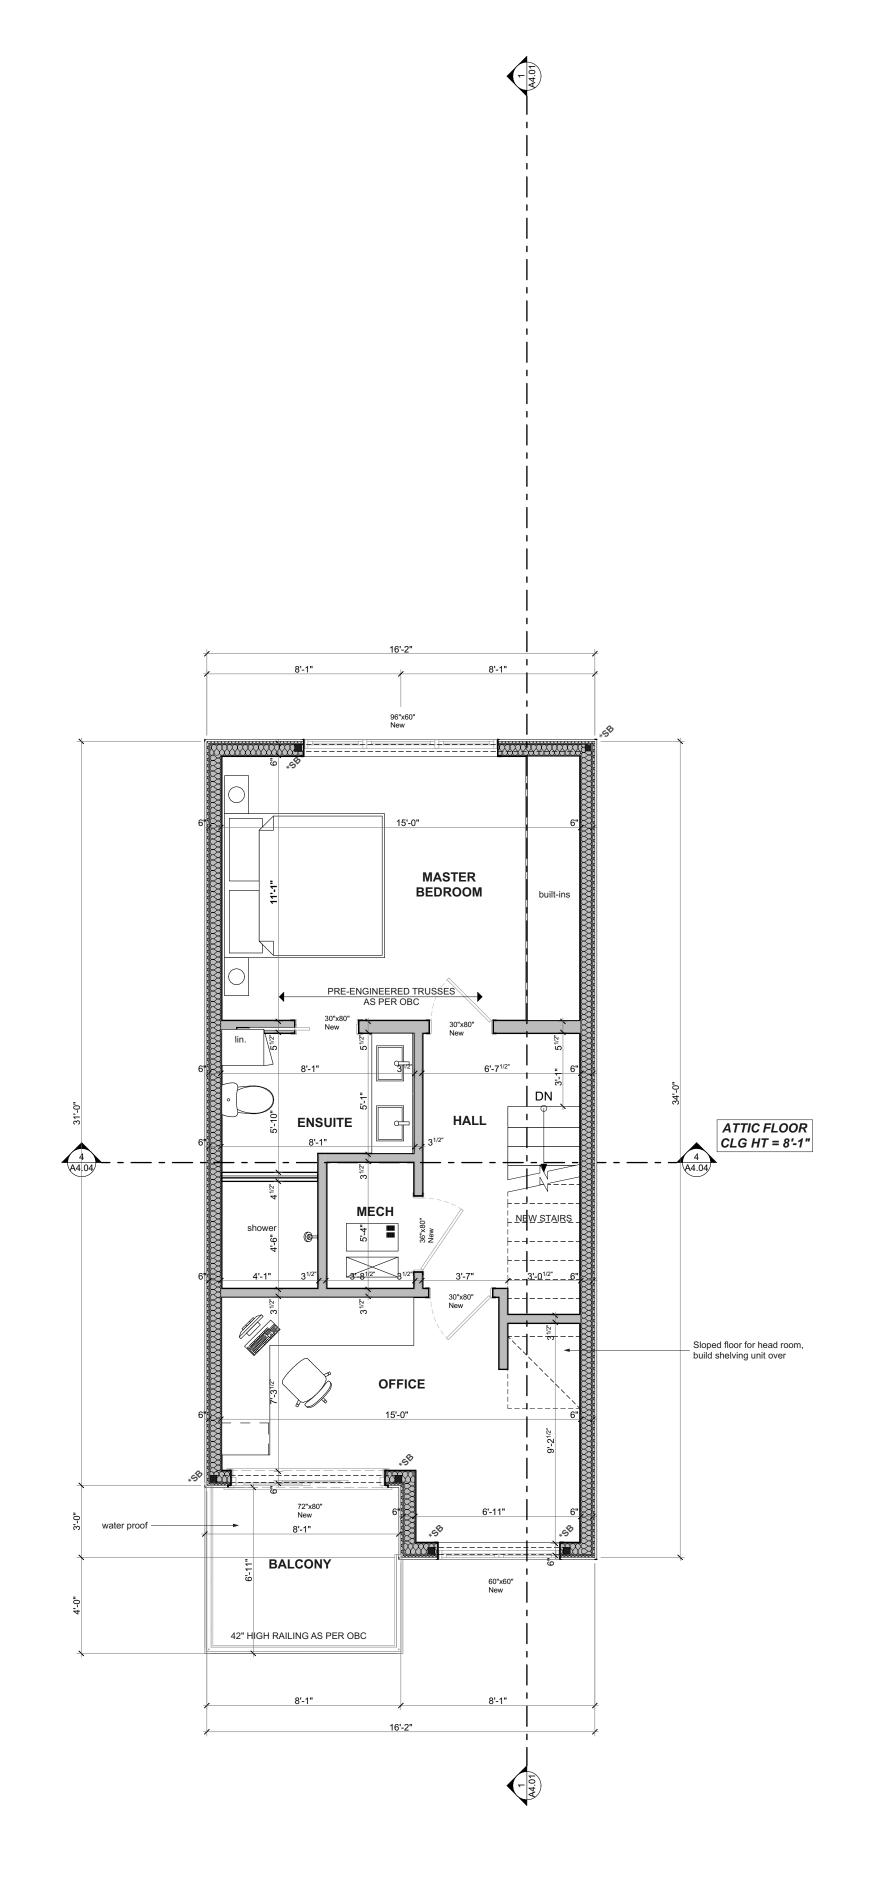



NO.	REVISION	DATE
1	ISSUED FOR DESIGN 1 REVIEW	2021.03.29
2	ISSUED FOR DESIGN 2 REVIEW	2021.04.08
3		
4		
5		

PROPOSED THIRD FLOOR **PLAN**


DRAWING:

PROJECT NAME: **BURNEY-SUGGITT**

PROJECT ADDRESS: 20 WOOD ST W HAMILTON ON L8L 1E9

DATE: 2021-04-16

SCALE: DRAWING NO: AS NOTED PROJECT NO:

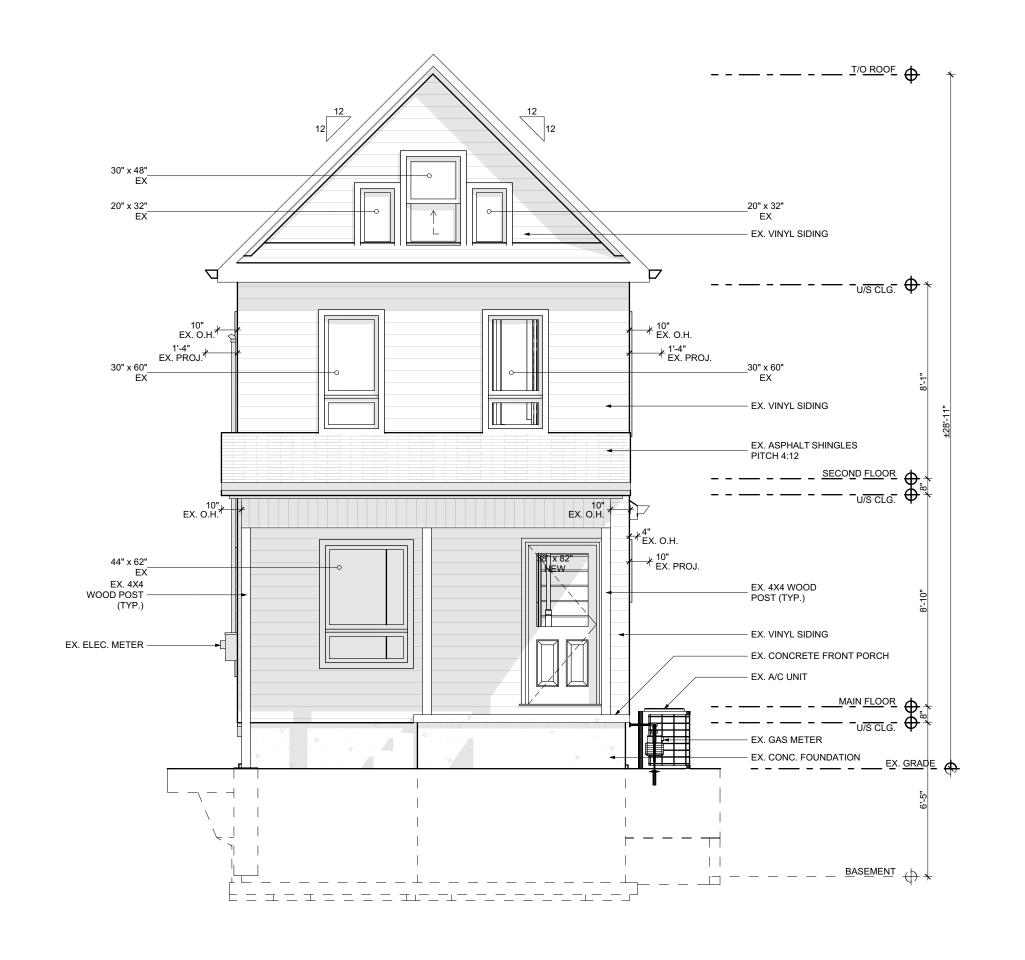



CONSTRUCTION

NO.	REVISION	DATE
1	ISSUED FOR DESIGN 1 REVIEW	2021.03.29
2	ISSUED FOR DESIGN 2 REVIEW	2021.04.08
3		
4		
5		

EXISTING FRONT ELEVATION

DRAWING:

PROJECT NAME:
BURNEY-SUGGITT


PROJECT ADDRESS:
20 WOOD ST W HAMILTON ON L8L 1E9

DATE: 2021-04-16

SCALE: DRAWING NO:

AS NOTED

PROJECT NO: A2.01

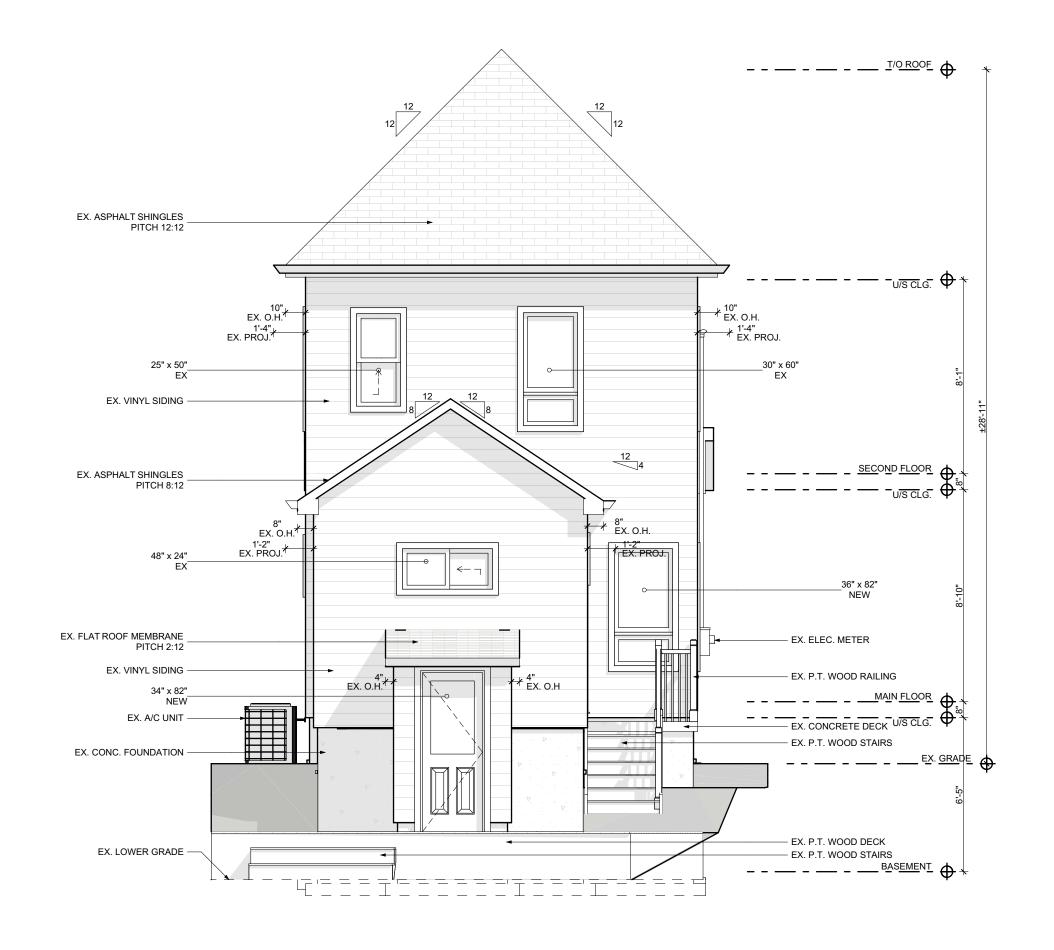



NO.	REVISION	DATE
1	ISSUED FOR DESIGN 1 REVIEW	2021.03.29
2	ISSUED FOR DESIGN 2 REVIEW	2021.04.08
3		
4		
5		

EXISTING REAR ELEVATION

DRAWING:


PROJECT NAME: **BURNEY-SUGGITT**

PROJECT ADDRESS: 20 WOOD ST W HAMILTON ON L8L 1E9

SCALE: AS NOTED PROJECT NO:

DATE: 2021-04-16

DRAWING NO:

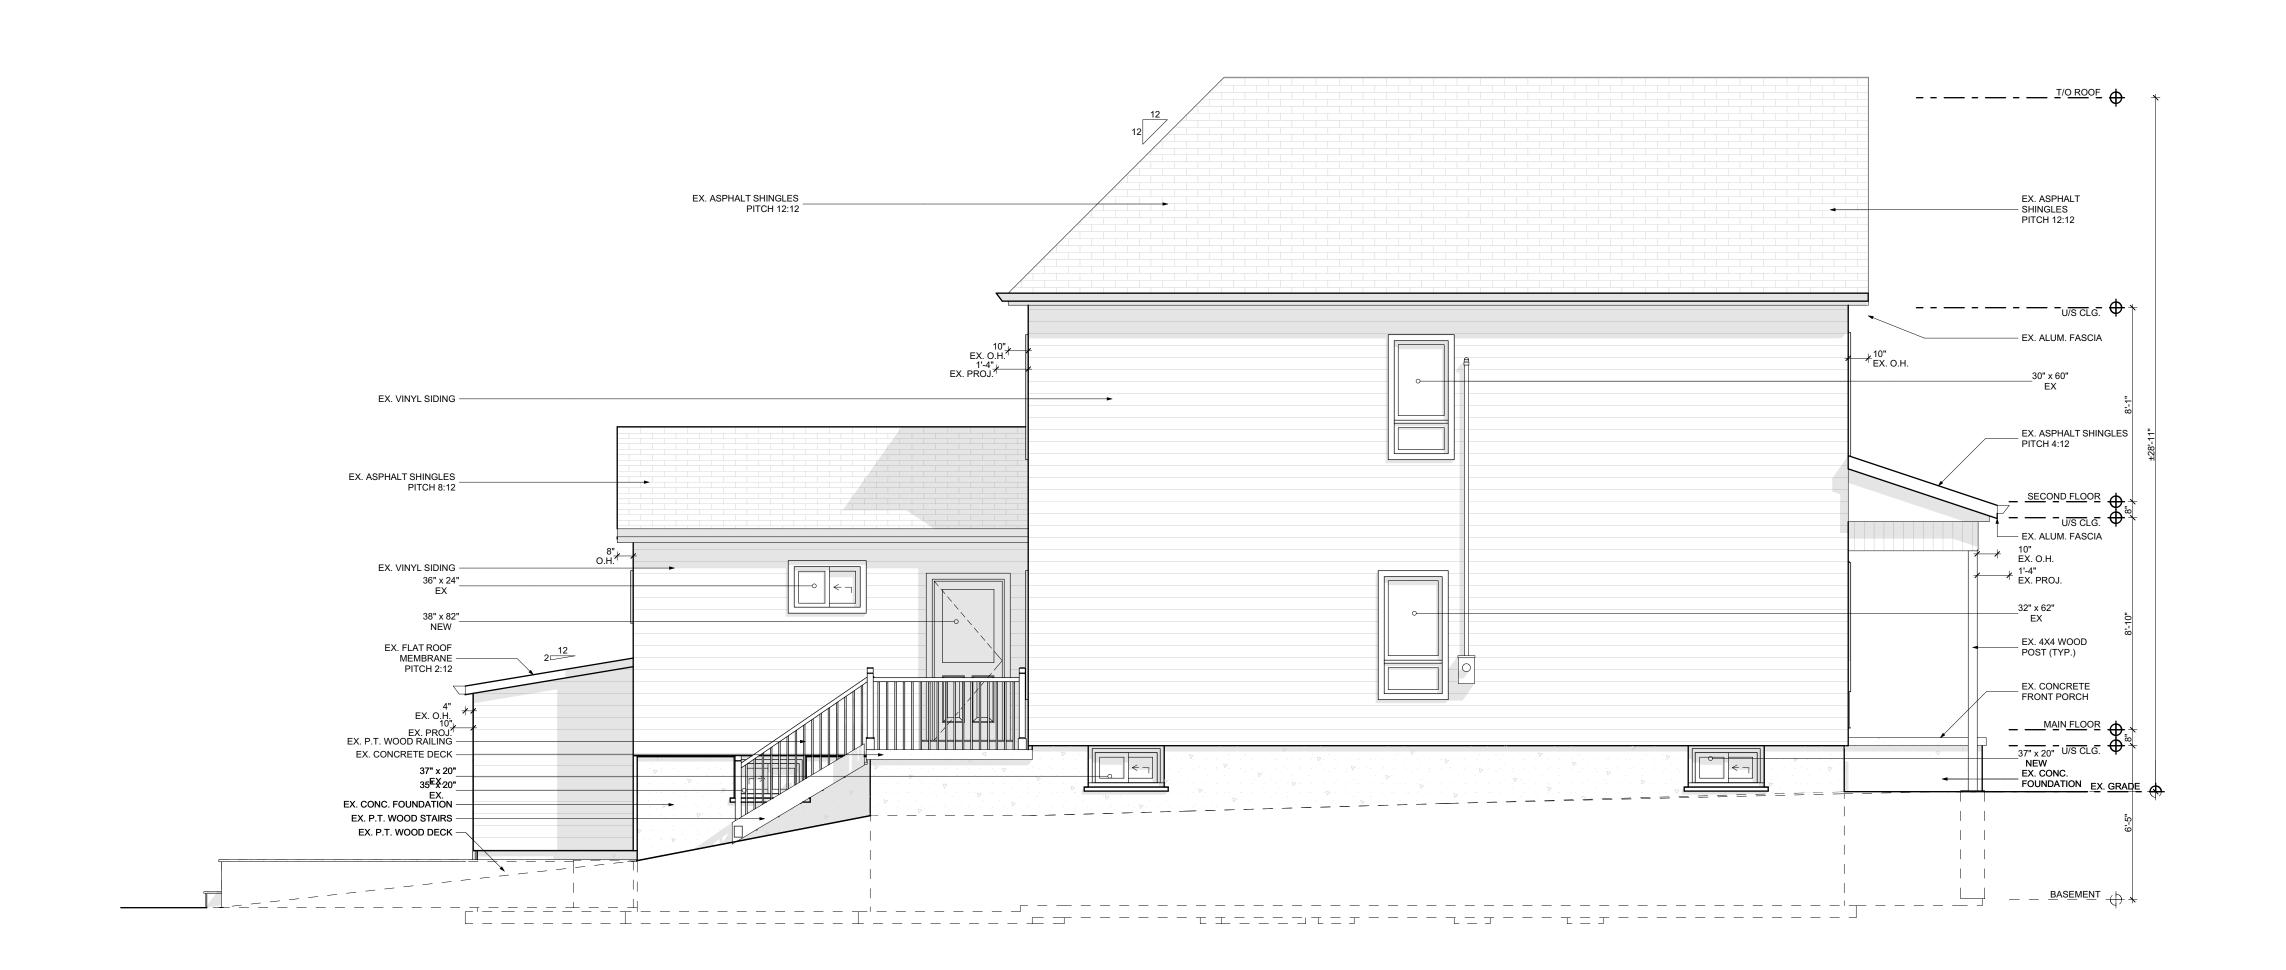

SPACIAL SEPARATION CALCULATIONS

LIMITING DISTANCE =
EXPOSED BUILDING FACE (EFB) =
PROPOSED GLAZING AREA =

PERMITTED GLAZING % =
ACTUAL GLAZING AREA % =

CONTRACTOR

Figure 190 SHAVER RD. ANCASTER
L9G 3K9 ON

CONSTRUCTION

1 ISSUED FOR DESIGN 1 REVIEW 2021.03.29
2 ISSUED FOR DESIGN 2 REVIEW 2021.04.08
3 4 5
DRAWING:

EXISTING LEFT ELEVATION

PROJECT NAME: BURNEY-SUGGITT

PROJECT ADDRESS:
20 WOOD ST W HAMILTON ON L8L 1E9

DATE: 2021-04-16

SCALE: DRAWING NO:

AS NOTED

PROJECT NO: A2.03

1 EXISTING LEFT ELEVATION

SCALE: 1/4" = 1'-0"

⊕ <u>T/O ROOF</u> — - — - — - -EX. ASPHALT SHINGLES
PITCH 12:12 EX. ASPHALT SHINGLES — PITCH 12:12 EX. ALUM. FASCIA — 10" EX. O.H. 1'-4" EX. PROJ. 10"<u>,</u> EX. O.H.[†] — EX. VINYL SIDING EX. ASPHALT SHINGLES _ PITCH 4:12 EX. ASPHALT SHINGLES
PITCH 8:12 SECOND FLOOR - -EX. ALUM. FASCIA — *10" * 1'-4" EX. 4X4 WOOD _ POST (TYP.) — EX. VINYL SIDING EX. FLAT ROOF

MEMBRANE
PITCH 2:12 EX. GAS METER -EX. CONCRETE _ FRONT PORCH EX. ASPHALT SHINGLES
PITCH 12:12

10"
EX. PROJ.
EX. P.T. WOOD RAILING
EX. CONCRETE DECK NEW EX. CONC. FOUNDATION __35" x 20" NEW EX. CONC. FOUNDATION
EX. P.T. WOOD STAIRS
EX. P.T. WOOD DECK BASEMENT _ _

SPACIAL SEPARATION CALCULATIONS

LIMITING DISTANCE =

EXPOSED BUILDING FACE (EFB) =

PROPOSED GLAZING AREA =

PERMITTED GLAZING % =

ACTUAL GLAZING AREA % =

CONTRACTOR

790 SHAVER RD. ANCASTER L9G 3K9 ON

NOT FOR CONSTRUCTION

 NO.
 REVISION
 DATE

 1
 ISSUED FOR DESIGN 1 REVIEW
 2021.03.29

 2
 ISSUED FOR DESIGN 2 REVIEW
 2021.04.08

 3
 4

 5
 5

DRAWING:
EXISTING RIGHT
ELEVATION

PROJECT NAME:

BURNEY-SUGGITT
PROJECT ADDRESS:


20 WOOD ST W HAMILTON ON L8L 1E9

DATE: 2021-04-16

SCALE: DRAWING NO:

AS NOTED

PROJECT NO: A2.04

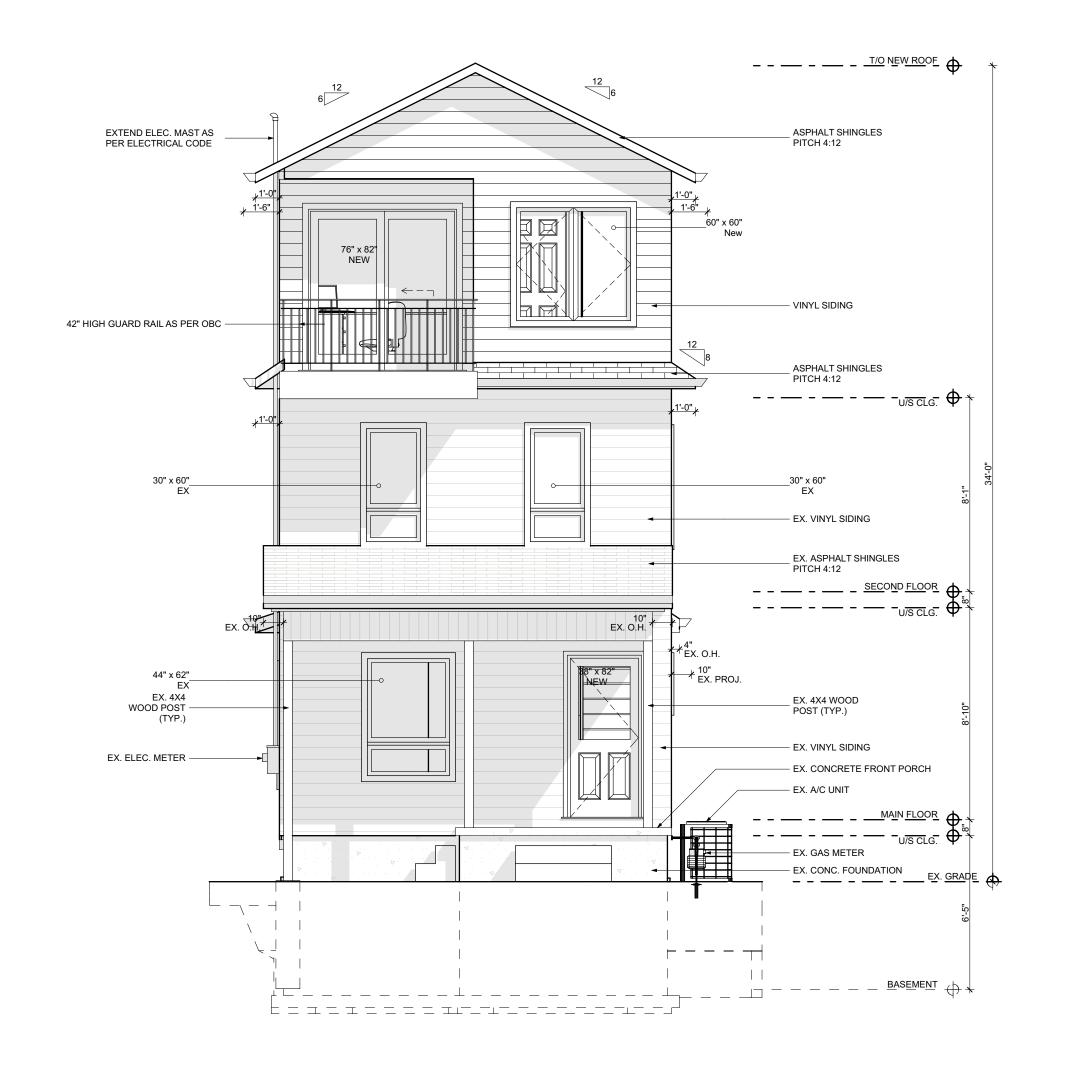



CONSTRUCTION

NO.	REVISION	DATE
1	ISSUED FOR DESIGN 1 REVIEW	2021.03.29
2	ISSUED FOR DESIGN 2 REVIEW	2021.04.08
3		
4		
5		

DRAWING:

PROPOSED FRONT ELEVATION

PROJECT NAME: **BURNEY-SUGGITT**


PROJECT ADDRESS:
20 WOOD ST W HAMILTON ON L8L 1E9

DATE: 2021-04-16

SCALE: DRAWING NO:

AS NOTED

PROJECT NO: A 2.05

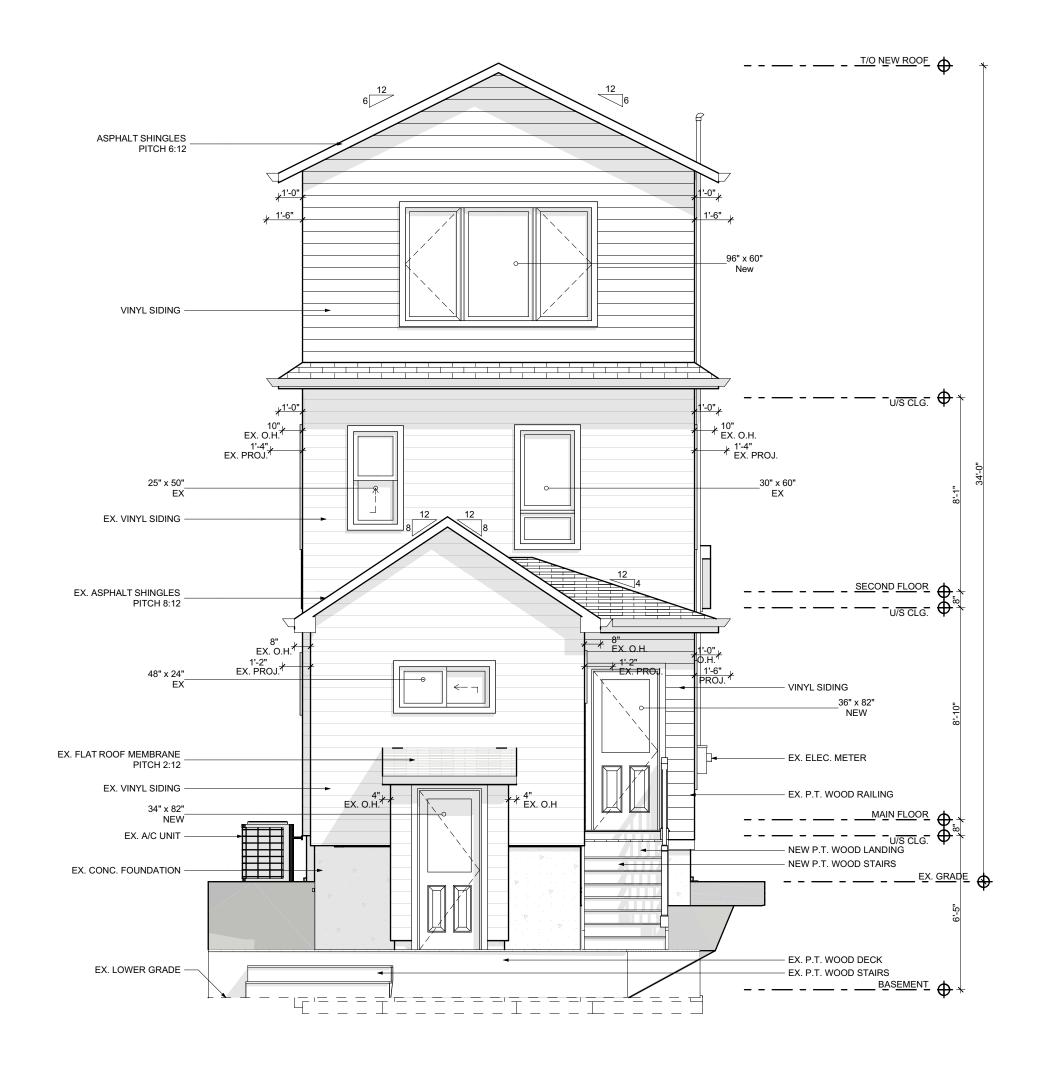



NO.	REVISION	DATE
1	ISSUED FOR DESIGN 1 REVIEW	2021.03.29
2	ISSUED FOR DESIGN 2 REVIEW	2021.04.08
3		
4		
5		

DRAWING: PROPOSED REAR


ELEVATION

PROJECT NAME: **BURNEY-SUGGITT**

PROJECT ADDRESS: 20 WOOD ST W HAMILTON ON L8L 1E9

DATE: 2021-04-16

DRAWING NO: SCALE: AS NOTED PROJECT NO:

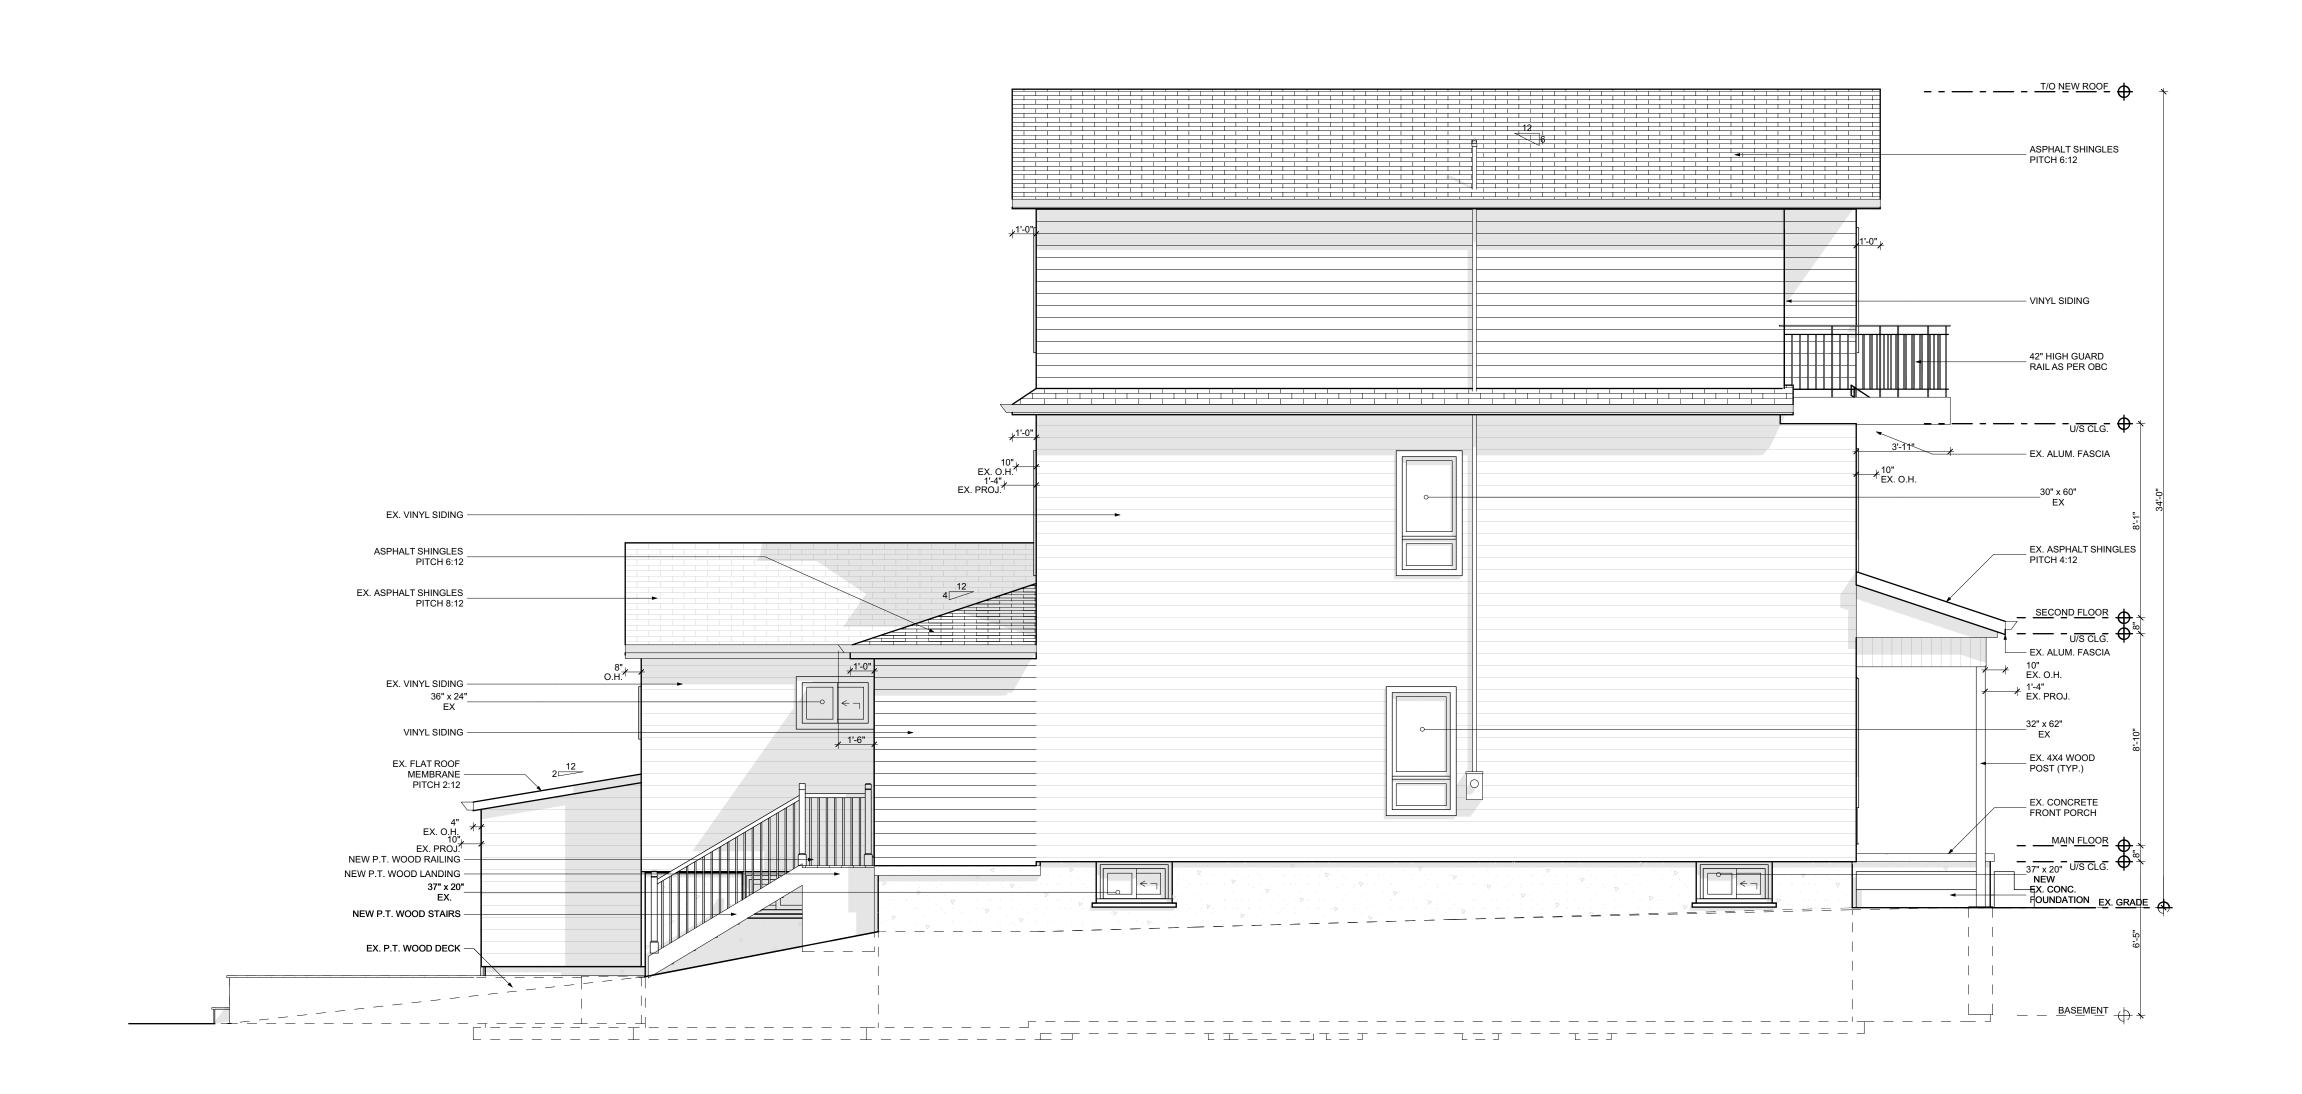

SPACIAL SEPARATION CALCULATIONS LIMITING DISTANCE = EXPOSED BUILDING FACE (EFB) = PROPOSED GLAZING AREA = PERMITTED GLAZING % = ACTUAL GLAZING AREA % =



1 ISSUED FOR DESIGN 1 REVIEW 2021.03.29 2 ISSUED FOR DESIGN 2 REVIEW 2021.04.08

> PROPOSED LEFT **ELEVATION**

DRAWING:

PROJECT NAME: **BURNEY-SUGGITT**

PROJECT ADDRESS: 20 WOOD ST W HAMILTON ON L8L 1E9

DATE: 2021-04-16

DRAWING NO: SCALE: AS NOTED PROJECT NO:

◆ T/O NEW ROOF - - - - - - - -ASPHALT SHINGLES _ PITCH 6:12 VINYL SIDING — 42" HIGH GUARD RAIL AS PER OBC † \$\Phi \tau/\s \text{clg.}^- \leftarrow - \ / 3'-11" - EX. VINYL SIDING EX. ASPHALT SHINGLES _ PITCH 4:12 EX. ASPHALT SHINGLES
PITCH 8:12 SECOND FLOOR - - U/S CLG. - - -EX. ALUM. FASCIA — *10" * 1'-4" EX. 4X4 WOOD _ POST (TYP.) — EX. VINYL SIDING EX. FLAT ROOF EX. GAS METER -MEMBRANE
PITCH 2:12 EX. CONCRETE _ FRONT PORCH EX. ASPHALT SHINGLES
PITCH 12:12

10"
EX. PROJ.
EX. P.T. WOOD RAILING
EX. CONCRETE DECK MAIN FLOOR

U/S CLG. 37" × 20"

NEW EX. CONC.

EX. GRADE FOUNDATION __35" x 20" NEW EX. CONC. FOUNDATION
EX. P.T. WOOD STAIRS
EX. P.T. WOOD DECK BASEMENT _ _

SPACIAL SEPARATION CALCULATIONS

LIMITING DISTANCE =

EXPOSED BUILDING FACE (EFB) =

PROPOSED GLAZING AREA =

PERMITTED GLAZING % =

ACTUAL GLAZING AREA % =

CONTRACTOR

CONTRACTOR

Fending States of the contractor of the co

CONSTRUCTION

 NO.
 REVISION
 DATE

 1
 ISSUED FOR DESIGN 1 REVIEW
 2021.03.29

 2
 ISSUED FOR DESIGN 2 REVIEW
 2021.04.08

 3
 4
 5

PROPOSED RIGHT ELEVATION

DRAWING:

PROJECT NAME: **BURNEY-SUGGITT**

PROJECT ADDRESS:
20 WOOD ST W HAMILTON ON L8L 1E9


DATE: 2021-04-16

SCALE:

AS NOTED

PROJECT NO:

SCALE: DRAWING NO:

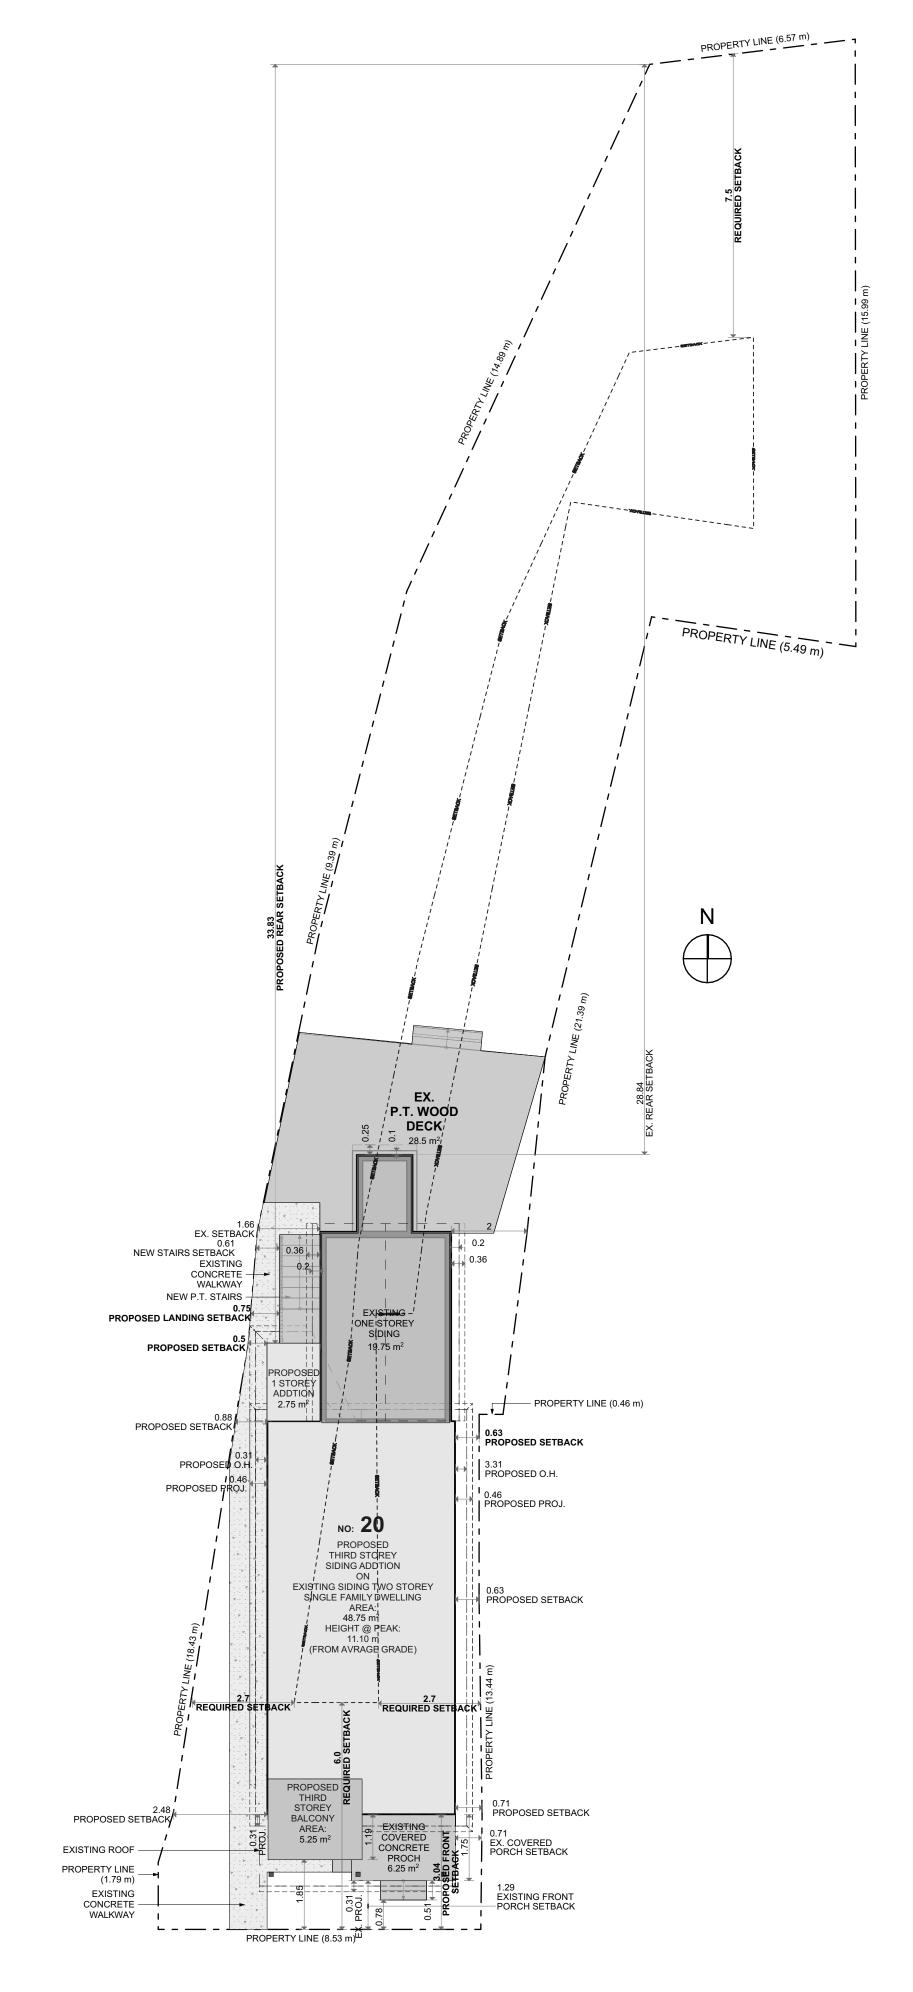

 $W \circ O \circ D \circ S \circ T \circ W$

SITE INFORMATION Zoning Information taken on: 2021.04.15 ADDRESS: 20 WOOD ST W MUNICIPALITY: HAMILTON POSTAL CODE: L8L 1E9 **ZONING INFORMATION** PARENT BYLAW #: 6593 FORMER HAMILTON ZONE: D BYLAW EXCEPTION #: N/A MINOR VARIANCE #: N/A Required: Existing: Proposed: Conforms LOT AREA (m2): 360 min 404.69 AS EX. 12 min 8.53 AS EX. N/A 50.14 AS EX. LOT WIDTH (m): LOT FRONTAGE: 12 min 8.53 AS EX. LOT COVERAGE (%)1: FLOOR AREA RATIO2: GROSS FLOOR AREA⁴: N/A
GROUND FLOOR AREA: N/A BUILDING HEIGHT (m): PARKING SPACES3: Habitable Rooms:
 SETBACKS (m)
 Required:
 Existing:
 Proposed:
 Conforms

 FRONT:
 6.00
 3.04
 3.04
 O

 REAR:
 7.50
 28.84
 33.83
 ●

 RIGHT SIDE (EAST):
 2.70
 0.63
 0.63
 O

 LEFT SIDE SIDE (WEST):
 2.70
 0.88
 0.50
 O

 ENCROACHMENTS (m)
 Required:
 Existing:
 Proposed:
 Conforms

 ROOF PROJECTION:
 0.6
 0.41
 0.46
 O

 COVERED PORCH:
 1.5
 2.04
 EX. NON-CON.
 O

 UNCOVERED PORCH:
 1.5
 N/A
 N/A
 O

 DECK:
 1.5
 2.7
 EX. NON-CON.
 O
 ACCESSORY BUILDINGS: Required: Existing: Proposed: Conforms

SIZE: N/A N/A N/A O

HEIGHT: N/A N/A N/A O

> Req. Not Req. CONSERVATION AUTHORITY NIAGARA ESCARPEMENT CONTROL MTO SEPTIC SITE PLAN CONTROL TREE PROTECTION

REFERENCES

OTHER RETRICTIONS:

¹ Proposed lot coverage calculations = Proposed Footprint area / Lot Area ² Floor Area Ratio Calculation:Total GFA / Lot Area

³ Parking space sizing as follows: Hamilton: 2.7m x 6.0m Burlington: 2.7m x 6.0m ⁴ Area of all floors excluding the following:
1. 100sf for laundry if possible
2. 70sf for mechanical if possible
3. Attic spaces
4. Any area that is uninhabitable

> CONTRACTOR 790 SHAVER RD. ANCASTER L9G 3K9 ON

NO. REVISION 1 ISSUED FOR DESIGN 1 REVIEW 2021.03.29 2 ISSUED FOR DESIGN 2 REVIEW 2021.04.08

SITE PLAN

DRAWING:

PROJECT NAME:

BURNEY-SUGGITT

PROJECT ADDRESS:

20 WOOD ST W HAMILTON ON L8L 1E9

DATE: 2021-04-16

SCALE: DRAWING NO: AS NOTED PROJECT NO:



FOR OFFICE USE ONLY.

Committee of Adjustment

City Hall, 5th Floor, 71 Main St. W., Hamilton, ON L8P4Y5

Phone: (905) 546-2424 ext. 4221

Email: cofa@hamilton.ca

APPLICATION FOR A MINOR VARIANCE

APPLICATION NO	DATE APPLICATION RECEIVED		
PAID	DATE APPLICATION DEEMED COMPLETE		
SECRETARY'S SIGNATURE			
	The F	Planning Act	
	Application for Mino	r Variance or for Permiss	ion
	ning Act, R.S.O. 1990, Ch	ee of Adjustment for the Cit apter P.13 for relief, as des	
1, 2	NAME	ADDRESS	
Registered Owners(s)			
Applicant(s)*			
Agent or Solicitor			
		communications will be s	- 1

Additional sheets can be submitted if there is not sufficient room to answer the following questions. Additional sheets must be clearly labelled

- 4. Nature and extent of relief applied for:
 - 1-To permit 3.04m front (south) yard setback for the proposed third storey addition instead of 6.0m with 0.31 roof projection.
 - 2-To permit 0.60 right (east) side yard setback instead of 2.7m with roof projection of 0.46m for the proposed third storey addition.
 - 3-To permit 0.50m left (west) side yard setback instead of 2.7m with roof projection of 0.46m for the proposed rear addition.
 - 4-To permit no parking spaces instead of the required 3 parking spaces.
 - 5- To permit 1.2 balcony projection from the proposed setback 3.04m
- 5. Why it is not possible to comply with the provisions of the By-law?
- 6. Legal description and Address of subject lands (registered plan number and lot number or other legal description and where applicable, **street and street number**):

7.	PREVIOUS USE OF PROPERTY						
	Residential _	Industrial	Commercial				
	Agricultural _	Vacant					
	Other		·····				
8.1	If Industrial or	Commercial, speci	ify use				
8.2	Has the grading of the subject land been changed by adding earth or other material, i.e. has filling occurred?						
	Yes	No	Unknown				
8.3	Has a gas station been located on the subject land or adjacent lands at any time?						
	Yes	No	Unknown				
8.4	Has there been petroleum or other fuel stored on the subject land or adjacent lands?						
	Yes	No	Unknown				
8.5	Are there or have there ever been underground storage tanks or buried waste on the subject land or adjacent lands?						
	Yes	No	Unknown				
8.6	Have the lands or adjacent lands ever been used as an agricultural operation where cyanide products may have been used as pesticides and/or sewage sludge was applied to the lands?						
	Yes	No	Unknown				
8.7	Have the lands or adjacent lands ever been used as a weapon firing range?						
	Yes	No	Unknown				
8.8		boundary line of th	ne application within 500 metres (1,640 feet) of the fill area Il landfill or dump?				
	Yes	No	Unknown				
8.9		• .	existing buildings, are there any building materials ntially hazardous to public health (eg. asbestos, PCB's)?				
	Voc	No	Unknown				

8.10	Is there any reason to believe the subject land may have been contaminated by former uses on the site or adjacent sites?						
	Yes No	Unkno	own				
8.11	What information did y	ou use to determin	ne the answei	rs to 9.1 to 9.1	0 above?		
8.12	If previous use of prop previous use inventory land adjacent to the su	showing all forme	er uses of the		•		
	Is the previous use inv	entory attached?	Yes	No	(N/A)		
9.	ACKNOWLEDGEME I acknowledge that the remediation of contam reason of its approval	City of Hamilton i	erty which is			– by	
	Date		Signature P	roperty Owner	-		
			Print Name	of Owner			
10.	Dimensions of lands a Frontage Depth Area Width of street	ffected:					
11.	Particulars of all building ground floor area, gro	•		-		ify	
	Proposed						
12.	Location of all building distance from side, real Existing: FRONT (SOUTH) SII RIGHT SIDE (EAST) LEFT SIDE (WEST) REAR (NORTH) SID Proposed: FRONT (SOUTH) SIE RIGHT SIDE (EAST) LEFT SIDE (WEST) SREAR (NORTH) SIDI	DE:3.04 m SIDE:0.63 m SIDE:0.88 m E:28.84m DE:3.04 m SIDE:0.63 m		for the subjec	ct lands; (Specify	1	

Date of acquisition of subject lands:
Date of construction of all buildings and structures on subject lands:
Existing uses of the subject property:
Existing uses of abutting properties:
Length of time the existing uses of the subject property have continued:
Municipal services available: (check the appropriate space or spaces)
Water Connected
Starra Saurara
Storm Sewers Present Official Plan/Secondary Plan provisions applying to the land:
Present Restricted Area By-law (Zoning By-law) provisions applying to the land:
Has the owner previously applied for relief in respect of the subject property?
Yes No If the answer is yes, describe briefly.
Is the subject property the subject of a current application for consent under Section 53 o the <i>Planning Act</i> ?
Yes No
Additional Information
The applicant shall attach to each copy of this application a plan showing the dimensions of the subject lands and of all abutting lands and showing the location, size and type of all buildings and structures on the subject and abutting lands, and where required by the Committee of Adjustment such plan shall be signed by an Ontario Land Surveyor.