COMMITTEE OF ADJUSTMENT



City Hall, 5th floor, 71 Main Street West, Hamilton, ON L8P 4Y5 Telephone (905) 546-2424, ext. 4221, 3935 Fax (905) 546-4202

E-mail: cofa@hamilton.ca

NOTICE OF PUBLIC HEARING Minor Variance

You are receiving this notice because you are either:

- Assessed owner of a property located within 60 metres of the subject property
- Applicant/agent on file, or
- Person likely to be interested in this application

APPLICATION NO.: HM/A-21:262

APPLICANTS: Owner Chris Donaldson

SUBJECT PROPERTY: Municipal address 99 Kimberly Dr., Hamilton

ZONING BY-LAW: Zoning By-law 6593, as Amended

ZONING: C district (Urban Protected Residential, etc.)

PROPOSAL: To permit the construction of a single family dwelling notwithstanding

that:

- 1. The roofed-over unenclosed one-storey porch at the first storey level, including the stairs, eaves and gutters, shall be permitted to project entirely into the required front yard (being 1.9m) and shall be distant 0.0m from the front lot line instead of the requirement that a roofed-over or screened but otherwise unenclosed one-storey porch at the first storey level, including eaves and gutters, may project into a required front yard or rear yard to a distance of not more than 3.0m and every such projecting porch shall be distant at least 1.5m from the front lot line.
- 2. Eaves and gutters may project into the required front yard and shall be as close as 1.3m from the street line instead of the requirement that an eave or gutter may project into a required front yard provided that no such projection shall be closer to a street line than 1.5m.
- 3. One (1) parking space shall be permitted instead of the minimum required two (2) parking spaces.
- 4. A minimum aisle width manoeuvring space of 1.9m shall be provided instead of the minimum required aisle width manoeuvring space of 6.0m.
- 5. The finished level of the garage floor shall be permitted to be a minimum of 0.2m above grade instead of the requirement that where a dwelling is constructed with an attached garage, then the finished level of the garage floor shall be a minimum of 0.3 metres above grade.

NOTE:

i) Variance No. 3 of Minor Variance File No. HM/A-19:391 was granted to permit a minimum front yard of 1.9m for this lot which was severed from lands known municipally as 106 Ferndale Avenue, Hamilton pursuant to Consent File No. HM/B-19:38.

HM/A-21: 262

Page 2

This application will be heard by the Committee as shown below:

DATE: Thursday, August 26th, 2021

TIME: 3:00 p.m.

PLACE: Via video link or call in (see attached sheet for details)

To be streamed at

www.hamilton.ca/committeeofadjustment

for viewing purposes only

PUBLIC INPUT

Written: If you would like to submit written comments to the Committee of Adjustment you may do so via email or hardcopy. Please see attached page for complete instructions, including deadlines for submitting to be seen by the Committee.

Orally: If you would like to speak to this item at the hearing you may do so via video link or by calling in. Please see attached page for complete instructions, including deadlines for registering to participate.

MORE INFORMATION

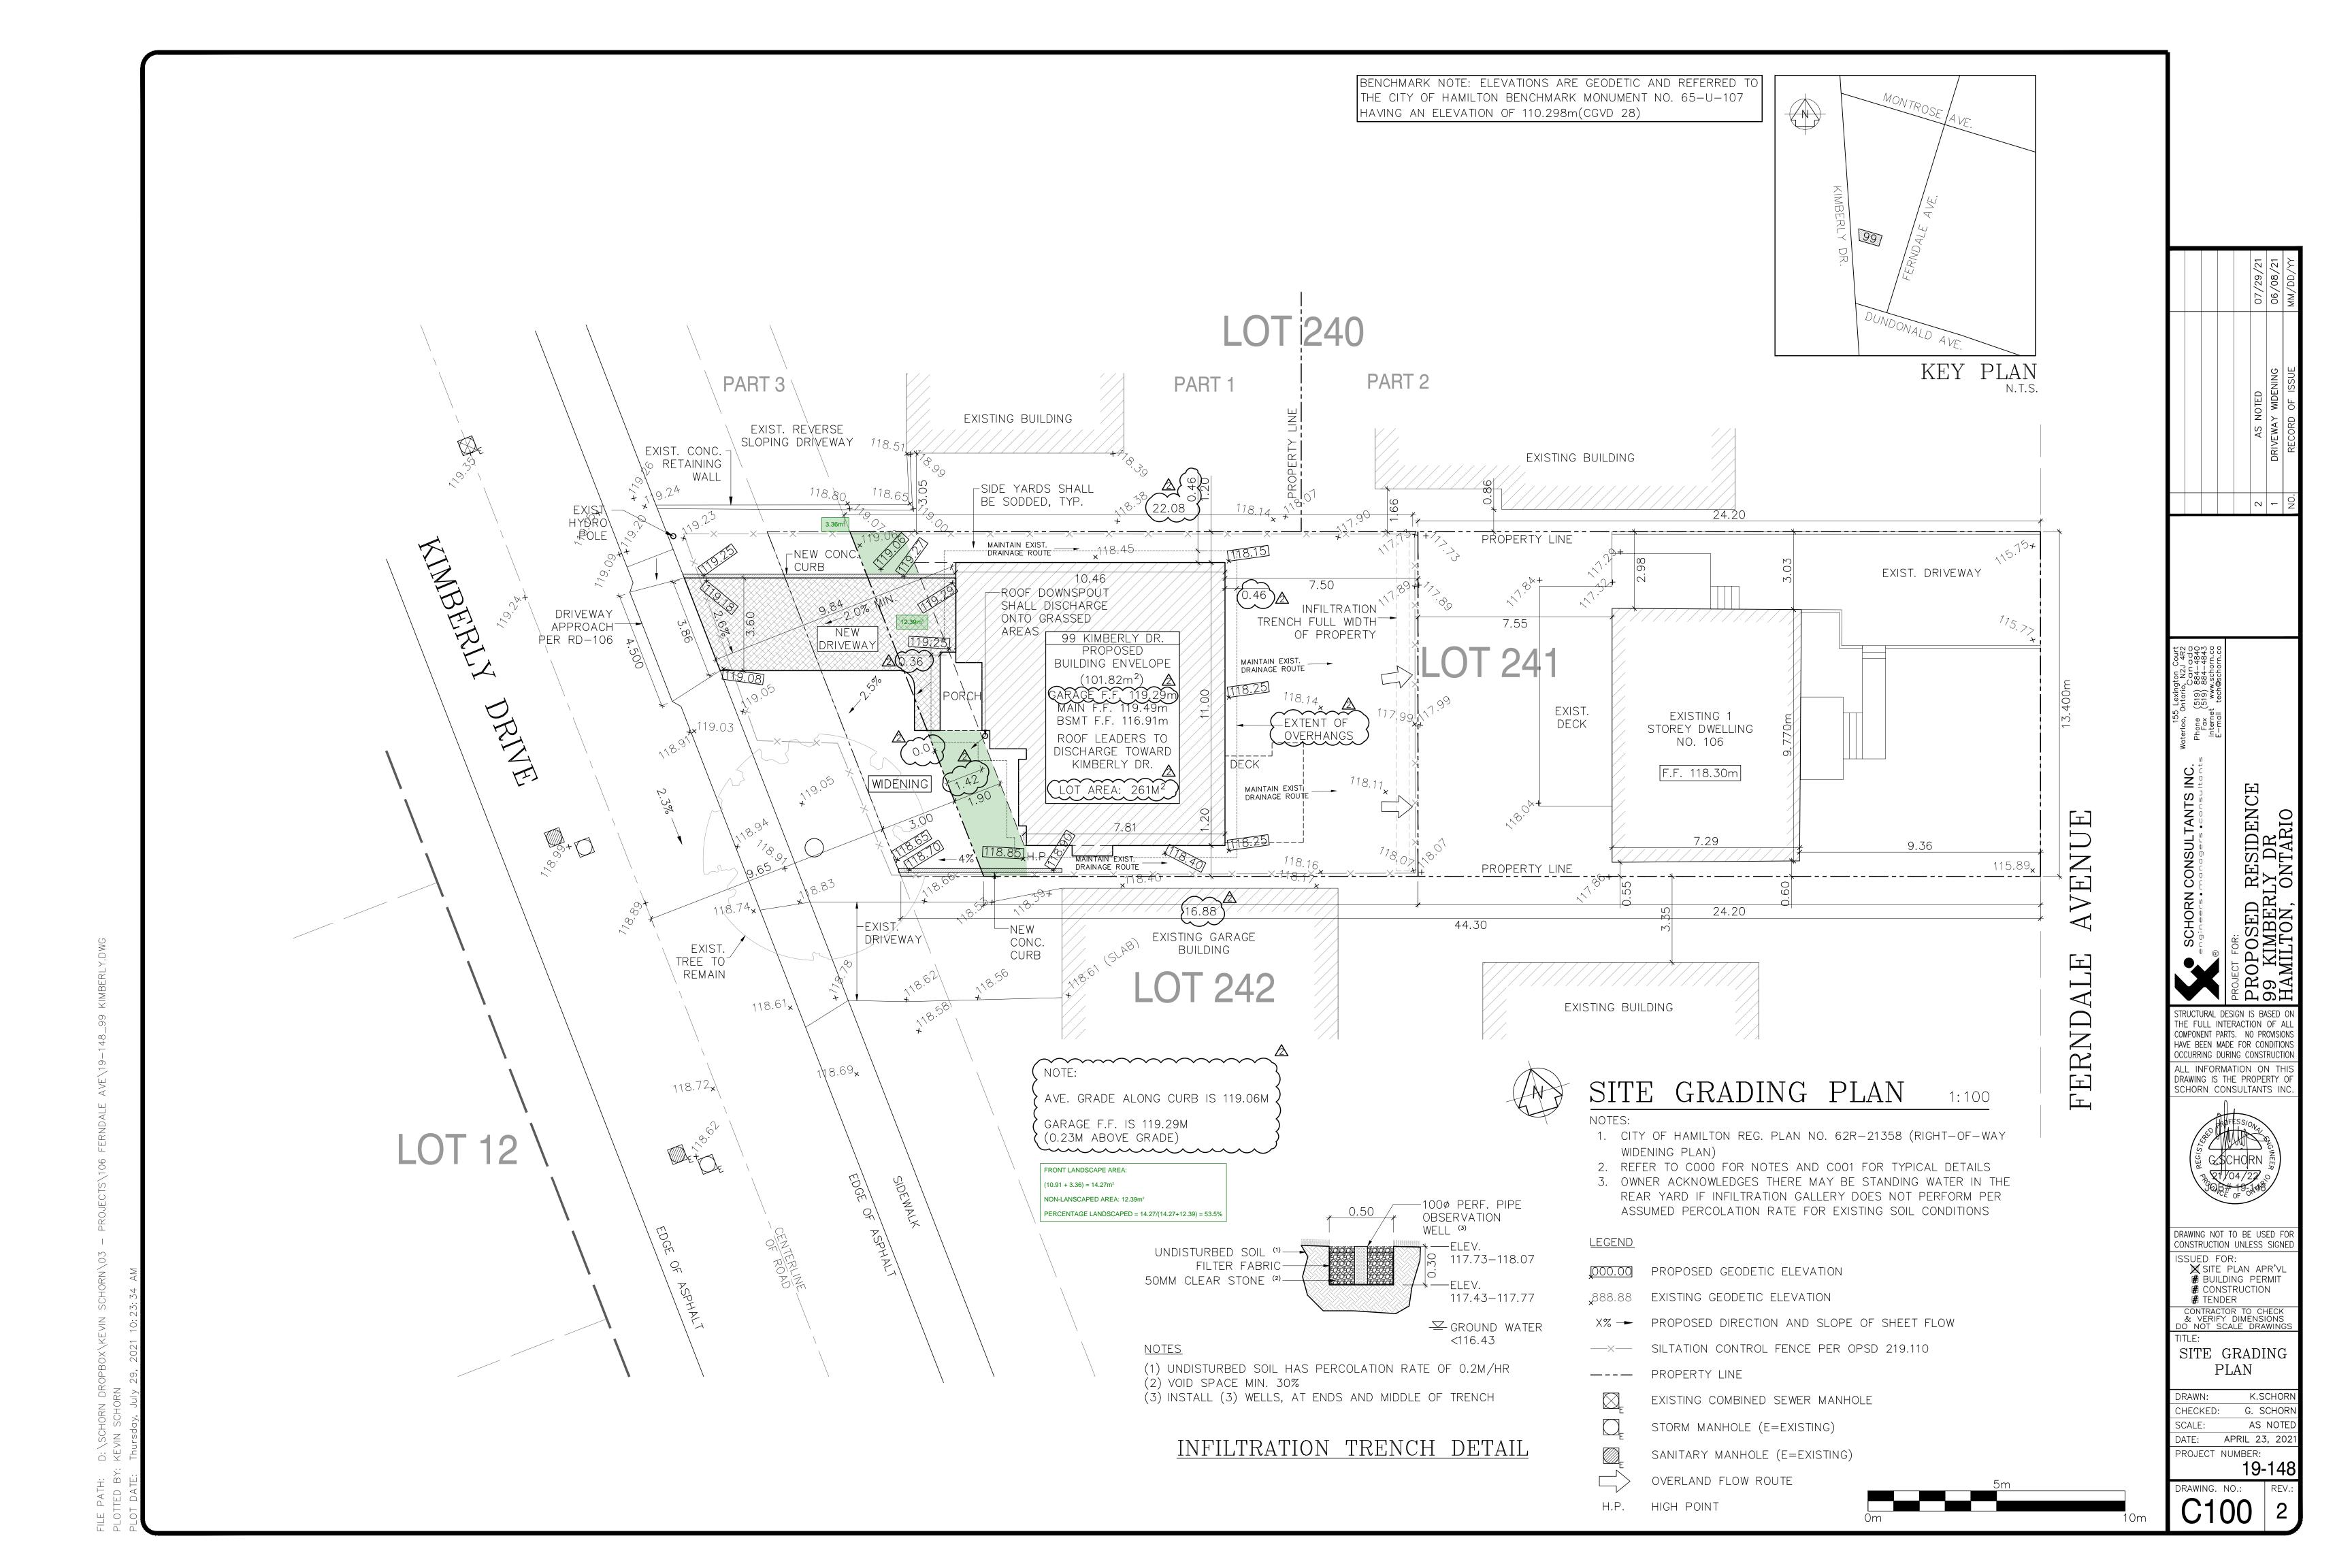
For more information on this matter, including access to drawings illustrating this request:

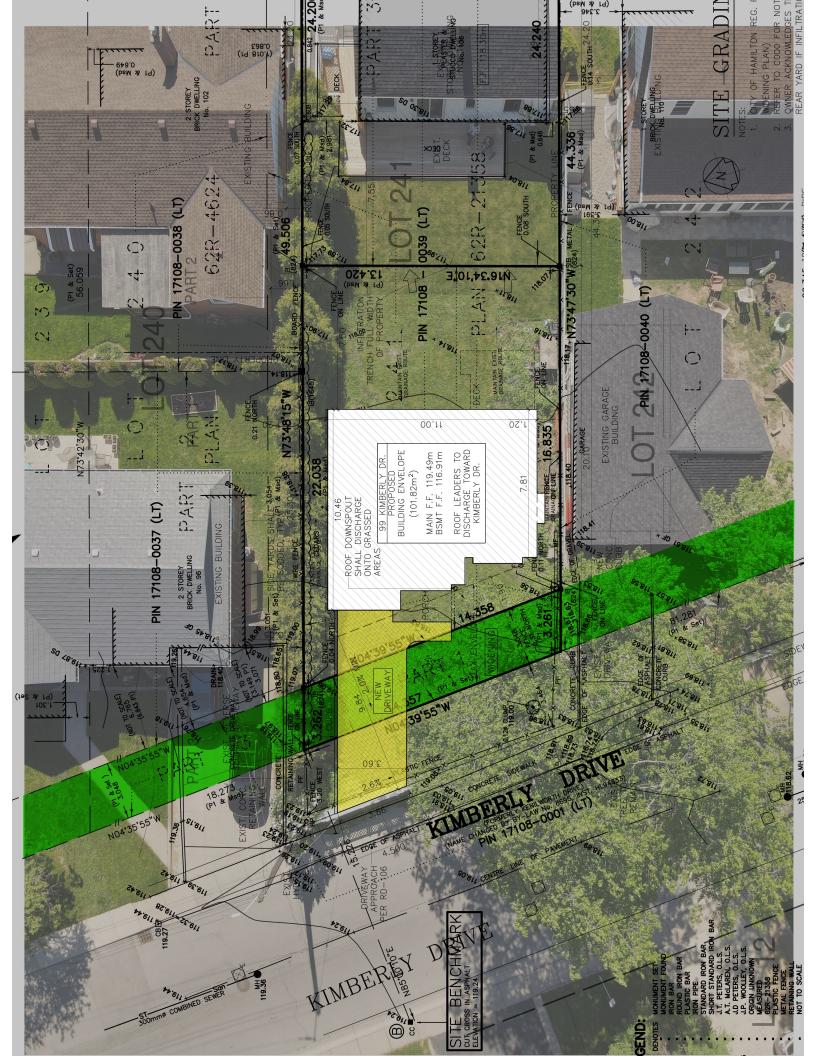
- Visit www.hamilton.ca/committeeofadjustment
- Call 905-546-CITY (2489) or 905-546-2424 extension 4221, 4130, or 3935
- Email Committee of Adjustment staff at cofa@hamilton.ca

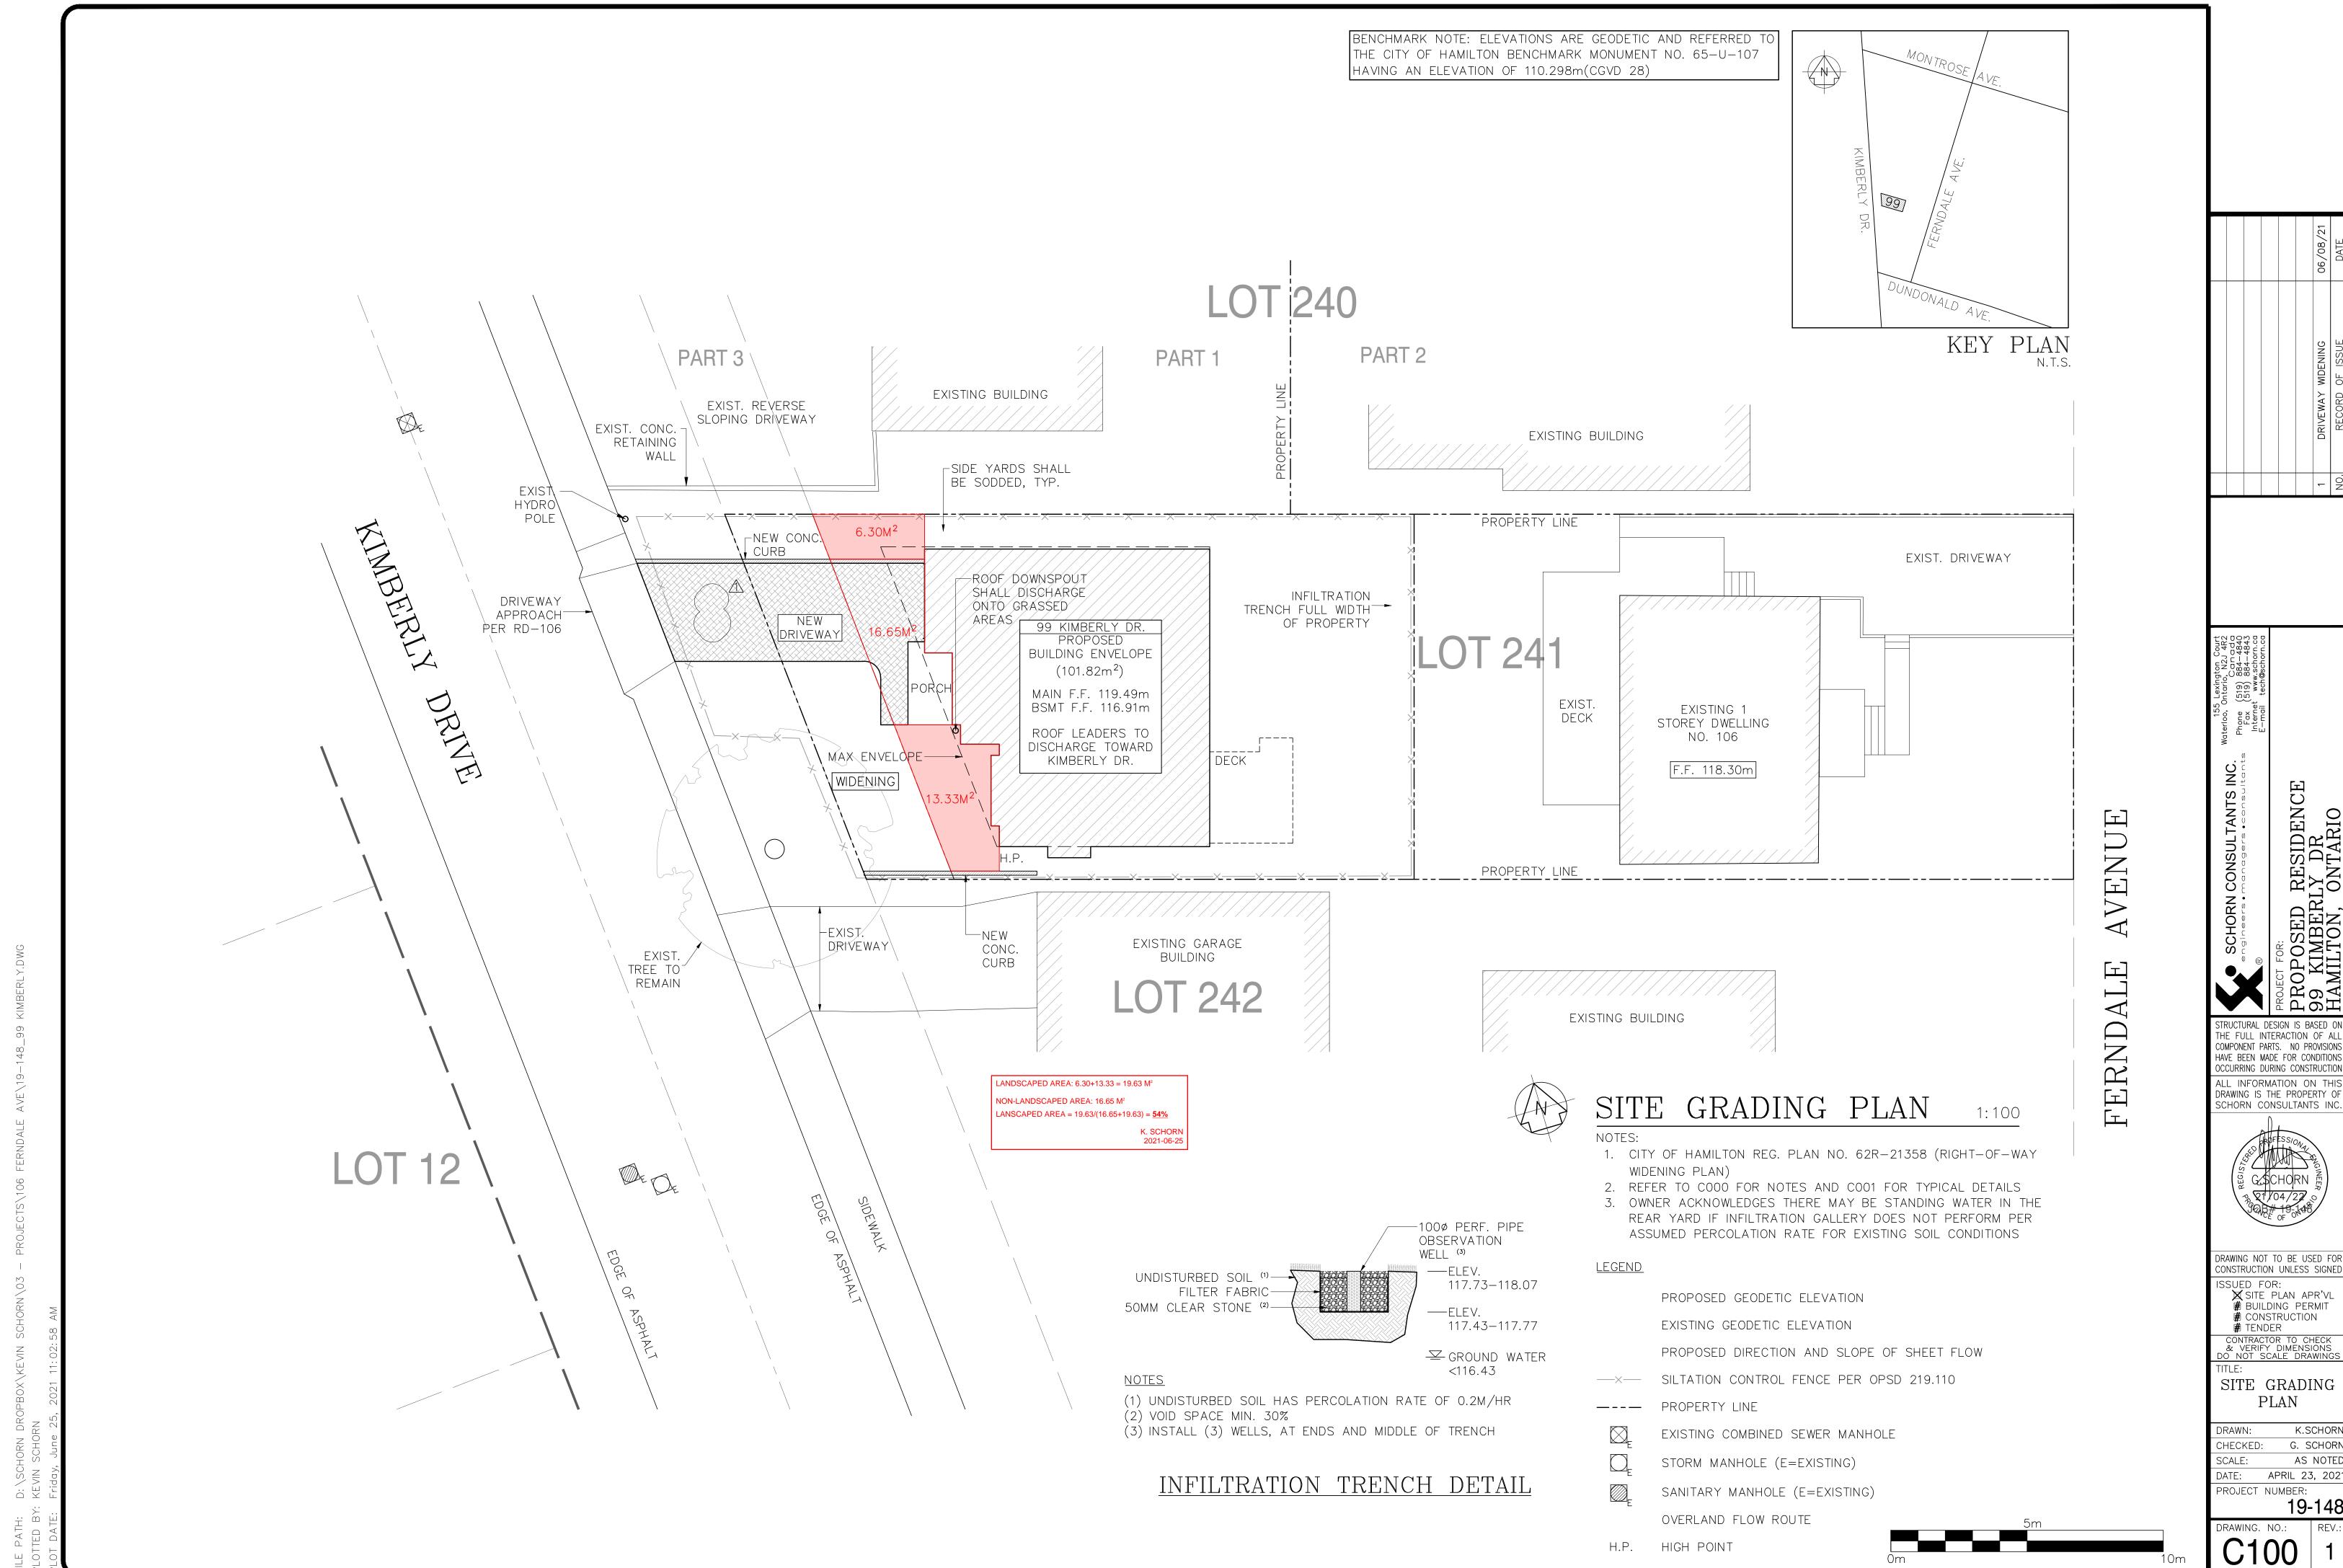
DATED: August 10th, 2021.

Jamila Sheffield,
Secretary-Treasurer
Committee of Adjustment

Information respecting this application is being collected under the authority of the Planning Act, R.S.O., 1990, c. P. 13. All comments and opinions submitted to the City of Hamilton on this matter, including the name, address, and contact information of persons submitting comments and/or opinions, will become part of the public record and will be made available to the Applicant and the general public.









CONSTRUCTION UNLESS SIGNED

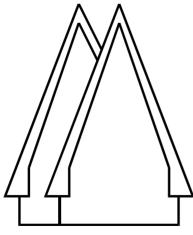
K.SCHOR G. SCHOR AS NOTE APRIL 23, 202

19-148

PROPOSED RESIDENCE 99 KIMBERLY DRIVE HAMILTON, ONTARIO

LIST OF DRAWINGS:

- A0.01 COVER SHEET
- A1.01 BASEMENT FLOOR PLAN
- A1.02 GROUND FLOOR PLAN
- A1.03 UPPER FLOOR PLAN
- A4.01 SECTION THROUGH
- A2.01 FRONT ELEVATION
- A2.02 REAR ELEVATION
- A2.03 RIGHT SIDE ELEVATION
- A2.04 LEFT SIDE ELEVATION



established 1983

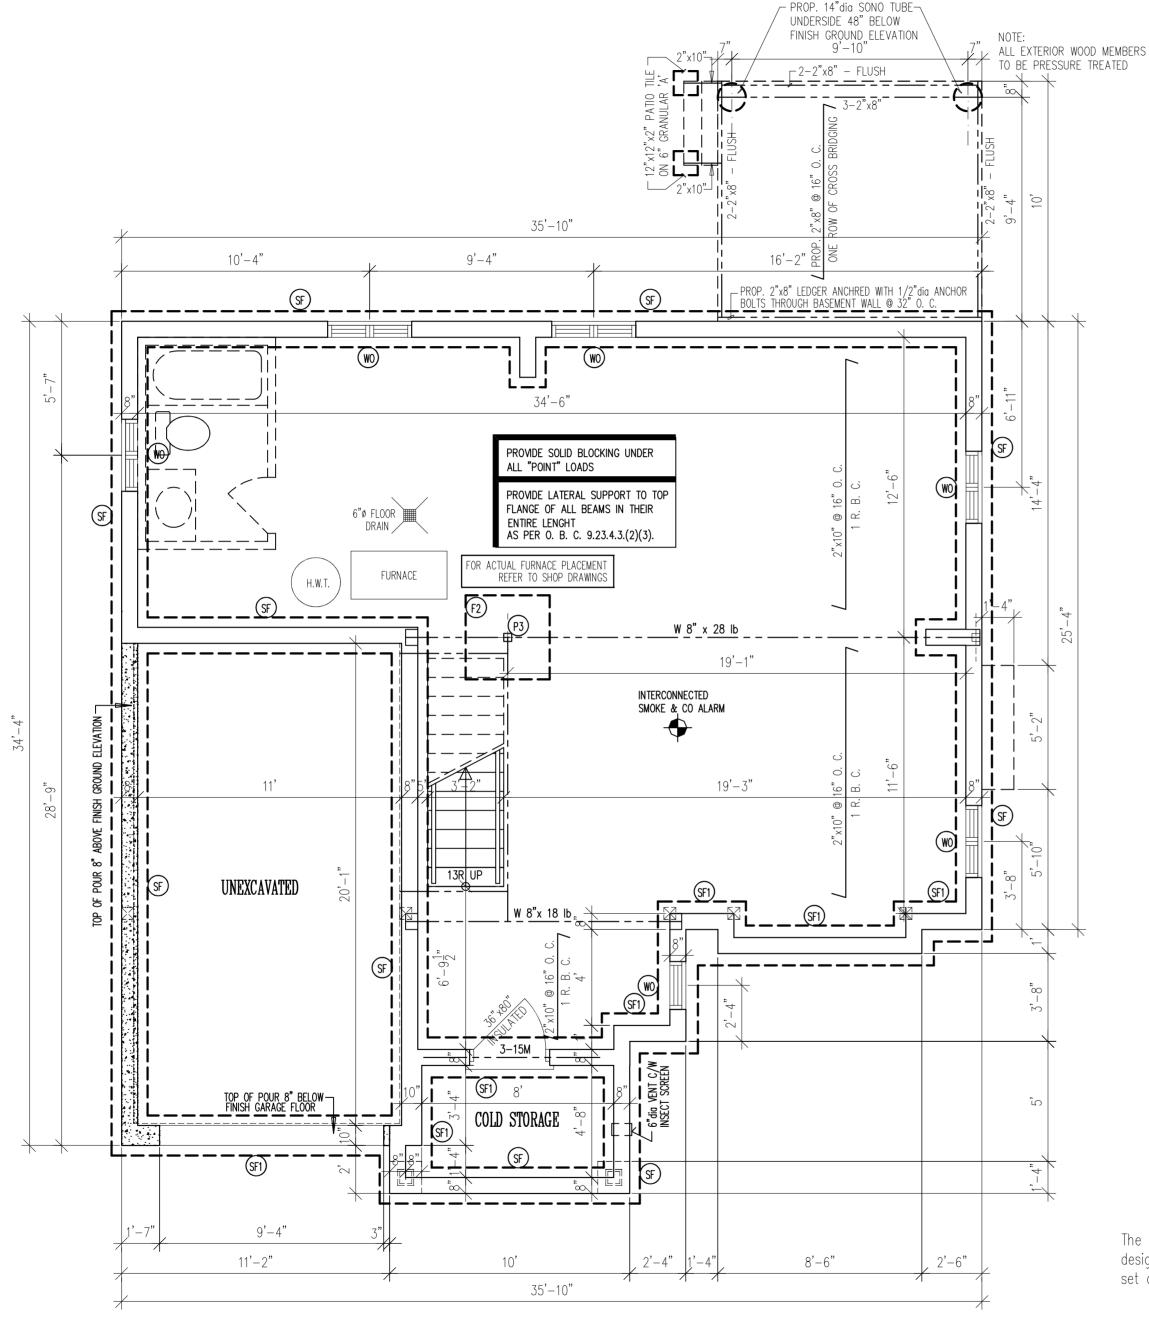
SAGITTARIUS

design & drafting 99 HANOVER PLACE HAMILTON, ONTARIO

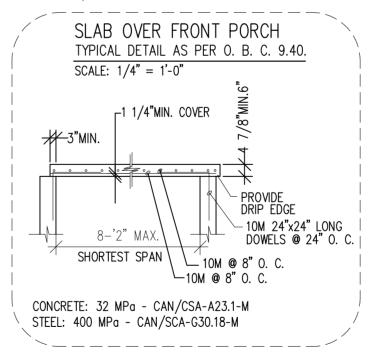
L8K - 5X7

Phone: (905) 973-9839

e-mail: sagit1129@rogers.com



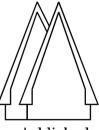
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REGISTRATION INFORMATION

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MILOS TRKULJA SAGITTARIUS DESIGNS BCIN: **24457** BCIN: **30427**



SAGITTARIUS

design & drafting 99 HANOVER PLACE HAMILTON, ONTARIO L8K - 5X7 Phone: (905) 973-9839

1983

established FAX: (905) 538-0587 e-mail: sagit1129@rogers.com

NOTE: PROVIDE MIN. 4'-0" FROST PROTECTION

STEP FOOTING AS PER SEC. 9.15.3.9 AND AS PER "LOT GRADING PLAN"

STEP TOP OF EXTERIOR FOUNDATION WALLS AS PER "LOT GRADING PLAN" MAXIMUM BACKFILL = 7'-7" MEASURED FROM FINISH BASEMENT FLOOR

ALL FOOTINGS TO BEAR ON NATIVE SOIL.

ASSUMED SOIL BEARING CAPACITY: 3000 lb/sq.ft. TO BE VERIFIED BY GEOTECHNICAL ENGINEER

ALL FOUNDING SURFACES SHALL BE INSPECTED BY GEOTECHNICAL ENGINEER PRIOR TO POURING CONCRETE ALL CONCRETE SHALL HAVE A MINIMUM COMPRESSIVE STRENGHT OF 25 MPa

75 MM MINIMUM CONCRETE COVER ON REINFORCING STEEL FOR FOUNDATIONS.

- P3 HSS-4"x4"x0.25" C/W 6"x4"x0.375 TOP PLATE & 8"x4"x0.375" BOTTOM PLATE ANCHORED INTO FOUNDATION WALL WITH 2 0.5"dia "HILTI" BOLTS
- (F2) 42"x42"x20" FOOTING PAD
- (SF1) 20"x8" STRIP FOOTING REINFORCED WITH 3-15M CONTINUOUS
- (SF) 18"x8" STRIP FOOTING REINFORCED WITH 3-15M CONTINUOUS
- WO EACH SIDE OF WINDOW TO BE REINFORCED WITH 3-15M VERTICALLY C/W DOWELS & 15M @ 12" O. C. BELOW WINDOWS EXTENDING 36" BEYOND EACH SIDE OF THE OPENING

PROPOSED RESIDENCE 99 KIMBERLY DRIVE HAMILTON, ONTARIO

BASEMENT FLOOR PLAN

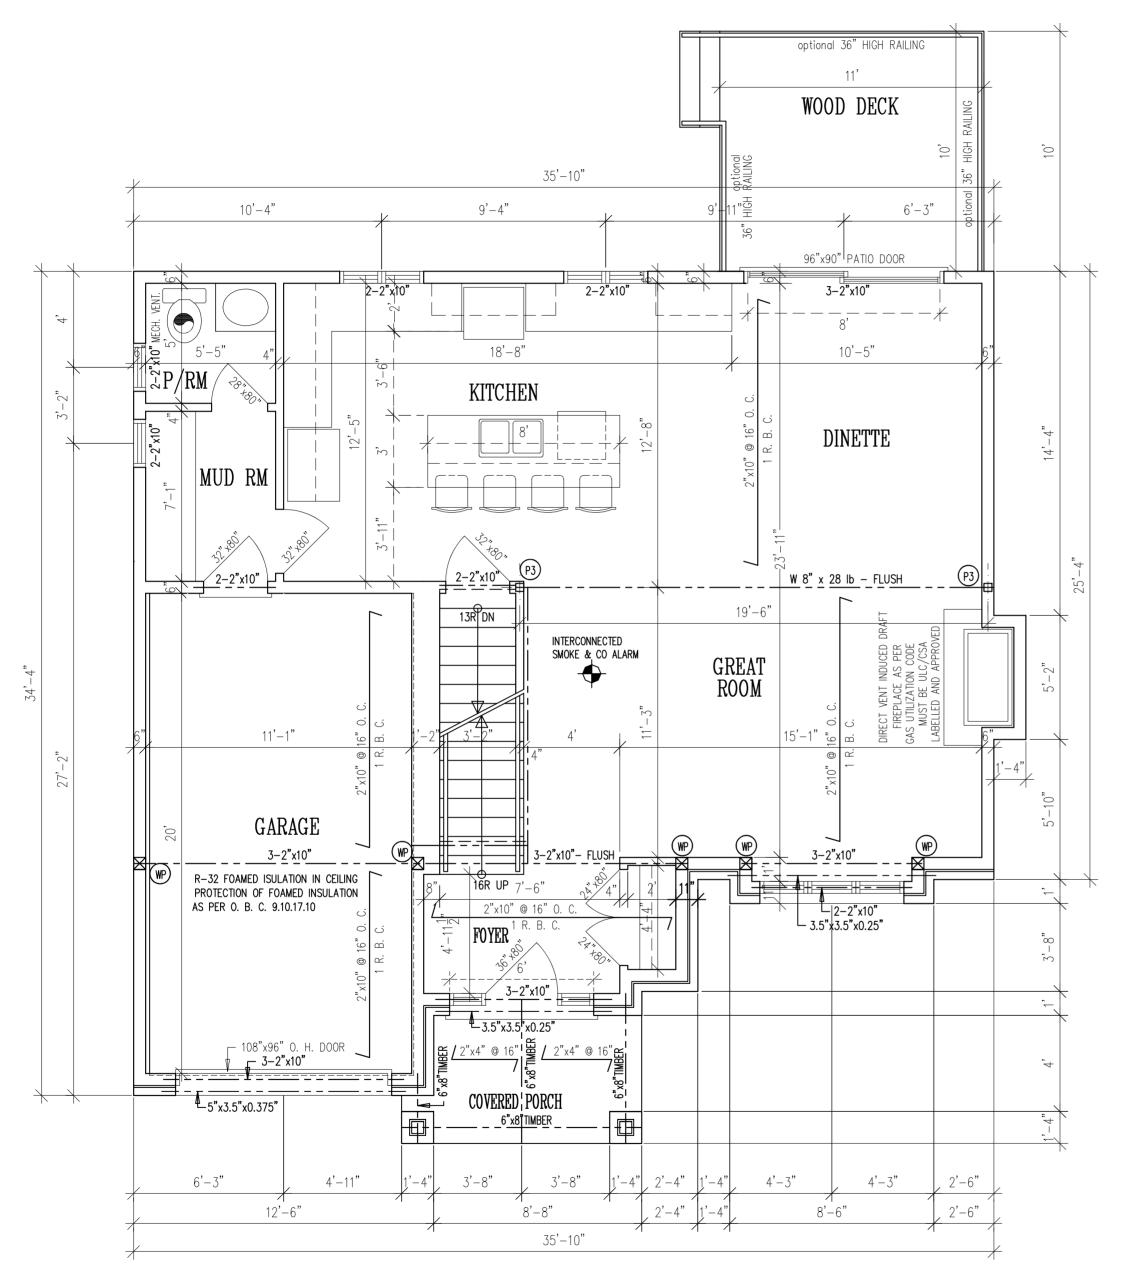
DATE:	APRIL 12, 2021
SCALE:	1/4"=1'-0"
DWG BY:	M.T.
FILE:	2101

DWG No.

A1.01

TO PERFORM ACTUAL CONSTRUCTION THE BUILDER SHALL USE SET OF DRAWINGS SEALED - THEREFORE APPROVED - BY THE LOCAL BUILDING DEPARTMENT

Signature: ___



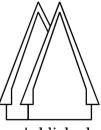
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BCIN: **24457** BCIN: **30427**



SAGITTARIUS

design & drafting 99 HANOVER PLACE HAMILTON, ONTARIO L8K - 5X7

Phone: (905) 973-9839 established FAX: (905) 538-0587 e-mail: sagit1129@rogers.com

- WP) 6"x6" WOOD POST
- P2 HSS-3"x3"x0.25" C/W 6"x6"x0.375 TOP PLATE & 8"x8"x0.375" BOTTOM PLATE ANCHORED INTO FOUNDATION WALL WITH 4-0.5" dig "HILTI" BOLTS C/W CLADDING AS PER BUILDER'S SELECTION
- P3 HSS-4"x4"x0.25" C/W 5.5"x5.5"x0.375 TOP PLATE & 8"x6"x0.375" BOTTOM PLATE ANCHORED INTO FOUNDATION WALL WITH 4-0.5"dia "HILTI" BOLTS

PROPOSED RESIDENCE 99 KIMBERLY DRIVE HAMILTON, ONTARIO

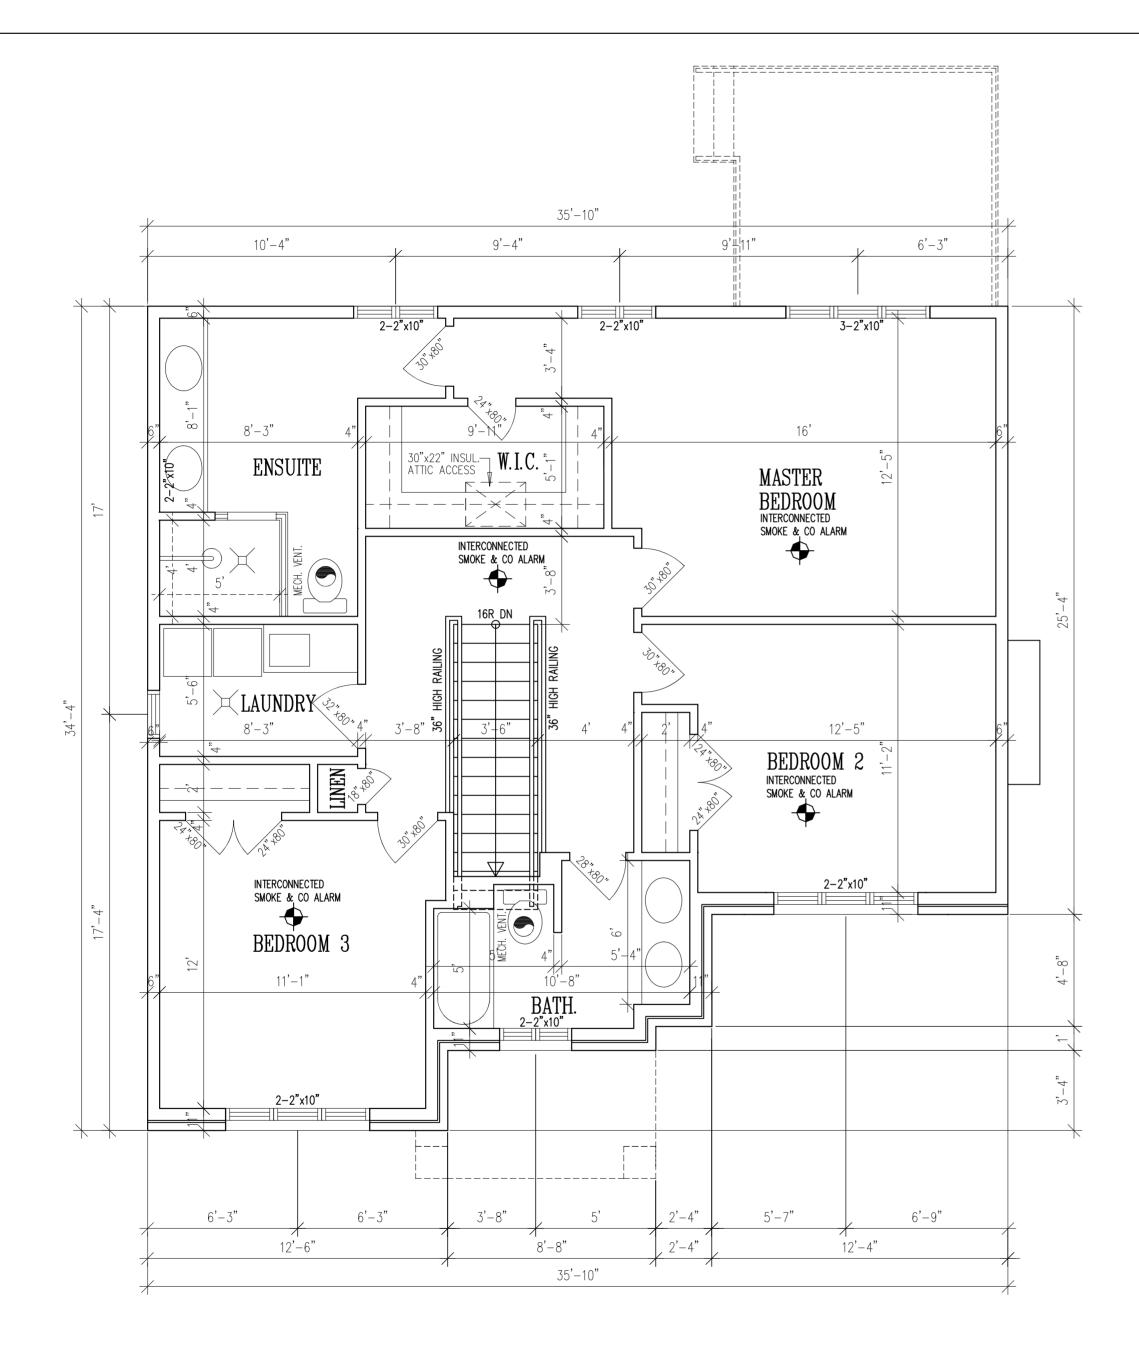
GROUND FLOOR PLAN 843.4 sq.ft.

DATE:	APRIL 12, 2021
SCALE:	1/4"=1'-0"
DWG BY:	M.T.
FILE:	2101
	DWG No.

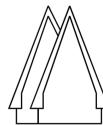
A1.02

Signature: ___

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SAGITTARIUS

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established FAX: (905) 538-0587 e-mail: sagit1129@rogers.com

PROPOSED RESIDENCE 99 KIMBERLY DRIVE HAMILTON, ONTARIO

UPPER FLOOR PLAN 1080.3 sq.ft.

DATE:	APRIL 12, 2021
SCALE:	1/4"=1'-0"
DWG BY:	M.T.
FILE:	2101
	DWG No.

A1.03

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Signature: ___



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PROPOSED RESIDENCE 99 KIMBERLY DRIVE HAMILTON, ONTARIO

FRONT ELEVATION

DATE:	APRIL 12, 2021
SCALE:	1/4"=1'-0"
DWG BY:	M.T.
FILE:	2101
	DWG No.

A2.01

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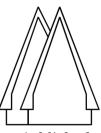
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PROPOSED RESIDENCE 99 KIMBERLY DRIVE HAMILTON, ONTARIO

REAR ELEVATION

DATE:	APRIL 12, 2021
SCALE:	1/4"=1'-0"
DWG BY:	M.T.
FILE:	2101
	DWG No.

A2.02

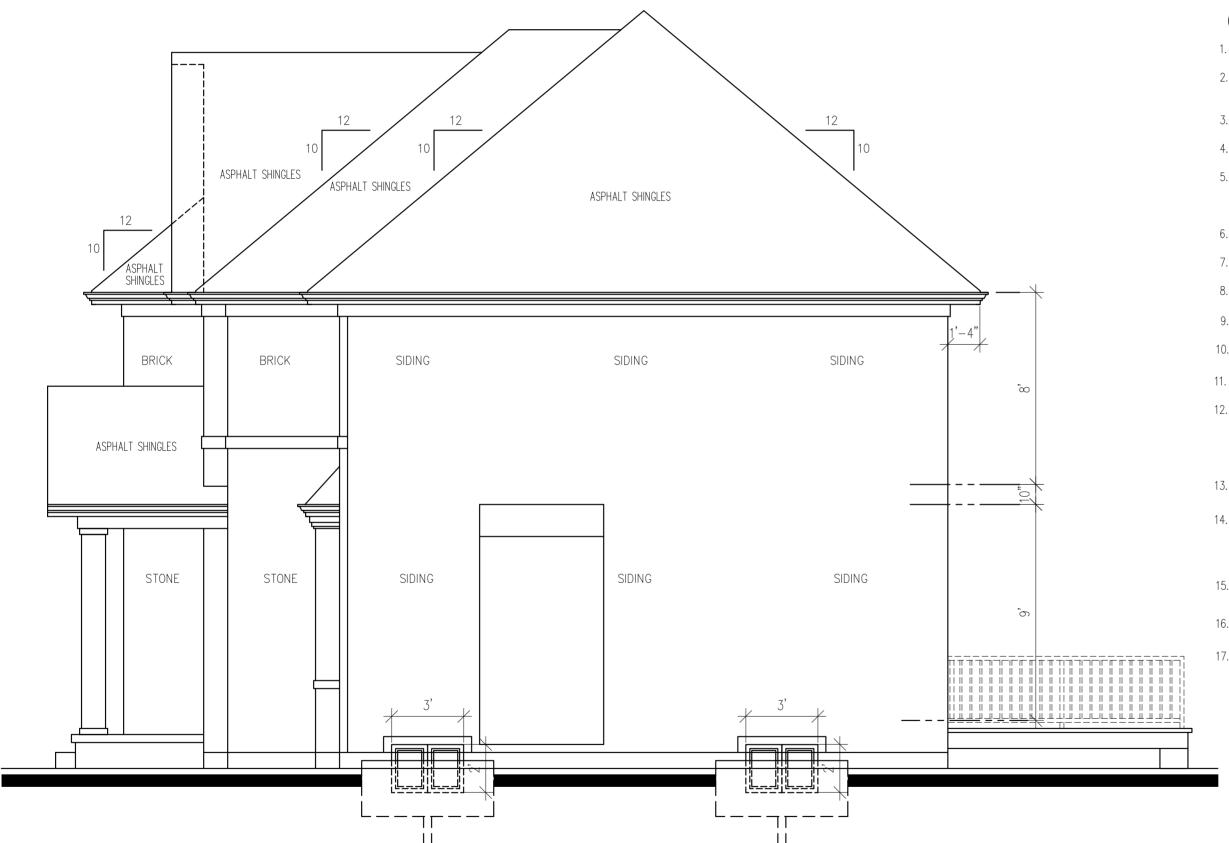
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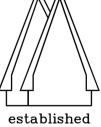
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- 13. THERMAL DESIGN & INSULATION AS PER SECTIONS SB-12, TABLE 3.1.1.2A PACKAGE A1
- 14. STAIRS, RAMPS, HANDRAILS & GUARDS AS PER SECTION 9.8. OF THE O. B. C. ATTACHMENT OF HANDRAILS AS PER SUPPLEMENTARY STANDARDS TO THE O. B. C. SB-7
- 15. ALL WORKS SHALL BE PERFORMED BY QUALIFIED AND LICENCED CONTRACTORS
- 16. ALL CONCRETE MATERIALS AND WORKMANSHIP TO SCA A23.1, 2 & 3.
- 17. THERMAL RESISTANCE OF WINDOWS AND DOORS AS PER SB-12, TABLE 3.1.1.2A PACKAGE A1



SAGITTARIUS

design & drafting 99 HANOVER PLACE HAMILTON, ONTARIO L8K - 5X7 Phone: (905) 973-9839

established FAX: (905) 538-0587 e-mail: sagit1129@rogers.com

PROPOSED RESIDENCE 99 KIMBERLY DRIVE HAMILTON, ONTARIO

RIGHT SIDE ELEVATION

DATE:	APRIL 12, 2021
SCALE:	1/4"=1'-0"
DWG BY:	M.T.
FILE:	2101
	DWG No.

A2.03

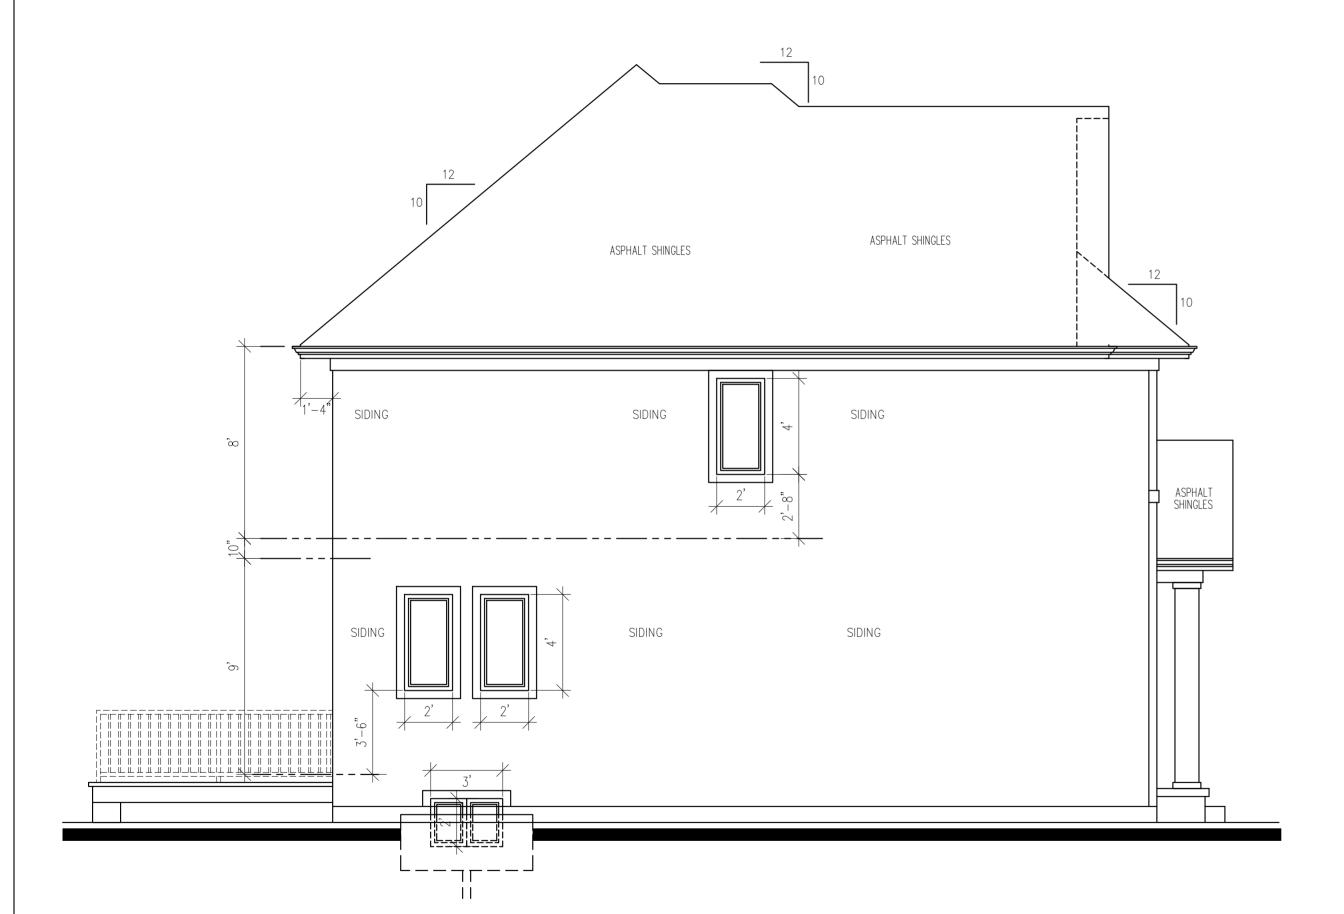
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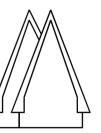
MILOS TRKULJA SAGITTARIUS DESIGNS

BCIN: **24457** BCIN: **30427**

TO PERFORM ACTUAL CONSTRUCTION THE BUILDER SHALL USE SET OF DRAWINGS SEALED - THEREFORE APPROVED - BY THE LOCAL BUILDING DEPARTMENT



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- 2. DO NOT SCALE DRAWINGS. CONTRACTOR SHALL VERIFY ALL DIMENSIONS PRIOR TO COMMENCING CONSTRUCTION.
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- 4. INSTALL DOUBLE JOISTS UNDER ALL PARALLEL PARTITIONS.
- 5. ALL CONSTRUCTION BETWEEN GARAGE AND DWELLING UNIT SHALL PROVIDE AN EFFECTIVE BARRIER FROM GAS AND EXHAUST. DOOR TO HAVE WEATHER STRIP'G AND SELF CLOSER.
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PROPOSED RESIDENCE 99 KIMBERLY DRIVE HAMILTON, ONTARIO

LEFT SIDE ELEVATION

DATE:	APRIL 12, 2021
SCALE:	1/4"=1'-0"
DWG BY:	M.T.
FILE:	2101
	DWG No.

A2.04

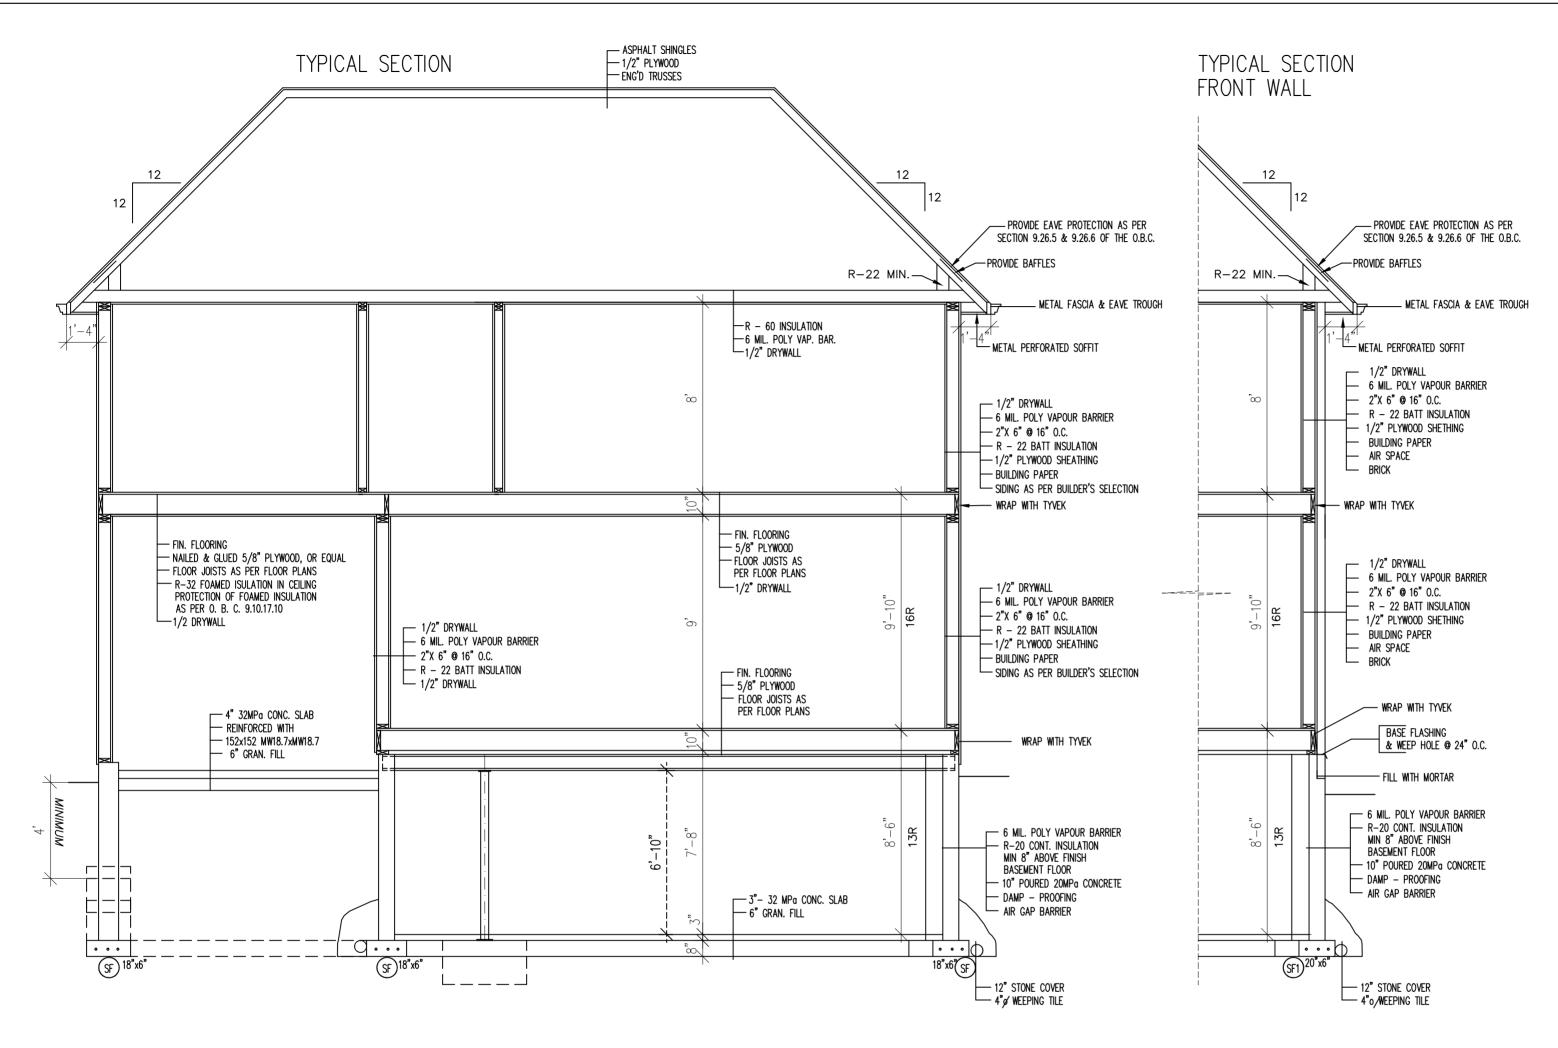
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PROPOSED RESIDENCE 99 KIMBERLY DRIVE HAMILTON, ONTARIO

SECTION THROUGH

DATE:	APRIL 12, 2021
SCALE:	1/4"=1'-0"
DWG BY:	M.T.
FILE:	2101

DWG No.

A4.01

Signature: _____ NO

Committee of Adjustment



City Hall, 5th Floor, 71 Main St. W., Hamilton, ON L8P4Y5

Hawere printing and require 1.9m manoeuvering space instead of 6m.

Email: cofa@hamilton.ca

APPLICATION FOR A MINOR VARIANCE

FOR OFFICE USE ONLY.
APPLICATION NO DATE APPLICATION RECEIVED
PAID DATE APPLICATION DEEMED COMPLETE
SECRETARY'S SIGNATURE

The Planning Act

Application for Minor Variance or for Permission

The undersigned hereby applies to the Committee of Adjustment for the City of Hamilton under Section 45 of the *Planning Act*, R.S.O. 1990, Chapter P.13 for relief, as described in this application, from the Zoning By-law.

1, 2	NAME	MAILING ADDRESS	
Registered Owners(s)	Chris Donaldson		
Applicant(s)*	Chris Donaldson		
Agent or Solicitor	n/a		Phone:
			E-mail:

Note: Unless otherwise requested all communications will be sent to the agent, if any.

3. Names and addresses of any mortgagees, holders of charges or other encumbrances:

n/a

Additional sheets can be submitted if there is not sufficient room to answer the following questions. Additional sheets must be clearly labelled

4.	Nature and extent of relief applied for: Require a minor variance to permit one parking space instead of two for a single family dwelling and require 1.9m manoeuvering space instead of 6m. Variance will ensure street uniformity by matching the setbacks of existing dwellings.
	Secondary Dwelling Unit Reconstruction of Existing Dwelling
5.	Why it is not possible to comply with the provisions of the By-law?
	Infill lot cannot provide 2 parking spaces or meet 6m manoeuvering space due to road widening and reduced setback.
6.	Legal description and Address of subject lands (registered plan number and lot number or other legal description and where applicable, street and street number):
	99 Kimberly Dr. Hamilton PT LT 241, PL 538, PART 2 ON PLAN 62R21358; CITY OF HAMILTON
7.	PREVIOUS USE OF PROPERTY
	Residential
	Agricultural Vacant Other
	Other
8.1	If Industrial or Commercial, specify use $\underline{\hspace{1cm}}^{n/a}$
8.2	Has the grading of the subject land been changed by adding earth or other material, i.e. has filling occurred? Yes No x Unknown
8.3	Has a gas station been located on the subject land or adjacent lands at any time? Yes No Unknown Unknown
8.4	Has there been petroleum or other fuel stored on the subject land or adjacent lands? Yes No X Unknown C
8.5	Are there or have there ever been underground storage tanks or buried waste on the subject land or adjacent lands? Yes No Unknown Unknown
8.6	Have the lands or adjacent lands ever been used as an agricultural operation where cyanide products may have been used as pesticides and/or sewage sludge was applied to the lands?
8.7	Yes No X Unknown A Have the lands or adjacent lands ever been used as a weapon firing range?
0.1	Yes No X Unknown O
8.8	Is the nearest boundary line of the application within 500 metres (1,640 feet) of the fill area of an operational/non-operational landfill or dump? Yes No x Unknown
8.9	If there are existing or previously existing buildings, are there any building materials remaining on site which are potentially hazardous to public health (eg. asbestos, PCB's)?
	Yes No X Unknown O

	uses on the site or a				
	Yes <u> </u>	o <u>(x)</u> U	Jnknown		
8.11	What information did	l vou use to dete	ermine the answers to 8.1 to 8.10 above?		
		-	Ferndale Ave. a residential lot built in the 1950s.		
	Lot is the former of	ackyard to 100 i	remuale Ave. a residential for built in the 1950s.		
8.12			ial or commercial or if YES to any of 8.2 to 8.10, a		
	land adjacent to the		former uses of the subject land, or if appropriate, the needed.		
	Is the previous use i	nventory attach	ed? Yes No x		
9.	ACKNOWLEDGEM				
		mination on the	Iton is not responsible for the identification and property which is the subject of this Application – by ation.	1	
	June 30 2021				
	Date		Signature Property Owner(s)		
			Chris Donaldson		
			Print Name of Owner(s)		
10.	Dimensions of lands	affected:			
	Frontage	14.358m			
	Depth	22.038m (irre	egular)		
	Area	261sqm			
	Width of street	9.28m curb to	o curb, 21m lot to lot		
11.			tures on or proposed for the subject lands: (Specify number of stories, width, length, height, etc.)		
	Existing:	1055 11001 area,	Trumber of Stories, width, length, neight, etc.)		
	none				
	none				
	Proposed				
	2-story single fan	nily dwelling			
	211 y 2 8 1 1	<i>y G</i>			
12.	Logation of all buildi	and atministration	ess an ar prepared for the cubicat lands. (Specify		
12.	distance from side, r		res on or proposed for the subject lands; (Specify t lines)		
	Existing:				
	none				
	Proposed:				
	1.9m from front				
	1.9m from front 1.2m from side				
	7.5m from back				

8.10 Is there any reason to believe the subject land may have been contaminated by former

Date of construction of all buildings and structures on subject lands:
Existing uses of the subject property (single family, duplex, retail, factory etc.): Empty residential infill lot
Existing uses of abutting properties (single family, duplex, retail, factory etc.): Single family dwellings
Length of time the existing uses of the subject property have continued: Lot severed on Nov 27, 2020
Municipal services available: (check the appropriate space or spaces)
Water
Sanitary Sewer x Connected along with building permit
Present Official Plan/Secondary Plan provisions applying to the land: Plans attached
Present Restricted Area By-law (Zoning By-law) provisions applying to the land: $\ensuremath{n/a}$
Has the owner previously applied for relief in respect of the subject property? Yes No No No No No No No N
If the answer is yes, describe briefly.
Minor variance for reduced setback to 1.9m due to road widening.
Is the subject property the subject of a current application for consent under Section 53 of the <i>Planning Act</i> ?
Yes No X
Additional Information
n/a
The applicant shall attach to each copy of this application a plan showing the dimensions of the subject lands and of all abutting lands and showing the location, size and type of all buildings and structures on the subject and abutting lands, and where required by the Committee of Adjustment such plan shall be signed by an Ontario Land Surveyor.