COMMITTEE OF ADJUSTMENT



City Hall, 5th floor, 71 Main Street West, Hamilton, ON L8P 4Y5 Telephone (905) 546-2424, ext. 4221, 3935 Fax (905) 546-4202

E-mail: cofa@hamilton.ca

NOTICE OF PUBLIC HEARING Minor Variance

You are receiving this notice because you are either:

- Assessed owner of a property located within 60 metres of the subject property
- Applicant/agent on file, or
- Person likely to be interested in this application

APPLICATION NO.: HM/A-21:310

APPLICANTS: Agent Shane Van Barneveld

Owner Stephen Edwards & Caitlin Chevreau

SUBJECT PROPERTY: Municipal address 65 Magill St., Hamilton

ZONING BY-LAW: Zoning By-law 6593, as Amended

ZONING: D/S-1787district (Urban Protected Residential - One and Two

Family Dwellings)

PROPOSAL: To permit a two (2) storey addition within the rear yard and a 34

square metre terrace (deck) within the rear and side yards for an

existing street townhouse, notwithstanding that:

- 1. The northerly side yard shall be 0.7m instead of 2.5m for a street townhouse dwelling not exceeding 3 storeys in height;
- 2. The eaves and gutter may project a maximum of 0.46m into the northerly side yard instead of the maximum projection of 0.35m or one-half of the side yard width;
- 3. A terrace (deck) may project entirely into the required southerly side yard and distant 0m from the southerly side lot line instead of the requirement to be not closer than 0.5m from the southerly side lot line;
- 4. An open stairway consisting of one step and landing may project 0.64m into the northerly side yard instead of the required maximum projection of one-third of the side yard width or 0.42m;
- 5. No parking spaces shall be required instead of 1 parking space for a street townhouse dwelling;

NOTES:

1. The property is developed with a legally established non-conforming street townhouse.

This application will be heard by the Committee as shown below:

DATE: Thursday, September 23rd, 2021

TIME: 1:50 p.m.

PLACE: Via video link or call in (see attached sheet for details)

To be streamed at

www.hamilton.ca/committeeofadjustment

for viewing purposes only

HM/A-21: 310

Page 2

PUBLIC INPUT

Written: If you would like to submit written comments to the Committee of Adjustment you may do so via email or hardcopy. Please see attached page for complete instructions, including deadlines for submitting to be seen by the Committee.

Orally: If you would like to speak to this item at the hearing you may do so via video link or by calling in. Please see attached page for complete instructions, including deadlines for registering to participate.

MORE INFORMATION


For more information on this matter, including access to drawings illustrating this request:

- Visit www.hamilton.ca/committeeofadjustment
- Call 905-546-CITY (2489) or 905-546-2424 extension 4221, 4130, or 3935
- Email Committee of Adjustment staff at cofa@hamilton.ca


DATED: September 7th, 2021.

Jamila Sheffield, Secretary-Treasurer Committee of Adjustment

Information respecting this application is being collected under the authority of the Planning Act, R.S.O., 1990, c. P. 13. All comments and opinions submitted to the City of Hamilton on this matter, including the name, address, and contact information of persons submitting comments and/or opinions, will become part of the public record and will be made available to the Applicant and the general public.

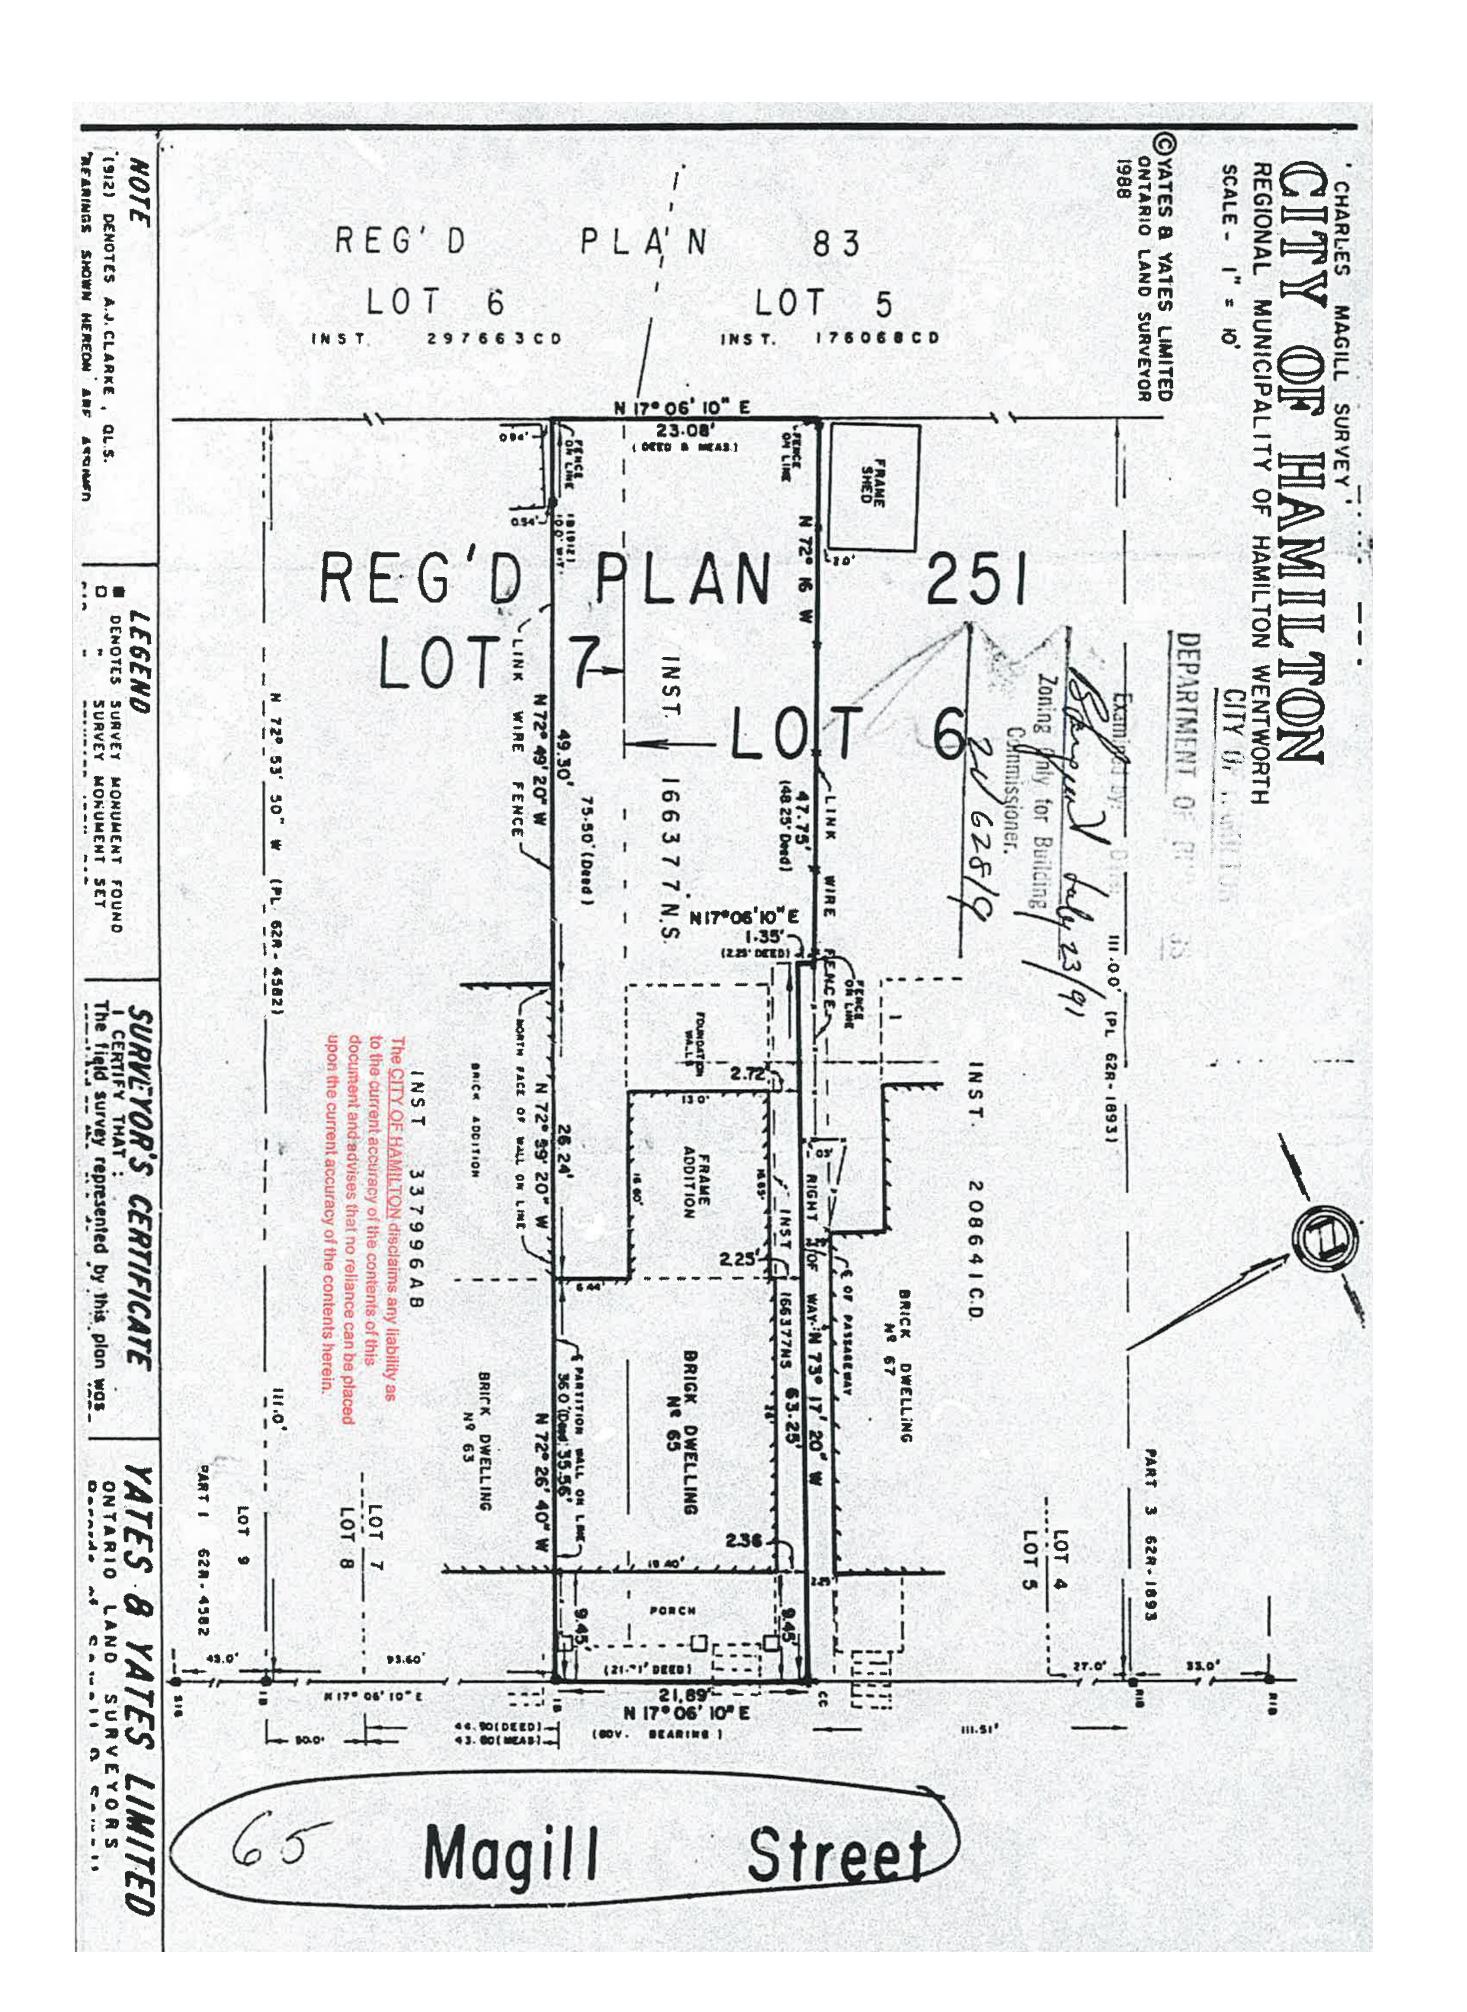



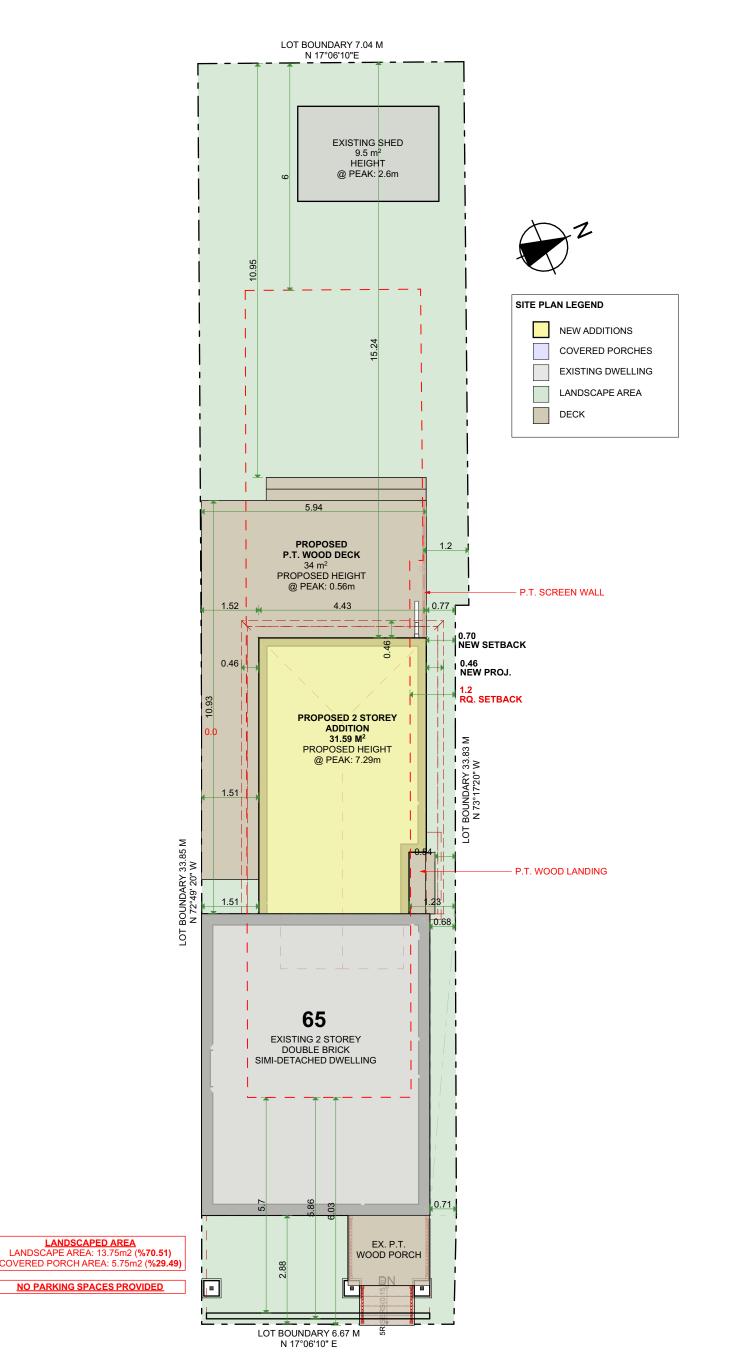

LOT FRONTAGE: AS EX. LOT COVERAGE (%)1: FLOOR AREA RATIO2: GROSS FLOOR AREA4: GROUND FLOOR AREA: BUILDING HEIGHT (m): PARKING SPACES3: Habitable Rooms: SETBACKS (m) 2.88 17.54 0.68 AS EX. 15.24 EAST (RIGHT) SIDE: 1.20 0.68 WEST (LEFT) SIDE: 1.20 ENCROACHMENTS (m) ROOF PROJECTION: COVERED PORCH: AS EX. UNCOVERED PORCH: N/A 9.50 AS EX. 2.6 m 2.6 m AS EX. OTHER RETRICTIONS: CONSERVATION AUTHORITY NIAGARA ESCARPEMENT CONTROL MTO SEPTIC SITE PLAN CONTROL TREE PROTECTION

¹ Proposed lot coverage calculations = Proposed Footprint area / Lot Area

SITE INFORMATION Zoning Information taken on: 2021.08.04

AS EX.

AS EX.

34.00

ADDRESS: 65 MAGILL ST MUNICIPALITY: HAMILTON POSTAL CODE: L8R 2Y4

BYLAW EXCEPTION #: N/A MINOR VARIANCE #: TBD

ZONE: D

ZONING INFORMATION PARENT BYLAW #: 6593 FORMER HAMILTON

² Floor Area Ratio Calculation:Total GFA / Lot Area ³ Parking space sizing as follows: Hamilton: 2.7m x 6.0m Burlington: 2.7m x 6.0m ⁴ Area of all floors excluding the following:

REFERENCES

 1. 100sf for laundry if possible
 2. 70sf for mechanical if possible Attic spaces
 Any area that is uninhabitable

> CONTRACTOR 790 SHAVER RD. ANCASTER L9G 3K9 ON

NO.	REVISION	DATE
1	DESIGN 1.0	2021.04.23
2	DESIGN 2.0	2021.04.27
3	DESIGN 2.1	2021.05.14
4	DESIGN 3.0	2021.06.29
5	ISSUED FOR MINOR VARIANCE	2021.08.04

SITE PLAN

DRAWING:

PROJECT NAME:

EDWARDS

PROJECT ADDRESS:

65 MAGILL ST HAMILTON ON L8R 2Y4

DATE: 8/4/2021 DRAWING NO: AS NOTED SP0.01

PROJECT NO:

SITE PLAN
SCALE: 1:100

MAGILL ST.

ALL CONSTRUCTION TO COMPLY WITH ONTARIO BUILDING CODE DESIGN AND LAYOUT OF ALL PRE ENGINEERED STRUCTURAL MEMBERS FROM ROOF TRUSS SUPPLIER TO BE SUPPLIED BY MANUFACTURER PRIOR TO CONSTRUCTION SOLID BLOCKING TO BEARING BELOW TO BE PROVIDED AT ALL GIRDER TRUSS AND BEAKING BELOW 10 BE PROVIDED AT ALL GIRDER TRUSS AND BEAM LOCATIONS (MIN. WIDTH EQUAL TO WIDTH OF BEARING POINT OVER) VERIFY WITH TRUSS TRUSS MEMBERS SHALL NEVER BE NOTCHED, DRILLED OR CUT UNLESS NOTCHING OR DRILLING HAS BEEN ACCOUNTED FORIN THE DESIGN OF THE TRUSS WHEN RENOVATING. INSULATION TO BE EQUAL TO OR GREATER THAN EXISTING BEAM BEARING = MIN. 3-1/2" LINTEL BEARING = MIN. 1-1/2" RAFTER BEARING = MIN. 1-1/2" JOISTS BEARING = MIN. 1-1/2"

CONTRACTOR TO CHECK AND VERIFY ALL SPECIFICATIONS AND DIMENSIONS PRIOR TO AND DURING CONSTRUCTION. ALL
DISCREPENCIES TO BE REPORTED TO DESIGNER (519) 339-1493 PROVIDE TEMPORARY BRACING/SHORING FOR ALL EXISTING FLOOR JOISTS & WALLS DURING CONSTRUCTION & INSTALLATION OF NEW BEAMS & FLOOR JOISTS AS REQ. (TYP.)

NOTE ABOUT MATCHING INSULATION IN OLDER HOMES THE ENERGY EFFICIENCY OF EXISTING BUILDINGS SHALL COMPLY WITH PART 11 OF DIVISION B OF THE BUILDING CODE

FOR RENOVATION. SB-12, 1.1.1.1. ENERGY EFFICIENCY

CONSTRUCTION MAY BE CARRIED OUT TO MAINTAIN THE EXISTING PERFORMANCE LEVEL OF ALL OR PART OF AN EXISTING BUILDING, BY THE REUSE, RELOCATION OR EXTENSION OF THE SAME OR SIMILAR MATERIALS OR COMPONENTS, TO RETAIN THE EXISTING CHARACTER, STRUCTURAL UNIQUENESS, HERITAGE VALUE, OR AESTHETIC APPEARANCE OF ALL OR PART OF THE BUILDING, IF THE CONSTRUCTION WILL NOT ADVERSELY AFFECT THE EARLY WARNING AND EVACUATION SYSTEMS, FIRE SEPARATIONS OR THE STRUCTURAL ADEQUACY OR WILL NOT CREATE AN UNHEALTHY ENVIRONMENT IN THE BUILDING. 11.3.3.1. BASIC RENOVATION (SEE APPENDIX A)

WHERE THE FRAMING SYSTEMS ARE BEING ALTERED TO MATCH EXISTING FRAMING, LESSER AMOUNTS AND EXTENT OF INSULATION AND VAPOR BARRIER IS ACCEPTABLE. PART 11 COMPLIANCE ALTERNATIVE, TABLE 11.5.1.1.C. (CONT'D), C199 - 12.2.1.1. (3)

SMOKE ALARMS

(1) Within dwelling units sufficient smoke alarms conforming to CAN/ULS-531 shall be installed so that (a) There is at least one smoke alarm on each storey, including basements, and

(b) On any storey of a dwelling unit containing sleeping rooms, a smoke (i) in each sleeping room, and
(ii) in a location between the sleeping rooms and remainder of the storey, and if the sleeping rooms are served by a hallway, the smoke alarm shall be located in the hallway


(2) Smoke alarms shall have a visual signalling component conforming to the requirements in 18.5.3. of NFPA 72. The visual signalling component need not be integrated with the smoke alarm provided it is interconnected

Interconnect smoke alarms to be permantly connected and have a battery backup as per OBC 9.10.19.4

TABLE 3.1.1.21. (IP) Thermal Performance Requirements for Additions to Existing Buildings

CEILING WITH ATTIC SPACE CEILING WITHOUT ATTIC SPACE EXPOSED FLOOR WALLS ABOVE GRADE BASEMENT WALLS R19 + R5 c.i. R20 c.i. or R12 + R10 c.i. BELOW GRADE SLAB EDGE OF BELOW GRADE SLAB HEATED SLAB WINDOWS AND SLIDING GLASS DOORS ENERGY RATING 0.28U 25

ELECTRICAL FACILITIES SHALL BE PROVIDED AS PER ONTARIO BUILDING CODE 2012 AS PER 9.34

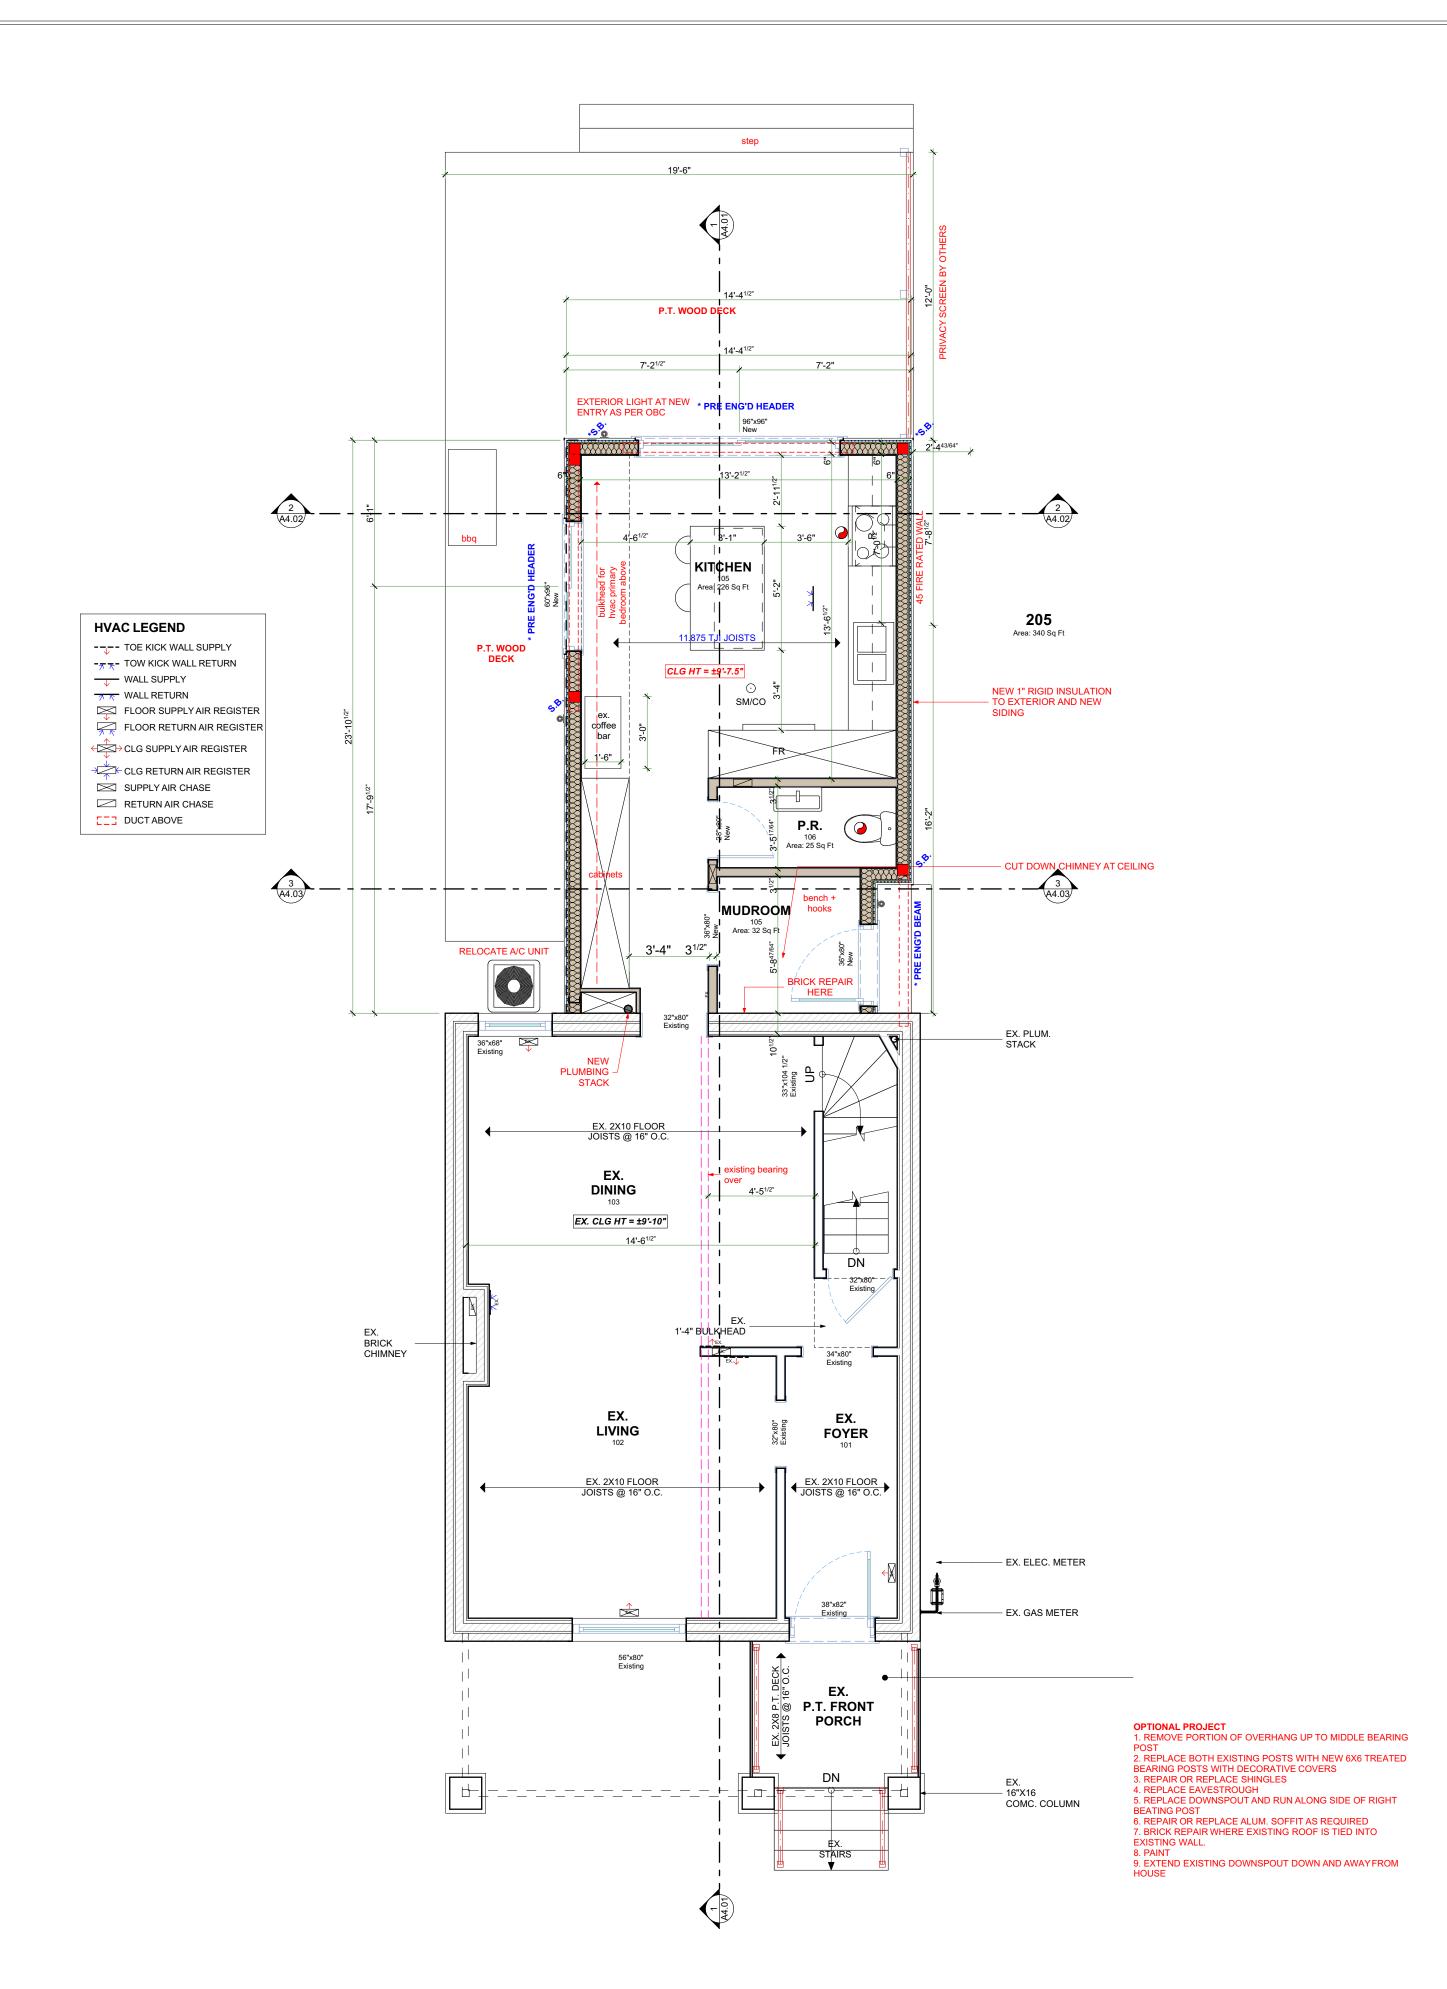



NO.	INEVISION	DAIL
1	DESIGN 1.0	2021.04.23
2	DESIGN 2.0	2021.04.27
3	DESIGN 2.1	2021.05.14
4	DESIGN 3.0	2021.06.29
5	ISSUED FOR MINOR VARIANCE	2021.08.04
	DRAWING:	

PROPOSED MAIN FLOOR **PLAN**

PROJECT NAME: **EDWARDS**

PROJECT ADDRESS: 65 MAGILL ST HAMILTON ON L8R 2Y4

DATE: 8/4/2021 DRAWING NO: SCALE: AS NOTED

PROJECT NO:

A1.05

1 PROPOSED MAIN FLOOR PLAN

SCALE: 1/4" = 1'-0"

ALL CONSTRUCTION TO COMPLY WITH ONTARIO BUILDING CODE DESIGN AND LAYOUT OF ALL PRE ENGINEERED STRUCTURAL MEMBERS FROM ROOF TRUSS SUPPLIER TO BE SUPPLIED BY MANUFACTURER PRIOR TO CONSTRUCTION SOLID BLOCKING TO BEARING BELOW TO BE PROVIDED AT ALL GIRDER TRUSS AND BEAM LOCATIONS (MIN. WIDTH EQUAL TO WIDTH OF BEARING POINT OVER) VERIFY WITH TRUSS TRUSS MEMBERS SHALL NEVER BE NOTCHED, DRILLED OR CUT UNLESS NOTCHING OR DRILLING HAS BEEN ACCOUNTED FORIN THE DESIGN OF THE TRUSS WHEN RENOVATING. INSULATION TO BE EQUAL TO OR GREATER THAN EXISTING BEAM BEARING = MIN. 3-1/2" LINTEL BEARING = MIN. 1-1/2" RAFTER BEARING = MIN. 1-1/2" JOISTS BEARING = MIN. 1-1/2"

ALL EXISTING FLOOR JOISTS & WALLS DURING CONSTRUCTION & INSTALLATION OF NEW BEAMS & FLOOR JOISTS AS REQ. (TYP.) NOTE ABOUT MATCHING INSULATION IN OLDER HOMES

PROVIDE TEMPORARY BRACING/SHORING FOR

CONTRACTOR TO CHECK AND VERIFY ALL SPECIFICATIONS AND DIMENSIONS PRIOR TO AND DURING CONSTRUCTION. ALL
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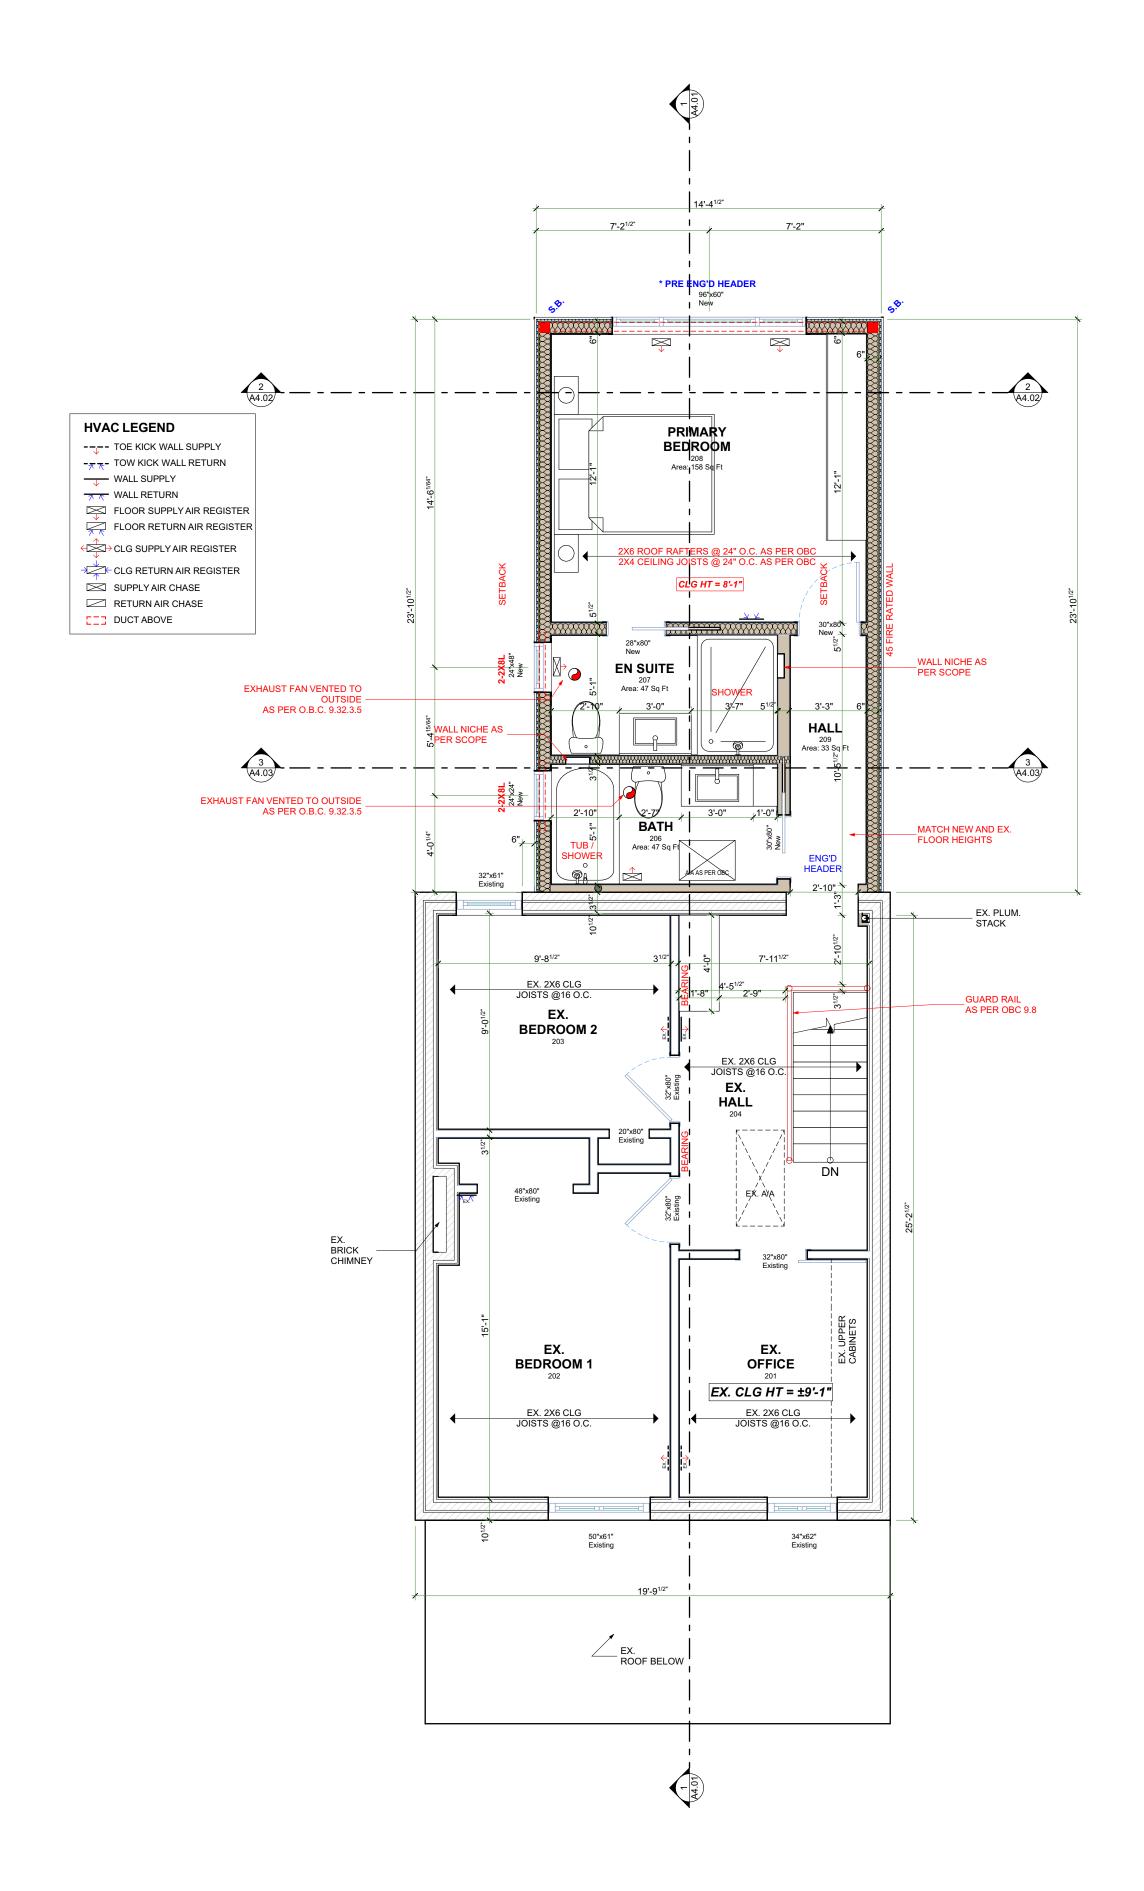
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TABLE 3.1.1.21. (IP) Thermal Performance Requirements for Additions to Existing Buildings

CEILING WITH ATTIC SPACE CEILING WITHOUT ATTIC SPACE EXPOSED FLOOR
WALLS ABOVE GRADE
BASEMENT WALLS R31 R19 + R5 c.i. R20 c.i. or R12 + R10 c.i. BELOW GRADE SLAB EDGE OF BELOW GRADE SLAB HEATED SLAB WINDOWS AND SLIDING GLASS DOORS ENERGY RATING 0.28U 25

ELECTRICAL FACILITIES SHALL BE PROVIDED AS PER ONTARIO BUILDING CODE 2012 AS PER 9.34





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	1	DESIGN 1.0	2021.04.23
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	3	DESIGN 2.1	2021.05.14
	4	DESIGN 3.0	2021.06.29
	5	ISSUED FOR MINOR VARIANCE	2021.08.04
		DRAWING:	


PROPOSED SECOND **FLOOR PLAN**

PROJECT NAME: **EDWARDS**

PROJECT ADDRESS: 65 MAGILL ST HAMILTON ON L8R 2Y4

DATE: 8/4/2021 SCALE: DRAWING NO: AS NOTED A1.06

PROJECT NO:

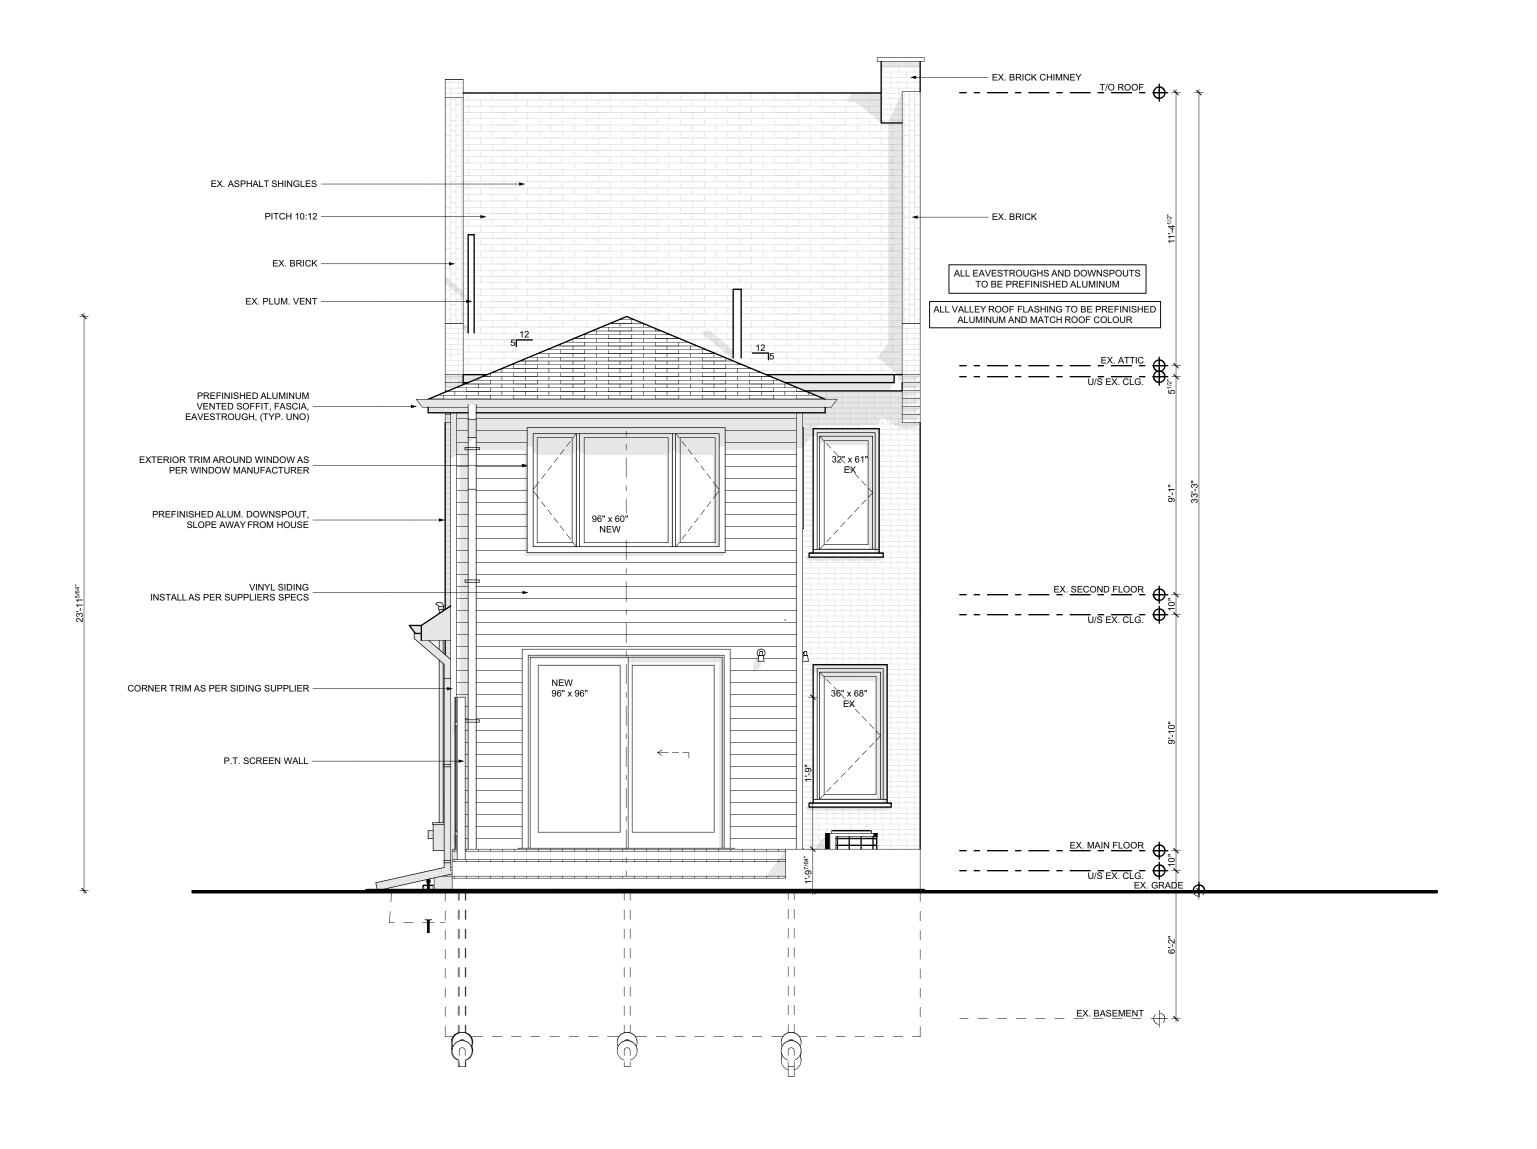





NO.	REVISION	DATE
1	DESIGN 1.0	2021.04.23
2	DESIGN 2.0	2021.04.27
3	DESIGN 2.1	2021.05.14
4	DESIGN 3.0	2021.06.29
5	ISSUED FOR MINOR VARIANCE	2021.08.04

DRAWING:

PROPOSED REAR ELEVATION

PROJECT NAME: **EDWARDS**

PROJECT ADDRESS:
65 MAGILL ST HAMILTON ON L8R 2Y4


DATE: 8/4/2021

SCALE: DRAWING NO:

AS NOTED

PROJECT NO:

AS NOTED

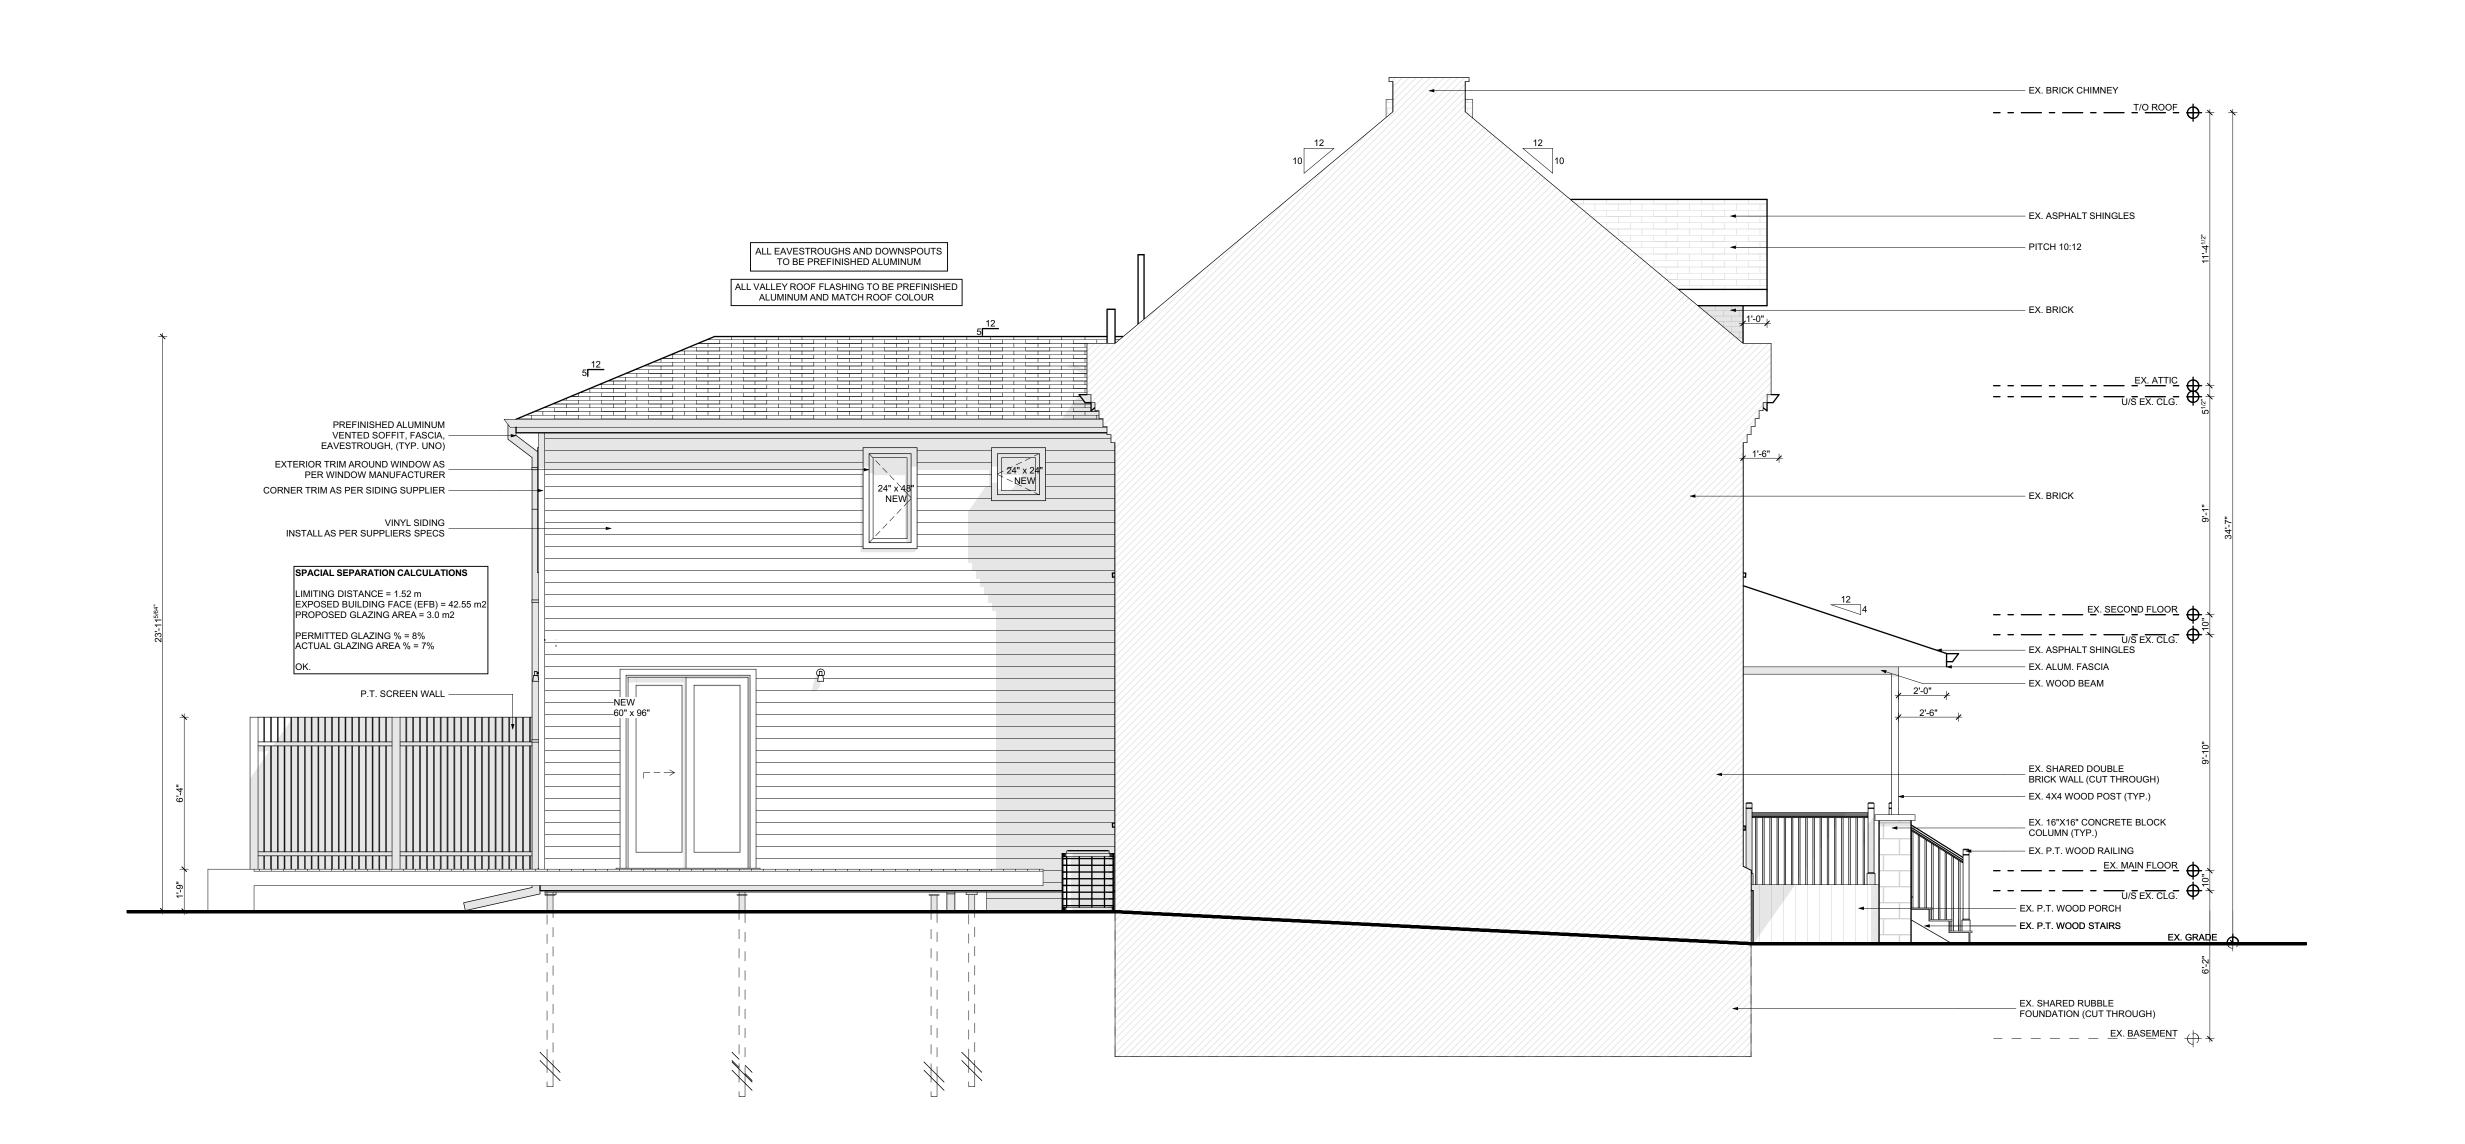





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	1	DESIGN 1.0	2021.04.23
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	4	DESIGN 3.0	2021.06.29
	5	ISSUED FOR MINOR VARIANCE	2021.08.04
		DRAWING:	

PROPOSED LEFT **ELEVATION**

PROJECT NAME: **EDWARDS**

PROJECT ADDRESS: 65 MAGILL ST HAMILTON ON L8R 2Y4

DATE: 8/4/2021 SCALE: DRAWING NO: AS NOTED A2.07

PROJECT NO:

PROPOSED LEFT ELEVATION

SCALE: 1/4" = 1'-0"

RENOVATION TO: EDWARDS

65 MAGILL ST HAMILTON ON L8R 2Y4

GENERAL NOTES

1. O.B.C. TO BE UNDERSTOOD AS ONTARIO BUILDING CODE 2012 LATEST EDITION AND

2. ALL STAGES OF CONSTRUCTION SHALL CONFORM

3. DO NOT SCALE DRAWINGS. 4. CONTRACTOR TO REVIEW AND VERIFY ALL DIMENSIONS PRIOR
TO AND DURING CONSTRUCTION. ALL DISCREPANCIES TO BE REPORTED TO DESIGNER. 5. ALL WALL & CEILINGS BETWEEN DWELLING UNIT AND GARAGE ARE TO BE GAS PROOFED AND

INSULATED TO ENERGY EFFICIENCY SUMMARY 6. SEE ELEVATIONS AND FLOOR PLANS FOR WALL AND CEILING HEIGHTS. ANY DISCREPANCIES TO BE REPORTED TO DESIGNER.

7. WOOD IN CONTACT WITH CONCRETE OR MASONRY TO BE SEPARATED WITH MINIMUM 2 MIL. POLY UNLESS OTHER WISE NOTED ON DRAWINGS.

8. UNDERCUT ALL DOORS TO ROOMS WITHOUT RETURN AIR INLETS

9. SMOKE AND CO.DETECTORS TO BE LOCATED AT EACH LEVEL. SMOKE ALARMS LOCATED IN EACH BEDROOM AND ARE TO BE INTERCONNECTED. 10. ALL LIGHTING AND ELECTRICAL AS PER O.B.C.

11. PROVIDE SUMP PIT AND SEALED PIT COVER FOR DRAINAGE AS PER O.B.C. 9.14.

12. ATTIC ACCESS TO BE INSULATED MIN. R20 AND WEATHER STRIPPED.

SUB-FLOOR SHALL BE REINFORCED AS PER O.B.C. 9.30.6.3. 14. HVAC DRAWINGS TO BE DESIGNED BY OTHERS AS PER O.B.C. DRAWINGS TO BE PROVIDED TO TBOUMA DESIGN AND DRAFTING PRIOR TO FINALIZED WORKING DRAWINGS. DRAWINGS NOT

INCORPORATED INTO PLANS AND ON RECORD. 15. HRV / ERV TO BE BALANCE POST 16. PROVIDE MIN. 6'-5" HEADROOM BELOW ALL

BEAMS & DUCTWORK. 17. ALL EXHAUST FANS TO BE VENTED TO EXTERIOR. 18. VENTED RANGE HOODS TO BE VENTED TO EXTERIOR WITH NON-COMBUSTIBLE DUCTING

MASONRY

1. ALL FLASHING TO CONFORM TO O.B.C. 9.20.13. 2. ALL BRICK OR STONE SILLS TO BE FLASHED IN ACCORDANCE WITH THE O.B.C. 3. ALL STEEL LINTELS FOR MASONRY TO HAVE MINIMUM 6" BEARING EACH END AND SUPPORTED BACK TO FOUNDATION DESIGNER

DIRECTOR 104857 2. CONTRACTOR IS TO OBTAIN QUALIFIED DESIGNERS FOR ALL ENGINEERED
STRUCTURAL MEMBERS AND SYSTEMS WHERE INDICATED DESIGNED BY OTHERS ON

3. DESIGNER ASSUMES NO RESPONSIBILITY FOR FAILURE OF THE CONTRACTOR OR SUB-CONTRACTOR TO CARRY OUT THE WORK IN ACCORDANCE WITH THESE DRAWINGS

THE WHOLE DRAWING SET. 5. CONTRACTOR SHALL CHECK AND VERIFY ALL DIMENSIONS ON THE WORKING DRAWING SET. ANY DISCREPANCIES ARE TO BE REPORTED TO UNOBSTRUCTED OPEN AREA OF 3.8 SQ, FT, THE DESIGNER PRIOR TO COMMENCEMENT OF WITH NO DIMENSION LESS THAN 15".

b. ANY MODIFICATIONS TO THE DESIGN SHALL
NOT BE MADE WITHOUT AGREEMENT BETWEEN
DESIGNER AND CONTRACTOR.

DOCUMENTATION SHALL SET TO SHA

DOCUMENTATION SHALL BE THE ONLY FORM OF 7. WHEN DRAWINGS ARE TO BE MODIFIED OR 9. WINDOW VALUES REFER TO FLOOR PLAN CHANGES ARE TO BE MADE THE BUILDING
DEPARTMENT WILL BE NOTIFIED FOR PURPOSE OF REVIEW PRIOR TO CONSTRUCTION.

8. UNDER NO CIRCUMSTANCE SHALL THE CONTRACTOR OR SUB-CONTRACTOR PROCEED IF THERE IS ANY UNCERTAINTY. DESIGNER SHALL BE CONTACTED. 9. THE DRAWINGS THAT ARE APPROVED AND STAMPED BY THE BUILDING DEPARTMENT ARE TO BE THE ONLY TRUE DRAWINGS AND ARE TO

BE ACCESSIBLE TO ALL CONTRACTORS AND SUB-CONTRACTORS AT ALL TIMES WITH-IN THE JOB SITE TILL ALL WORK IS COMPLETED.

1. ALL STAIR COMPONENTS TO CONFORM TO O.B.C. STANDARDS. • MIN. RUN = 8 1/4" • MIN TREAD = 9 1/4"

• MIN. HEADROOM = 6'-5"

GUARDS:
• MIN. HEIGHT = 36" NON-CLIMBABLE

EXTERIOR GUARDS:

• 2'-0" TO 5'-11" ABOVE FINISHED GRADE

• MINIMUM HEIGHT = 36" MINIMUM HEIGHT = 42"

DOORS AND WINDOWS

1. REGISTRATION:

NAME OF REGISTRATION FIRM TBOUMA DESIGN
INC. REGISTRATION NUMBER ASSIGNED BY

1. ALL EXTERIOR DOORS TO BE METAL
INSULATED OR WOOD WITH STORM DOOR WITH
WEATHER STRIPPING 2. DOOR BETWEEN GARAGE AND DWELLING TO BE WEATHER STRIPPED AND GAS TIGHT

> 3. DOOR AT COLD STORAGE TO BE EXTERIOR 4. ALL WINDOWS AND DOORS AS PER ENERGY

EXTERIOR TYPE DOOR WITH SELF CLOSING DEVICE.

EFFICIENCY DESIGN SUMMARY OR ATTACHED 4. SINGLE PAGES OF THESE DRAWINGS NOT TO BE READ INDEPENDENTLY OF ALL PAGES OF THE WHOLE DRAWING SET.

5. ALL EXTERIOR DOORS AND WINDOWS TO COMPLY WITH FORCED ENTRY REQUIREMENTS. O.B.C. 9.7.5.2. AND 9.7.6.

HAVE ONE OPERABLE WINDOW WITH A MINIMUM UNOBSTRUCTED OPEN AREA OF 3.8 SQ, FT,

8. UNDERCUT ALL DOORS TO ROOMS WITHOUT RETURN AIR INLET.

1. ALL LUMBER TO COMPLY WITH O.B.C 2. ALL STRUCTURAL LUMBER TO BE OF SPRUCE #2 OR BETTER.

3. ALL PRE-ENGINEERED FLOOR AND ROOF SPECIFICATIONS ALL DRAWINGS TO BE PROVIDED TO TBOUMA DESIGN AND DRAFTING, NOT FOR APPROVAL JUST TO BE PROPERLY INCORPORATED INTO PLANS AND ON RECORD. 4. AS NOTED ON DRAWINGS STUDS TO BE USED AS BEARING POINTS WHERE IT IS APPLICABLE. 5. ALL BEAMS TO HAVE MINIMUM 3 1/2" BEARING AT BOTH ENDS BEARING TO BE CONTINUOUS TO FOUNDATION


6. DOUBLE JOISTS AROUND STAIRWELL UNLESS OTHER WIDE NOTED BY PRE-ENGINEERED FLOOR DESIGNER.

FOUNDATION

2. STEP FOOTINGS TO BE DESIGNED AS PER

 CONTRACTOR TO VERIFY SOIL CONDITIONS
 PRIOR TO PLACING OF FOOTINGS. ANY ABNORMALITIES TO BE REPORTED TO

O.B.C. 9.15.3.9.
• MAX RISE SHALL NOT EXCEED 23 5/8" • MIN RUN SHALL NOT BE LESS THAN 23 5/8" 3. ALL FOOTINGS TO BEAR ON FIRM UNDISTURBED SOIL MIN. 4'-0" BELOW FINISHED GRADE AND MIN. BEARING CAPACITY OF 75 KPa ALL GUARDS TO BE CONSTRUCTED TO O.B.C. 4. WALL HEIGHTS AND THICKNESS TO CONFORM TO O.B.C. 9.15.4.

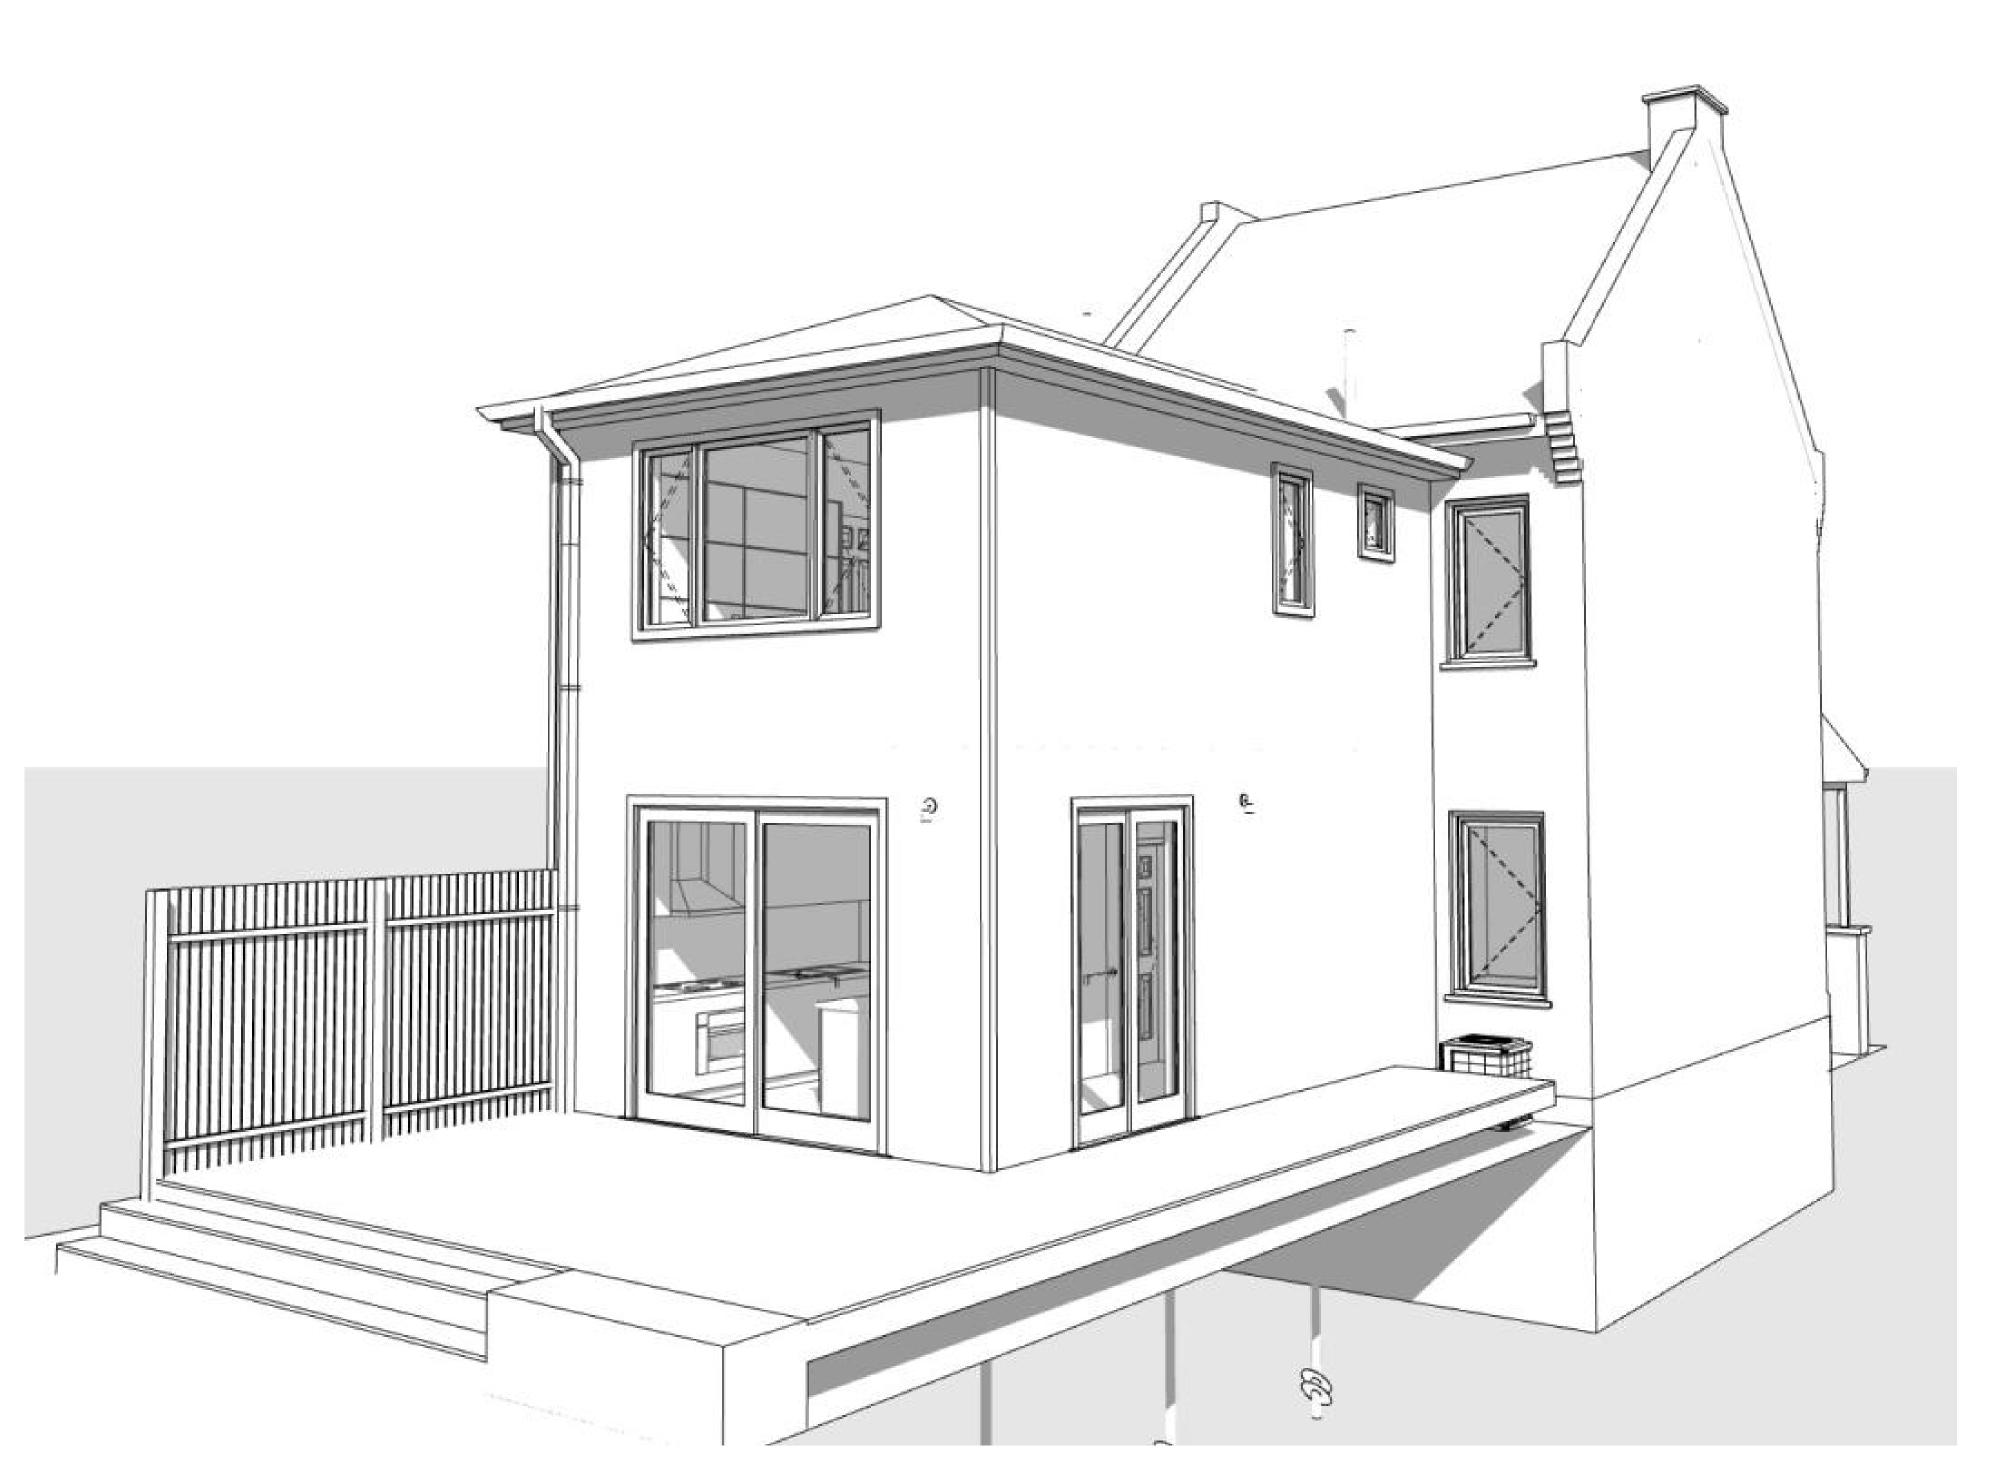





2021.04.27

TITLE SHEET / GENERAL INFO


> PROJECT NAME: **EDWARDS**

PROJECT ADDRESS: 65 MAGILL ST HAMILTON ON L8R 2Y4

DATE: 8/4/2021 AS NOTED

PROJECT NO:

DRAWING NO:

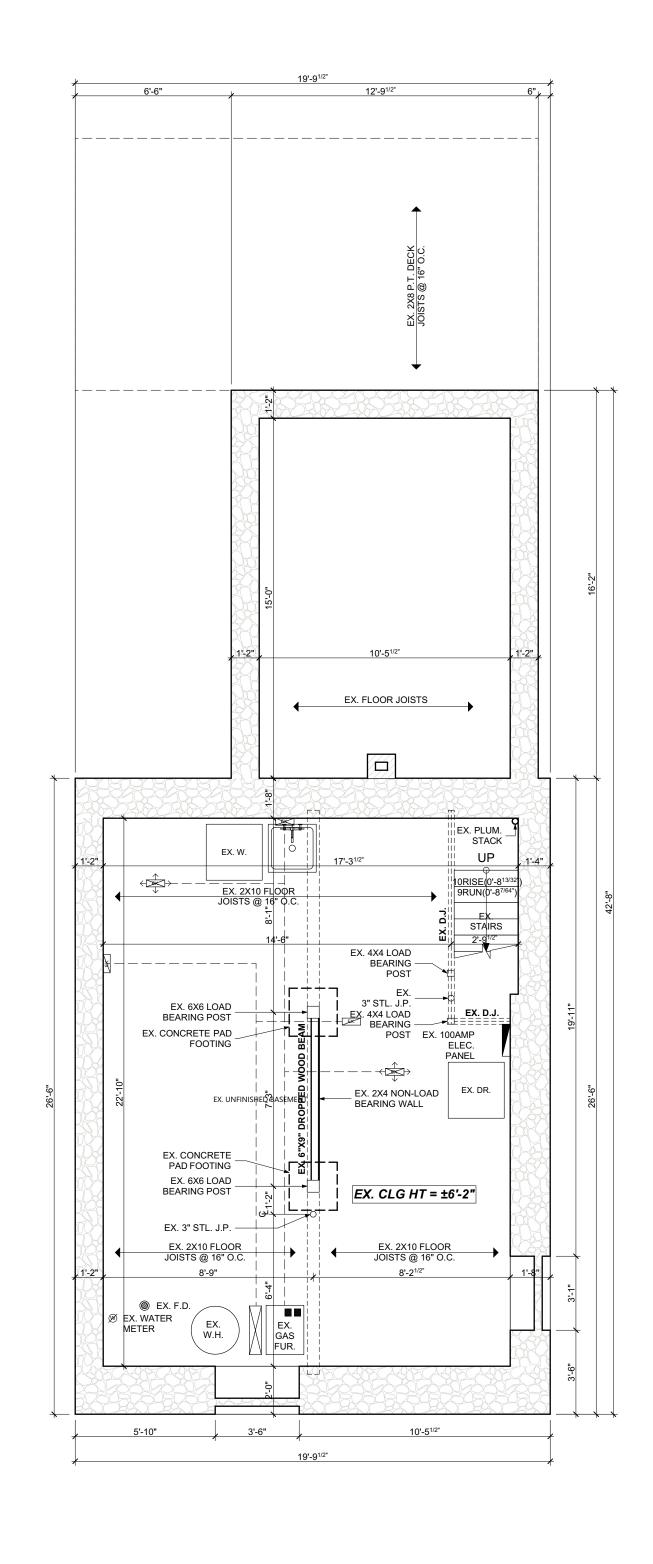

HVAC LEGEND

----- TOE KICK WALL SUPPLY - 大下 TOW KICK WALL RETURN

- ──── WALL SUPPLY → K WALL RETURN FLOOR SUPPLY AIR REGISTER

 FLOOR RETURN AIR REGISTER
- ← CLG SUPPLY AIR REGISTER
- CLG RETURN AIR REGISTER

[]] DUCTABOVE

- RETURN AIR CHASE
- SUPPLY AIR CHASE

CONTRACTOR

790 SHAVER RD. ANCASTER L9G 3K9 ON

NO.	REVISION	DATE
1	DESIGN 1.0	2021.04.23
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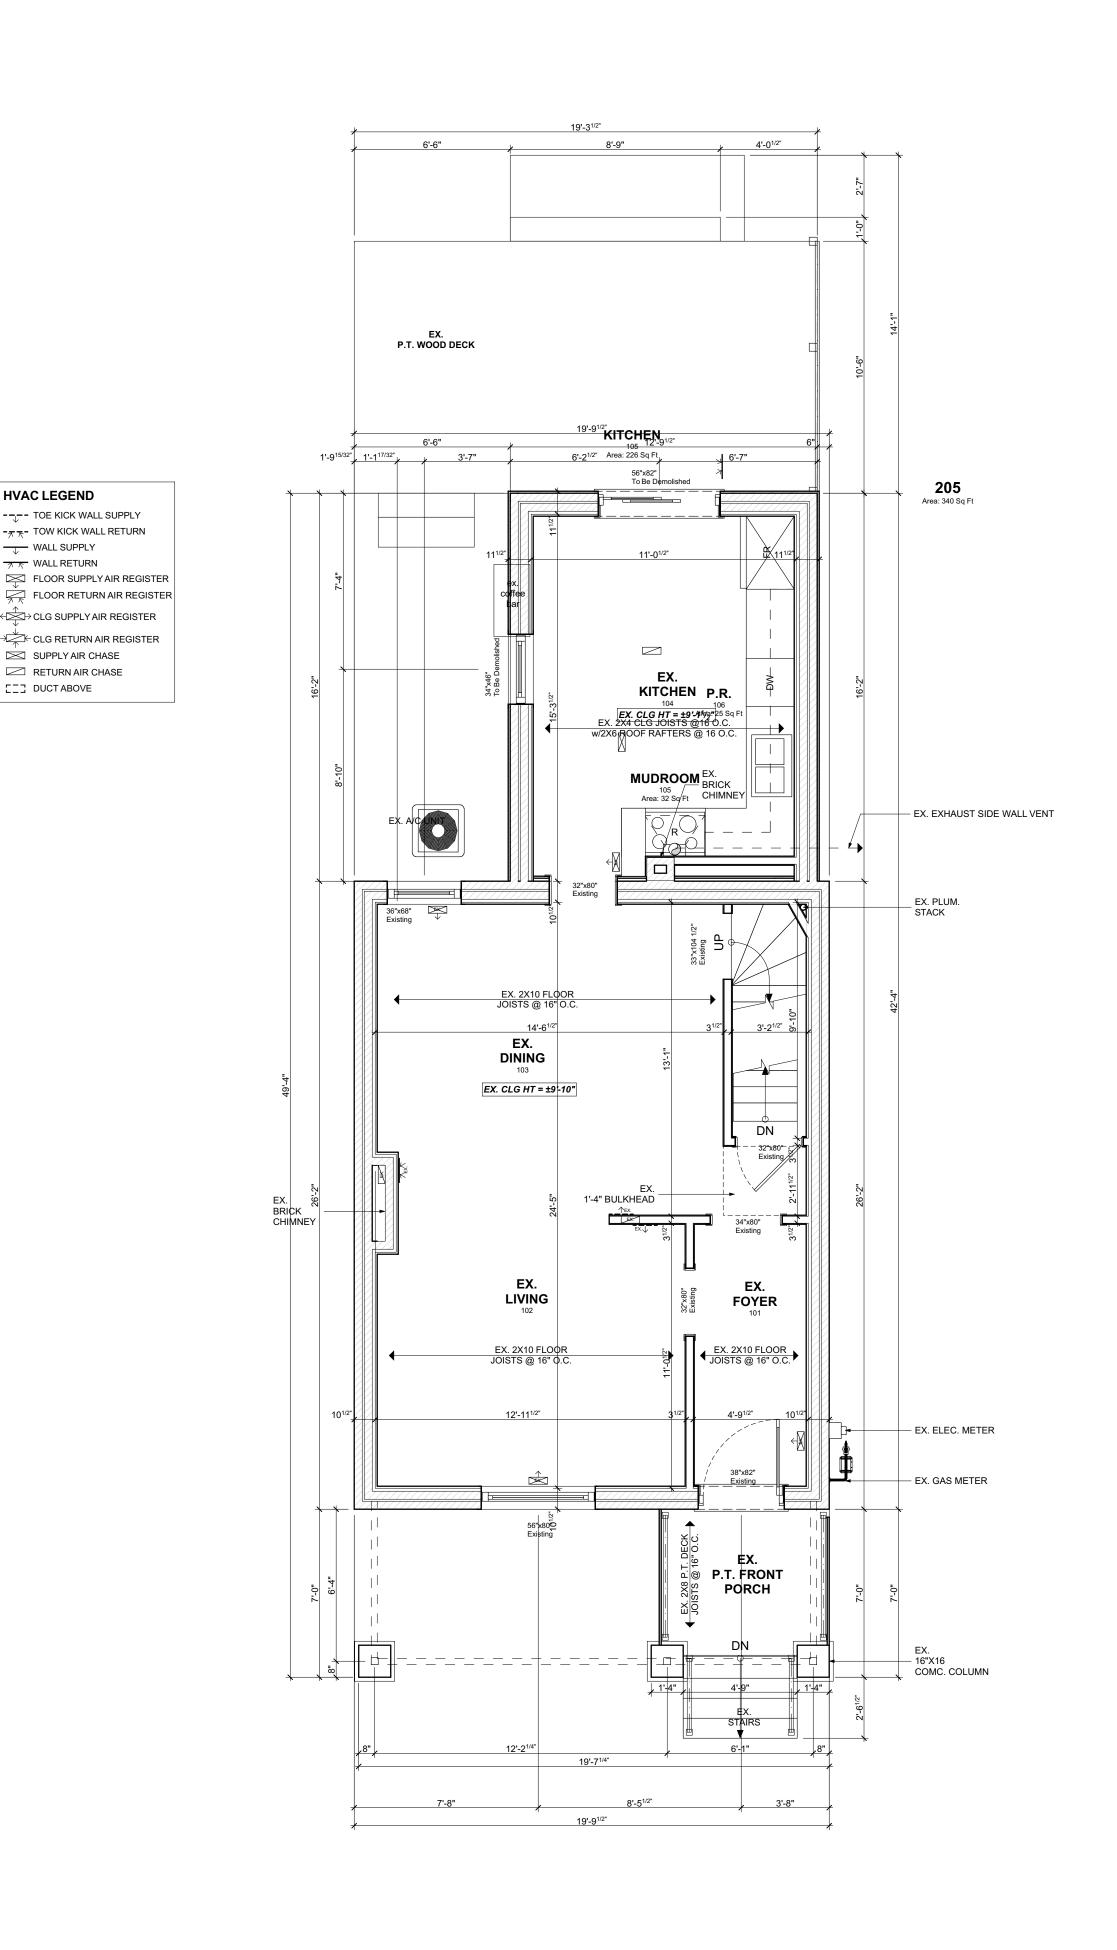
DRAWING: **EXISTING BASEMENT PLAN**

PROJECT NAME: **EDWARDS**

PROJECT ADDRESS:

65 MAGILL ST HAMILTON ON L8R 2Y4

DATE: 8/4/2021 DRAWING NO: SCALE: AS NOTED A1.01 PROJECT NO:



HVAC LEGEND

→ WALL SUPPLY カト WALL RETURN

--,-- TOE KICK WALL SUPPLY - 天大- TOW KICK WALL RETURN

← CLG SUPPLY AIR REGISTER CLG RETURN AIR REGISTER SUPPLY AIR CHASE RETURN AIR CHASE DUCT ABOVE



NO.	REVISION	DATE
1	DESIGN 1.0	2021.04.23
2	DESIGN 2.0	2021.04.27
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EXISTING MAIN FLOOR PLAN

DRAWING:

PROJECT NAME: **EDWARDS**

PROJECT ADDRESS:

65 MAGILL ST HAMILTON ON L8R 2Y4

DATE: 8/4/2021 SCALE:

DRAWING NO: AS NOTED A1.02 PROJECT NO:

1 EXISTING MAIN FLOOR PLAN
SCALE: 1/4" = 1'-0"




HVAC LEGEND

FLOOR SUPPLY AIR REGISTER
FLOOR RETURN AIR REGISTER ← CLG SUPPLY AIR REGISTER

CLG RETURN AIR REGISTER

SUPPLY AIR CHASE

RETURN AIR CHASE

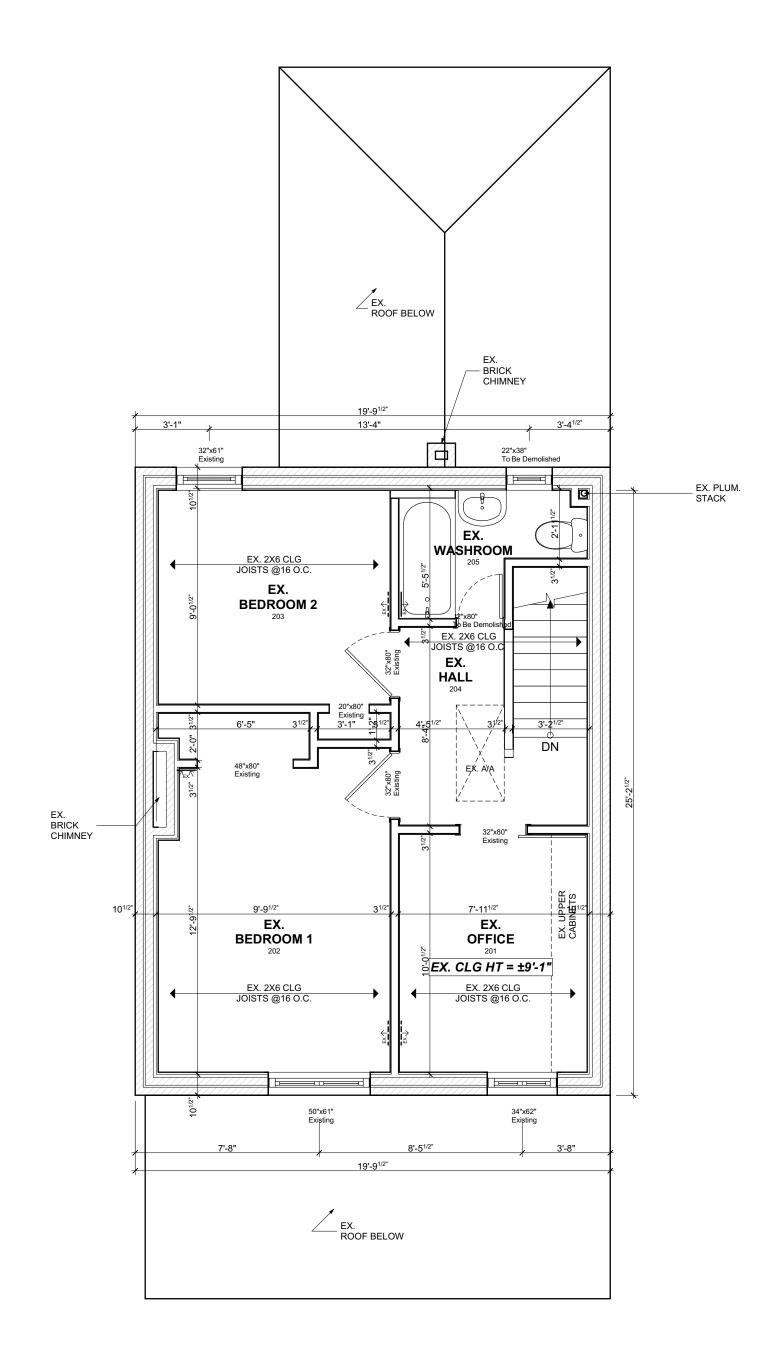





NO.	REVISION	DATE
1	DESIGN 1.0	2021.04.23
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4	DESIGN 3.0	2021.06.29
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	1 2 3 4	1 DESIGN 1.0 2 DESIGN 2.0 3 DESIGN 2.1 4 DESIGN 3.0

EXISTING SECOND FLOOR PLAN

DRAWING:


PROJECT NAME:


EDWARDS PROJECT ADDRESS:


65 MAGILL ST HAMILTON ON L8R 2Y4

DATE: 8/4/2021

DRAWING NO: AS NOTED A1.03 PROJECT NO:

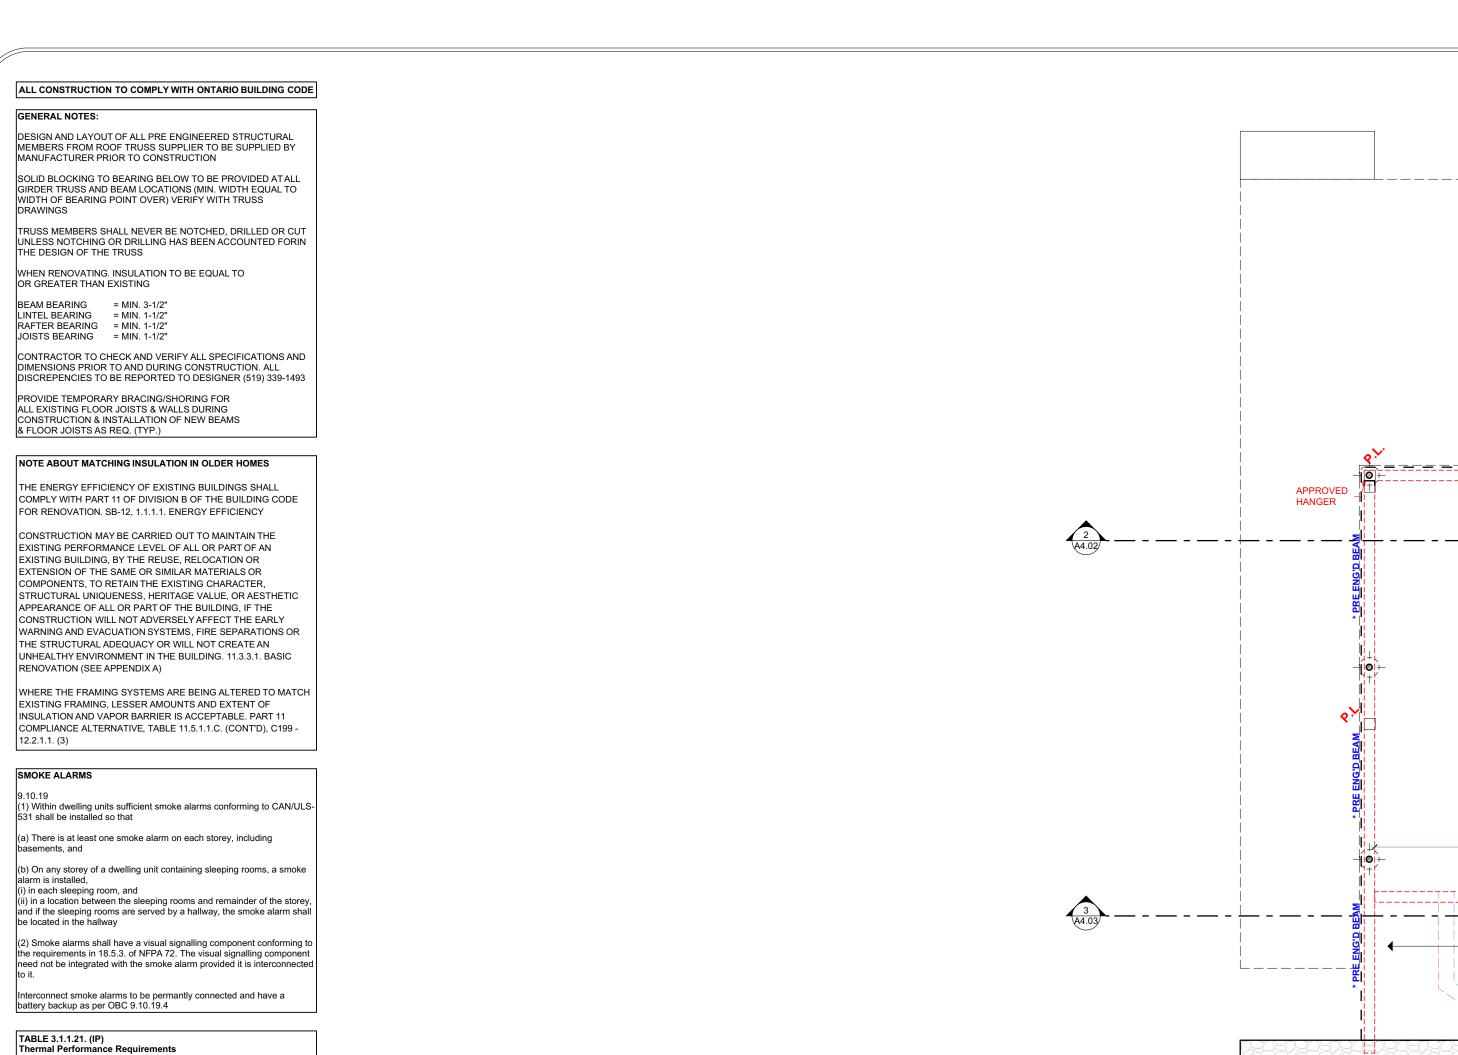

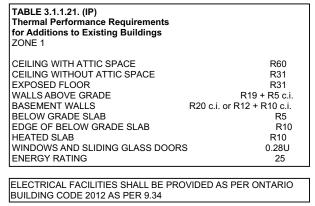

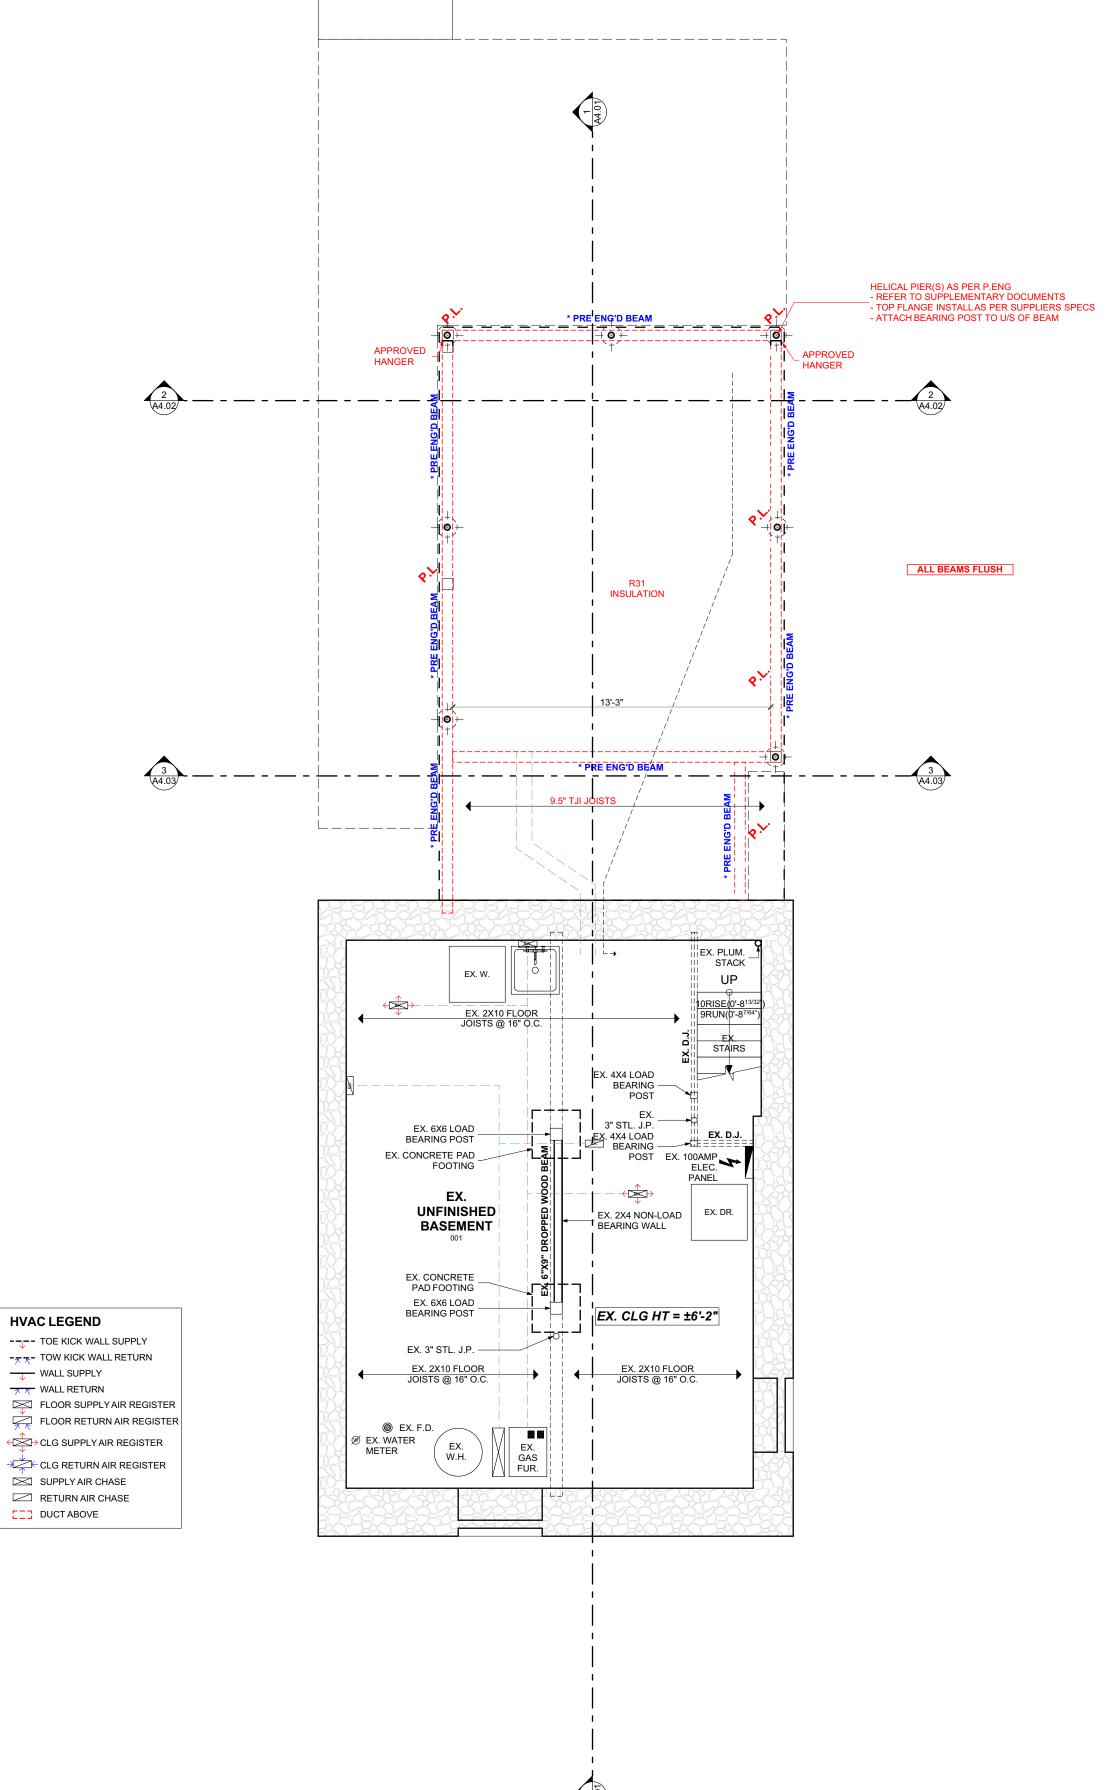



CONSTRUCTION

- 1	110.	TIEVIOIOIT	5, (12
	1	DESIGN 1.0	2021.04.23
	2	DESIGN 2.0	2021.04.27
	3	DESIGN 2.1	2021.05.14
	4	DESIGN 3.0	2021.06.29
	5	ISSUED FOR MINOR VARIANCE	2021.08.04
		DRAWING:	

PROPOSED BASEMENT PLAN

PROJECT NAME: **EDWARDS**

PROJECT ADDRESS:
65 MAGILL ST HAMILTON ON L8R 2Y4


DATE: 8/4/2021

SCALE: DRAWING NO:

AS NOTED

PROJECT NO:

AS NOTED

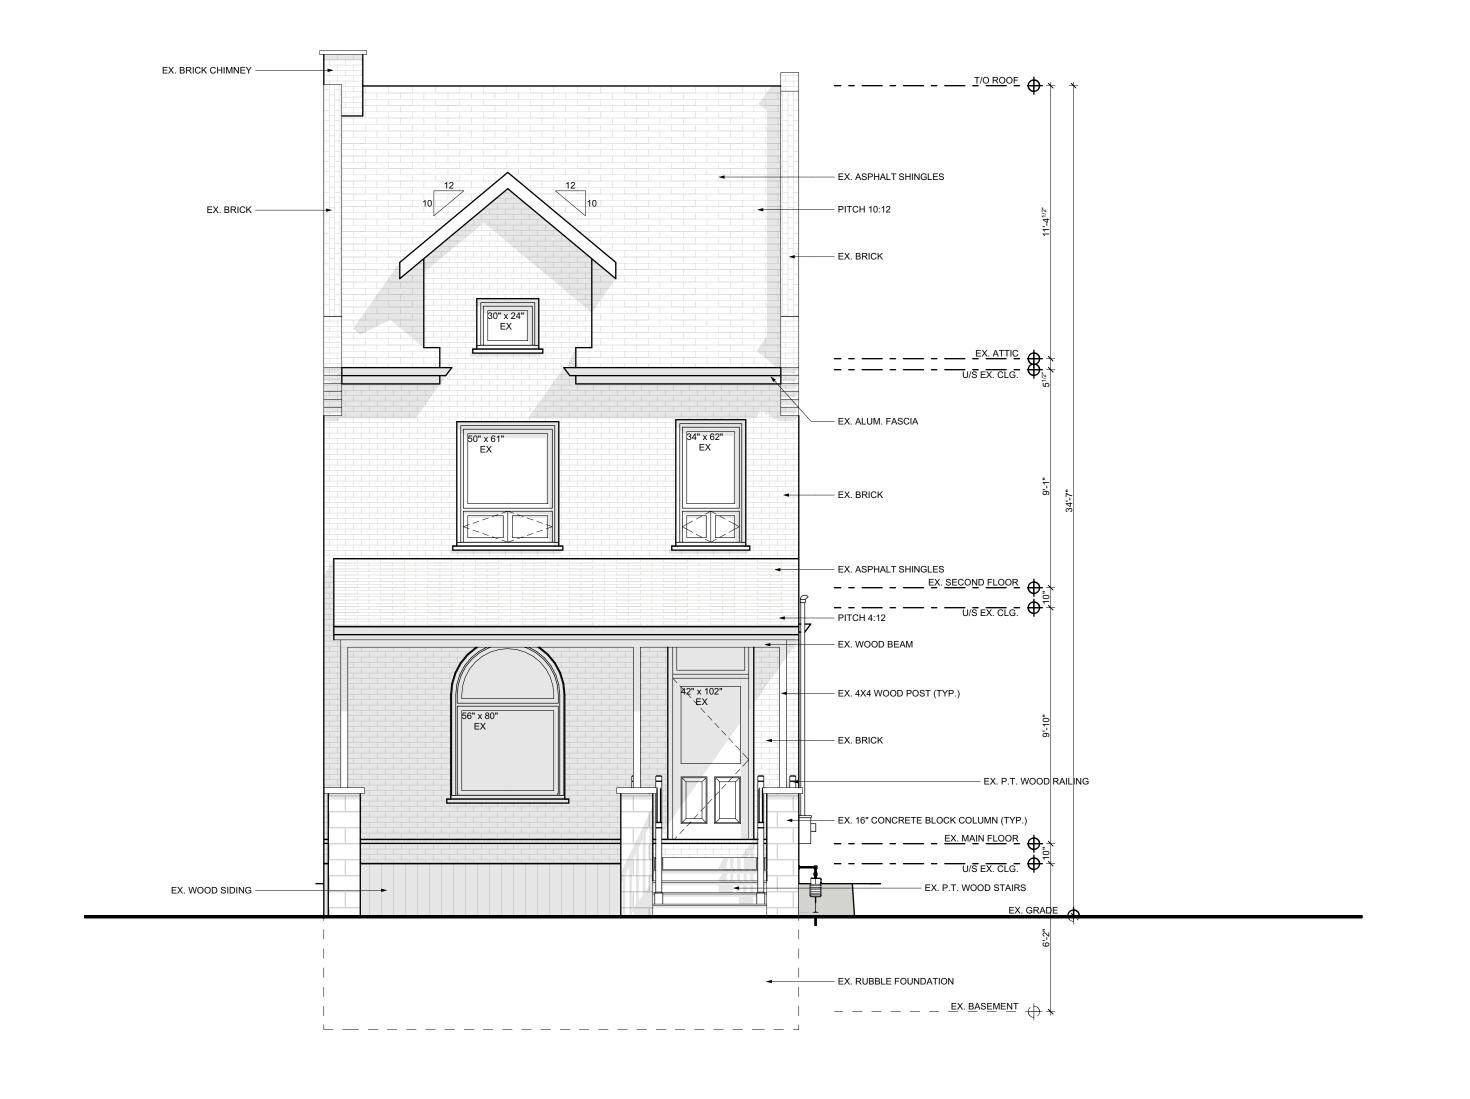





NO.	REVISION	DATE		
1	DESIGN 1.0	2021.04.23		
2	DESIGN 2.0	2021.04.27		
3	DESIGN 2.1	2021.05.14		
4	DESIGN 3.0	2021.06.29		
5	ISSUED FOR MINOR VARIANCE	2021.08.04		
DRAWING:				

EXISTING FRONT ELEVATION

PROJECT NAME: **EDWARDS**

PROJECT ADDRESS:
65 MAGILL ST HAMILTON ON L8R 2Y4

DATE: 8/4/2021


SCALE: DRAWING NO:

AS NOTED

PROJECT NO:

AS 14/2021

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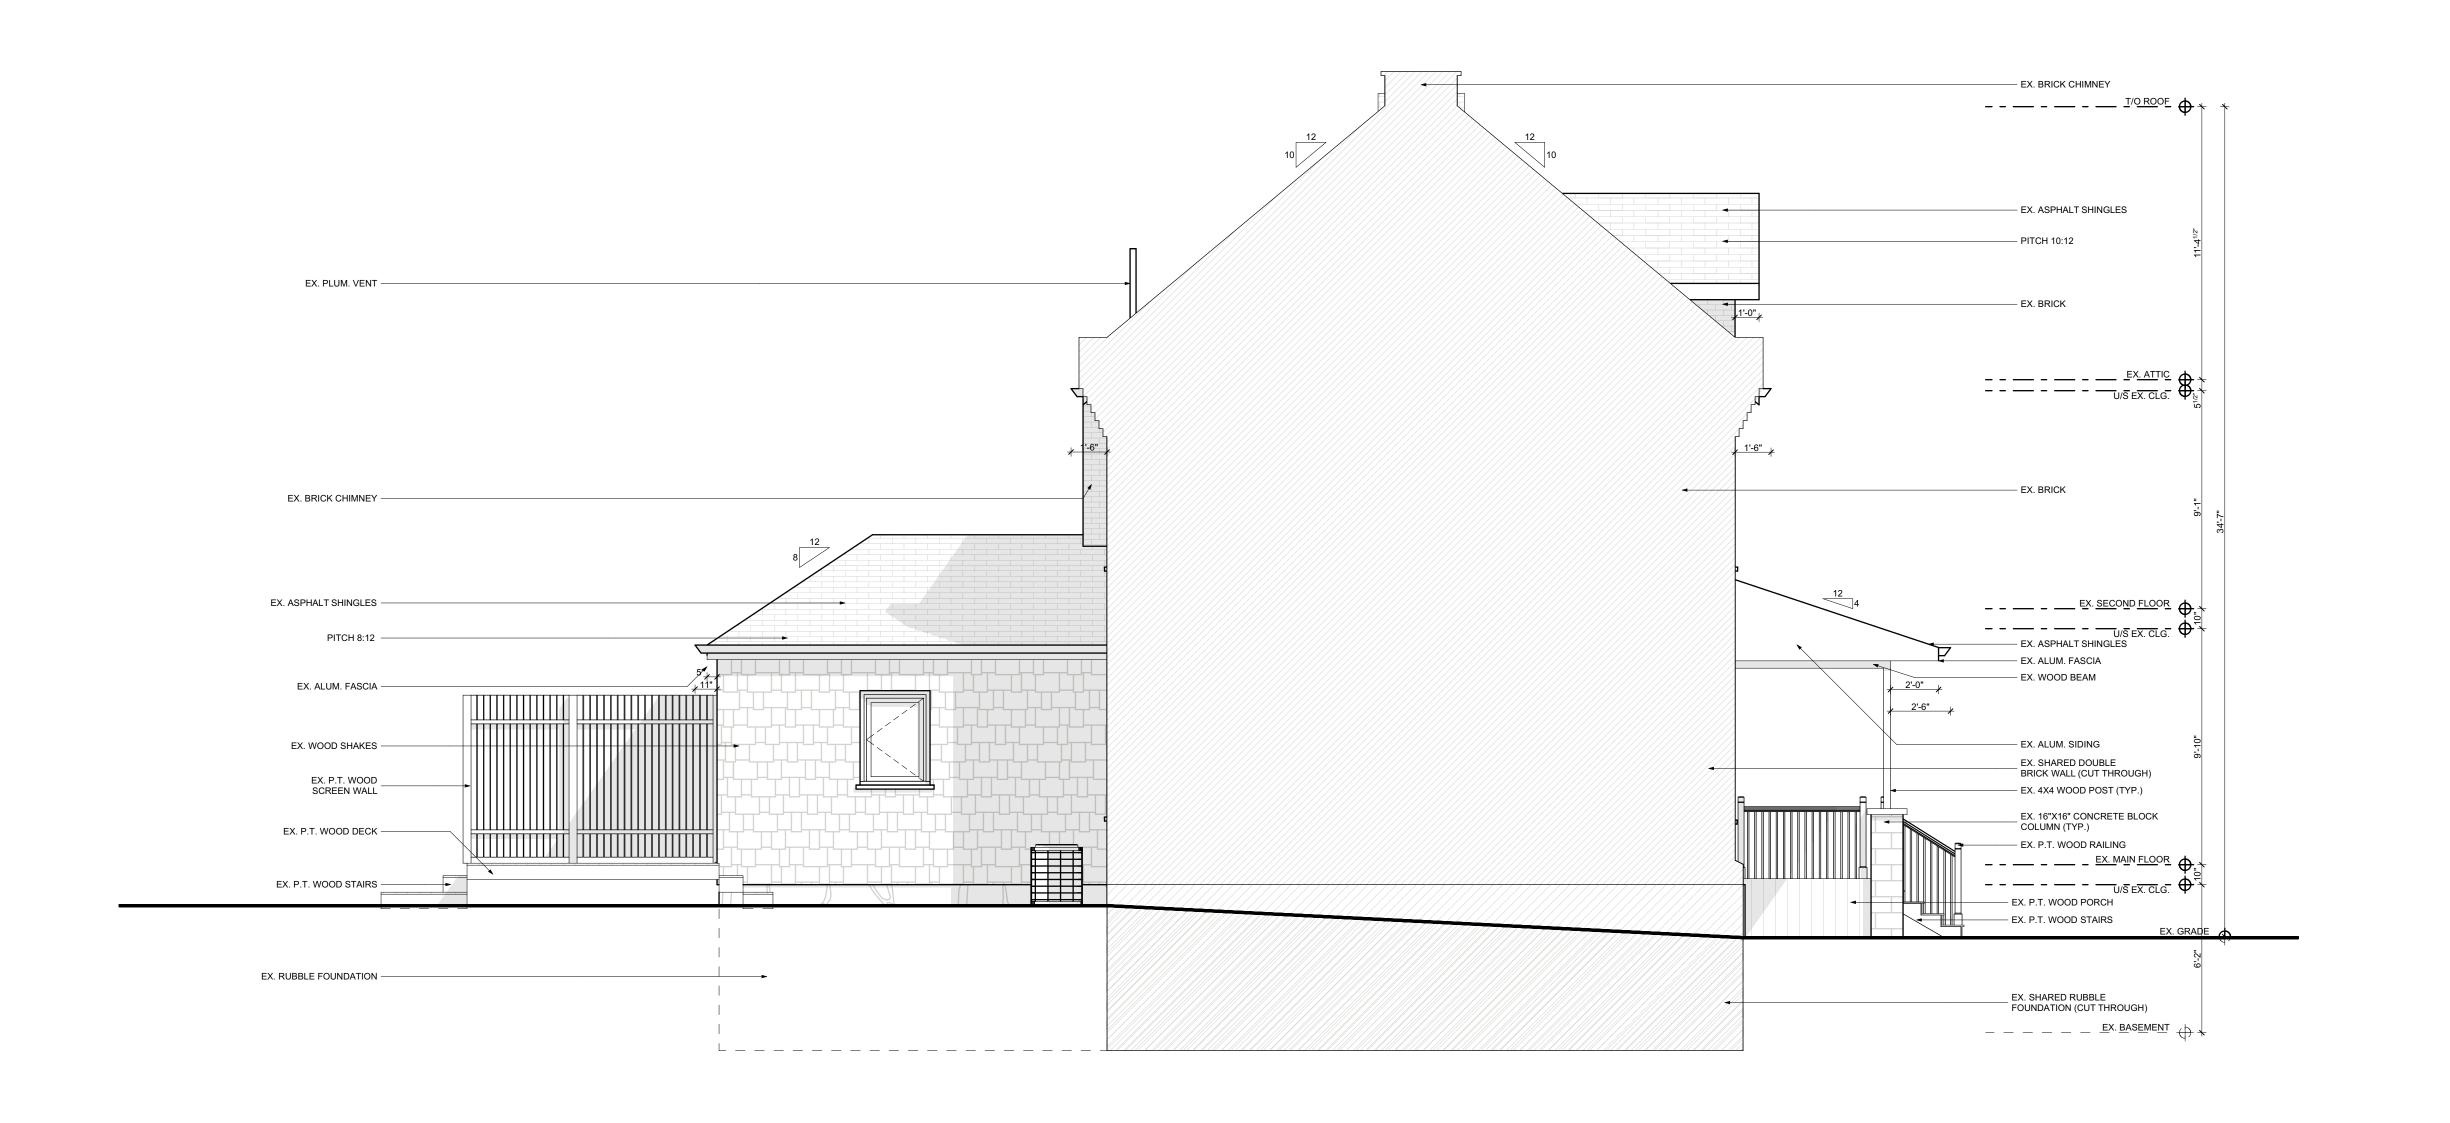
1	DESIGN 1.0	2021.04.23
2	DESIGN 2.0	2021.04.27
3	DESIGN 2.1	2021.05.14
4	DESIGN 3.0	2021.06.29
5	ISSUED FOR MINOR VARIANCE	2021.08.04

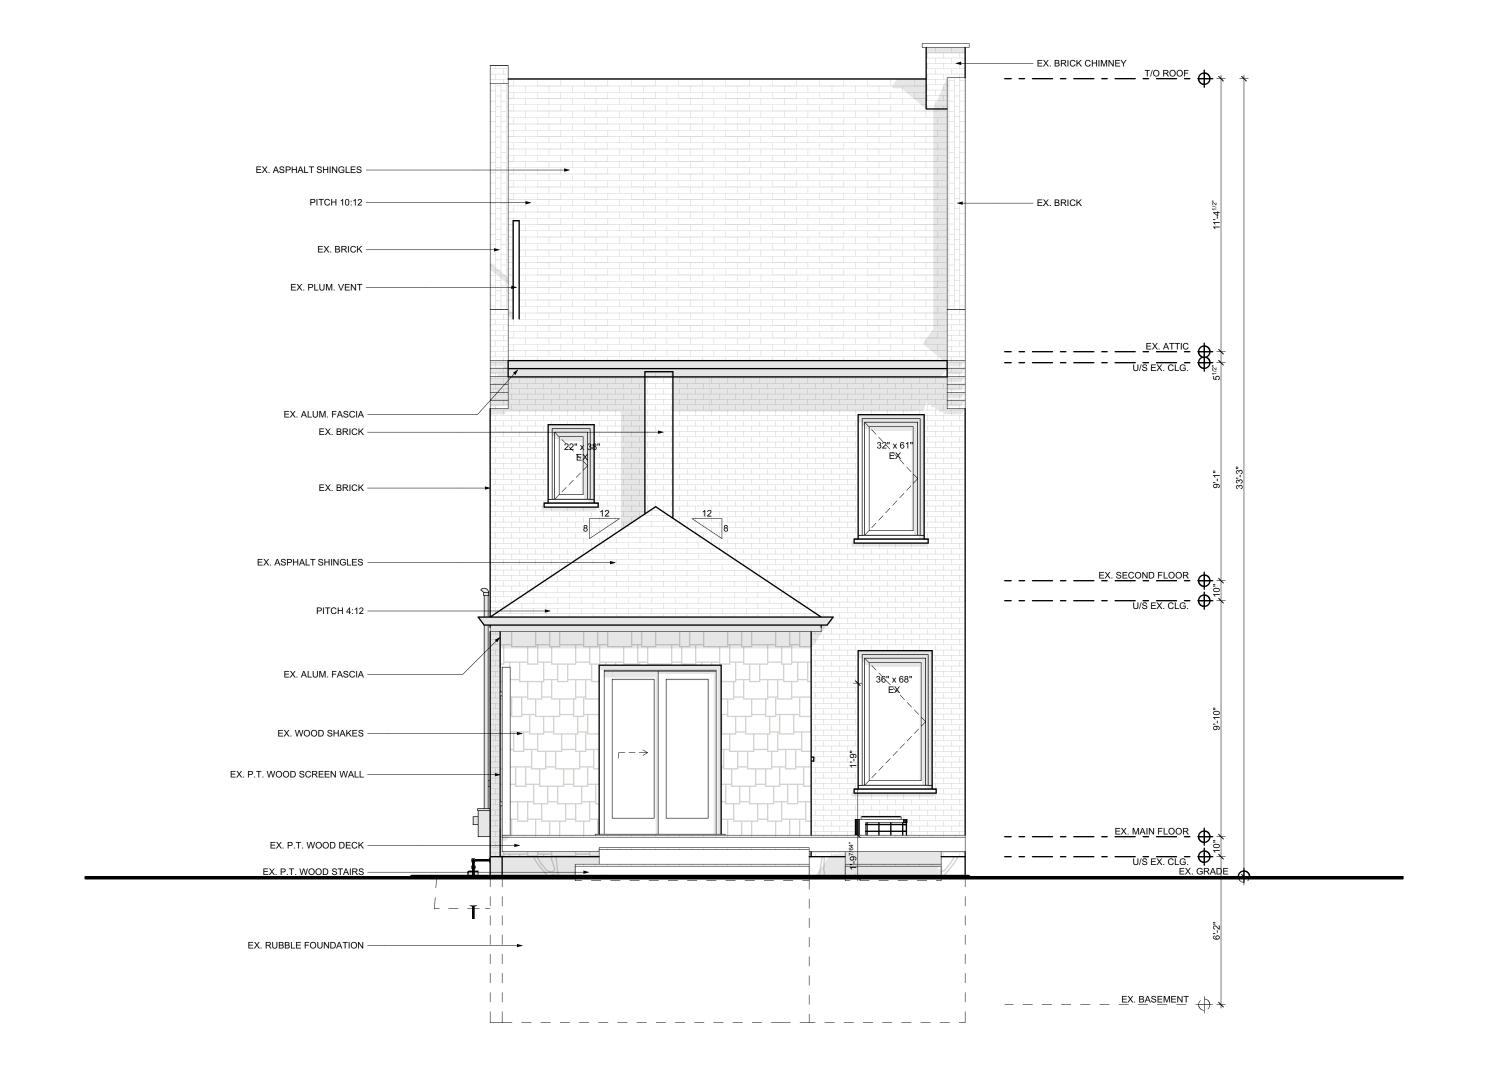DRAWING: EXISTING REAR ELEVATION

> PROJECT NAME: **EDWARDS**

PROJECT ADDRESS: 65 MAGILL ST HAMILTON ON L8R 2Y4

DATE: 8/4/2021 SCALE: DRAWING NO: AS NOTED A2.02 PROJECT NO:





790 SHAVER RD. ANCASTER L9G 3K9 ON

- 1			
	1	DESIGN 1.0	2021.04.23
	2	DESIGN 2.0	2021.04.27
	3	DESIGN 2.1	2021.05.14
	4	DESIGN 3.0	2021.06.29
	5	ISSUED FOR MINOR VARIANCE	2021.08.04
- 1			

DRAWING:

EXISTING LEFT ELEVATION


PROJECT NAME: **EDWARDS**

PROJECT ADDRESS:

65 MAGILL ST HAMILTON ON L8R 2Y4

DATE: 8/4/2021 SCALE:

DRAWING NO: AS NOTED PROJECT NO:

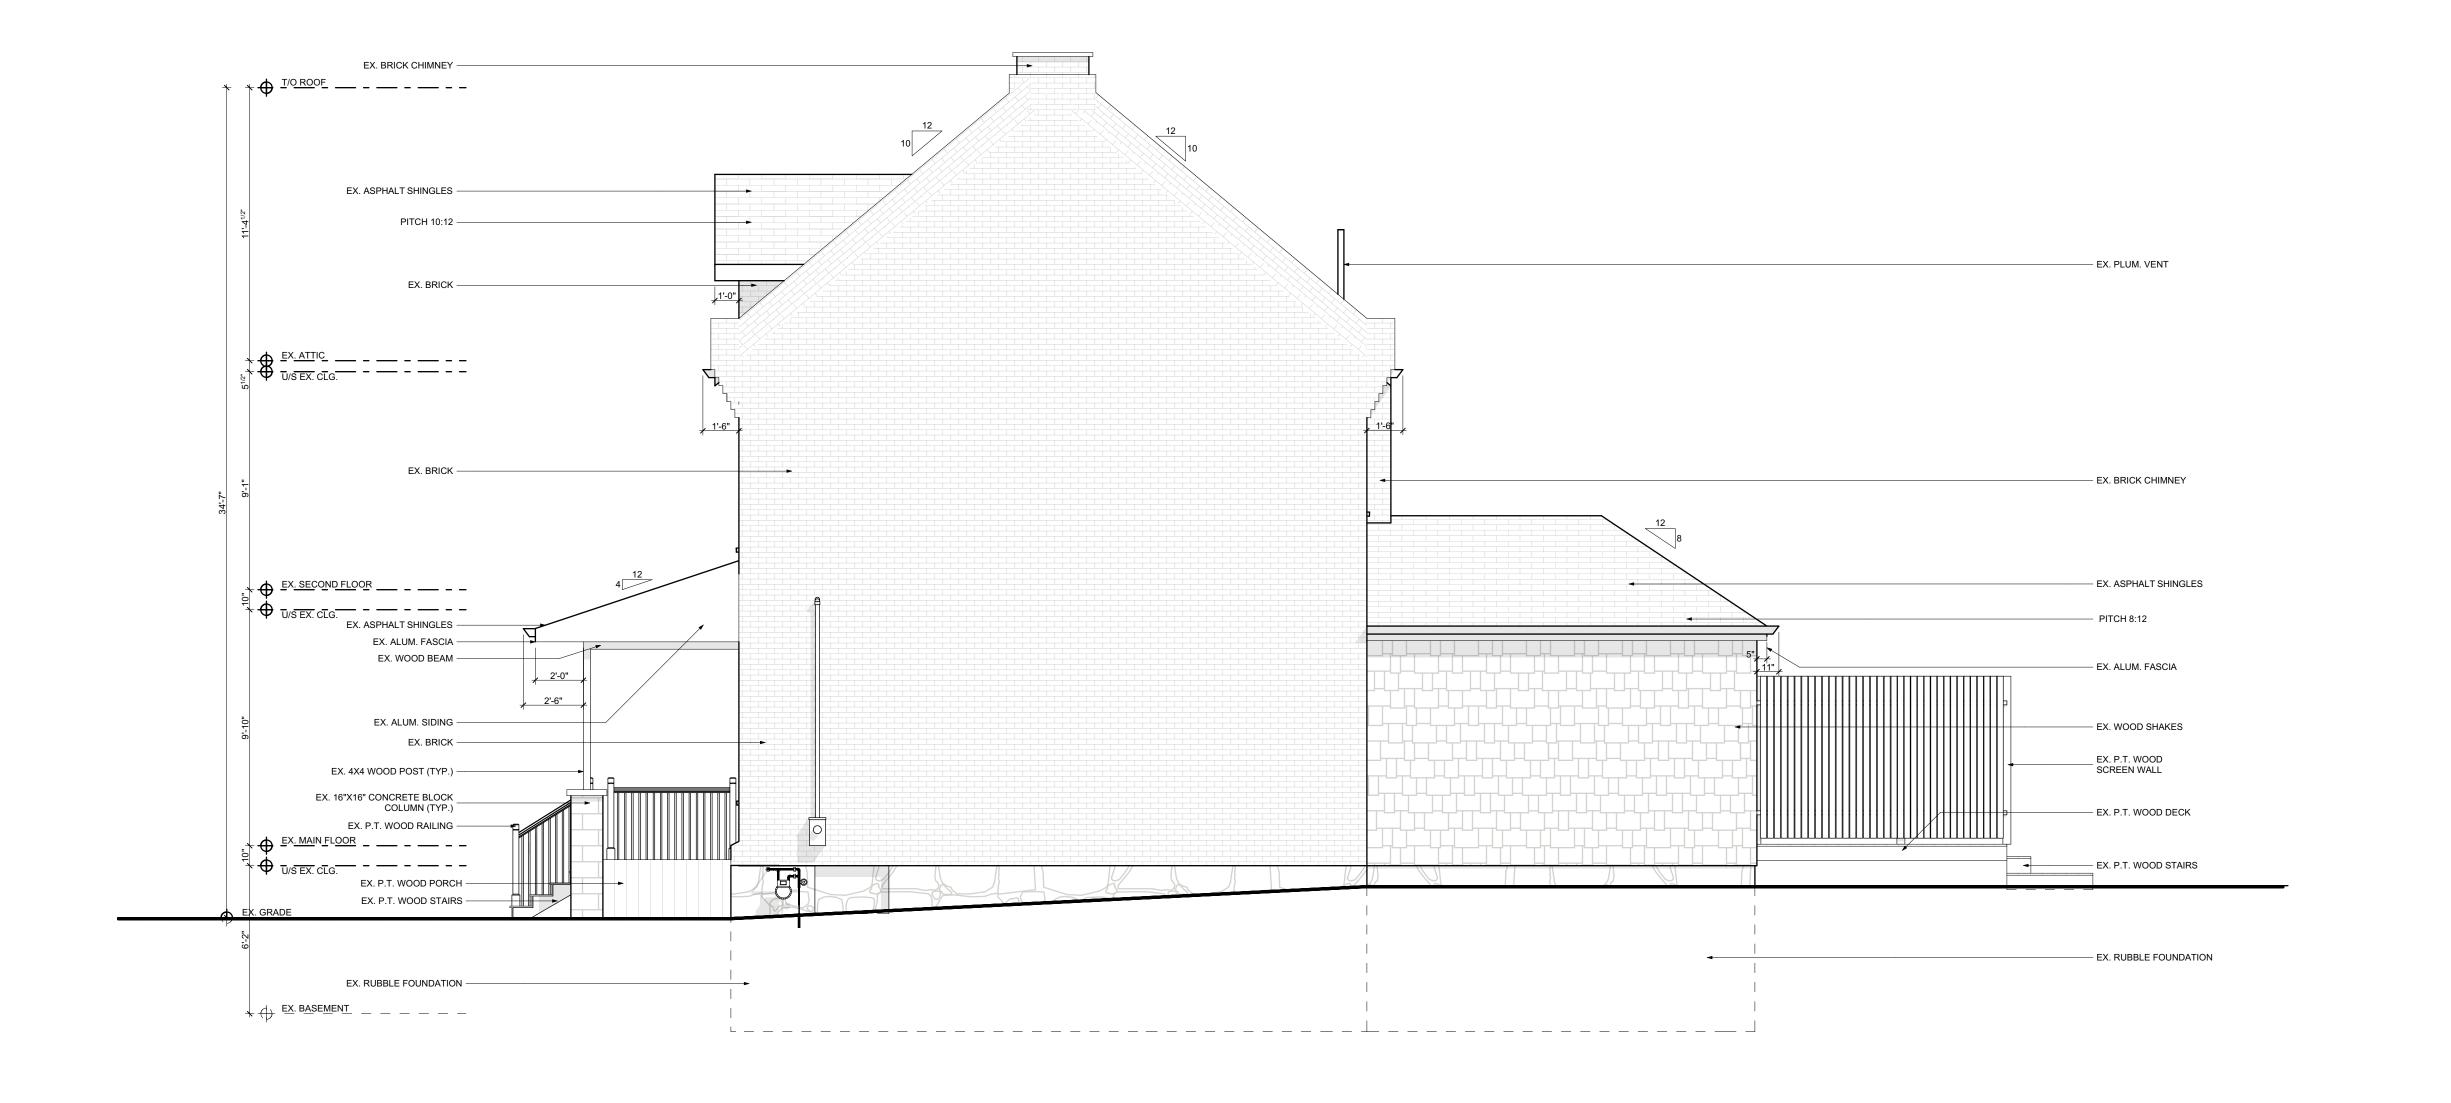



790 SHAVER RD. ANCASTER L9G 3K9 ON

NO. REVISION DATE

NO. KEVISION		DAIL	
1	DESIGN 1.0	2021.04.23	
2	DESIGN 2.0	2021.04.27	
3	DESIGN 2.1	2021.05.14	
4	DESIGN 3.0	2021.06.29	
5	ISSUED FOR MINOR VARIANCE	2021.08.04	
DRAWING:			

EXISTING RIGHT ELEVATION

PROJECT NAME: **EDWARDS**

PROJECT ADDRESS:

65 MAGILL ST HAMILTON ON L8R 2Y4

DATE: 8/4/2021


SCALE: DRAWING NO:

AS NOTED

PROJECT NO:

1 EXISTING RIGHT ELEVATION

SCALE: 1/4" = 1'-0"

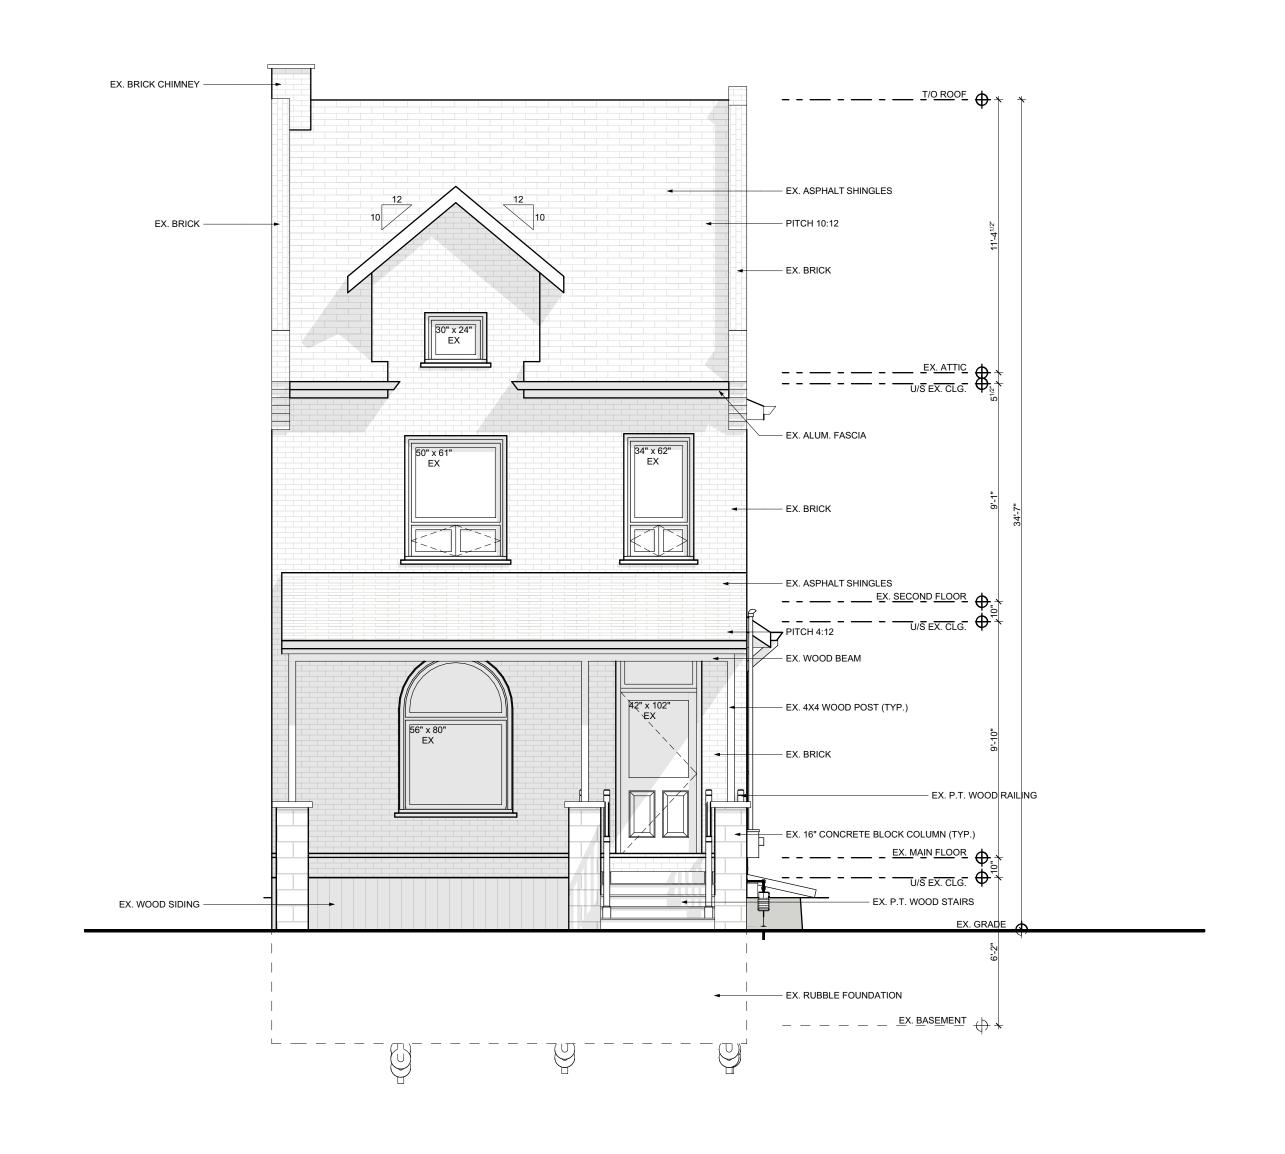





NO.	REVISION	DATE
1	DESIGN 1.0	2021.04.23
2	DESIGN 2.0	2021.04.27
3	DESIGN 2.1	2021.05.14
4	DESIGN 3.0	2021.06.29
5	ISSUED FOR MINOR VARIANCE	2021.08.04
	1 2 3 4	1 DESIGN 1.0 2 DESIGN 2.0 3 DESIGN 2.1 4 DESIGN 3.0

DRAWING:

PROPOSED FRONT **ELEVATION**

> PROJECT NAME: **EDWARDS**


PROJECT ADDRESS: 65 MAGILL ST HAMILTON ON L8R 2Y4

DATE: 8/4/2021 DRAWING NO: SCALE: AS NOTED A2.05

PROJECT NO:

1 PROPOSED FRONT ELEVATION

SCALE: 1/4" = 1'-0"

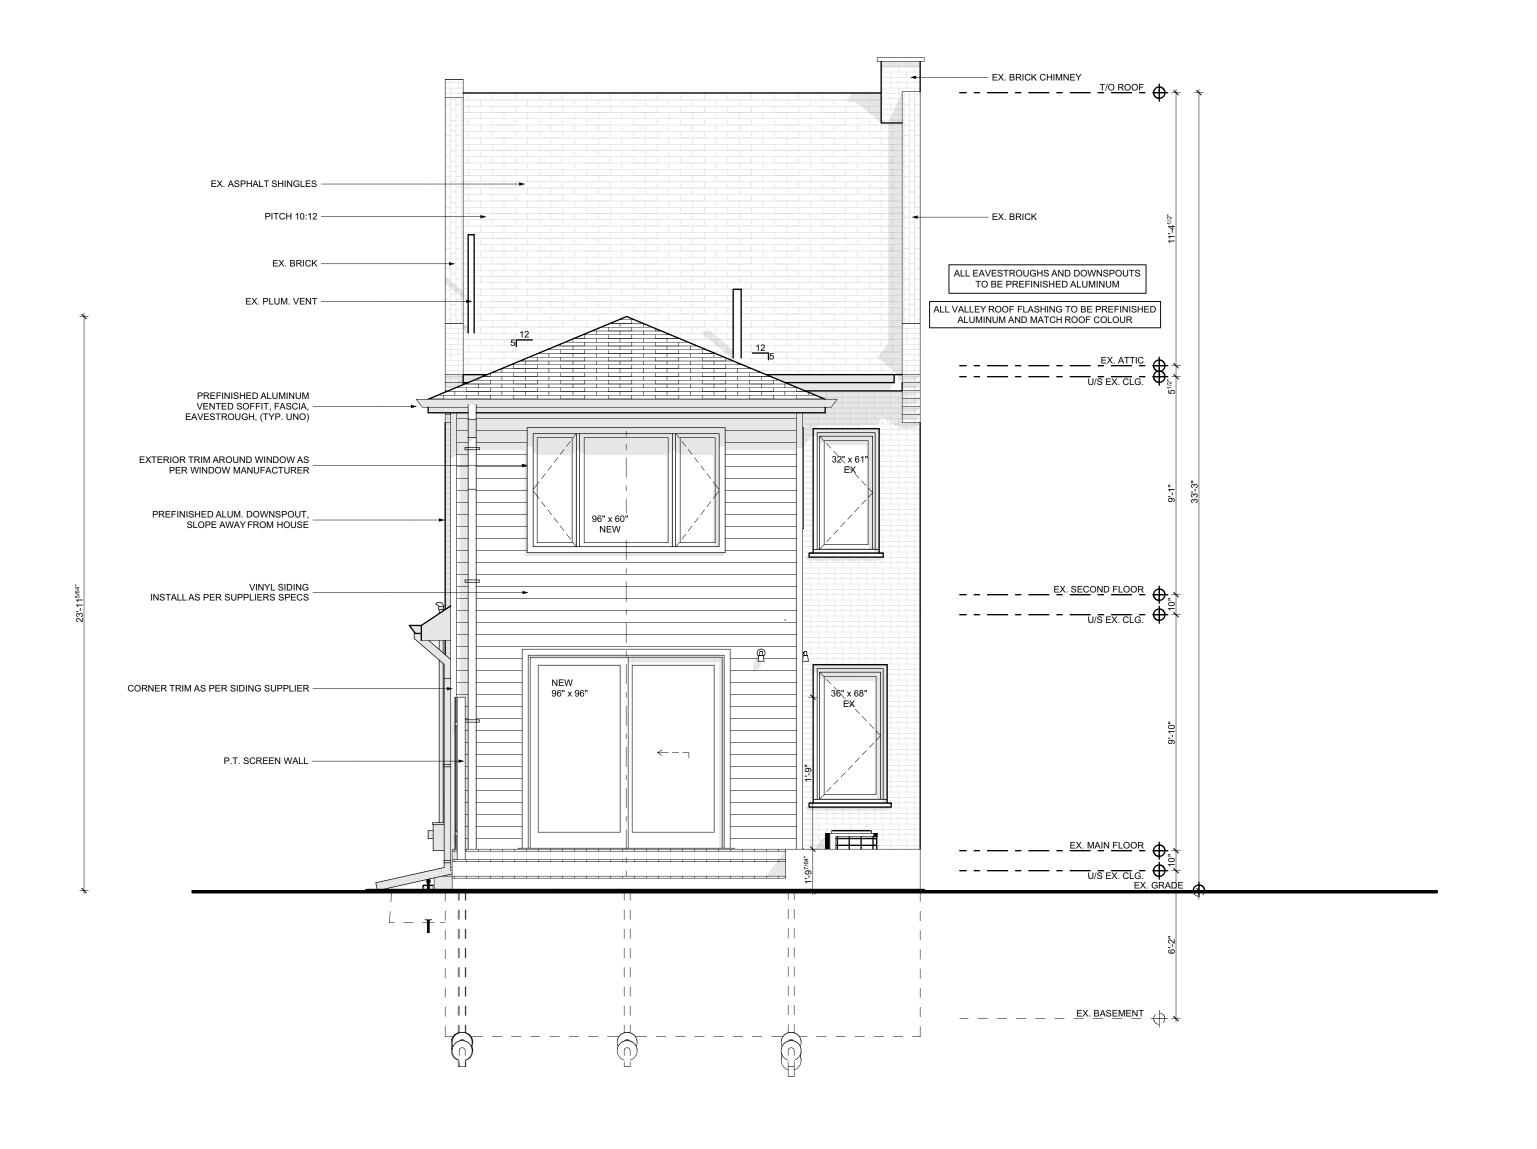





NO.	REVISION	DATE
1	DESIGN 1.0	2021.04.23
2	DESIGN 2.0	2021.04.27
3	DESIGN 2.1	2021.05.14
4	DESIGN 3.0	2021.06.29
5	ISSUED FOR MINOR VARIANCE	2021.08.04

DRAWING:

PROPOSED REAR ELEVATION

PROJECT NAME: **EDWARDS**

PROJECT ADDRESS:
65 MAGILL ST HAMILTON ON L8R 2Y4


DATE: 8/4/2021

SCALE: DRAWING NO:

AS NOTED

PROJECT NO:

AS NOTED

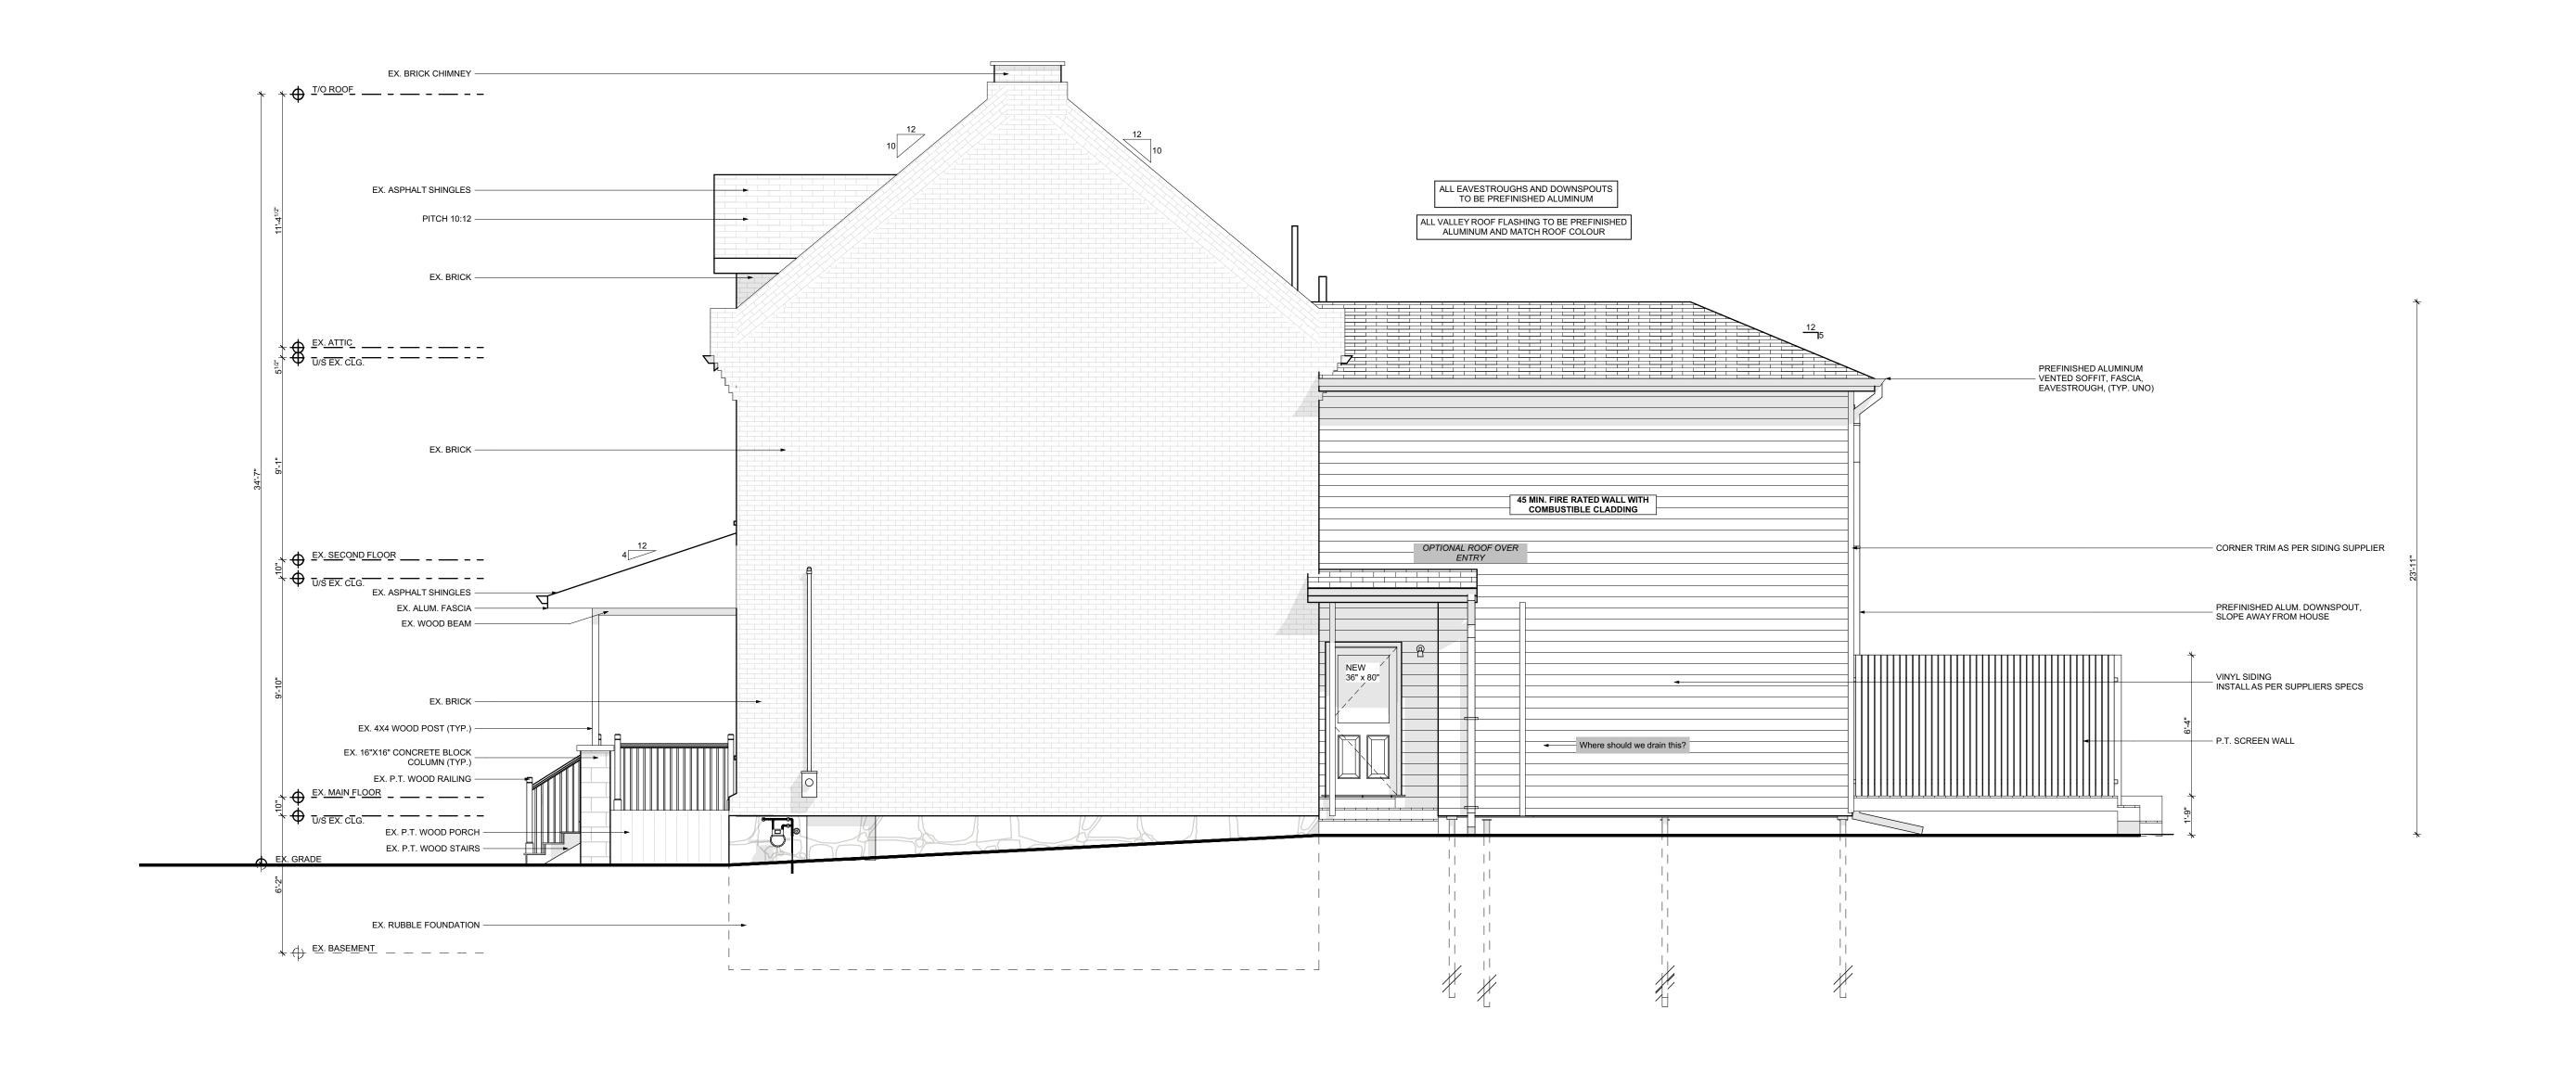



NO.	REVISION	DATE	
1	DESIGN 1.0	2021.04.23	
2	DESIGN 2.0	2021.04.27	
3	DESIGN 2.1	2021.05.14	
4	DESIGN 3.0	2021.06.29	
5	ISSUED FOR MINOR VARIANCE	2021.08.04	
DRAWING:			

PROPOSED RIGHT **ELEVATION**

PROJECT NAME:

EDWARDS PROJECT ADDRESS:


65 MAGILL ST HAMILTON ON L8R 2Y4

DATE: 8/4/2021

DRAWING NO: SCALE: AS NOTED A2.08 PROJECT NO:

1 PROPOSED RIGHT ELEVATION

SCALE: 1/4" = 1'-0"

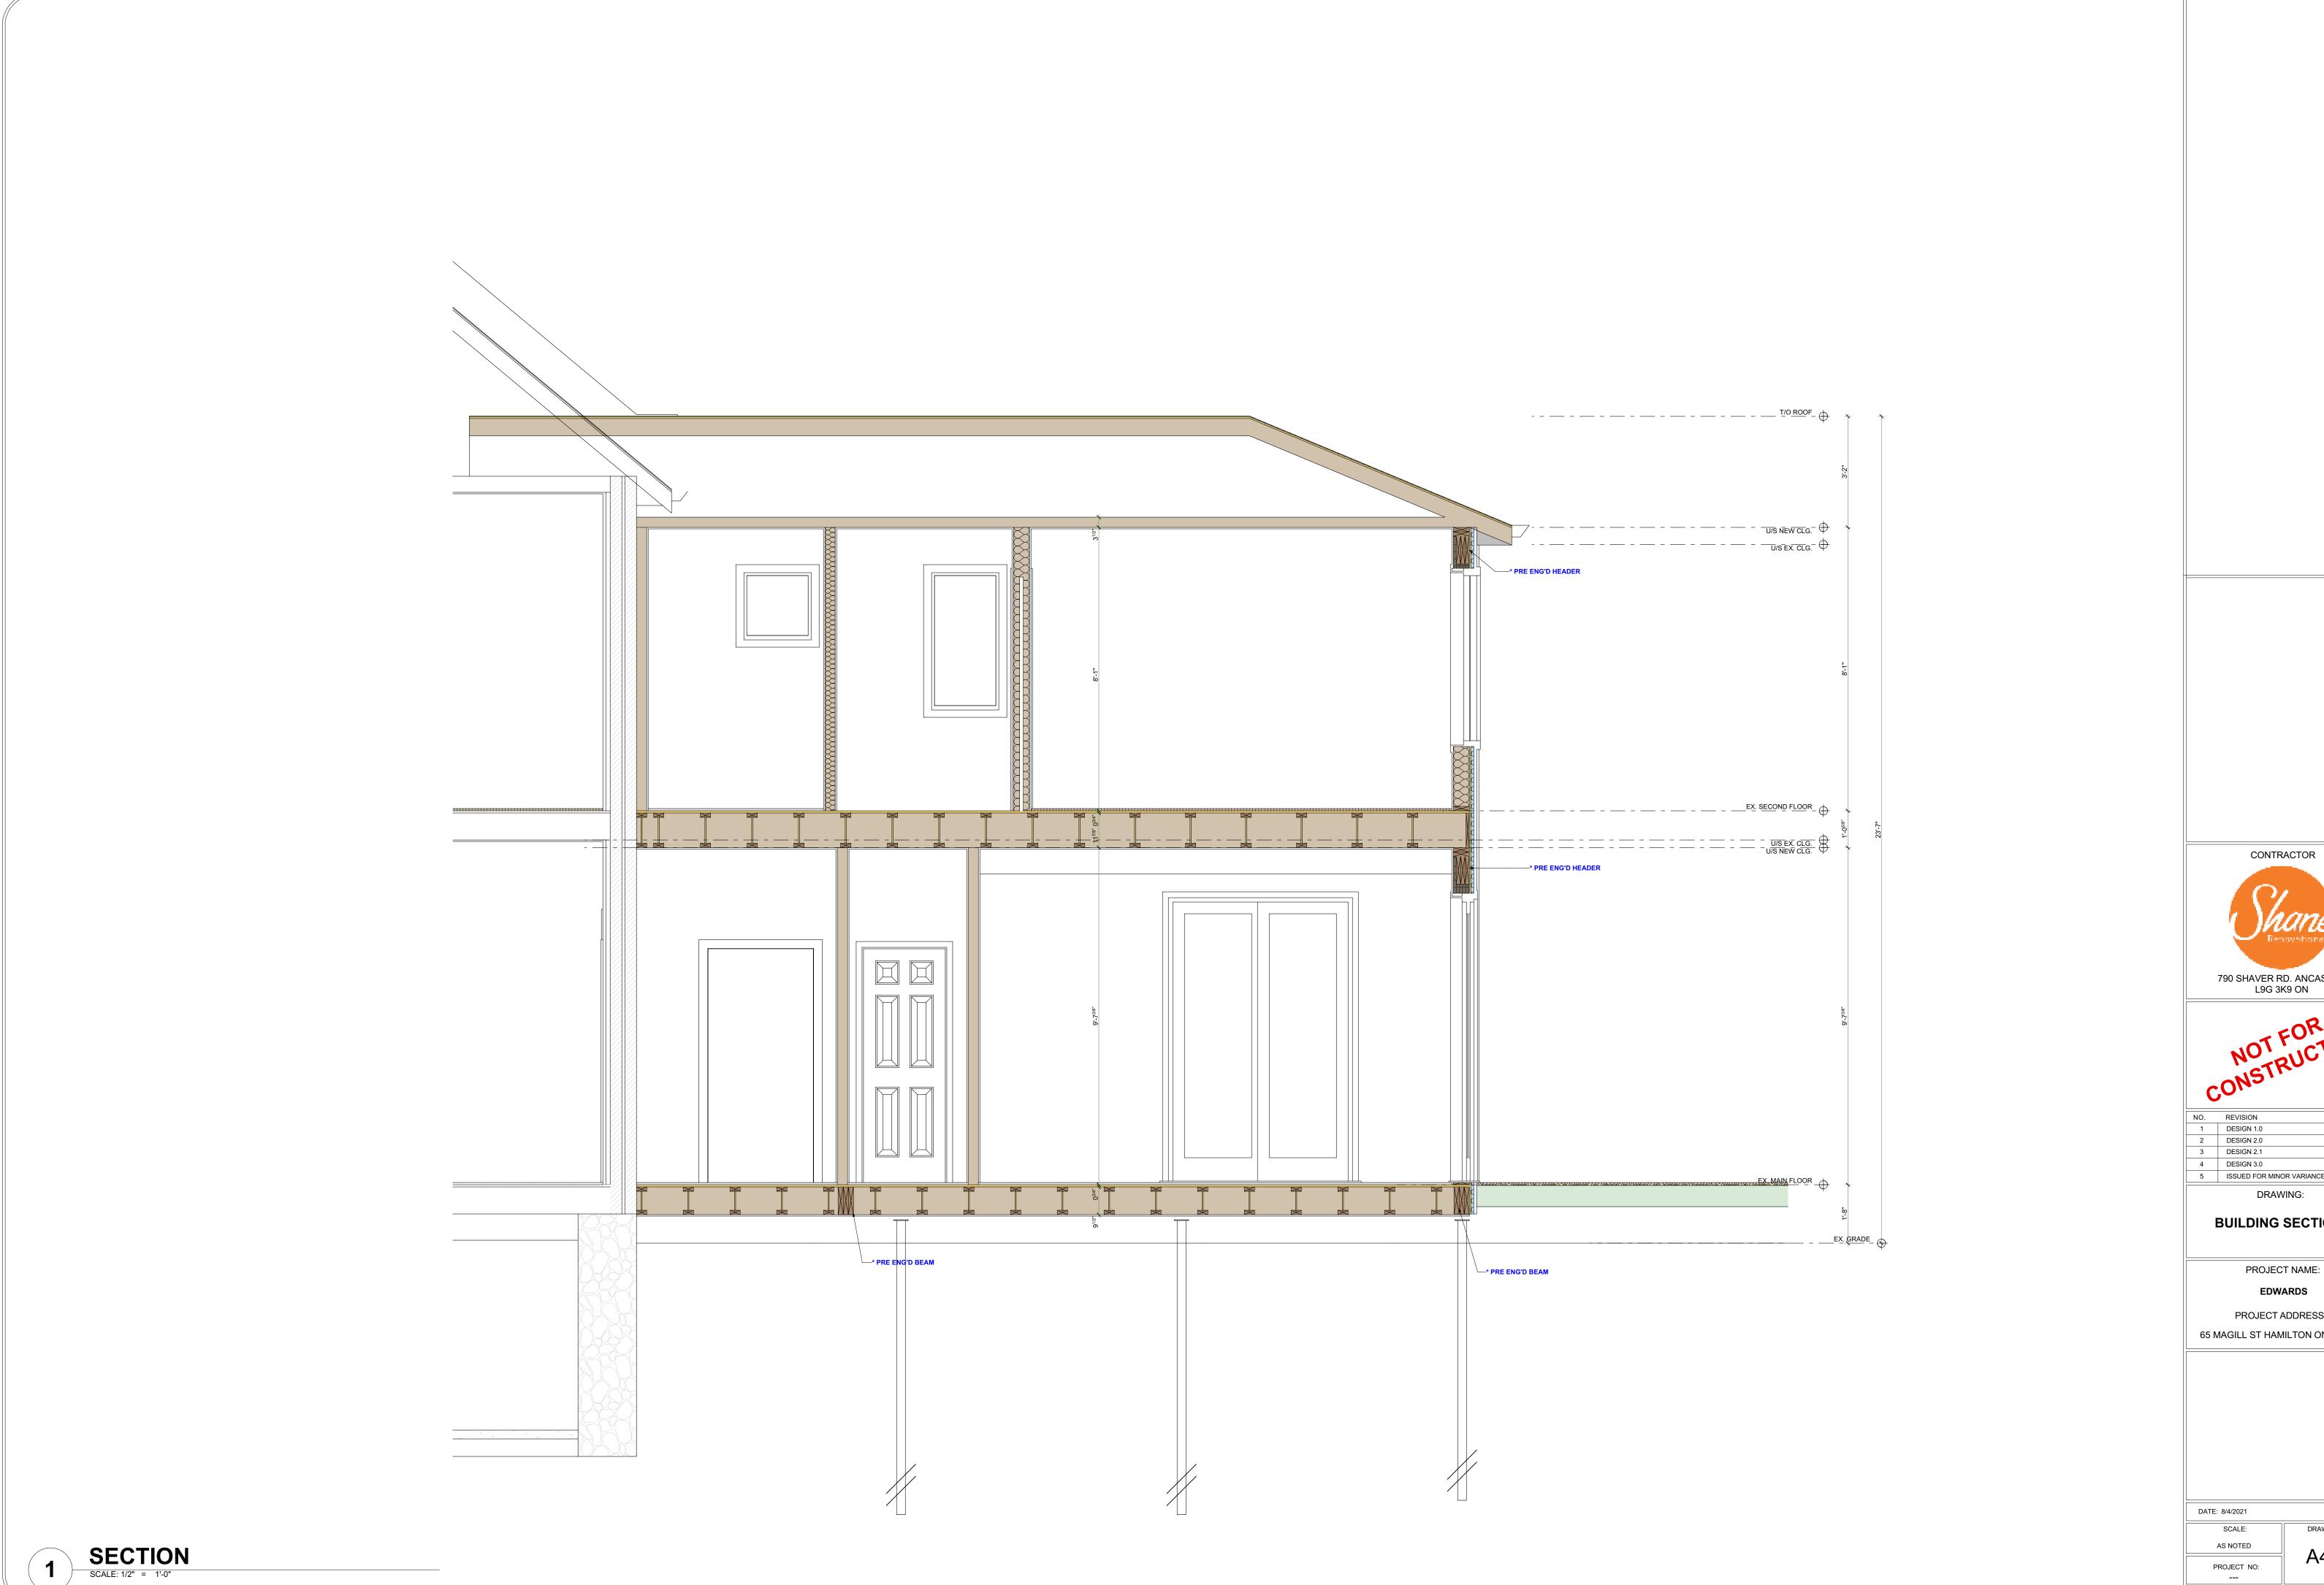




NO.	REVISION	DATE
1	DESIGN 1.0	2021.04.23
2	DESIGN 2.0	2021.04.27
3	DESIGN 2.1	2021.05.14
4	DESIGN 3.0	2021.06.29
5	ISSUED FOR MINOR VARIANCE	2021.08.04

BUILDING SECTIONS

EDWARDS

PROJECT ADDRESS: 65 MAGILL ST HAMILTON ON L8R 2Y4

DRAWING NO: A4.01

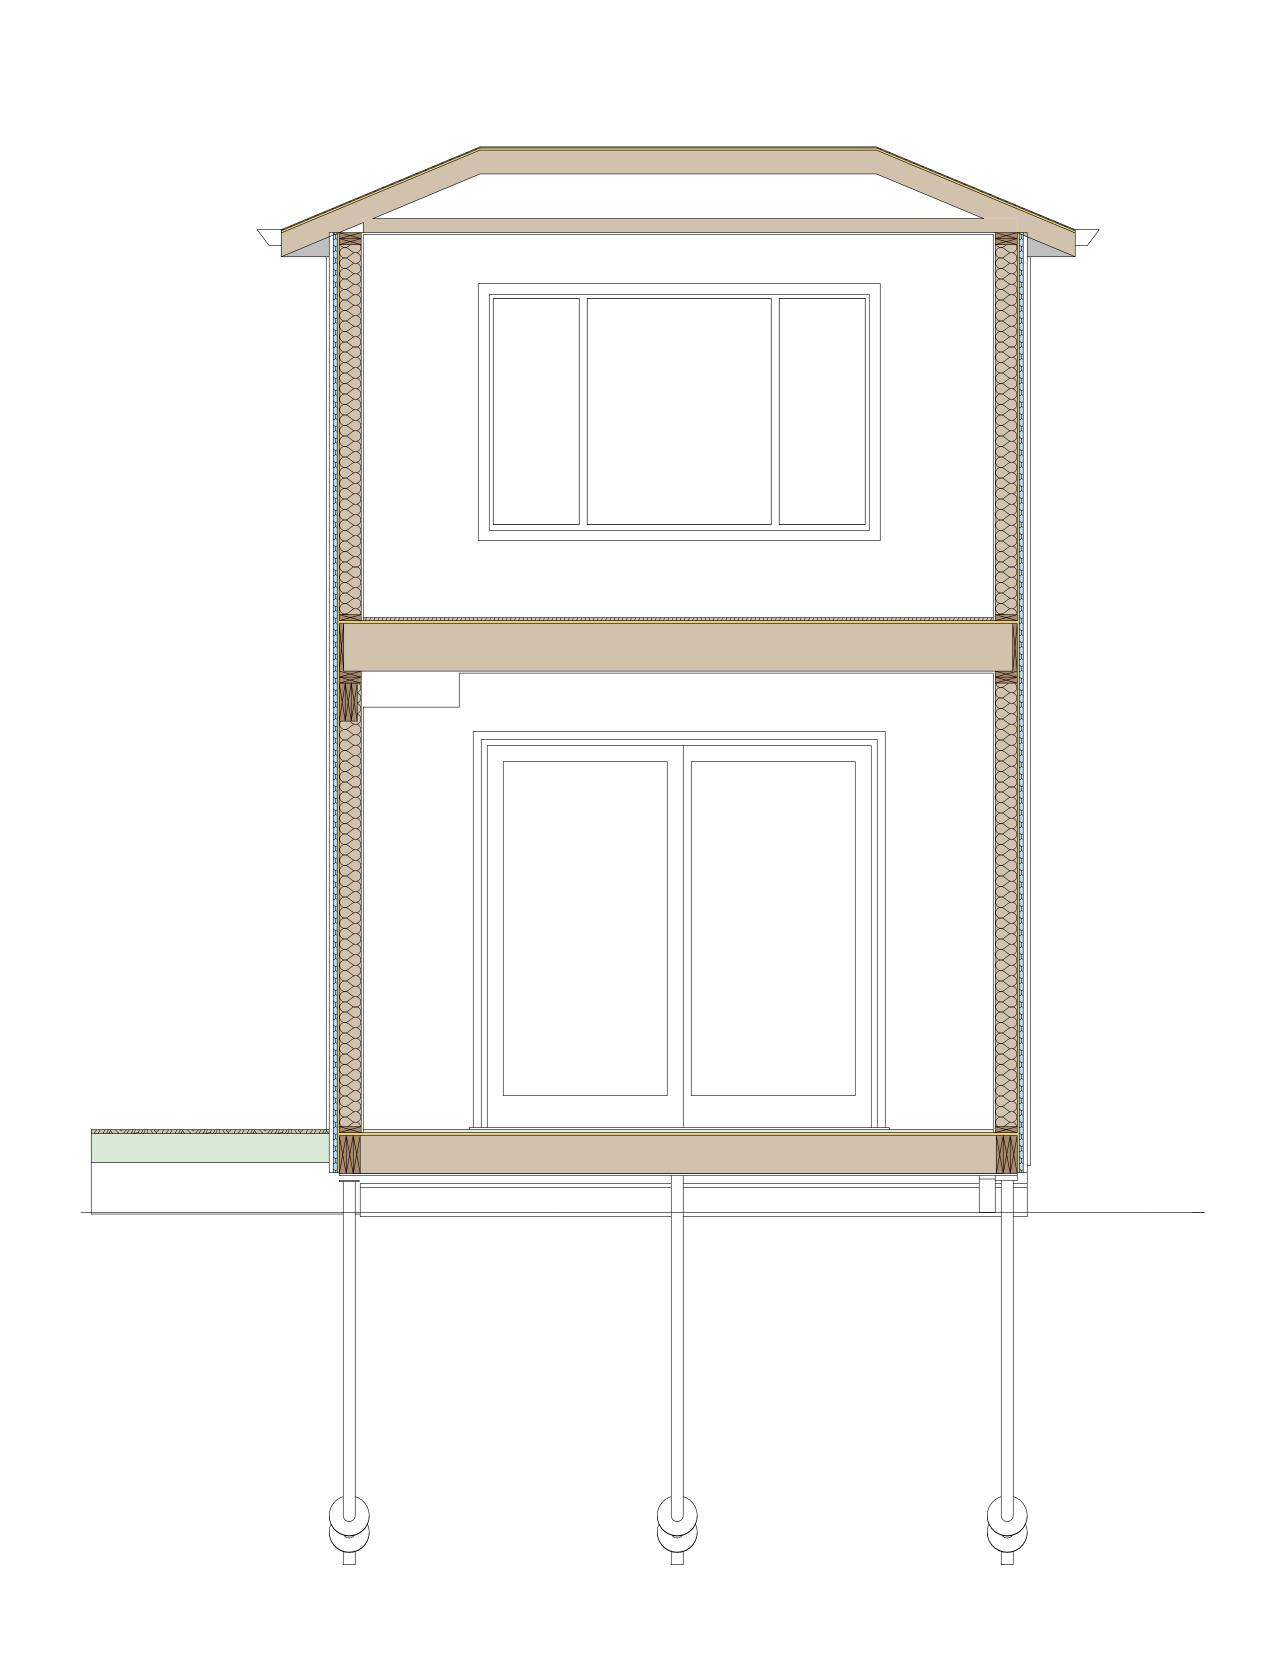



790 SHAVER RD. ANCASTER L9G 3K9 ON

NO.	REVISION	DATE	
1	DESIGN 1.0 2021.04.23		
2	DESIGN 2.0	2021.04.27	
3	DESIGN 2.1	2021.05.14	
4	DESIGN 3.0 2021.06.29		
5	5 ISSUED FOR MINOR VARIANCE 2021.08.04		
DRAWING:			


BUILDING SECTIONS

PROJECT NAME: **EDWARDS**

PROJECT ADDRESS: 65 MAGILL ST HAMILTON ON L8R 2Y4

DATE: 8/4/2021 SCALE:

DRAWING NO: AS NOTED A4.02 PROJECT NO:

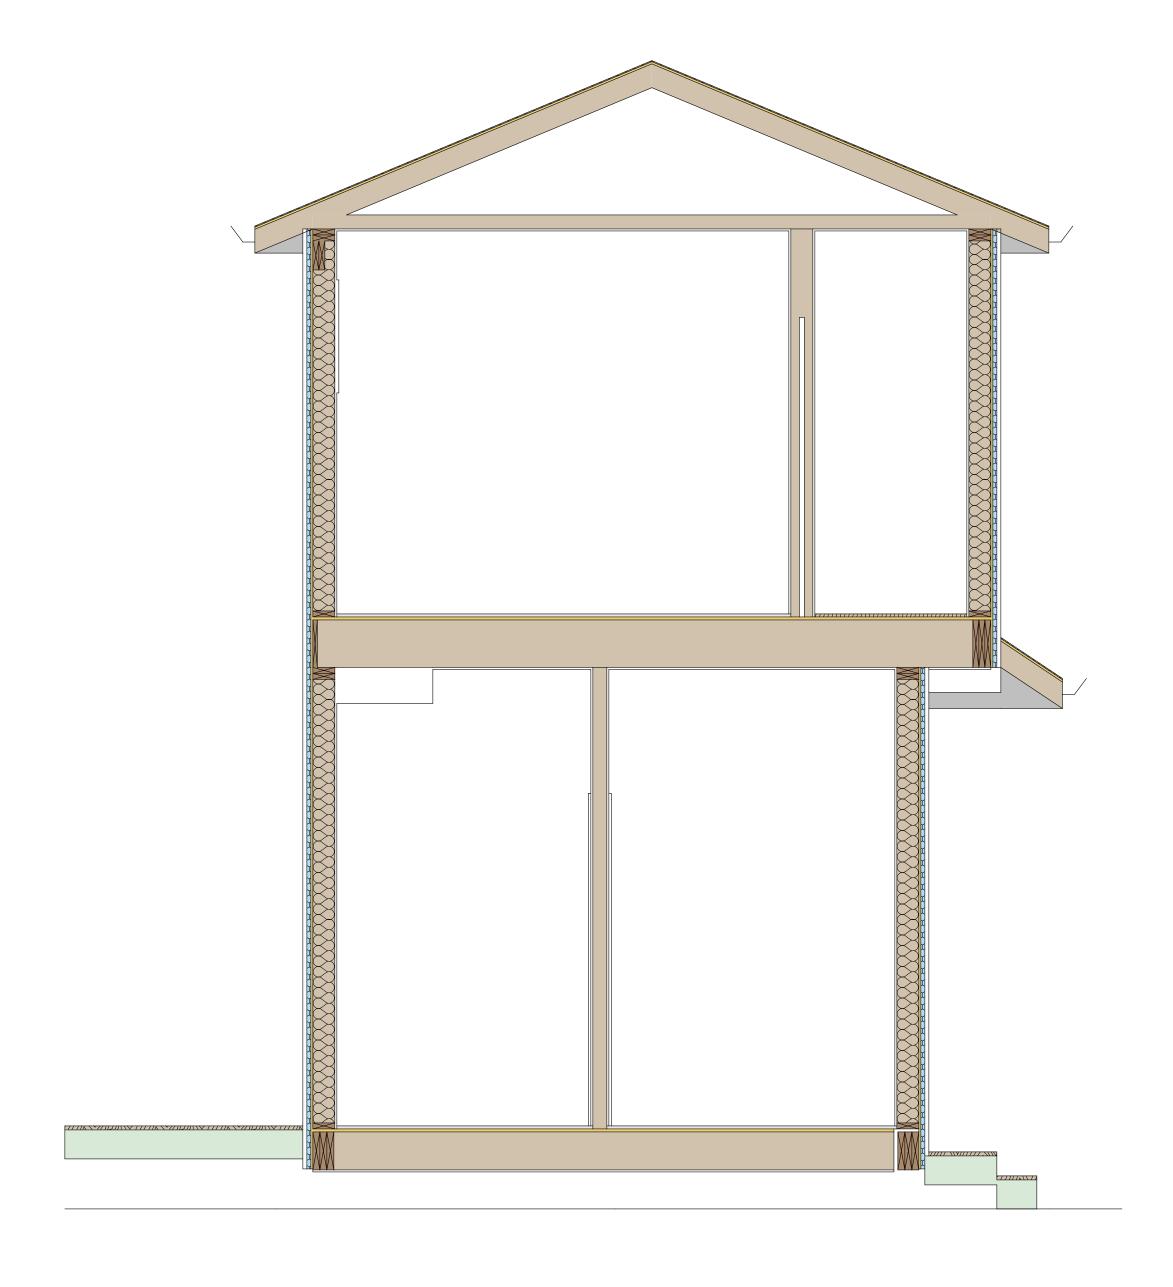



NO.	REVISION	DATE
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2	DESIGN 2.0	2021.04.27
3	DESIGN 2.1	2021.05.14
4	DESIGN 3.0	2021.06.29
5	ISSUED FOR MINOR VARIANCE	2021.08.04

BUILDING SECTIONS

DRAWING:

PROJECT NAME: **EDWARDS**


PROJECT ADDRESS:

65 MAGILL ST HAMILTON ON L8R 2Y4

DATE: 8/4/2021

SCALE: AS NOTED PROJECT NO:

DRAWING NO: A4.03

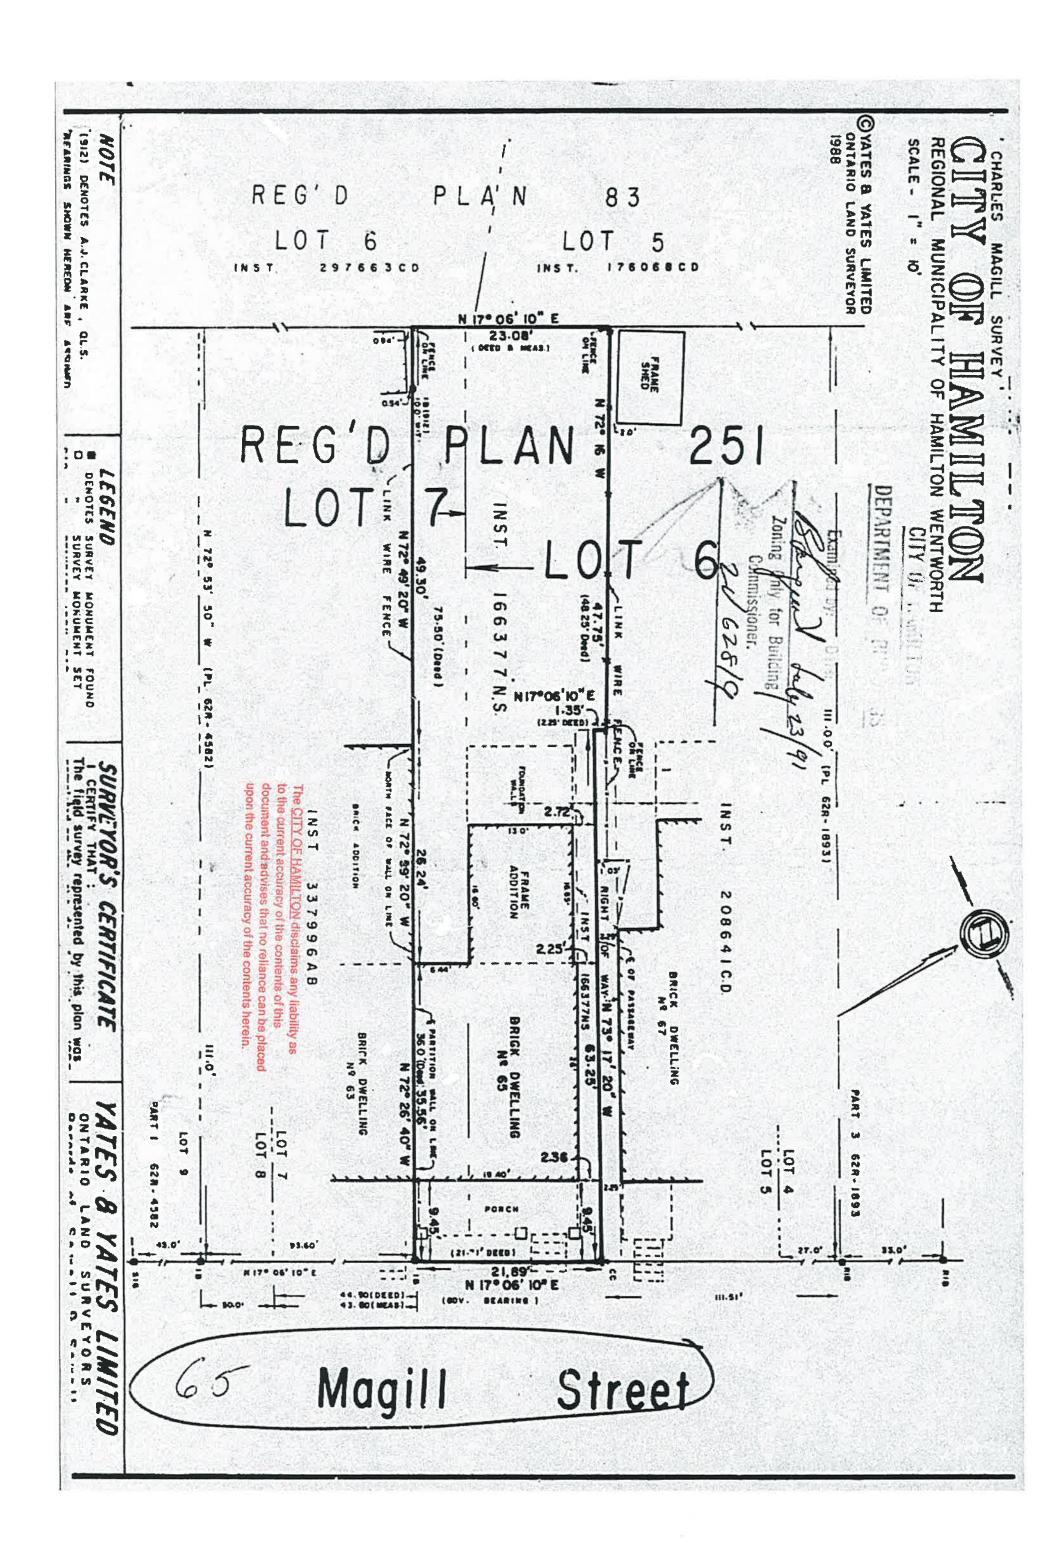



Committee of Adjustment
City Hall, 5th Floor,
71 Main St. W.,

Hamilton, ON L8P4Y5

Phone: (905) 546-2424 ext. 4221 Email: cofa@hamilton.ca

APPLICATION FOR A MINOR VARIANCE

FOR OFFICE USE ONLY	
APPLICATION NO	DATE APPLICATION RECEIVED
PAID	DATE APPLICATION DEEMED COMPLETE
SECRETARY'S SIGNATURE	

The Planning Act

Application for Minor Variance or for Permission

The undersigned hereby applies to the Committee of Adjustment for the City of Hamilton under Section 45 of the *Planning Act*, R.S.O. 1990, Chapter P.13 for relief, as described in this application, from the Zoning By-law.

1, 2	NAME	ADDRESS	
Registered Owners(s)	STEPHEN ANDREW EDWARDS & CAITLIN ELISE CHEVREAU		
Applicant(s)*	SHANE VAN BARNEVELD		
Agent or Solicitor	SHANE VAN BARNEVELD		

Note: Unless otherwise requested all communications will be sent to the agent, if any.

3. Names and addresses of any mortgagees, holders of charges or other encumbrances:

Stephen Edwards & Caitlin Chevreau 65 Magill St. Hamilton, ON L8R 2Y4 Canada

Additional sheets can be submitted if there is not sufficient room to answer the following questions. Additional sheets must be clearly labelled

- 4. Nature and extent of relief applied for:
 1- To permit 0 parking space instead the required 2 parking spaces.
 2-To permit 0.60m left side (east) yard setback for the proposed rear addition instead of 1.2m and its roof projection 0.46m.
 3- To permit the rear/side deck to project to property line instead of minimum required
 - 3- To permit the rear/side deck to project to property line instead of minimum required setback of 0.50m.
- 5. Why it is not possible to comply with the provisions of the By-law?
 The proposed rear addition cannot comply with the current zoning by-law re

The proposed rear addition cannot comply with the current zoning by-law regulations due to the existing non-conforming lot size.

6.	Legal description and Address of subject lands (registered plan number and lot number or other legal description and where applicable, street and street number): PT LTS 6 & 7, PL 251, SHOWN AS MAGILL SURVEY NORTH PT, AS IN			
	CD498162, S/T & T/W CD498162 ; HAMILTON			
	65 Magill St, Hamilton, ON, L8R 2Y4			
7.	PREVIOUS USE OF PROPERTY			
	Residential Commercial			
	Agricultural Vacant Vacant			
	Other N/A			

	Other N/A
8.1	If Industrial or Commercial, specify use N/A
8.2	Has the grading of the subject land been changed by adding earth or other material, i.e. has filling occurred?
	Yes O No Unknown O
8.3	Has a gas station been located on the subject land or adjacent lands at any time?
	Yes O No Unknown
8.4	Has there been petroleum or other fuel stored on the subject land or adjacent lands?
	Yes No Unknown
8.5	Are there or have there ever been underground storage tanks or buried waste on the subject land or adjacent lands?
	Yes O No Unknown O
8.6	Have the lands or adjacent lands ever been used as an agricultural operation where cyanide products may have been used as pesticides and/or sewage sludge was applied to the lands?
	Yes No Unknown O
8.7	Have the lands or adjacent lands ever been used as a weapon firing range? Yes No Unknown
8.8	Is the nearest boundary line of the application within 500 metres (1,640 feet) of the fill area of an operational/non-operational landfill or dump? Yes No Unknown
8.9	If there are existing or previously existing buildings, are there any building materials

remaining on site which are potentially hazardous to public health (eg. asbestos, PCB's)?

Unknown (

No 💿

	Yes N	adjacent sites? lo <u> </u>	own O
8.11		d you use to determine subjected propert	ne the answers to 9.1 to 9.10 above? y.
8.12	previous use invent		r commercial or if YES to any of 9.2 to 9.10, a er uses of the subject land, or if appropriate, the ded.
	Is the previous use	inventory attached?	Yes No (N/A)
9.	ACKNOWLEDGEN	MENT CLAUSE	
	remediation of conta		s not responsible for the identification and perty which is the subject of this Application – by
	8/5/2021		Stephen Edwards
	Date		Signature Property Owner
			Stephen Edwards
			Print Name of Owner
10.	Dimensions of lands		
	Frontage	6.67 m	
	Depth	34.00 m 242.81m ²	_
	Area Width of street		NFIRMED BY PUBLIC WORKS)
11.			
	Proposed See attached plans	s.	
12.		rear and front lot line	n or proposed for the subject lands; (Specify s)
	Proposed: See attached plans	s.	

8.10 Is there any reason to believe the subject land may have been contaminated by former

13.	Date of acquisition of subject lands: July 10, 2018
14.	Date of construction of all buildings and structures on subject lands: May 13, 1989
15.	Existing uses of the subject property: RESIDENTIAL
16.	Existing uses of abutting properties: RESIDENTIAL
17.	Length of time the existing uses of the subject property have continued: SINCE BUILT
18.	Municipal services available: (check the appropriate space or spaces) Water YES Connected -
	Sanitary Sewer YES Connected - Storm Sewers YES
19.	Present Official Plan/Secondary Plan provisions applying to the land: N/A
20.	Present Restricted Area By-law (Zoning By-law) provisions applying to the land: N/A
21.	Has the owner previously applied for relief in respect of the subject property? Yes No
	If the answer is yes, describe briefly. N/A
22.	Is the subject property the subject of a current application for consent under Section 53 of the <i>Planning Act</i> ? Yes
23.	Additional Information N/A
24.	The applicant shall attach to each copy of this application a plan showing the dimensions of the subject lands and of all abutting lands and showing the location, size and type of a buildings and structures on the subject and abutting lands, and where required by the Committee of Adjustment such plan shall be signed by an Ontario Land Surveyor.