COMMITTEE OF ADJUSTMENT



City Hall, 5th floor, 71 Main Street West, Hamilton, ON L8P 4Y5 Telephone (905) 546-2424, ext. 4221, 3935 Fax (905) 546-4202

E-mail: cofa@hamilton.ca

NOTICE OF PUBLIC HEARING Minor Variance

You are receiving this notice because you are either:

- Assessed owner of a property located within 60 metres of the subject property
- Applicant/agent on file, or
- Person likely to be interested in this application

APPLICATION NO.: HM/A-21:314

APPLICANTS: Owner Su Ming Feng

SUBJECT PROPERTY: Municipal address 155 Howard Ave., Hamilton

ZONING BY-LAW: Zoning By-law 6593, as Amended

ZONING: C district (Urban Protected Residential and Etc.)

PROPOSAL: To permit a secondary dwelling unit within an existing single family

dwelling, notwithstanding that:

1. One parking space shall have a minimum length of 5.4 metres instead of the minimum required 6.0 metres;

NOTES:

- 1. By-law 21-076 was approved by City Council on May 12, 2021 to permit secondary dwelling units in single detached, semi-detached and street townhouses in all residential districts and the H District and is in effect.
- 2. The application was written as requested by the applicant.
- 3. The parking space requirements under By-law 21-076 for Secondary Dwelling Units outside of Schedule P (lands which are generally not below the Escarpment), require the provision of three parking spaces for a dwelling with a secondary dwelling unit. Of this, 2 parking spaces are required for the principal dwelling unit and the third space, which is for the secondary dwelling unit is to be unobstructed.

This application will be heard by the Committee as shown below:

DATE: Thursday, September 23rd, 2021

TIME: 3:05 p.m.

PLACE: Via video link or call in (see attached sheet for details)

To be streamed at

www.hamilton.ca/committeeofadjustment

for viewing purposes only

HM/A-21: 314

Page 2

PUBLIC INPUT

Written: If you would like to submit written comments to the Committee of Adjustment you may do so via email or hardcopy. Please see attached page for complete instructions, including deadlines for submitting to be seen by the Committee.

Orally: If you would like to speak to this item at the hearing you may do so via video link or by calling in. Please see attached page for complete instructions, including deadlines for registering to participate.

MORE INFORMATION


For more information on this matter, including access to drawings illustrating this request:

- Visit <u>www.hamilton.ca/committeeofadjustment</u>
- Call 905-546-CITY (2489) or 905-546-2424 extension 4221, 4130, or 3935
- Email Committee of Adjustment staff at cofa@hamilton.ca

DATED: September 7th, 2021.

Jamila Sheffield, Secretary-Treasurer Committee of Adjustment

Information respecting this application is being collected under the authority of the Planning Act, R.S.O., 1990, c. P. 13. All comments and opinions submitted to the City of Hamilton on this matter, including the name, address, and contact information of persons submitting comments and/or opinions, will become part of the public record and will be made available to the Applicant and the general public.

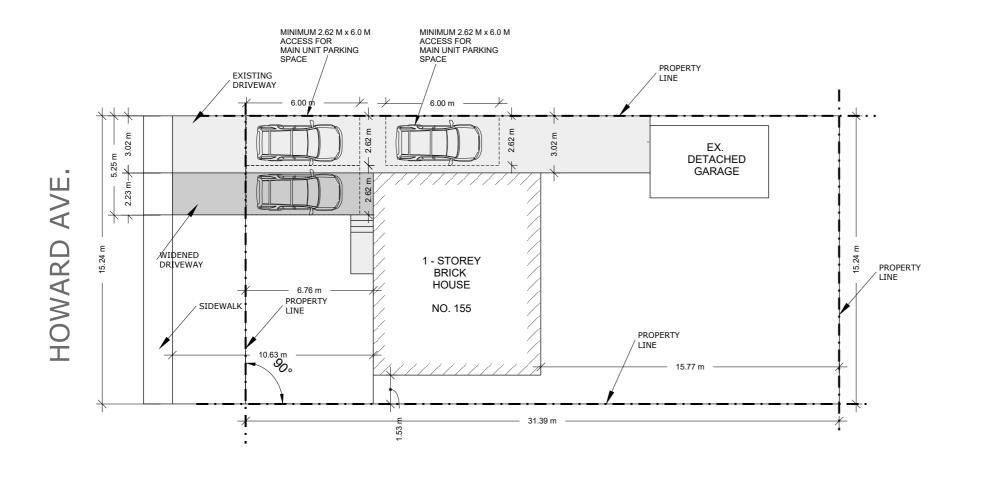

SITE PLAN:

BASED ON MAP.HAMILTON.CA AND MEASUREMENTS ON SITE

SUITE ADDITIONS INC. ASSUMES NO RESPONSIBILITY FOR ACCURACY OF MAP.HAMILTON.CA

THIS SITE PLAN SHALL NOT BE USED FOR ANY OTHER PURPOSES.

NO WORK TO ENCROACH ONTO ADJOINING PROPERTIES

FRONT YARD: 102.99 M2

LANDSCAPED AREA = 58.83 M2= 57.1%

HARD SURFACE AREA = 44.16 M2 = 42.9%





SCALE: 1:200

SITE INFORMATION & STATISTICS:

ADDRESS	155 HOWARD AV	ENUE, HAM ILTON, ON	I, L9A 2W9
NEIGHBOURHOOD			
LOT NUMBER			
PLAN NUMBER			
ZONING TYPE	C - URBAN PRO	OTECTED RESIDENT	TAL
LOT AREA	478.45 SQ. M		
LOT FRONTAGE	15.24 M		
DESCRIPTION			
FLOOR AREAS	ALLOWED	EXISTING	PROPOSED
BASEMENT	-	94.76 SQ. M.	NO CHANGE
MAIN FLOORS	-	94.76 SQ. M.	NO CHANGE
SETBACKS			
FRONT (W)	-	6.76 M	NO CHANGE
SIDE (N)	-	3.02 M	NO CHANGE
BACK (E)	-	15.77 M	NO CHANGE
SIDE (S)	-	1.53M	NO CHANGE

EXISTING STRUCTURE NOTE:

OWNER AND CONTRACTOR IS FULLY RESPONSIBLE FOR VERIFYING ALL EXISTING STRUCTURAL CONDITIONS PRIOR TO ANY WORK. ANY AND ALL DISCREPANCIES SHALL BE REPORTED TO SUITE ADDITIONS INC. PRIOR TO ANY WORK. OWNER AND CONTRACTOR IS FULLY RESPONSIBLE FOR SHORING EXISTING STRUCTURE PRIOR TO ANY WORK

GENERAL NOTES:

- ALL CONSTRUCTION TO COMPLY WITH THE REVISED ONTARIO BUILDING CODE 2012.
 ALL DIMENSION ARE MEASURED TO ROUGH FRAMING OR TO MASONRY SURFACES UNLESS.
- 3. ALL DOORS AND WINDOW OPENINGS ARE MEASURED TO ROUGH FRAMING OR MASONRY OPENINGS. 4. CONTRACTOR IS TO VERIFY WINDOW OPENINGS WITH WINDOW MANUFACTURER PRIOR TO COMMENCING WORK.
- 5. READ ARCHITECTURAL DRAWINGS IN CONJUNCTION WITH STRUCTURAL, MECHANICAL AND ELECTRICAL DRAWINGS.
- 6. ELEVATION REFERENCES ARE BASED ON 100'-0" = 131.70m GEODETIC ELEVATIONS AS NOTED ON A1 7. ALL DIMENSION MUST BE CHECKED AGAINST THE ARCHITECTURAL DRAWINGS AND THE FIELD
- CONDITIONS BEFORE COMMENCING FABRICATION. ANY INCONSISTENCIES ARE TO BE REPORTED TO THE CONSULTANT BEFORE PROCEEDING WITH THE WORK. 8 THE CONTRACTOR SHALL PROPERLY SUPERVISE THE WORK AND ENSURE THAT THE WORK IS INSTALLED TO THE CORRECT LINES AND LEVELS, THAT THE CONNECTIONS AND DETAILS CONFORM TO
- THE DRAWING DETAILS AND SHALL COORDINATE THE INTERFACING OF ALL WORK WITH ALL SUB-TRADES PROVIDE POSITIVE FRONT YARD SLOPE TO MUNICIPAL SEWER FOR WATER RUN-OFF. 10. CONTRACTOR TO BE RESPONSIBLE FOR VERIFYING THE LOCATIONS OF ALL EXISTING UNDERGROUND AND ABOVE UTILITIES AND SERVICES. VARIOUS UTILITIES CONCERNED TO BE GIVEN REQUIRED
- ADVANCED NOTICE PRIOR TO ANY DIGGING, FOR STAKE OUT. 11. REFER TO LANDSCAPING PLAN FOR PLANTING CONFIRM LAYOUT WITH LANDSCAPE CONTRACTOR.
- 12. DESIGNER NOT RESPONSIBLE FOR ACCURACY OF SURVEY DRAWING.

13. EXISTING DRAINAGE PATTERNS TO REMAIN.

AND DRAWING LIST

A1.01 - EXISTING BASEMENT LEVEL

A1.02 - EXISTING MAIN LEVEL PLAN A1.03 - PROPOSED BASEMENT LEVEL

A1.04 - PROPOSED MAIN LEVEL PLAN

A2.01 - WEST ELEVATION

A3.01 - SOUTH SECTION DETAILS

A5.01 - CONSTRUCTION

SPECIFICATIONS A5.03 - CONSTRUCTION

BUILDING CODE COMPLIANCE NOTE:

THESE DRAWINGS DO NOT REPRESENT A COMPREHENSIVE AND EXHAUSTIVE GUIDE FOR COMPLIANCE WITH THE ONTARIO BUILDING CODE. IT IS ASSUMED THAT THE CONTRACTOR HAS REASONABLY SUFFICIENT KNOWLEDGE OF THE ONTARIO BUILDING CODE IN ORDER TO PERFORM ALL WORK AS PER THESE DRAWINGS IN SUCH A WAY THAT WILL COMPLY WITH ALL ASPECTS OF THE OBC AND WILL NOT CONTRAVENE ANY OTHER APPLICABLE LAWS

DRAWING LIST:

SP1.01 - SITE PLAN, SITE STATISTICS

PLAN

PLAN

A2.02 - NORTH ELEVATION

A2.03 - EAST ELEVATION

A3.02 - FIRE RESISTANCE RATING DETAILS

SPECIFICATIONS A5.02 - CONSTRUCTION

SPECIFICATIONS

SITE PLAN, SITE STATISTICS AND DRAWING LIST

SCALE: 1:200

DRAWING NO:

SP1.01



SUITE ADDITIONS INC.

Toronto, ON, M1S 3L6 Tel: 416-525-2628 info@suiteadditions.com

drawings

Contractor must verify all dimensions and be responsible for reporting any discrepancies to Suite Additions Inc. before commencing with work. The drawing is an instrument of service and shall remain the property of Suite Additions Inc. the copyright of this drawing and work executed from the same being reserved. Do not scale

The undersigned has reviewed and takes

responsibility for this design, and has the qualifications and meets the requirements set out in the Ontario Building Code to be a designed

Chily Stan

2 FAMILY DWELLING

CLIENT: SUMING FENG

DRAWN BY: ANDY TRAN

155 HOWARD AVENUE, HAM ILTON,

RE-ISSUE DATE:

FEB 05, 2020

JUL 09, 2020

Andy Tran - Signature Individual BCIN: 102774

Firm: Suite Additions Inc. Firm BCIN: 102497

PROJECT:

CONVERSION


ADDRESS:

ON, L9A 2W9

ISSUE DATE:

MAR 05, 2020

DESCRIPTION:

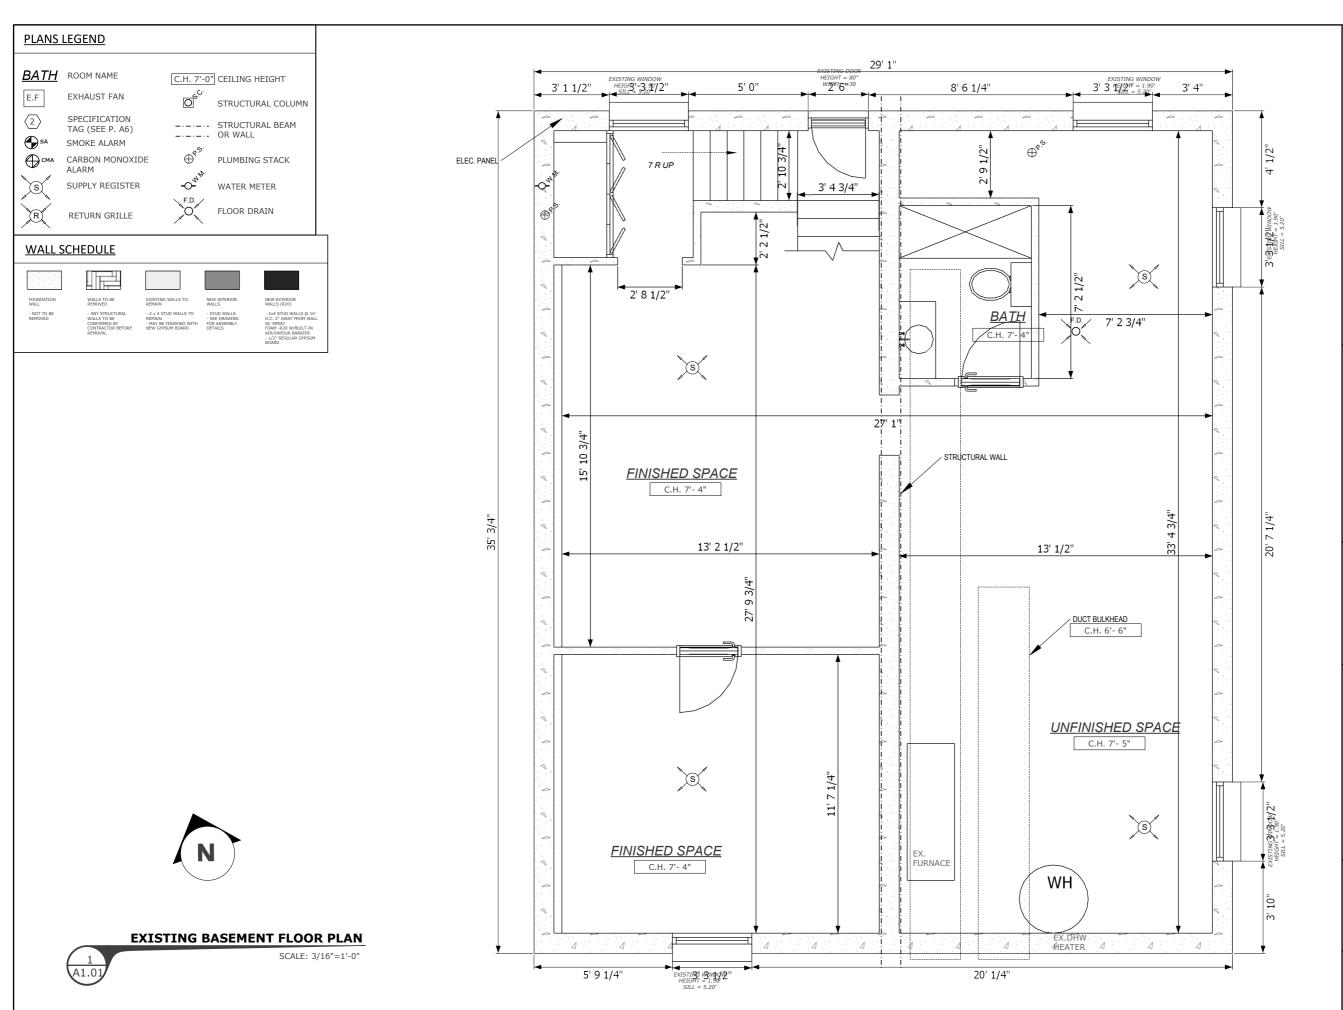

SUITE ADDITIONS INC. 3-2375 Brimley Rd, Suite 807 Toronto, ON, M1S 3L6 Tel: 416-525-2628 info@suiteadditions.com



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Wily Than Andy Tran - Signature Individual BCIN: 102774 Firm: Suite Additions Inc. Firm BCIN: 102497

PROJECT: **2 FAMILY DWELLING CONVERSION**

ADDRESS:

155 HOWARD AVENUE, HAM ILTON, ON, L9A 2W9

CLIENT: SUMING FENG

DRAWN BY: ANDY TRAN

ISSUE DATE:

RE-ISSUE DATE: MAR 05, 2020


DESCRIPTION:


EXISTING BASEMENT LEVEL FLOOR PLAN


SCALE: 3/16" = 1'-0"

DRAWING NO:

A1.01

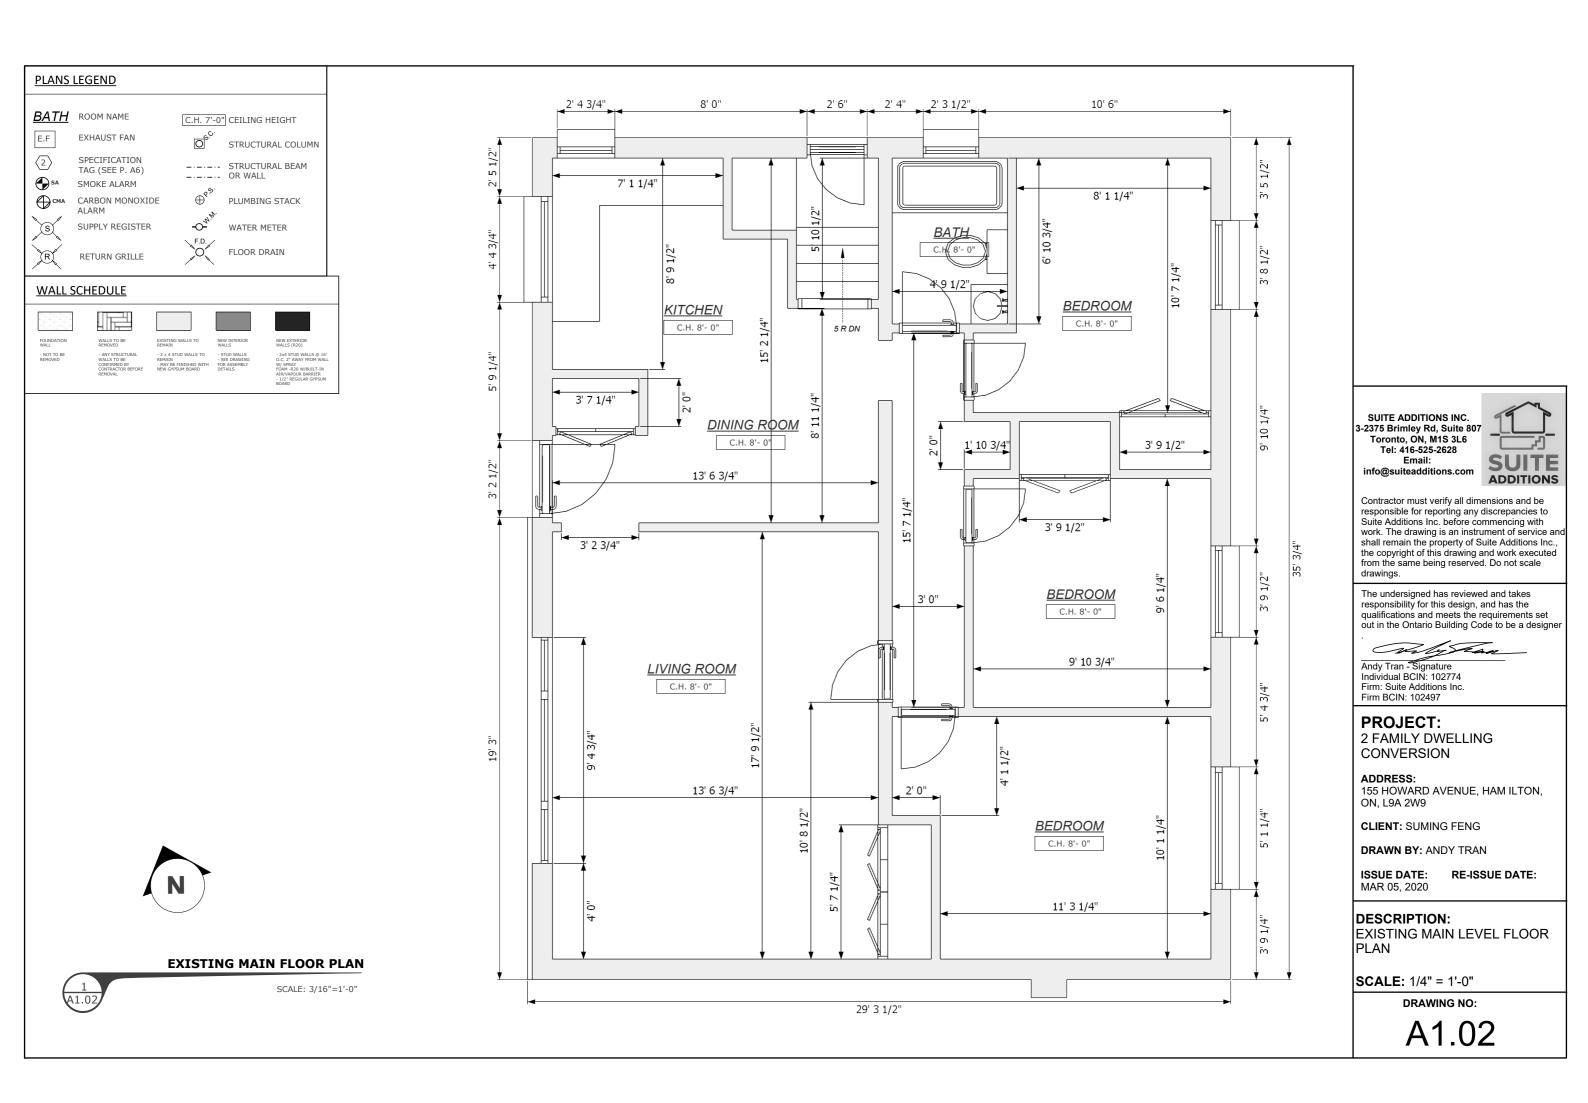

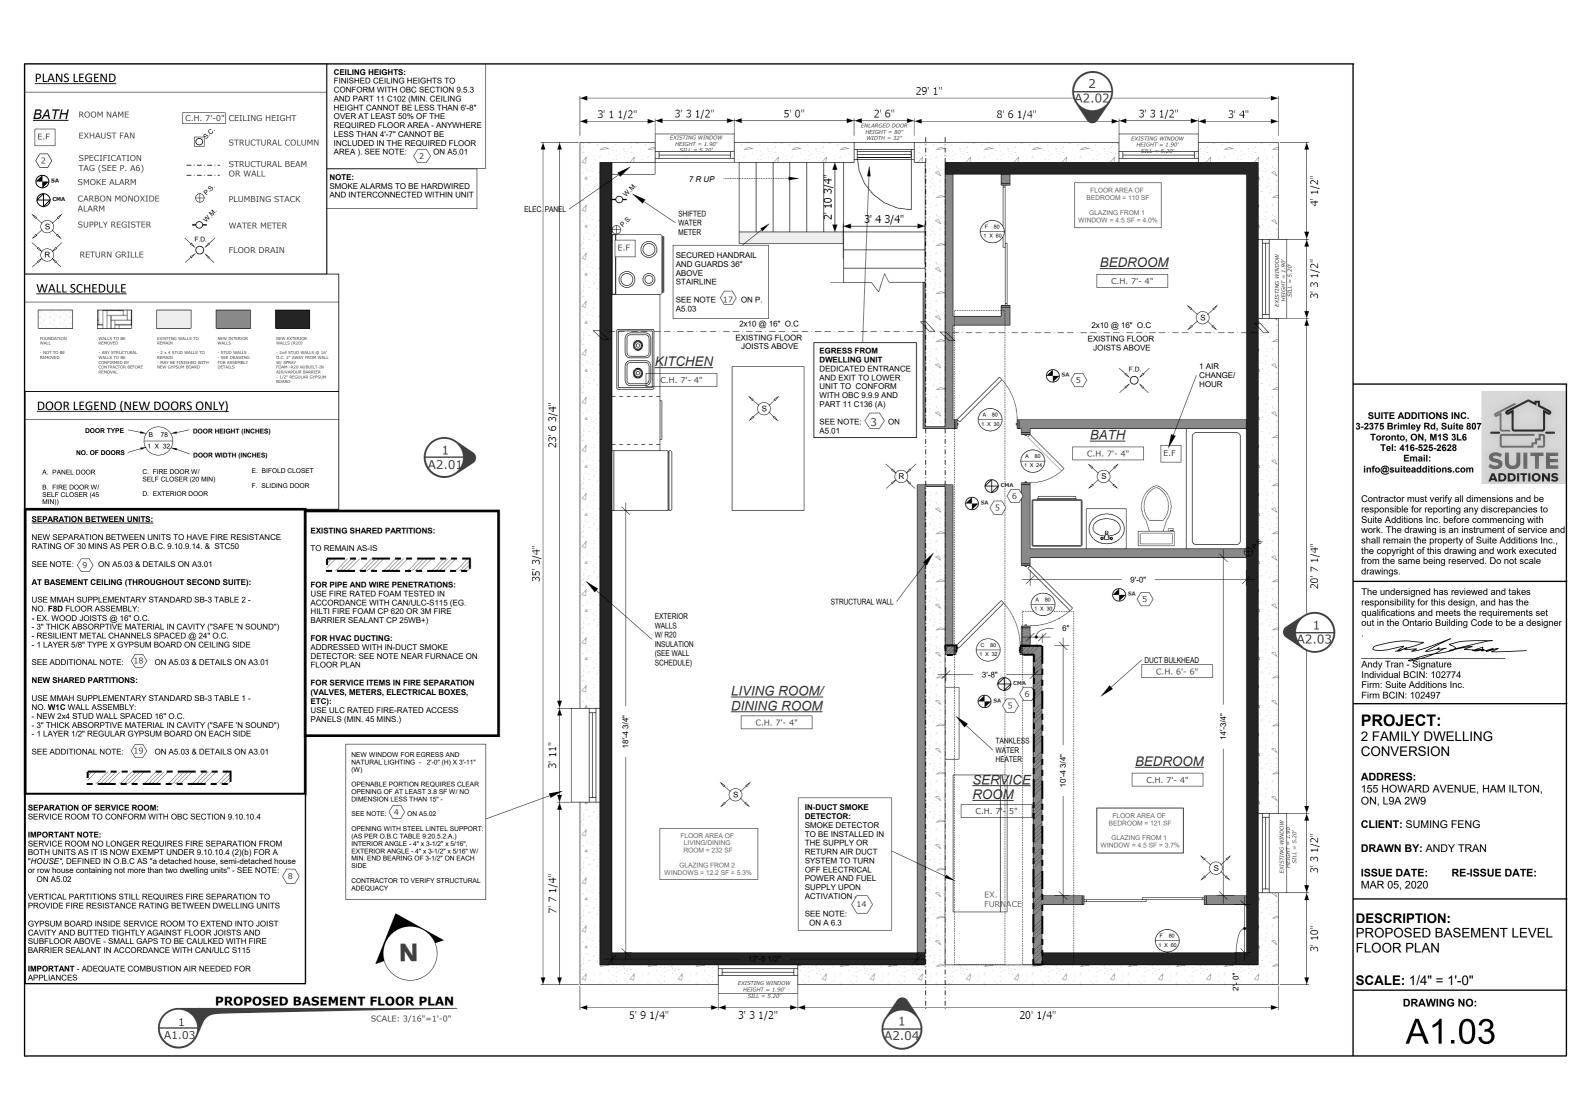

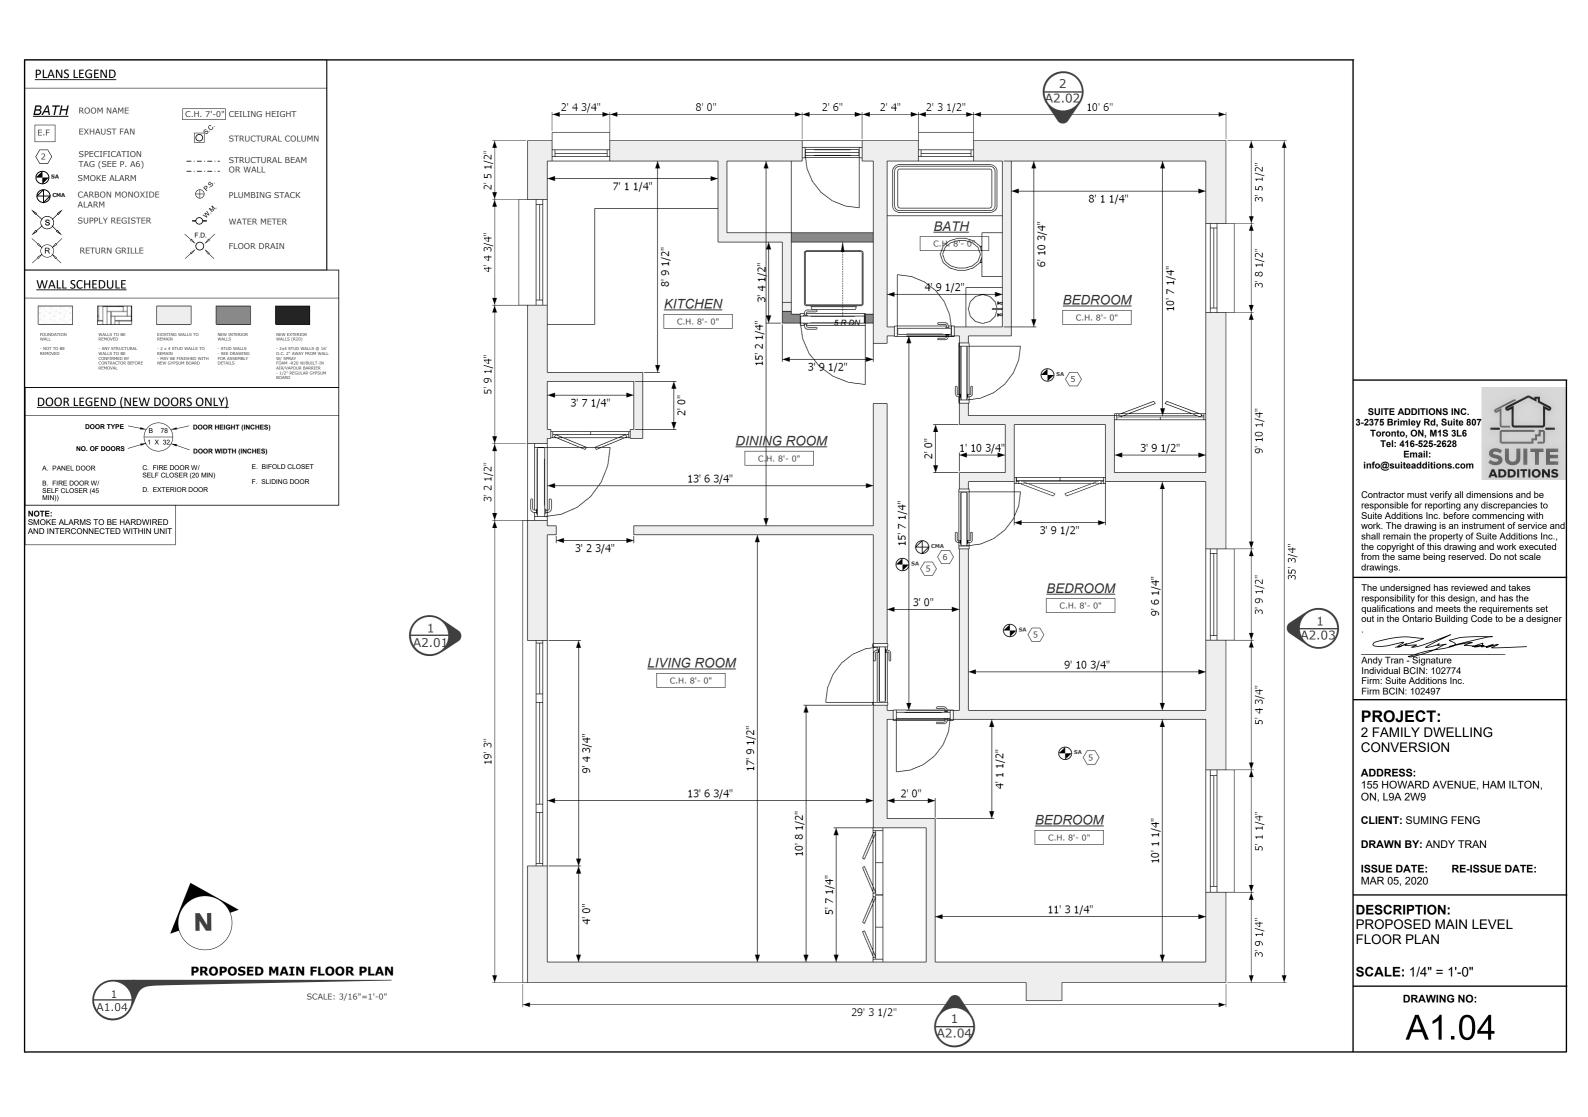



GROUND FLOOR 🗡



FRONT ELEVATION

WEST ELEVATION (FRONT)

SCALE: 1/4"=1'-0"

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Why Kan Andy Tran - Signature Individual BCIN: 102774 Firm: Suite Additions Inc. Firm BCIN: 102497

PROJECT: 2 FAMILY DWELLING CONVERSION

155 HOWARD AVENUE, HAM ILTON, ON, L9A 2W9

CLIENT: SUMING FENG

DRAWN BY: ANDY TRAN

ISSUE DATE: MAR 05, 2020

RE-ISSUE DATE:

DESCRIPTION: WEST ELEVATION

SCALE: 1/4" = 1'-0"

DRAWING NO:



LEFT ELEVATION



SUITE ADDITIONS INC. 3-2375 Brimley Rd, Suite 807 Toronto, ON, M1S 3L6 Tel: 416-525-2628 Email: info@suiteadditions.com



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Andy Tran - Signature Individual BCIN: 102774 Firm: Suite Additions Inc. Firm BCIN: 102497

PROJECT: 2 FAMILY DWELLING CONVERSION

ADDRESS:

155 HOWARD AVENUE, HAM ILTON, ON, L9A 2W9

CLIENT: SUMING FENG

DRAWN BY: ANDY TRAN

ISSUE DATE: MAR 05, 2020

RE-ISSUE DATE:

DESCRIPTION:NORTH ELEVATION

SCALE: 3/16" = 1'-0"

DRAWING NO:



GROUND FLOOR 🗡

REAR ELEVATION

EAST ELEVATION (REAR)

SCALE: 3/16"=1'-0"

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Why han Andy Tran - Signature Individual BCIN: 102774 Firm: Suite Additions Inc. Firm BCIN: 102497

PROJECT: 2 FAMILY DWELLING CONVERSION

155 HOWARD AVENUE, HAM ILTON, ON, L9A 2W9

CLIENT: SUMING FENG

DRAWN BY: ANDY TRAN

ISSUE DATE: MAR 05, 2020

RE-ISSUE DATE:


DESCRIPTION: EAST ELEVATION

SCALE: 3/16" = 1'-0"

DRAWING NO:



RIGHT ELEVATION

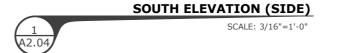

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Andy Tran - Signature Individual BCIN: 102774 Firm: Suite Additions Inc. Firm BCIN: 102497

PROJECT: 2 FAMILY DWELLING CONVERSION

ADDRESS:

155 HOWARD AVENUE, HAM ILTON, ON, L9A 2W9

CLIENT: SUMING FENG

DRAWN BY: ANDY TRAN


ISSUE DATE: MAR 05, 2020

RE-ISSUE DATE:

DESCRIPTION:SOUTH ELEVATION

SCALE: 3/16" = 1'-0"

DRAWING NO:

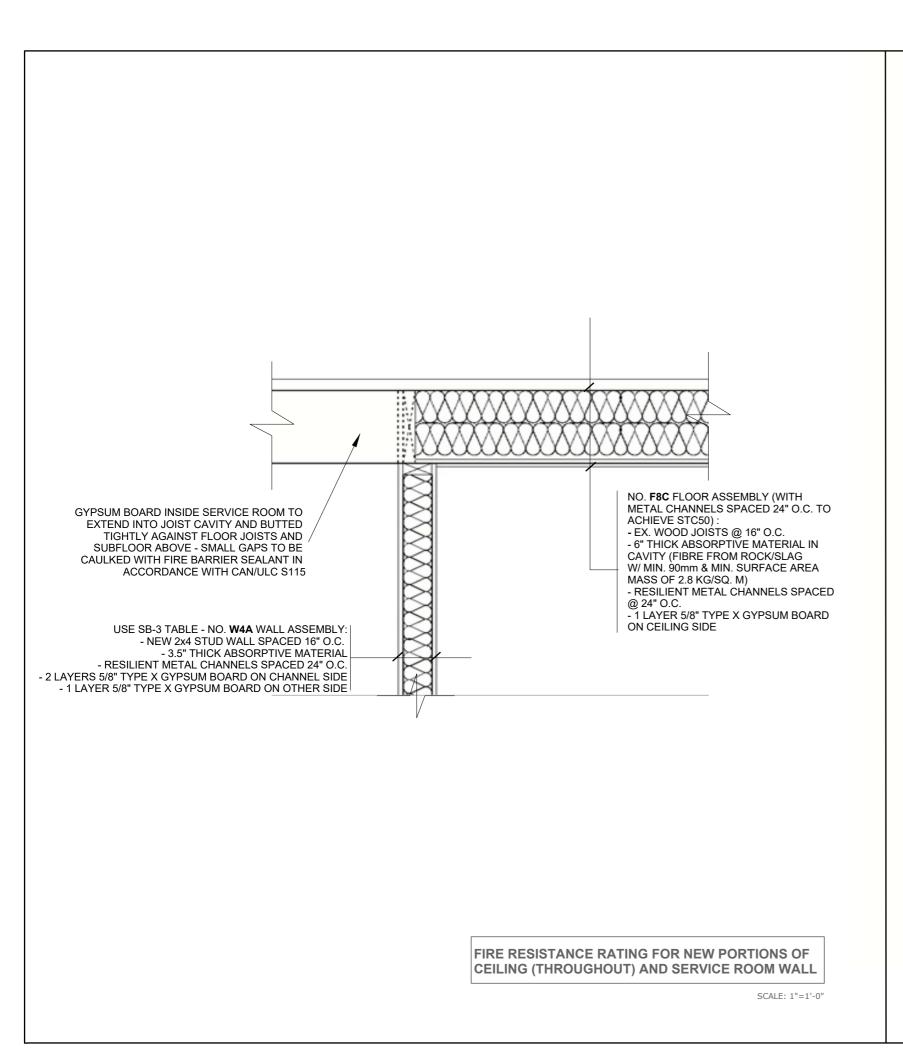

COMPLETE FIRE RATED F8C FLOOR/CEILING ASSEMBLY TO FOUND-ATION WALL BEFORE FRAMING EXTERIOR FOUNDTION WALL ADDITONAL LAYER OF 5/8" TYPE X GYMSUM BOARD FOUNDATION WALL EX. / GRADE 2x4" STUDS @ 16" --O.C." 2" AWAY FROM WALL, WITH 3.5" SPRAY FOAM INSULATION @ R20 1/2" REGULAR GYPSUM BOARD NOTE: FOUNDATION WALL, SLAB AND FOOTING FOR REFERENCE ONLY - EXACT SIZE NOT DETERMINED CONCRETE SLAB **EXTERIOR FOUNDATION WALL DETAIL** SCALE: 1"=1'-0"

SUITE ADDITIONS INC. -2375 Brimley Rd, Suite 807 Toronto, ON, M1S 3L6 Tel: 416-525-2628



ADDITIONS Contractor must verify all dimensions and be responsible for reporting any discrepancies to Suite Additions Inc. before commencing with

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Wily Fran Andy Tran - Signature Individual BCIN: 102774 Firm: Suite Additions Inc. Firm BCIN: 102497

PROJECT: 2 FAMILY DWELLING CONVERSION

155 HOWARD AVENUE, HAM ILTON, ON, L9A 2W9

CLIENT: SUMING FENG

DRAWN BY: ANDY TRAN

ISSUE DATE:

RE-ISSUE DATE: MAR 05, 2020


DESCRIPTION:

CROSS SECTION DETAILS

SCALE: SEE DETAILS

DRAWING NO:

A3.01

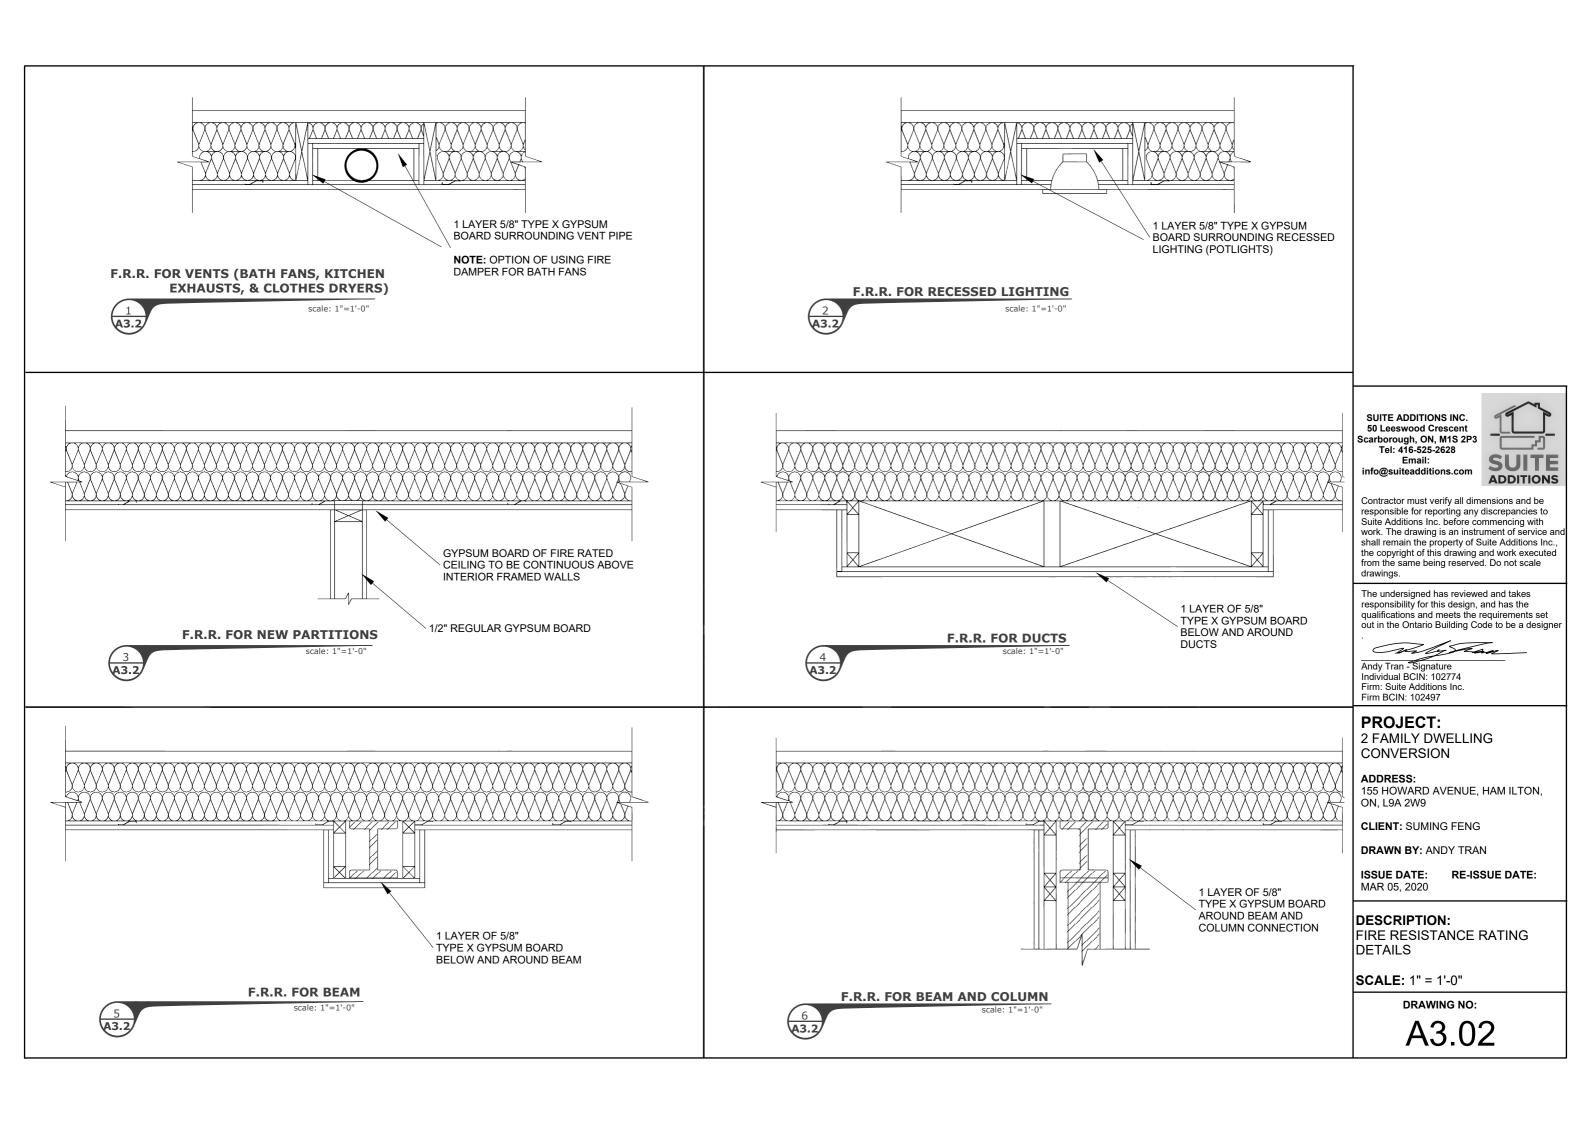

CONSTRUCTION NOTES AND SPECIFICATIONS

GENERAL NOTES:

- ALL CONSTRUCTION TO COMPLY WITH THE CURRENT ONTARIO BUILDING CODE (REVISED 2012 OBC DEC 19, 2017).
- ALL DIMENSIONS ARE MEASURED TO ROUGH FRAMING, MASONRY, OR CONCRETE SURFACES U.O N.
- ALL DOORS AND WINDOW OPENINGS ARE MEASURED TO ROUGH FRAMING OR MASONRY OPENING.
- CONTRACTOR SHALL VERIFY WINDOW OPENINGS WITH THE MANUFACTURER PRIOR TO WORK.
- READ ARCHITECTURAL DRAWINGS IN CONJUNCTION WITH ELECTRICAL PLANS SUPPLIED BY LICENSED ELECTRICAL CONTRACTOR.
- ALL DIMENSIONS MUST BE CHECKED AGAINST THE ARCHITECTURAL DRAWINGS AND FIELD CONDITIONS BEFORE COMMENCING FABRICATION. ANY INCONSISTENCIES ARE TO BE REPORTED TO SUITE ADDITIONS INC. BEFORE PROCEEDEDING WITH THE WORK.
- THE CONTRACTOR SHALL PROPERLY SUPERVISE THE WORK AND ENSURE THAT THE WORK IS INSTALLED TO THE CORRECT LINES AND LEVELS, THAT THE CONNECTIONS AND DETAILS CONFORM TO THE DRAWING DETAILS AND SHALL COORDINATE THE INTERFACING OF ALL WORK WITH ALL SUBTRADES.
- PROVIDE POSITIVE FRONT YARD SLOPE TO MUNICIPAL SEWER FOR WATER RUN-OFF.
- CONTRACTOR TO BE RESPONSIBLE FOR VERIFYING THE LOCATIONS OF ALL EXISTING UNDERGROUND AND ABOVE UTILITIES AND SERVICES. VARIOUS UTILITIES CONCERNED TO BE GIVEN REQUIRED ADVANCE NOTICE PRIOR TO ANY DIGGING, FOR STAKE OUT.
- SUITE ADDITIONS INC. NOT RESPONSIBLE FOR ACCURACY OF SURVEY DRAWING.
- EXISTING DRAINAGE PATTERNS TO REMAIN. ANY NEW SUMP PUMP INSTALLATIONS TO DISCHARGE IN REAR YARD.

BUILDING FROM THESE SHALL PROCEED ONLY WHEN MARKED "ISSUED FOR CONSTRUCTION."

EXISTING STRUCTURE NOTE:

OWNER AND CONTRACTOR ARE FULLY RESPONSIBLE FOR VERIFYING ALL EXISTING GENERAL AND STRUCTURAL CONDITIONS PRIOR TO ANY WORK. ANY AND ALL DISCREPANCIES SHALL BE REPORTED TO SUITE ADDITIONS INC. PRIOR TO ANY WORK. OWNER AND CONTRACTOR IS FULLY RESPONSIBLE FOR SHORING EXISTING STRUCTURE PRIOR TO ANY WORK IF REQUIRED.

CODE REFERENCES AND SPECIFICATIONS



FIRE PROTECTION MEASURES

ALL FIRE PROTECTION MEASURES MUST COMPLY WITH OBC 9.10. (U.O.N.)



CEILING HEIGHTS

CEILING HEIGHTS SHALL COMPLY WITH OBC 9.5.3.1. AND PART 11 - C102 OF TABLE 11.5.1.1.C.

PART

BASEMENT SPACE - 2 100 mm (6'-10 3/4") over at least 75% of the *basement* area except that under beams and ducts the clearance is permitted to be reduced to 1 950 mm (6'-4 7/8")

PART 11 (COMPLIANCE ALTERNATIVE):

In a house,

- (a) minimum room height shall not be less than 1 950 mm (6'-4 7/8") over the required floor area and in any location that would normally be used as a *means of egress*, or
- (b) minimum room height shall not be less than 2 030 mm (6'-10") over at least 50% of the required floor area, provided that any part of the floor having a clear height of less than 1 400 mm (4'-7 1/8") shall not be considered in computing the required floor area.



EGRESS FROM DWELLING UNIT

EGRESS FROM DWELLING UNIT SHALL COMPLY WITH OBC 9.9.9 AND PART 11 COMPLIANCE - C136 OF TABLE 11.5.1.1.C.

PART 9:

9.9.9.1. Travel Limit to Exits or Egress Doors

- (1) Except as provided in Sentences (2) and (3), every *dwelling unit* containing more than 1 *storey* shall have *exits* or egress doors located so that it shall not be necessary to travel up or down more than 1 *storey* to reach a level served by.
- (a) an egress door to a public corridor, enclosed exit stair or exterior passageway, or
- (b) an exit doorway not more than 1 500 mm above adjacent ground level.
- (2) Where a dwelling unit is not located above or below another suite, the travel limit from a floor level in the dwelling unit to an exit or egress door is permitted to exceed 1 storey where that floor level is served by an openable window or door.
- (a) providing an unobstructed opening of not less than 1 000 mm in height and 550 mm in width, and
- (b) located so that the sill is not more than.
- (i) 1 000 mm above the floor, and
- (ii) 7 m above adjacent ground level.
- (3) The travel limit from a floor level in a *dwelling unit* to an *exit* or egress door is permitted to exceed 1 *storey* where that floor level has direct access to a balcony.

9.9.9.2. Two Separate Exits

(1) Except as provided in Sentence 9.9.7.3.(1), where an egress door from a *dwelling unit* opens onto a *public corridor* or exterior passageway it shall be possible from the location where the egress door opens onto the corridor or exterior passageway to go in opposite directions to two separate *exits* unless the *dwelling unit* has a second and separate *means of earess*.

9.9.9.3. Shared Egress Facilities

- (1) A dwelling unit shall be provided with a second and separate means of egress where an egress door from the dwelling unit opens onto.
- (a) an exit stairway serving more than one suite,
- (b) a public corridor.
- (i) serving more than one suite, and
- (ii) served by a single exit,
- (c) an exterior passageway,
- (i) serving more than one suite,
- (ii) served by a single exit stairway or ramp, and
- (iii) more than 1.5 m above adjacent ground level, or
- (d) a balcony.
- (i) serving more than one suite,
- (ii) served by a single exit stairway or ramp, and
- (iii) more than 1.5 m above adjacent ground level.

PART 11 (COMPLIANCE ALTERNATIVE):

- In a house, exit requirements are acceptable if at least one of the following conditions exists:
- (a) a door, including a sliding door, that opens directly to the exterior from a *dwelling unit*, serves only that *dwelling unit* and has reasonable access to ground level, and the *dwelling units* are equipped with *smoke alarms* installed in conformance with Subsection 9.10.19.,
- (b) an exit that is accessible to more than one dwelling unit and provides the only means of egress from each dwelling unit, provided that the means of egress is separated from the remainder of the building and common areas by a fire separation having a 30 min fire-resistance rating and provided further that the required access to exit from any dwelling unit cannot be through another dwelling unit, service room or other occupancy, and both dwelling units and common areas are provided with smoke alarms that are installed in conformance with Subsection 9.10.19. and are interconnected, or
- (c) access to an exit from one dwelling unit which leads through another dwelling unit where,
- (i) an additional means of escape is provided through a window that conforms to the following:
- (A) the sill height is not more than 1 000 mm above or below adjacent ground level,
- (B) the window can be opened from the inside without the use of tools,
- (C) the window has an individual unobstructed open portion having a minimum area of 0.38 m² with no dimension less than 460 mm,
- (D) the sill height does not exceed 900 mm above the floor or fixed steps,
- (É) where the window opens into a window well, a clearance of not less than 1 000 mm shall be provided in front of the window, and
- (F) smoke alarms are installed in every dwelling unit and in common areas in conformance with Subsection 9.10.19. and are interconnected,
- (ii) an additional means of escape is provided through a window that conforms to the following:
- (A) the window is a casement window not less than 1 060 mm high, 560 mm wide, with a sill height not more than 900 mm above the inside floor.
- (B) the sill height of the window is not more than 5 m above adjacent ground level, and
- (C) smoke alarms are installed in every dwelling unit and in common areas in conformance with Subsection 9.10.19. and are interconnected, or (iii) the building is sprinklered and the dwelling units are equipped with smoke alarms installed in conformance with Subsection 9.10.19.

SUITE ADDITIONS INC. 3-2375 Brimley Rd, Suite 807 Toronto, ON, M1S 3L6 Tel: 416-525-2628 Email:

info@suiteadditions.com



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The undersigned has reviewed and takes responsibility for this design, and has the qualifications and meets the requirements set out in the Ontario Building Code to be a designe

Andy Tran - Signature Individual BCIN: 102774 Firm: Suite Additions Inc. Firm BCIN: 102497

PROJECT: 2 FAMILY DWELLING CONVERSION

ADDRESS:

155 HOWARD AVENUE, HAM ILTON, ON, L9A 2W9

CLIENT: SUMING FENG

DRAWN BY: ANDY TRAN

ISSUE DATE: MAR 05, 2020 RE-ISSUE DATE:

DESCRIPTION: CONSTRUCTION SPECIFICATIONS

SCALE: N/A

DRAWING NO:

A5.01

\langle 4 \rangle

EGRESS FROM BEDROOMS

EGRESS FROM BEDROOMS SHALL COMPLY WITH OBC 9.9.10.1

PART 9:

- (1) Except where a door on the same floor level as the bedroom provides direct access to the exterior, every floor level containing a bedroom in a *suite* shall be provided with at least one outside window that,
- (a) is openable from the inside without the use of tools,
- (b) provides an individual, unobstructed open portion having a minimum area of 0.35 m² with no dimension less than 380 mm, and
- (c) maintains the required opening described in Clause (b) without the need for additional support.
- (2) Except for *basement* areas, the window required in Sentence (1) shall have a maximum sill height of 1 000 mm above the floor.
- (3) When sliding windows are used, the minimum dimension described in Sentence (1) shall apply to the openable portion of the window.
- (4) Where the sleeping area within a *live/work unit* is on a *mezzanine* with no obstructions more than 1 070 mm above the floor, the window required in Sentence (1) may be provided on the main level of the *live/work unit* provided the *mezzanine* is not more than 25% of the area of the *live/work unit* or 20 m2, whichever is less, and an unobstructed direct path of travel is provided from the *mezzanine* to this window.
- (5) Where a window required in Sentence (1) opens into a window well, a clearance of not less than 550 mm shall be provided in front of the window.
- **(6)** Where the sash of a window referred to in Sentence (5) swings towards the window well, the operation of the sash shall not reduce the clearance in a manner that would restrict escape in an emergency.
- (7) Where a protective enclosure is installed over the window well referred to in Sentence (5), such enclosure shall be openable from the inside without the use of keys, tools or special knowledge of the opening mechanism.



SMOKE ALARMS

SMOKE ALARMS SHALL COMPLY WITH OBC 9.10.19. AND PART 11 COMPLIANCE – C175 OF TABLE 11.5.1.1.C.

PART 9:

9.10.19.1. Required Smoke Alarms

- (1) Smoke alarms conforming to CAN/ULC-S531, "Smoke Alarms", shall be installed in each dwelling unit and in each sleeping room not within a dwelling unit.
- (2) Smoke alarms required in Sentence (1) shall have a visual signalling component conforming to the requirements in 18.5.3. (Light, Color and Pulse Characteristics) of NFPA 72, "National Fire Alarm and Signaling Code".
- (3) The visual signalling component required in Sentence (2) need not, (a) be integrated with the *smoke alarm* provided it is interconnected to it, (b) be on battery backup, or (c) have synchronized flash rates, when installed in a *dwelling unit*.
- (4) The luminous intensity for visual signalling components required in Sentence (2) that are installed in sleeping rooms shall be a minimum of 175 cd.
- (5) Smoke alarms required in Sentence (1) shall be installed on or near the ceiling.

9.10.19.3. Location of Smoke Alarms

- (1) Within dwelling units, sufficient smoke alarms shall be installed so that,
- (a) there is at least one smoke alarm installed on each storey, including basements, and
- (b) on any storey of a dwelling unit containing sleeping rooms, a smoke alarm is installed,
- (i) in each sleeping room, and
- (ii) in a location between the sleeping rooms and the remainder of the *storey*, and if the sleeping rooms are served by a hallway, the *smoke alarm* shall be located in the hallway.
- (2) Within a house that contains an interior shared means of egress or common area, a smoke alarm shall be installed in each shared means of egress and common area.
- (3) A smoke alarm required in Sentences (1) and (2) shall be installed in conformance with CAN/ULC-S553, "Installation of Smoke Alarms".

9.10.19.4. Power Supply

- (1) Except as provided in Sentences (2) and (3), *smoke alarms* required in Sentences 9.10.19.1.(1) and 9.10.19.3.(2) shall,
- (a) be installed with permanent connections to an electrical circuit,
- (b) have no disconnect switch between the overcurrent device and the smoke alarm, and
- (c) in case the regular power supply to the *smoke alarm* is interrupted, be provided with a battery as an alternative power source that can continue to provide power to the *smoke alarm* for a period of not less than 7 days in the normal condition, followed by 4 min of alarm.

9.10.19.5. Interconnection of Smoke Alarms

(1) Where more than one *smoke alarm* is required in a *dwelling unit*, the *smoke alarms* shall be wired so that the activation of one alarm will cause all alarms within the *dwelling unit* to sound.

PART 11 (COMPLIANCE ALTERNATIVE):.

Smoke alarms may be battery operated.

6

CARBON MONOXIDE ALARMS

CARBON MONOXIDE ALARMS SHALL COMPLY WITH OBC 9.33.4. AND PART 11 COMPLIANCE – C197 OF TABLE 11.5.1.1.C.

PART 9:

9.33.4.1. Application

- (1) This Subsection applies to every building that,
- (a) contains a residential occupancy, and
- (b) contains a fuel-burning appliance or a storage garage.

9.33.4.2. Location of Carbon Monoxide Alarms

- (1) Where a fuel-burning appliance is installed in a suite of residential occupancy, a carbon monoxide alarm shall be installed adjacent to each sleeping area in the suite.
- (2) Where a fuel-burning appliance is installed in a service room that is not in a suite of residential occupancy, a carbon monoxide alarm shall be installed,
- (a) adjacent to each sleeping area in every suite of residential occupancy that is adjacent to the service room, and
- (b) in the service room.
- (3) Where a *storage garage* is located in a *building* containing a *residential occupancy*, a carbon monoxide alarm shall be installed adjacent to each sleeping area in every *suite* of *residential occupancy* that is adjacent to the *storage garage*.
- (4) Where a storage garage serves only the dwelling unit to which it is attached or built in, a carbon monoxide alarm shall be installed adjacent to each sleeping area in the dwelling unit.
- (5) A carbon monoxide alarm shall be mechanically fixed,
- (a) at the manufacturer's recommended height, or
- (b) in the absence of specific instructions, on or near the ceiling.

9.33.4.3. Installation and Conformance to Standards

- (1) The carbon monoxide alarm required by Article 9.33.4.2. shall,
- (a) except as permitted in Sentence (2), be permanently connected to an electrical circuit and shall have no disconnect switch between the overcurrent device and the carbon monoxide alarm,
- (b) be wired so that its activation will activate all carbon monoxide alarms within the *suite*, where located within a *suite* of *residential occupancy*,
- (c) be equipped with an alarm that is audible within bedrooms when the intervening doors are closed, where located adjacent to a sleeping area, and
- (d) conform to,
- (i) CAN/CSA-6.19, "Residential Carbon Monoxide Alarming Devices", or
- (ii) UL 2034, "Single and Multiple Station Carbon Monoxide Alarms".
- (2) Where the building is not supplied with electrical power, carbon monoxide alarms are permitted to be battery operated.

PART 11 (COMPLIANCE ALTERNATIVE):.

Carbon monoxide alarms may be battery operated or plugged into an electrical outlet.



FIRE-RESISTANCE RATINGS FOR WALLS, COLUMNS AND ARCHES

FIRE-RESISTANCE RATINGS FOR WALLS, COLUMNS AND ARCHES SHALL COMPLY WITH OBC 9.10.8.3 AND PART 11 COMPLIANCE - C147 OF TABLE 11.5.1.1.C.

PART 9

(1) Except as otherwise provided in this Subsection, all *loadbearing* walls, columns and arches in the *storey* immediately below a floor or roof assembly shall have a *fire-resistance rating* of not less than that required for the supported floor or roof assembly.

PART 11 (COMPLIANCE ALTERNATIVE):.

- (a) Except as provided in (b) and (c), 30 min rating is acceptable.
- (b) In a house, 15 min horizontal fire separation is acceptable where,
- (i) smoke alarms are installed in every dwelling unit and in common areas in conformance with Subsection 9.10.19., and
- (ii) smoke alarms are interconnected.
- (c) In a house, the fire-resistance rating of the fire separation is waived where the building is sprinklered.



SEPARATION OF SERVICE ROOMS

SEPARATION OF SERVICE ROOMS SHALL COMPLY WITH OBC 9.10.10.4

PART 9:

9.10.10.4. Appliances and Equipment to be Located in a Service Room

- (1) Except as provided in Sentences (2) and (3) and Article 9.10.10.5., fuel-fired appliances shall be located in a service room separated from the remainder of the building by a fire separation having not less than a 1 h fire-resistance rating.

 (2) Except as required in the appliance installation standards referenced in Sentences 6.2.1.4.(1) and 9.33.1.2.(1), fuel fired space-heating appliances, space-cooling appliances and service water heaters need not be separated from the remainder of the building as required in Sentence (1) where the equipment serves,
- (a) not more than one room or suite,
- (b) a house, or
- (c) a building, other than a house, with a building area of not more than 400 m² and a building height of not more than 2 storeys.
- (3) Sentence (1) does not apply to fireplaces and cooking appliances.

SUITE ADDITIONS INC. 3-2375 Brimley Rd, Suite 807 Toronto, ON, M1S 3L6 Tel: 416-525-2628 Email: info@suiteadditions.com



Contractor must verify all dimensions and be responsible for reporting any discrepancies to Suite Additions Inc. before commencing with work. The drawing is an instrument of service and shall remain the property of Suite Additions Inc., the copyright of this drawing and work executed from the same being reserved. Do not scale drawings.

The undersigned has reviewed and takes responsibility for this design, and has the qualifications and meets the requirements set out in the Ontario Building Code to be a designed

Andy Tran - Signature Individual BCIN: 102774 Firm: Suite Additions Inc. Firm BCIN: 102497

PROJECT: 2 FAMILY DWELLING CONVERSION

ADDRESS:

155 HOWARD AVENUE, HAM ILTON, ON, L9A 2W9

RE-ISSUE DATE:

CLIENT: SUMING FENG

DRAWN BY: ANDY TRAN

ISSUE DATE: MAR 05, 2020

DESCRIPTION:CONSTRUCTION
SPECIFICATIONS

SCALE: N/A

DRAWING NO:

A5.02



SEPARATION OF RESIDENTIAL SUITES

SEPARATION OF RESIDENTIAL SUITES SHALL COMPLY WITH OBC 9.10.9.14 AND PART 11 COMPLIANCE - C152 OF TABLE 11.5.1.1.C.

PART 9:

- (1) Except as provided in Sentences (2) and (3) and Article 9.10.21.2., suites in residential occupancies shall be separated from adjacent rooms and suites by a fire separation having a fire-resistance rating of not less than 45 min.
- (2) Sleeping rooms in *boarding, lodging or rooming houses* where sleeping accommodation is provided for not more than 8 boarders or lodgers shall be separated from the remainder of the *floor area* by a *fire separation* having a *fire-resistance rating* of not less than 30 min where the sleeping rooms form part of the proprietor's residence and do not contain cooking facilities.
- (3) Except as provided in Sentences (4) and (5), dwelling units that contain 2 or more storeys including basements shall be separated from the remainder of the building by a fire separation having a fire-resistance rating of not less than 1 h.
- (4) Except as provided in Sentence (5), *dwelling units* in a *house* shall be separated from each other and common areas by a *fire separation* having a *fire-resistance rating* of not less than 45 min.
- (5) The fire-resistance rating of the fire separation required in Sentence (4) is permitted to be waived where the house is sprinklered.

PART 11 (COMPLIANCE ALTERNATIVE):

- (a) Except as provided in (b) and (c), 30 min fire separation is acceptable.
- (b) In a house, 15 min horizontal fire separation is acceptable where,
- (i) smoke alarms are installed in every dwelling unit and in common areas in conformance with Subsection 9.10.19., and
- (ii) smoke alarms are interconnected.
- (c) In a house, the fire-resistance rating of the fire separation is waived where the building is sprinklered.

10

CLOSURES (DOORS):

CLOSURES SHALL COMPLY WITH OBC 9.10.13.1 AND PART 11 COMPLIANCE - C155 OF TABLE 11.5.1.1.C.

PART 9:

(1) Except as provided in Article 9.10.13.2., openings in required *fire separations* shall be protected with a *closure* conforming to Table 9.10.13.1. and shall be installed in conformance with NFPA 80, · Fire Doors and Other Opening Protectives·, unless otherwise specified in this Part.

PART 11 (COMPLIANCE ALTERNATIVE):

Existing functional closures are acceptable subject to C.A.'s C8 and C156.

- (a) Existing functional and sound doors in existing *buildings* that are either hollow metal or kalamein and containing wired glass at least 6 mm thick and conforming to Sentence 3.1.8.14.(2) are permitted in lieu of doors not required to exceed 45 min
- (b) all existing functional and sound hollow metal or kalamein doors which carry existing 1.5 h labels are acceptable in lieu of current 1.5 h labels and may contain wired glass panels not exceeding 0.0645 m², at least 6 mm thick and conforming to Sentence 3.1.8.14.(2), and
- (c) every fire door, window assembly or glass block used as a *closure* in a required *fire separation* shall be installed in conformance with good engineering practice.
- In a *house*, existing unlabelled doors at least 45 mm solid core wood or metal clad are acceptable. For existing *closures*, ratings of 20 min will not be required where the entire *floor area* is *sprinklered*.



LAUNDRY FIXTURES

LAUNDRY FIXTURES SHALL COMPLY WITH OBC 9.31.4.2.

PART 9

(1) Laundry facilities or a space for laundry facilities shall be provided in every *dwelling unit* or grouped elsewhere in the *building* in a location conveniently accessible to occupants of every *dwelling unit*.

12 NATURAL VENTILATION

NATURAL VENTILATION SHALL COMPLY WITH OBC 9.32.2.1 AND PART 11 COMPLIANCE - C194 OF TABLE 11.5.1.1.C.

DAPT 0

- (1) The unobstructed openable ventilation area to the outdoors for rooms and spaces in a *residential* occupancy ventilated
- by natural means shall conform to Table 9.32.2.1.

PART 11 (COMPLIANCE ALTERNATIVE):

In a *house*, rooms or spaces to be ventilated by natural means in accordance with Subsection 9.32.2. or by providing adequate mechanical ventilation.



ELECTRICAL FACILITIES

ELECTRICAL FACILITIES SHALL COMPLY WITH OBC 9.34.

(14)

INTERCONNECTION OF SYSTEMS

INTERCONNECTION OF SYSTEMS SHALL COMPLY WITH OBC 6.2.3.9 AND PART 11 COMPLIANCE - C91 OF TABLE 11.5.1.1.C.

PART 6:

(1) In a residential occupancy, air from one suite shall not be circulated to any other suite or to a public corridor or public stairway.

PART 11 (COMPLIANCE ALTERNATIVE):

In a building containing not more than four dwelling units or residential suites, the existing heating or air-conditioning system may be altered to serve more than one dwelling unit or suite, provided smoke alarms are installed in each dwelling unit or suite and provided a smoke detector is installed in the supply or return air duct system serving the entire building which would turn off the fuel supply and electrical power to the heating system upon activation of such detector.



PENETRATIONS

PIPING, TUBING, DUCTS, CHIMNEYS, WIRING, CONDUIT, ELECTRICAL OUTLET BOXES AND OTHER SIMILAR SERVICE EQUIPMENT THAT PENETRATE A FIRE SEPARATION MUST BE NON COMBUSTIBLE AND FIRE STOPPED. ANY FIRE BARRIER SEALANT USED NEEDS TO BE IN ACCORDANCE WITH CAN/ULC S115 STANDARD. CORRECT MATERIAL TECHNICAL SPECIFICATIONS AND MANUFACTURER'S INSTALLATION METHODS ("CUT SHEETS") TO BE PROVIDED ON SITE.



PLUMBING

ALL PLUMBING MUST CONFORM TO O.REG.332/12, DIV, B PART 7 OF THE BUILDING CODE



HANDRAILS AND GUARDRAILS

INSTALL HANDRAILS AND GUARDRAILS IN ACCORDANCE WITH 9.8.7. AND 9.8.8 OF THE BUILDING CODE RESPECTIVELY



ADDITIONAL NOTES ON FLOOR/CEILING FIRE RATED ASSEMBLY [FROM NOTE (12) IN TABLE 2 OF MMAH SUPPLEMENTARY STANDARD SB-3]

(12) Except where assemblies with wood I-joists are tested according to CAN/ULC-S101, "Fire Endurance Tests of Building Construction and Materials", the fire-resistance rating values apply only to I-joists that have been fabricated with a phenolic-based structural wood adhesive complying with CSA 0112.10, "Evaluation of Adhesives for Structural Wood Products (Limited Moisture Exposure)". For I-joists with flanges made of laminated veneer lumber (LVL), the fire-resistance rating values apply only where the adhesive used in the

LVL fabrication is a phenolic-based structural wood adhesive complying with CSA 0112.9, "Evaluation of Adhesives for Structural Wood Products (Exterior Exposure)".



ADDITIONAL NOTES ON WALL FIRE RATED ASSEMBLY [FROM NOTE (4)(5)(7) IN TABLE 2 OF MMAH SUPPLEMENTARY STANDARD SB-3]

(4) Sound absorptive material includes fibre processed from rock, slag, glass or cellulose fibre. It must fill at least 90% of the cavity thickness for the wall to provide the listed STC value. The absorptive material should not overfill the cavity to the point of producing significant outward pressure on the finishes; such an assembly will not achieve the STC rating. Where the absorptive material used

with steel stud assemblies is in batt form, 'steel stud batts", which are wide enough to fill the cavity from the web of one stud to the web of the adjacent studs, must be used.

- (5) The complete descriptions of indicated finishes are as follows:
- 12.7 mm regular gypsum board 12.7 mm regular gypsum board conforming to Article 9.29.5.2. of Division B of the Building Code.
- 12.7 mm Type X gypsum board 12.7 mm special fire-resistant Type X gypsum board conforming to Article 9.29,5.2. of Division B of the Building Code.
- 15.9 mm Type X gypsum board 15.9 mm special fire-resistant Type X gypsum board conforming to Article 9.29.5.2. of Division B of the Building Code.
- Except for exterior walls, the outer layer of finish on both sides of the wall must have its joints taped and finished.
- Fastener types and spacing must conform to CSA-A82.31-M, "Gypsum Board Application".
- (7) Regular gypsym board used in single layer assemblies must be installed so all edges are supported.

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Andy Tran - Signature Individual BCIN: 102774

Individual BCIN: 102774 Firm: Suite Additions Inc. Firm BCIN: 102497

PROJECT: 2 FAMILY DWELLING CONVERSION

DDRESS:

155 HOWARD AVENUE, HAM ILTON, ON, L9A 2W9

CLIENT: SUMING FENG

DRAWN BY: ANDY TRAN

ISSUE DATE: MAR 05, 2020 RE-ISSUE DATE:

DESCRIPTION:CONSTRUCTION SPECIFICATIONS

SCALE: N/A

DRAWING NO:

A5.03



Committee of Adjustment

City Hall, 5th Floor, 71 Main St. W., Hamilton, ON L8P4Y5

Phone: (905) 546-2424 ext. 4221

Email: cofa@hamilton.ca

APPLICATION FOR A MINOR VARIANCE

FOR OFFICE USE ONL	Υ.
APPLICATION NO.	DATE APPLICATION RECEIVED
PAID	DATE APPLICATION DEEMED COMPLETE
SECRETARY'S SIGNATURE	

The Planning Act

Application for Minor Variance or for Permission

The undersigned hereby applies to the Committee of Adjustment for the City of Hamilton under Section 45 of the *Planning Act*, R.S.O. 1990, Chapter P.13 for relief, as described in this application, from the Zoning By-law.

1, 2	NAME	MAILING ADDRESS	
Registered Owners(s)			
Applicant(s)*			
Agent or Solicitor			

Note: Unless otherwise requested all communications will be sent to the agent, if any.

3. Names and addresses of any mortgagees, holders of charges or other encumbrances:

Additional sheets can be submitted if there is not sufficient room to answer the following questions. Additional sheets must be clearly labelled

4.	Nature and extent of relief applied for:			
	Secondary Dwe	lling Unit	Reconstruction of	Existing Dwelling
5.	Why it is not pos	sible to comply	with the provisions of	the By-law?
6.			of subject lands (regis re applicable, street a	tered plan number and lot number or and street number):
7.	PREVIOUS USE			
	Residential	Indi	ustrial	Commercial
	Agricultural	Vac	cant	Other
	Other			
8.1	If Industrial or Co	ommercial, spec	cify use	
8.2	Has the grading has filling occurre		and been changed by	adding earth or other material, i.e.
	Yes	No	Unknown	
8.3	Has a gas station		on the subject land or Unknown	adjacent lands at any time?
8.4	Has there been p	oetroleum or otl	ner fuel stored on the	subject land or adjacent lands?
	Yes	No	Unknown	
8.5	Are there or have subject land or a		en underground stora	ge tanks or buried waste on the
	Yes	No	Unknown	
8.6		roducts may ha		an agricultural operation where sticides and/or sewage sludge was
			Unknown	
8.7		=		a weapon firing range?
	Yes		Unknown	
8.8	of an operational	/non-operation	al landfill or dump?	500 metres (1,640 feet) of the fill area
0.0			Unknown	
8.9		•		re there any building materials bublic health (eg. asbestos, PCB's)?
	Yes	No	Unknown	

	uses on the site or a	-		
	Yes N	o \	Unknown	
8.11	What information did	I you use to det	termine the answers to 8.1 to 8.10 above?	
8.12		ory showing all f	trial or commercial or if YES to any of 8.2 to 8.10, a former uses of the subject land, or if appropriate, the s needed.	
	Is the previous use i	nventory attach	ned? Yes No	
9.		he City of Hami imination on the	e property which is the subject of this Application – by cation.	
	Date		Signature Property Owner(s)	
			Print Name of Owner(s)	
10.	Dimensions of lands Frontage Depth Area	affected:		
	Width of street		-	
11.		•	ctures on or proposed for the subject lands: (Specify a, number of stories, width, length, height, etc.)	
	Proposed			
12.	Location of all buildidistance from side, in Existing:	•	ures on or proposed for the subject lands; (Specify ot lines)	
	Proposed:			

Is there any reason to believe the subject land may have been contaminated by former

13.	Date of acquisition of subject lands:		
14.	Date of construction of all buildings and structures on subject lands:		
15.	Existing uses of the subject property (single family, duplex, retail, factory etc.):		
16.	Existing uses of abutting properties (single family, duplex, retail, factory etc.):		
17.	Length of time the existing uses of the subject property have continued:		
18.	Municipal services available: (check the appropriate space or spaces)		
	Water Connected		
	Sanitary Sewer Connected		
	Storm Sewers		
19.	Present Official Plan/Secondary Plan provisions applying to the land:		
20.	Present Restricted Area By-law (Zoning By-law) provisions applying to the land:		
21.	Has the owner previously applied for relief in respect of the subject property?		
	Yes No If the answer is yes, describe briefly.		
22.	Is the subject property the subject of a current application for consent under Section 53 of the <i>Planning Act</i> ?		
	Yes No		
23.	Additional Information		
24.	The applicant shall attach to each copy of this application a plan showing the dimensions of the subject lands and of all abutting lands and showing the location, size and type of all buildings and structures on the subject and abutting lands, and where required by the Committee of Adjustment such plan shall be signed by an Ontario Land Surveyor.		

Permit#	15989983

Paid



HAMILTON MUNICIPAL PARKING SYSTEM RESIDENTIAL DRIVEWAY ACCESS PERMIT

Property Address:	155 HOWARD AVE, HAMILTON		
Lot#/Concession:			
Mailing Address:	3-2375 BRIMLEY ROAD SUITE 807, SO	CARBOROUGH	Postal Code: M1S 3L6
Applicant:	ANDY TRAN	Phone: 416-525-2628	Fax:
Survey: Yes []	No [X]		
Type of request:	Construct a new entrance	X Change the de	esign of an existing entrance
	Relocation of an existing entrance	Construct a to	emporary entrance
The applicant requi	res the authorization of Public Works for	the use of any other b	onded contractor.
	CLASSIFICATION, USE, PURPOSE ANI	D DETAIL OF ACCES	S
In the case that the Owne	er/Applicant or Agent installs the access, it is underst		
	800-400-2255) for all utility locates prior to excavation	_	-
	e satisfaction of the respective utility company. All v		
_	erated at the expense of the undersigned, and work n	-	
The issuance of a permit	by the City does not relieve the holder of the respons	sibility of complying with re	elevant Municipal By-Laws.
In consideration of any p	permit issued in respect to: this application, we, the A	pplicants for ourselves, our	Heirs, Executors,
	ors and Assigns hereby agree to observe, keep and pe		
-	demnify and save harmless, the City and its agents fr	_	
	to with the City may be put or which the City may be tenance, alterations or operation of the works authorized	-	-
	as considered proper and may cancel any such perm	_	
and 86-077.	,,,,	p	
Access required for:	Rural area	Urban	area X
Widen	existing driveway 10ft 3in to the south to ac	commodate parking for	r a 2nd dwelling unit.
Applicant's			-
Details			
Signature of applicar	nt		Dated
Dlagga maggida a dat	toiled elected of subone year second libra the		ah yama annyasah yama
•	tailed sketch of where you would like the p		
	ntrance or culvert extension to be located.		
your proposai. whe	en writing descriptions, please use North, S	South, East and West	directions.
	FOR OFFIC	CE USE ONLY	
Approved X	Denied Concr	rete Approach	Culvert
Access to be construct	cted by:	Approach ramp length	0.00
District #	Bonded contractor	Culvert diameter	0.00 Culvert length 0.00
Formeman/Superinten	dent	Phone #	

Perm	it#	
1 (1111	LILIT	

15989983

Paid



HAMILTON MUNICIPAL PARKING SYSTEM RESIDENTIAL DRIVEWAY ACCESS PERMIT

Property Address:	155 HOWARD AVE , HAMILTON
Lot#/Concession:	

May 3, 2021. Approach estimate required. Approved by: Andrew Brown

Existing driveway to be widened 3.1m to the south for a total driveway width of 6.1m.

Public Works to determine new width of approach ramp.

Attachment with visual included in Hansen.

Details