



Hamilton

COMMITTEE OF ADJUSTMENT

City Hall, 5th floor, 71 Main Street West, Hamilton, ON L8P 4Y5
Telephone (905) 546-2424, ext. 4221, 3935 Fax (905) 546-4202
E-mail: cofa@hamilton.ca

NOTICE OF PUBLIC HEARING
Minor Variance

You are receiving this notice because you are either:

- Assessed owner of a property located within 60 metres of the subject property
 - Applicant/agent on file, or
 - Person likely to be interested in this application
-

APPLICATION NO.: HM/A-21:379

APPLICANTS: Owner 1837675 Ontario Inc. c/o Reisha Dass/Wayne Fisher
Agent Wayne Fisher

SUBJECT PROPERTY: Municipal address **642 Concession St., Hamilton**

ZONING BY-LAW: Zoning By-law 05-200, as Amended by By-law 17-240

ZONING: C5a district (Mixed Use Medium Density - Pedestrian Focus)

PROPOSAL: To permit a (3) three storey mixed use building consisting of three (3) dwelling units under 50 square metres in gross floor area and two office suites comprising 449.96 square metres of gross floor area, notwithstanding that:

1. No parking spaces shall be required instead of the required 14 parking spaces, including 1 barrier free parking space (based on the zoning requirements in effect prior to the approval of amending by-law 17-240).

NOTES:

1. The variance is written as requested by the applicant.
2. The variance is required to facilitate Site Plan Approval application DA-19-176 which was granted Conditional Approval for Concurrent Site Plan and Building Permit Review on June 14, 2021.
3. The requested variance applies because certain parking requirements for the C5a Zone and other Commercial Mixed Use Zones approved under amending by-law 17-240 remain under appeal and are not in full force and effect. In particular, the proposal conforms to the requirements of the Zoning By-law, as amended by By-law 17-240 as 0 parking spaces are required for the proposed offices and dwelling units. However, as these regulations are under appeal, the provisions for parking for Zoning By-law 05-200 which were in effect prior to By-law 17-240 being passed (November 8, 2017) are applicable. As per the variance stated, this requirement is based on the 14 parking spaces required for the proposed offices and 0 parking spaces for the proposed dwelling units applicable to areas outside of the Downtown.

This application will be heard by the Committee as shown below:

DATE: Thursday, November 25th, 2021
TIME: 2:55 p.m.
PLACE: Via video link or call in (see attached sheet for details)
To be streamed at
www.hamilton.ca/committeeofadjustment
for viewing purposes only

PUBLIC INPUT

Written: If you would like to submit written comments to the Committee of Adjustment you may do so via email or hardcopy. Please see attached page for complete instructions, including deadlines for submitting to be seen by the Committee.

Orally: If you would like to speak to this item at the hearing you may do so via video link or by calling in. Please see attached page for complete instructions, including deadlines for registering to participate.

MORE INFORMATION

For more information on this matter, including access to drawings illustrating this request:

- Visit www.hamilton.ca/committeeofadjustment
- Call 905-546-CITY (2489) or 905-546-2424 extension 4221, 4130, or 3935
- Email Committee of Adjustment staff at cofa@hamilton.ca

DATED: November 9th, 2021.

Jamila Sheffield,
Secretary-Treasurer
Committee of Adjustment

Information respecting this application is being collected under the authority of the Planning Act, R.S.O., 1990, c. P. 13. All comments and opinions submitted to the City of Hamilton on this matter, including the name, address, and contact information of persons submitting comments and/or opinions, will become part of the public record and will be made available to the Applicant and the general public.

CONCESSION STREET
(ROAD ALLOWANCE BETWEEN CONCESSIONS 3 AND 4)
PIN 17115-0056(LT)

TOPOGRAPHIC SURVEY OF
LOT 2
REGISTERED PLAN No.700
IN THE
CITY OF HAMILTON
SCALE 1 : 150
3 1.5 0 6 METRES

ASHENHURST NOUWENS & ASSOCIATES INC.
COPYRIGHT 2019 ©

METRIC NOTE
DISTANCES AND ELEVATIONS SHOWN ON THIS PLAN ARE IN METRES AND CAN BE CONVERTED TO FEET BY DIVIDING BY 0.3048.

REGISTERED EASEMENTS AND/OR RIGHT-OF-WAY.
NONE

THIS SURVEY WAS PREPARED FOR NASKO IVANOV AND THE UNDERSIGNED ACCEPTS NO RESPONSIBILITY FOR USE BY OTHER PARTIES.


BENCHMARK
CITY OF HAMILTON BENCHMARK No. 07720100076
MONUMENT IS LOCATED AT THE SOUTH WEST CORNER OF JACK C. BEEMER PARK, ~11m NORTH OF THE C. OF KING WILLIAM STREET AND ~ 29m EAST OF THE C. OF VICTORIA STREET NORTH.
ELEVATION = 90.174 (DATUM CGVD 1928:1978)

NOTE
NOTE THE LOCATION OF THE BUILDINGS ALONG THE NORTH, EAST AND WEST LIMITS OF THE PROPERTY
NOTE THE LOCATION OF THE FENCES ALONG THE WEST, EAST AND SOUTH LIMITS OF THE PROPERTY
NOTE THE LOCATION OF THE AWNING ON THE NORTH FACE OF THE BUILDING

BEARING NOTE
BEARINGS ARE ASTRONOMIC AND ARE REFERRED TO THE SOUTHERLY LIMIT OF CONCESSION STREET AS SHOWN ON PLAN 700 HAVING A BEARING OF N69°11'00"W

- LEGEND**
- DENOTES FOUND
 - DENOTES PLANTED
 - IB DENOTES IRON BAR
 - PK DENOTES PK NAIL
 - CC DENOTES CUT CROSS
 - M DENOTES MEASURED
 - OJ DENOTES ORIGIN UNKNOWN
 - WIT DENOTES WITNESS
 - P1 DENOTES REGISTERED PLAN No.700
 - P2 DENOTES PLAN OF SURVEY BY ASHENHURST NOUWENS O.L.S., DATED JUNE 17, 1988
 - BLD DENOTES BUILDING
 - CLF DENOTES CHAIN LINK FENCE
 - DT DENOTES DECIDUOUS TREE
 - FF DENOTES FIRST FLOOR ELEVATION
 - MH DENOTES MANHOLE
 - OH DENOTES OVERHEAD UTILITY
 - WV DENOTES WATER VALVE
 - UP DENOTES UTILITY POLE
 - 824 DENOTES A. T. MCLAREN, O.L.S.
 - 912 DENOTES A. J. CLARKE, O.L.S.
 - ANC DENOTES ANCHOR
 - CB DENOTES CATCH BASIN

ASSOCIATION OF ONTARIO LAND SURVEYORS
PLAN SUBMISSION FORM
2082211



THIS PLAN IS NOT VALID UNLESS IT IS AN EMBOSSED ORIGINAL COPY ISSUED BY THE SURVEYOR in accordance with Regulation 1026, Section 29(3).

SURVEYOR'S CERTIFICATE
I CERTIFY THAT:
1. THIS SURVEY AND PLAN ARE CORRECT AND IN ACCORDANCE WITH THE SURVEYS ACT, THE SURVEYORS ACT, THE LAND TITLES ACT AND THE REGULATIONS MADE UNDER THEM.
2. THE SURVEY WAS COMPLETED ON THE 3RD DAY OF MAY, 2019.


MAY 2 2019 / DATE
HARRY KALANTZAKOS
ONTARIO LAND SURVEYOR

ASHENHURST NOUWENS & ASSOCIATES INC.
PROFESSIONAL ENGINEERS & ONTARIO LAND SURVEYORS
225 KING WILLIAM STREET, SUITE 204, HAMILTON, ONTARIO L8R 1B1
TELEPHONE: (905) 529-6316
(905) 529-4314
FAX: (905) 529-6651
e-mail: ani@AshenhurstNouwens.ca



SINCE 1956

DRAWN BY W.S.	CALCD BY W.S.	CHK'D BY H.K.	FILE No. 19037 TOPO
------------------	------------------	------------------	------------------------

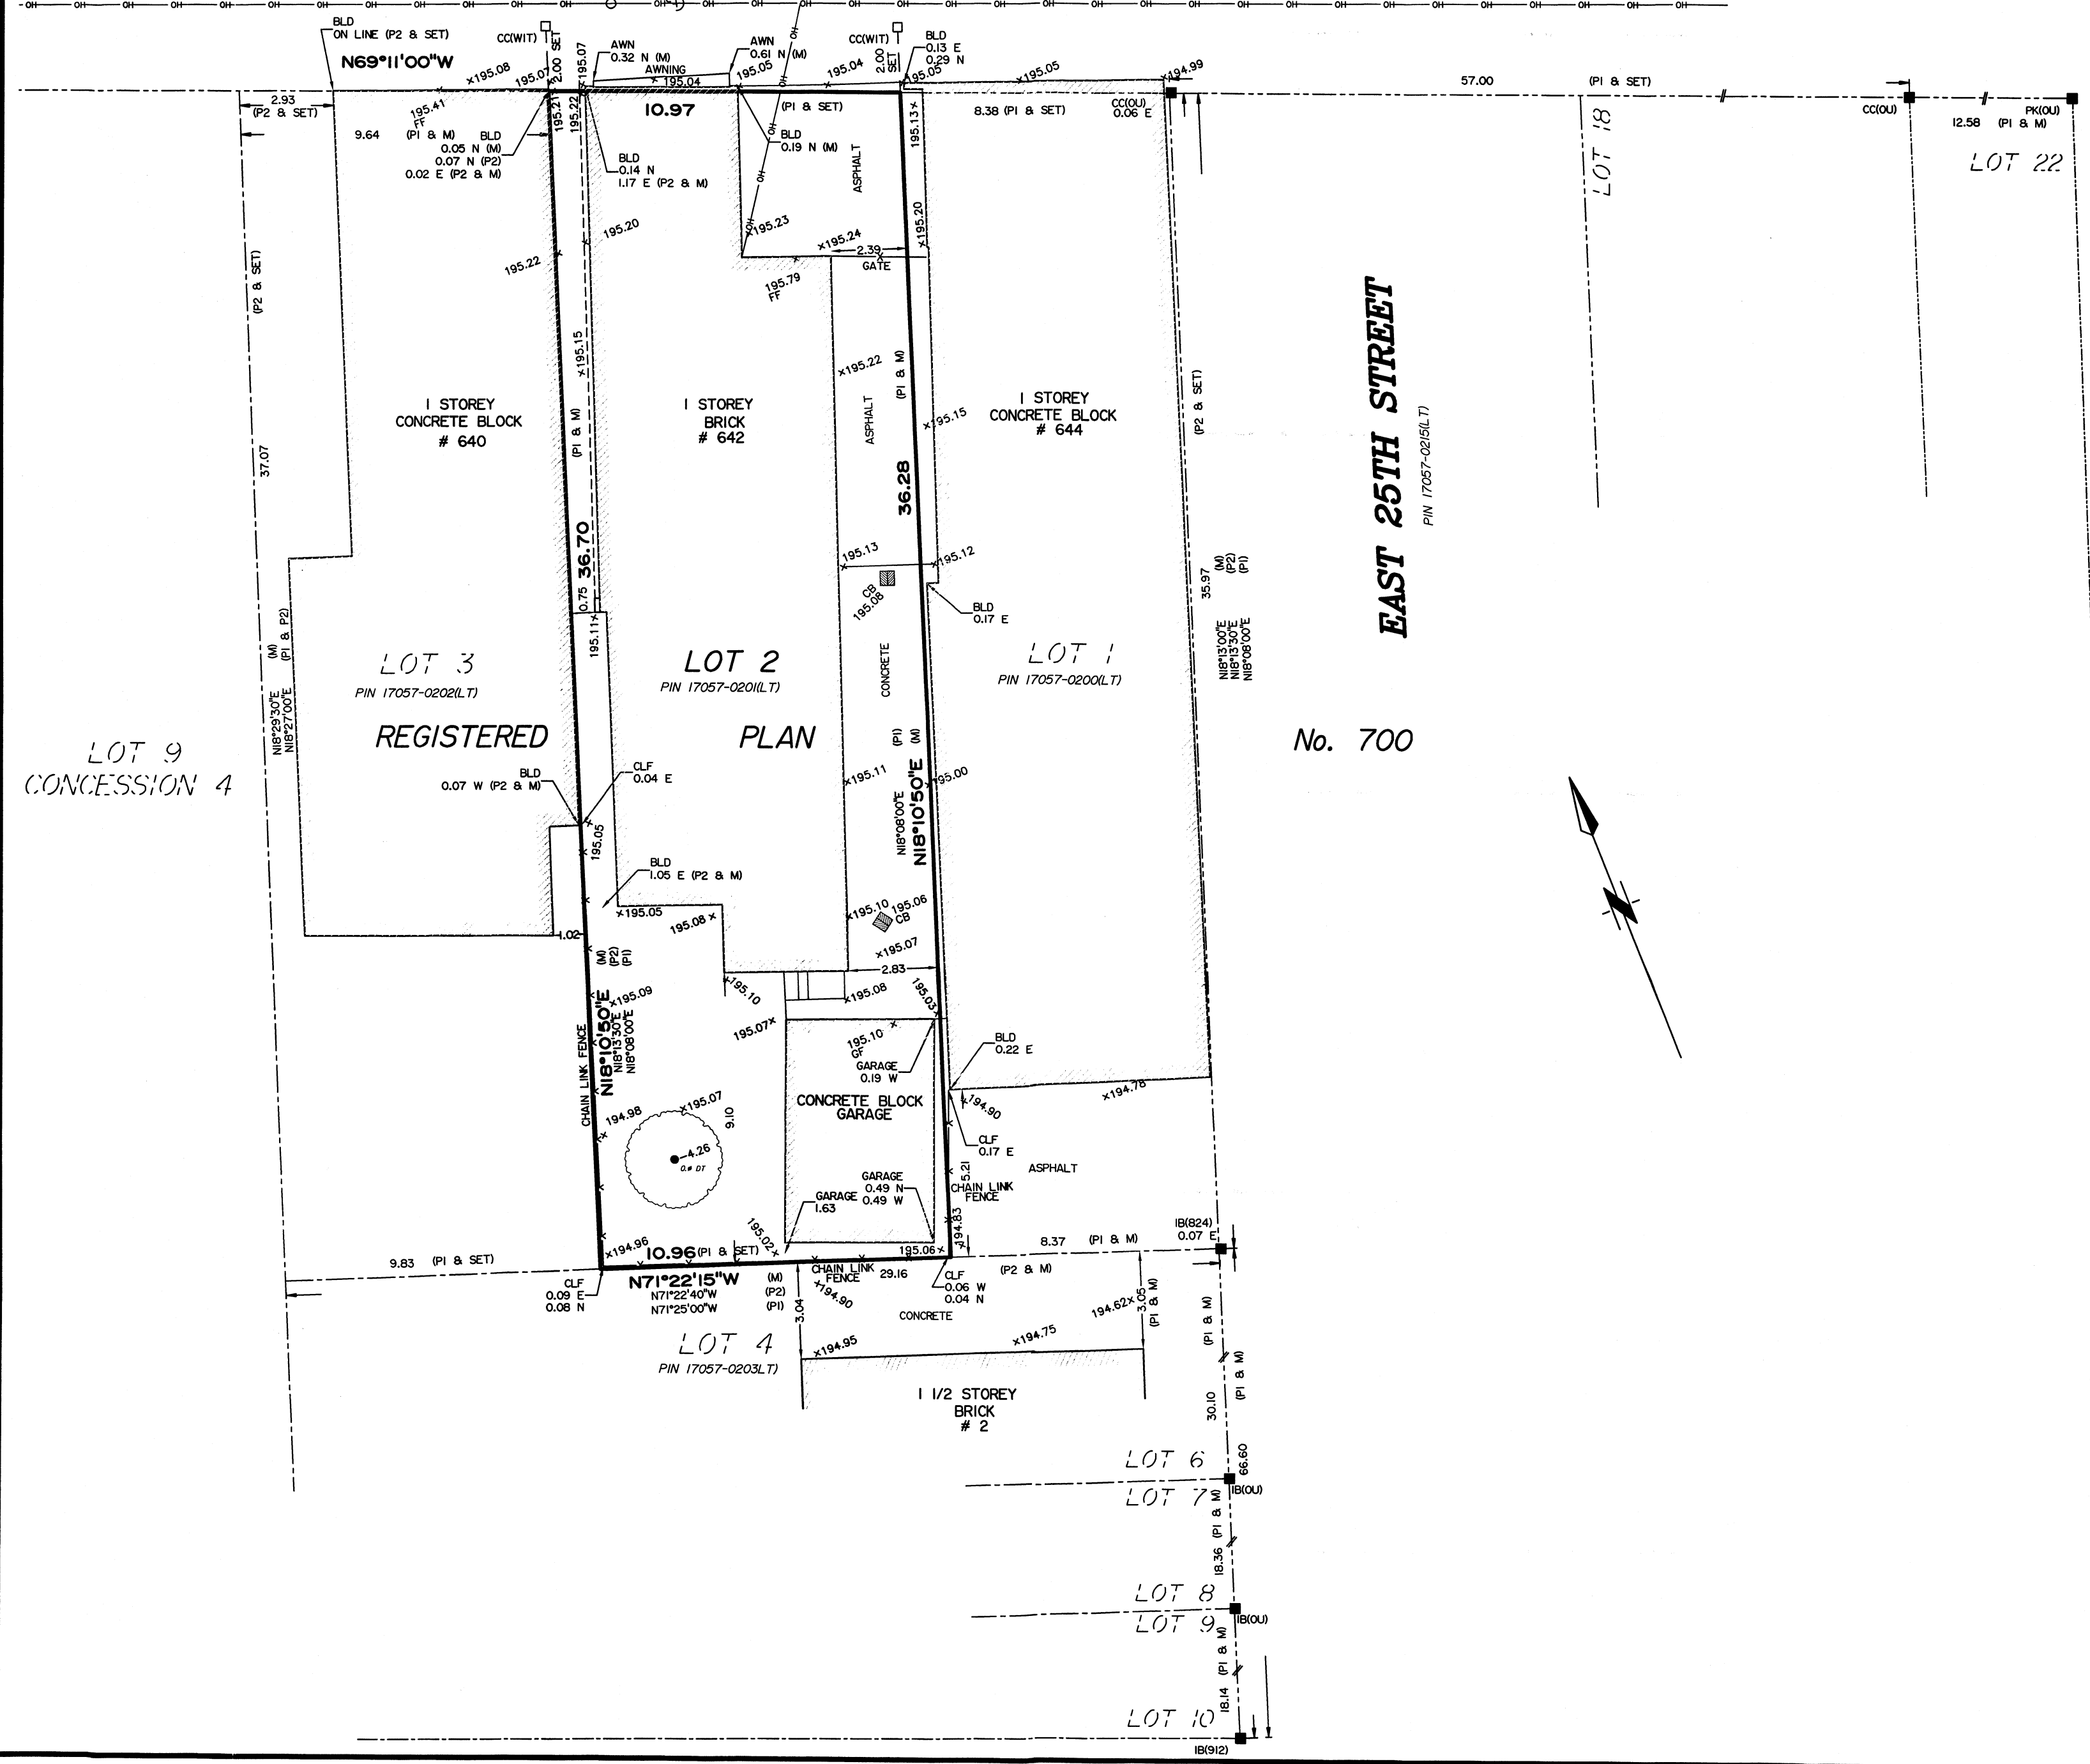

LOT 9
CONCESSION 4

No. 700

ALLEYWAY

EAST 25TH STREET
PIN 17057-0205(LT)

LOT 3
PIN 17057-0202(LT)

LOT 2
PIN 17057-0201(LT)

LOT 1
PIN 17057-0200(LT)

LOT 4
PIN 17057-0203(LT)

LOT 6

LOT 7

LOT 8

LOT 9

LOT 10

TOPOGRAPHIC SURVEY OF
LOT 2
 REGISTERED PLAN No.700
 IN THE
 CITY OF HAMILTON

ASHENHURST NOUWENS & ASSOCIATES INC.
 COPYRIGHT 2019 ©

METRIC NOTE
 DISTANCES AND ELEVATIONS SHOWN ON THIS PLAN ARE
 IN METRES AND CAN BE CONVERTED TO FEET BY
 DIVIDING BY 0.3048.


BEARING NOTE
 BEARINGS ARE ASTRONOMIC AND ARE REFERRED TO THE
 SOUTHERLY LIMIT OF CONCESSION STREET AS SHOWN ON
 PLAN 700 HAVING A BEARING OF N69°11'00"W

- ALECTRA UTILITIES
 1- RELOCATION, MODIFICATION, OR REMOVAL OF ANY EXISTING HYDRO FACILITIES, SHALL
 BE AT THE OWNERS EXPENSE.
- 2- DO NOT EXCAVATE WITHIN 2M OF HYDRO POLE OR ANCHORS.
- 3- EXCAVATION WITHIN 1M OF UNDERGROUND HYDRO PLANT IS NOT PERMITTED UNLESS
 APPROVAL IS GRANTED BY A HORIZON UTILITIES REPRESENTATIVE AND IS PRESENT TO
 PROVIDE DIRECT SUPERVISION. COST ASSOCIATED WITH THIS TASK SHALL BE AT THE
 OWNERS EXPENSE.
- 4- ALECTRA UTILITIES MUST BE CONTACTED IF REMOVAL, ISOLATION OR RELOCATION OF
 EXISTING PLAN IS REQUIRED, ALL COST ASSOCIATED WITH THIS WORK WILL BE AT THE
 OWNERS EXPENSE.


GENERAL NOTES:

- ALL WORK INVOLVED IN THE CONSTRUCTION, RELOCATION, REPAIR OF MUNICIPAL SERVICES FOR THE PROJECT SHALL BE TO THE SATISFACTION OF THE DIRECTOR OF PLANNING AND CHIEF PLANNER, PLANNING AND ECONOMIC DEVELOPMENT DEPARTMENT
- FIRE ROUTE SIGNS AND 3-WAY FIRE HYDRANTS SHALL BE ESTABLISHED TO THE SATISFACTION OF THE CITY FIRE DEPARTMENT AND AT THE EXPENSE OF THE OWNER
- MAIN DRIVEWAY DIMENSIONS AT THE PROPERTY LINE BOUNDARIES ARE PLUS OR MINUS 7.5M UNLESS OTHERWISE STATED
- ALL DRIVEWAYS FROM PROPERTY LINES FOR THE FIRST 7.5M SHALL BE WITHIN 5% MAXIMUM GRADE, THEREAFTER, ALL DRIVEWAYS SHALL BE WITHIN 10% MAXIMUM GRADES.
- THE APPROVAL OF THIS PLAN DOES NOT EXEMPT THE OWNER'S BONDED CONTRACTOR FROM THE REQUIREMENTS TO OBTAIN THE VARIOUS PERMITS/APPROVALS NORMALLY REQUIRED TO COMPLETE A CONSTRUCTION PROJECT, SUCH AS, BUT NOT LIMITED TO THE FOLLOWING:
 - BUILDING PERMIT
 - SEWER AND WATER PERMITS
 - ROAD CUT PERMIT
 - RELOCATION OF SERVICES
 - APPROACH APPROVAL PERMITS
 - ENCROACHMENT AGREEMENTS
 - COMMITTEE OF ADJUSTMENT (IF REQUIRED)
- ABANDONED ACCESSES MUST BE REMOVED AND THE CURB AND BOULEVARD RESTORED WITH SOD AT THE OWNER'S EXPENSE TO THE SATISFACTION OF THE CORRIDOR MANAGEMENT SECTION, PUBLIC WORKS DEPARTMENT
- FOR VISIBILITY TRIANGLES AT THE VEHICULAR ACCESS POINTS, FOLLOWING NOTE TO BE PROVIDED:

METRE BY METRE VISIBILITY TRIANGLES IN WHICH THE MAXIMUM HEIGHT OF ANY OBJECTS OR MATURE VEGETATION IS NOT TO EXCEED A HEIGHT OF 0.70 METRES ABOVE THE CORRESPONDING PERPENDICULAR CENTRELINE ELEVATION OF THE ADJACENT STREET
- ALL SIGNS MUST COMPLY WITH SIGN BY-LAW NO. 10-197
- THIS PROPERTY IS ELIGIBLE FOR WEEKLY COLLECTION OF GARBAGE, RECYCLING, ORGANICS, AND LEAF AND YARD WASTE THROUGH THE CITY OF HAMILTON SUBJECT TO COMPLIANCE WITH SPECIFICATIONS INDICATED BY THE PUBLIC WORKS DEPARTMENT AND SUBJECT TO COMPLIANCE WITH THE CITY'S SOLID WASTE MANAGEMENT BY-LAW 08-067, AS AMENDED.
- ALL FENCING SHALL CONFORM TO HAMILTON FENCE BY-LAW NO 10-142.
- UNION GAS CANON GAS HAS SERVICE LINES RUNNING WITHIN THE AREA WHICH MAY OR MAY NOT BE AFFECTED BY THE DEVELOPMENT. SHOULD THE SITE PLAN IMPACT THE SERVICES IT MAY BE NECESSARY TO

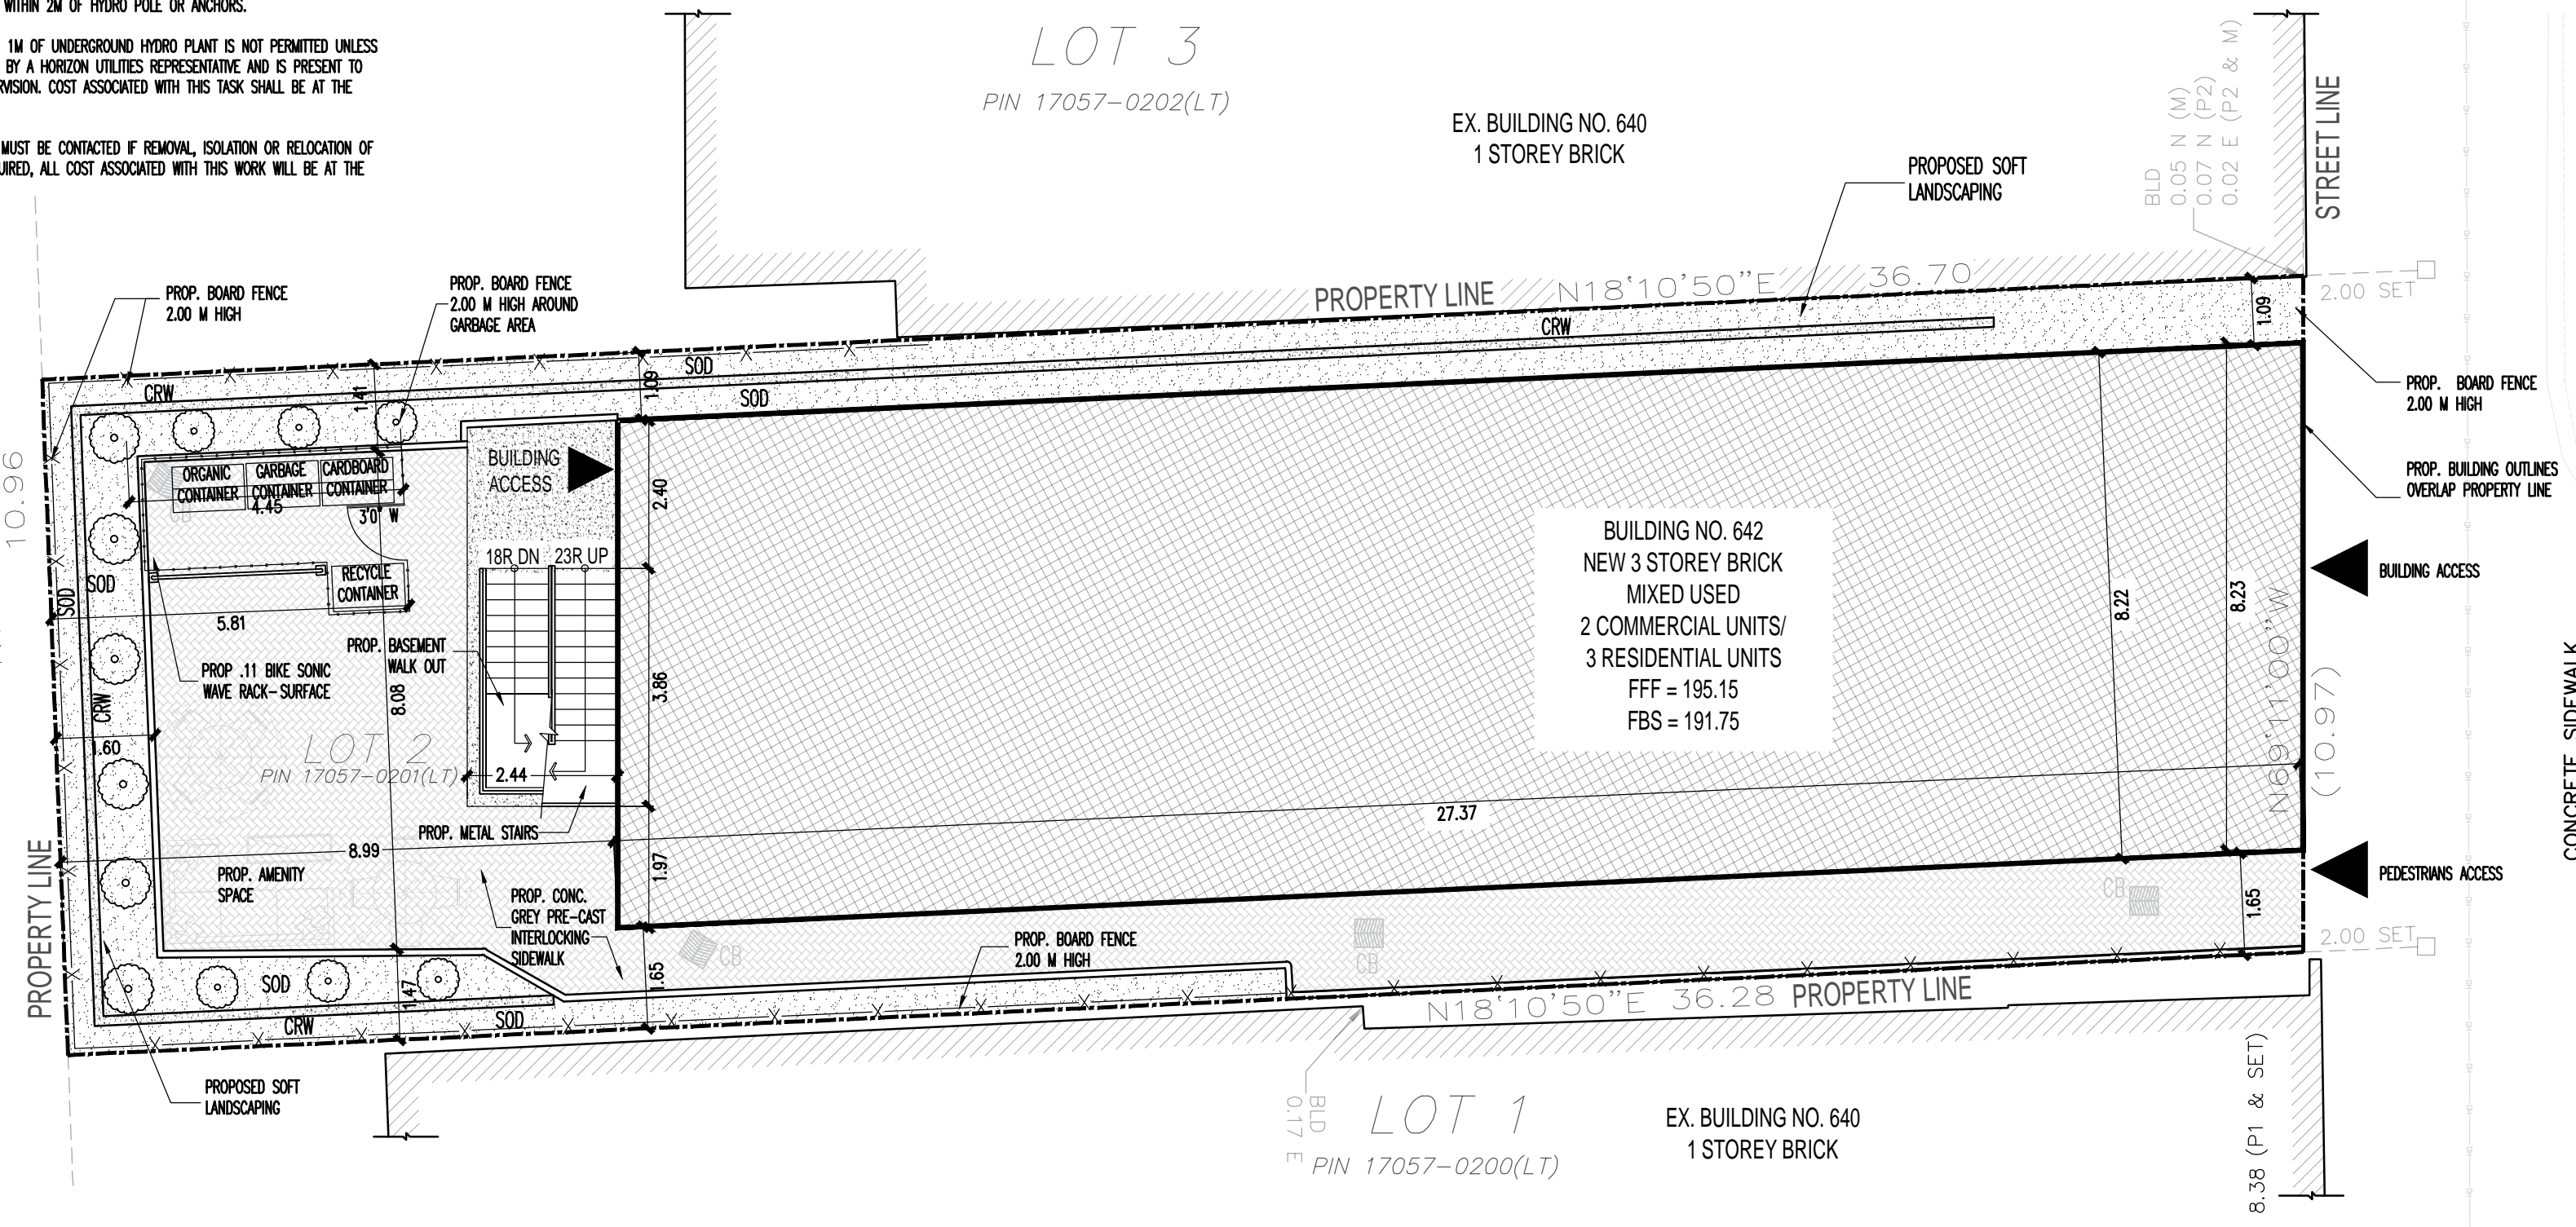

SITE PLAN
 SCALE: 1:100

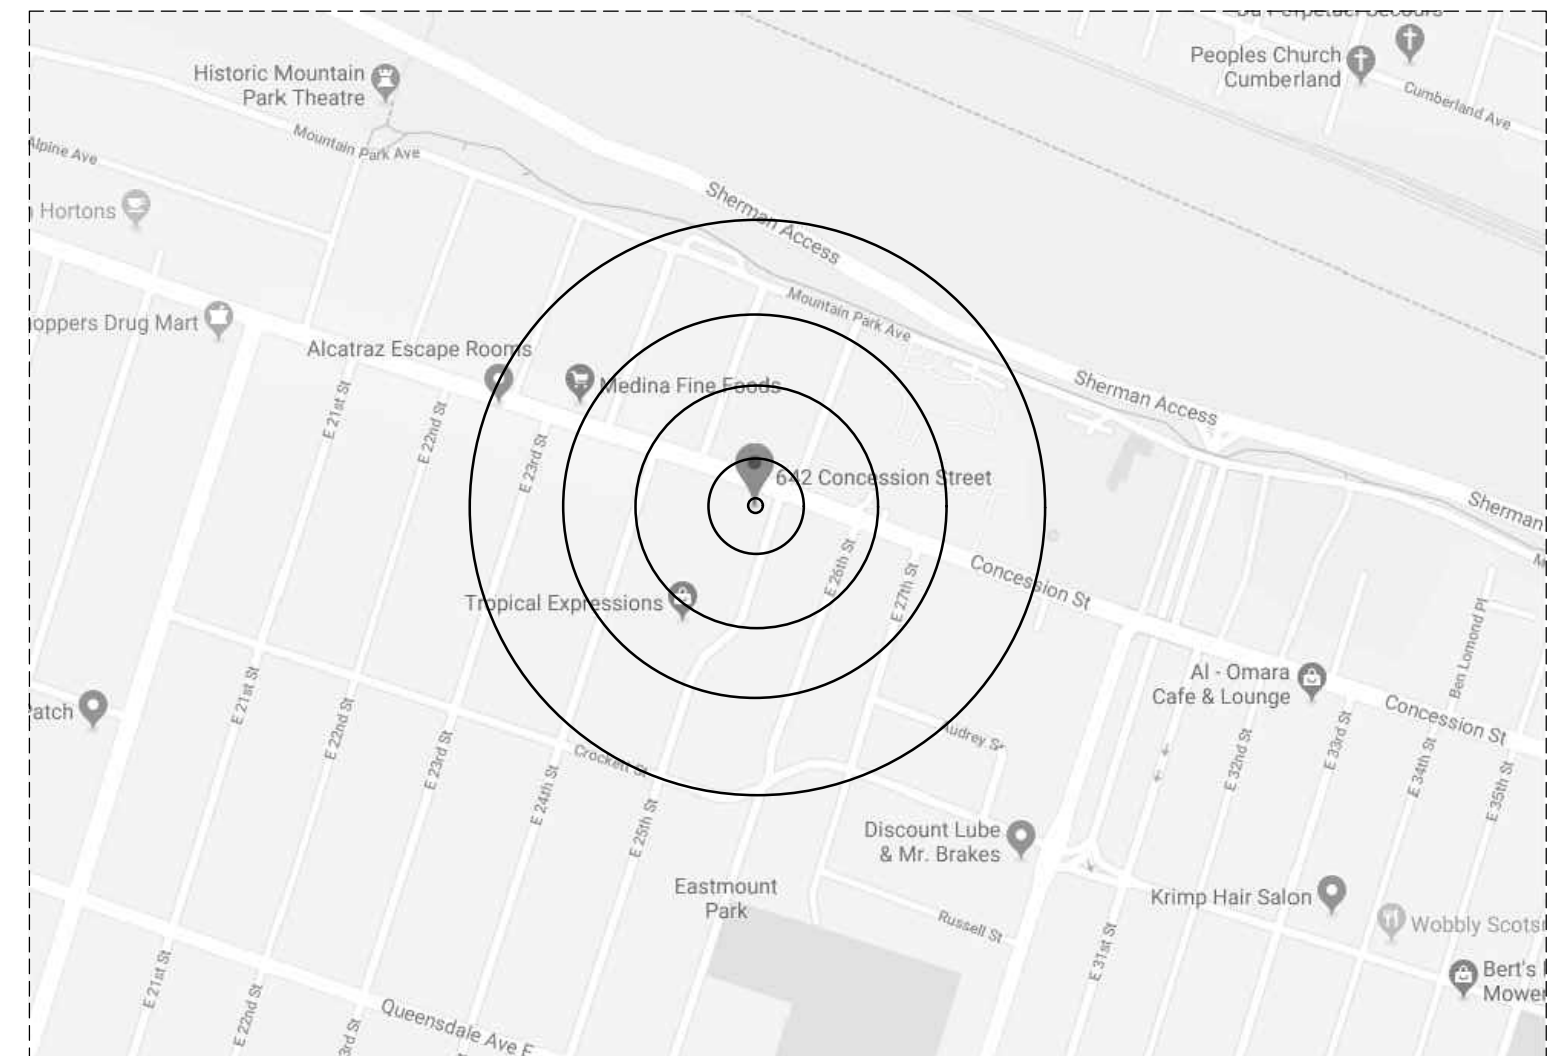

KEY PLAN
 SCALE: N/A

ZONING AND SITE RESTRICTION

MUNICIPALITY AND PROJECT INFORMATION	
PROJECT TYPE AND DESCRIPTION	NEW COMMERCIAL/RESIDENTIAL 3 STOREY BUILDING
MUNICIPALITY	HAMILTON, WARD 7
ZONING DESIGNATION	C5c; HI=22.0m

LOT SIZE (PROPERTY LINE)	EXISTING (m)	SETBACKS	PERMITTED (m)	PROPOSED (m)
WEST	33.7	FRONT YARD	3.0 m [MAX]	0.0 m
EAST	33.3	SIDE YARD EAST	0.0 m	1.65 m
NORTH	10.9	SIDE YARD WEST	0.0 m	1.09 m
SOUTH	10.9	REAR YARD	7.5 m	8.99 m
		BUILDING HEIGHT	22.0 m	12.60 m

LOT AREA	
TOTAL LOT AREA	4,306.61 ft² / 400.1 m²

	PERMITTED (ft²/m²)	EXISTING (ft²/m²)	PROPOSED (ft²/m²)	NEW TOTAL (ft²/m²)
LOT COVERAGE	N/A	0.0 ft² / 0.0 m²	2,421.63 ft² (56.8%) / 224.98 m²	2,421.63 ft² (56.8%) / 224.98 m²
MAX. GROSS FLOOR AREA	26,909.7 ft² / 2,500.00 m²	0.0 ft² / 0.0 m²	7,264.89 ft² (168.7%) / 674.93 m²	7,264.89 ft² (168.7%) / 674.93 m²
FIRST FLOOR AREA	0.0 ft² / 0.0 m²	0.0 ft² / 0.0 m²	2,421.63 ft²	2,421.63 ft²
SECOND FLOOR AREA	0.0 ft² / 0.0 m²	0.0 ft² / 0.0 m²	2,421.63 ft²	2,421.63 ft²
NEW TOTAL AREA	0.0 ft² / 0.0 m²	0.0 ft² / 0.0 m²	2,421.63 ft²	2,421.63 ft²



TOTAL UNIT AREAS	ft²	m²
BASEMENT FLOOR LEVEL	2,421.63	224.98
- STORAGE	1,725.99	160.35
- COMMON AREA	695.64	64.63
FIRST FLOOR LEVEL	2,421.63	224.98
- UNIT 1 AREA	1,688.31	156.85
- COMMON AREA	733.32	68.13
SECOND FLOOR LEVEL	2,421.63	224.98
- UNIT 2 AREA	1,766.08	164.07
- COMMON AREA	655.55	60.91
THIRD FLOOR LEVEL	2,421.63	224.98
- UNIT 3 AREA	537.81	49.97
- UNIT 4 AREA	538.18	49.99
- UNIT 5 AREA	537.83	49.97
- COMMON AREA	807.78	75.05

LANDSCAPING - FRONT	PERMITTED (ft²/m²)	PROPOSED (ft²/m²)
FRONT YARD	N/A	0.0 ft² / 0.0 m²
TOTAL LANDSCAPING	N/A	(0.0%) 0.0 ft² / 0.0 m²

LANDSCAPING - REAR	PERMITTED (ft²/m²)	PROPOSED (ft²/m²)
REAR YARD	N/A	1,073.79 / 99.76
TOTAL LANDSCAPING	N/A	948.99 / 88.16
SOFT LANDSCAPING	N/A	328.53 / 30.52

GENERAL NOTES:

- NO WORK TO ENCRUCH ON ADJOINING PROPERTIES
- SMOKE ALARMS SHALL BE INSTALLED ON EACH STOREY OF A DWELLING UNIT. INCLUDING BASEMENTS CITY OF TORONTO BY-LAW 1994-0580 AND O.B.C. 9.10.18.2. [1] [a] [b] and [c]
- CARBON MONOXIDE DETECTORS : SHALL BE INSTALLED AS PER CITY OF TORONTO BY-LAW No. 60-1998
- CARBON MONOXIDE DETECTORS : IN EACH ROOM THAT CONTAINS A FUEL BURNING APPLIANCE PROVIDE A CARBON MONOXIDE DETECTOR ON OR NEAR THE CEILING EQUIPPED WITH AN ALARM AUDIBLE THROUGHOUT DWELLING UNIT OR INTERCONNECT WITH SMOKE ALARM SO THAT WHEN THE CARBON MONOXIDE DETECTOR IS ACTIVATED, IT WILL ACTIVATE THE SMOKE ALARM AS PER O.B.C. 9.33.4.1.[1] AND AS PER O.B.C. 9.33.4.2.[1] [2] AND [4]
- EXCAVATION NOTES : EXCAVATION AND / OR CONSTRUCTION ON ADJACENT PROPERTIES REQUIRES THE CONSENT OF AFFECTED PROPERTY OWNER(S).
- EVERY EXCAVATION SHALL BE UNDERTAKEN IN A MANNER AS TO PREVENT MOVEMENT WHICH WOULD CAUSE DAMAGE TO ADJACENT PROPERTY. EXISTING STRUCTURES, UTILITIES, ROADS AND SIDEWALKS AT ALL STAGES OF CONSTRUCTION.
- MIN. SOIL BEARING CAPACITY 75KPa. SOIL IS NOT PEAT, FILL OR SENSITIVE CLAY. THE DISTANCE BETWEEN THE BOTTOM OF FOOTINGS AND THE WATER TABLE IS EQUAL TO OR GREATER THAN THE WIDTH OF THE FOOTGS.
- WHERE THE DEPTH OF EXCAVATION EXCEEDS 4'-0", EXCAVATE AT 45° ANGLE OR IN ACCORDANCE WITH APPROVED SHORING DETAILS. STRUCTURE IS NOT LOCATED ON GROUNDS HAVING A SLOPE STEEPER THAN 1 VERTICAL TO 2 HORIZONTAL.
- SURFACE DRAINAGE SHALL NOT BE DISCHARGED DIRECTLY OR INDIRECTLY ONTO A SIDEWALK, DRIVEWAY, STAIRWAY OR AN ADJOINING PROPERTY.
- TREES ON PRIVATE PROPERTY NO PERSON SHALL WITHIN THE CITY'S BOUNDARIES, INJURE OR DESTROY ANY TREE HAVING A DIAMETER OF 30 cm (12 INCHES) OR MORE, MEASURED AT 1.4 m (4'-7") ABOVE GROUND LEVEL UNLESS SO AUTHORIZED BY PERMIT FROM THE COMMISSIONER OF PARKS AND RECREATION, PER MUNICIPAL CODE CHAPTER 331.

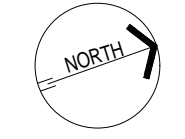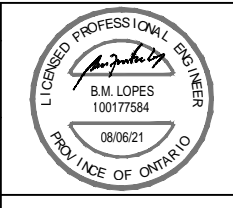

PROJECT	642 CONCESSION ST		SCALE	1 : 100
DATE	AUGUST 2021		JOB No.	36-319
TITLE	SITE PLAN		FILE No.	DA-19-176
DRAWING No.	SP1.01			

Name of Practice: MXL Engineering 1649 St Clair Ave W - ON M6N 1H7	
Name of Project: 642 Concession St Mixed Use Building	
Location: 642 Concession St - Hamilton	
Date: AUG-2020	
Ontario Building Code Data Matrix Part 11 – Renovation of Existing Building	
11.00	Building Code Version: <u>O. Reg. 332/12</u> Last Amendment <u>O. Reg. 191/14</u> Building Code Reference 1
11.01	Project Type: Addition Renovation Addition and renovation X Change of use Description: PROP. 3 STOREY MIXED USE BUILDING [A] 1.1.2.
11.02	Major Occupancy Classification: Use <u>35</u> <u>GROUP D - COMMERCIAL OFFICE</u> <u>6</u> <u>GROUP C - DWELLING UNIT</u> 3.1.2.1.(1)
11.03	Superimposed Major Occupancies: X No Yes Description: 3.2.2.7.
11.04	Building Area (m2): Description: Existing New Total <u>Commercial Office</u> .0 449.96 449.96 <u>Dwelling Unit</u> .0 224.98 224.98 <u>Storage</u> .0 224.98 224.98 [A] 1.4.1.2. <small>Insert additional lines as needed</small>
11.05	Building Height: 3 Storeys above grade 12.6 (m) Above grade 1 Storeys below grade [A] 1.4.1.2. & 3.2.1.1.
11.06	Number of Streets/Firefighter access: 1 street(s) 3.2.2.10. & 3.2.5.
11.07	Building Size: Small Medium Large T.11.2.1.1.B.-N.



11.08	Existing Building Classification: A2 Restaurant Change in Major Occupancy: Yes Not Applicable Construction Index: 3 Hazard Index: 3 11.2.1.1. T 11.2.1.1A T 11.2.1.1B to N 4.2.1.(3), 5.2.2.1.(2)
11.09	Renovation type: Basic Renovation Extensive Renovation X N/A 11.3.3.1. 11.3.3.2.
11.10	Occupant Load: Floor Level/Area Occupancy Type Based On Occupant Load (Persons) 1st/2nd Floor - Office .D .Area 35 3rd Floor - Residential .C .Personel 6 Insert additional lines as needed
11.11	Plumbing Fixture Requirements: Ratio: M/F = 1/1 Except as otherwise noted Floor Level/Area Occupant OBC Load Reference Fixtures Required Fixtures Provided 1st Floor - Office 17 .4 2 2 1st/2nd Floor - Office 18 .4 2 2 Insert additional lines as needed
11.12	Barrier-free Design: X Yes Explanation No 11.3.3.2.(2)
11.13	Reduction in Performance Level: Structural: No Yes X N/A 11.4.2.1. By increase in occupant load: No Yes X N/A 11.4.2.2. By change of major occupancy: No Yes X N/A 11.4.2.3. Plumbing: No Yes X N/A 11.4.2.4. Sewage-systems: No Yes X N/A 11.4.2.5. Extension of combustible construction: No Yes X N/A 11.4.2.6.

11.14	Compensating Construction:	No Yes X N/A	11.4.3.1.
11.15	Compliance Alternatives Proposed:	No Yes X N/A	11.5.1.
11.16	Notes:		11.5.1.

Insert additional lines as needed

1 All references are to Division B of the OBC unless preceded by [A] for Division A and [C] for Division C.

NO.	DESCRIPTION OF ISSUE	DATE	NO.	DESCRIPTION OF ISSUE	DATE
1	CITY COMMENTS REV01 SUBMISSION	02/22/2020	5	CITY COMMENTS REVIEW SUBMISSION	03/30/2021
2	CITY COMMENTS REV02 SUBMISSION	05/12/2020	6	CITY COMMENTS REVIEW SUBMISSION	08/02/2021
3	ISSUED FOR BUILDING PERMIT APPLICATION	08/11/2020	7		
4	REVIEWED FOR BUILDING PERMIT APPLICATION	08/28/2020	8		

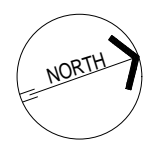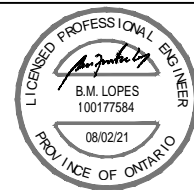

PROJECT	642 CONCESSION ST		SCALE	1 : 100	
TITLE	MATRIX 11		DATE	AUGUST 2021	
	JOB No.	36-319	FILE No.	DA-19-176	
	DRAWING No.	A0.01			

BEAM SCHEDULE:

- BM-1 W12X40 STEEL BEAM
- BM-2 W12X53 STEEL BEAM
- BM-3 W12X30 STEEL BEAM

FLOOR JOISTS SCHEDULE:

- FJ-1 11 7/8" S47 FLR. JSTS @12" O.C. W/ 3/4" OSB SUBFLOOR (GLUED-NAILED)
- RJ-1 14" TJI S47 JSTS @ 16" O.C.

COLUMN SCHEDULE:

- COL-1 W12X22 STEEL COLUMN W/ 10"x10"x 1/2" TOP PLATE WELDED TO COL. & 12"x12"x 1/2" BOTTOM PLATE WELDED TO COL. ANCHORED W/ 2- 1/2" DIA. X 12" LONG X 2" HOOK ANCHORS TO 60"x 60"x 20"(H) 20 MPa CONCRETE FOOTING ON UNDISTURBED SOIL
- COL-2 W12X22 STEEL COLUMN W/ 10"x10"x 1/2" TOP PLATE WELDED TO COL. & 10"x10"x 1/2" BOTTOM PLATE WELDED TO COL.
- COL-3 W12X22 STEEL COLUMN W/ 8"x8"x 3/8" TOP PLATE WELDED TO COL. & 8"x8"x 3/8" BOTTOM PLATE WELDED TO COLUMN TO FOUND WALL W/ 2- 1/2" DIA. X 12" LONG X 2" HOOK ANCHORS
- COL-4 W12X22 STEEL COLUMN W/ 8"x8"x 3/8" TOP PLATE WELDED TO COL. & 8"x8"x 3/8" BOTTOM PLATE WELDED TO COLUMN

(W) NEW RATED LOAD BEARING PARTITION WALL


1 HOUR FIRE RATED, WITH MIN. STC RATING 51, AS PER SB-3 W4b
 2 LAYERS 5/8" TYPE "X" GYP. WALL BRD. APPLIED TO RESILIENT MET. CHANNELS @ 16" O.C. INSIDE OF 2" X 4" OR 2"x6" MET. STUDS @ 16" O.C., (48 GAUGE), ONE LAYER 5/8" TYPE "X" GYP. WALL BRD. ON THE OTHER SIDE OF STUDS C/W 5 1/2" SOUND ABSORPTIVE INSUL. TO U/S OF SUB-FLOOR ABOVE.

(C) NEW CEILING

1 HOUR FIRE RATED WITH STCS2 REFER TO ULC DESIGN NO. M501
 FILL JOIST CAVITY W/ SOUND PROOF INSUL. (SOUND TRANSMISSION TO CONFORM TO O.B.C. 9.11.21.) C/W 5/8" RESILIENT MET. FURRING CHANNELS @ 16" O.C. PERPENDICULAR TO FLOOR JOISTS W/ 1/2" TYPE "X" GYP. WALL BRD. W/ PAINTED FINISH (TYP.)

LEGEND



- SMOKE ALARM
- CARBON MONOXIDE DETECTOR
- MECHANICAL VENTILATION
- HOSE BIB
- SOLID WOOD BEARING
- POINT LOAD
- EXIST'G WALL TO REMAIN
- FLOOR DRAIN
- AREA DRAIN

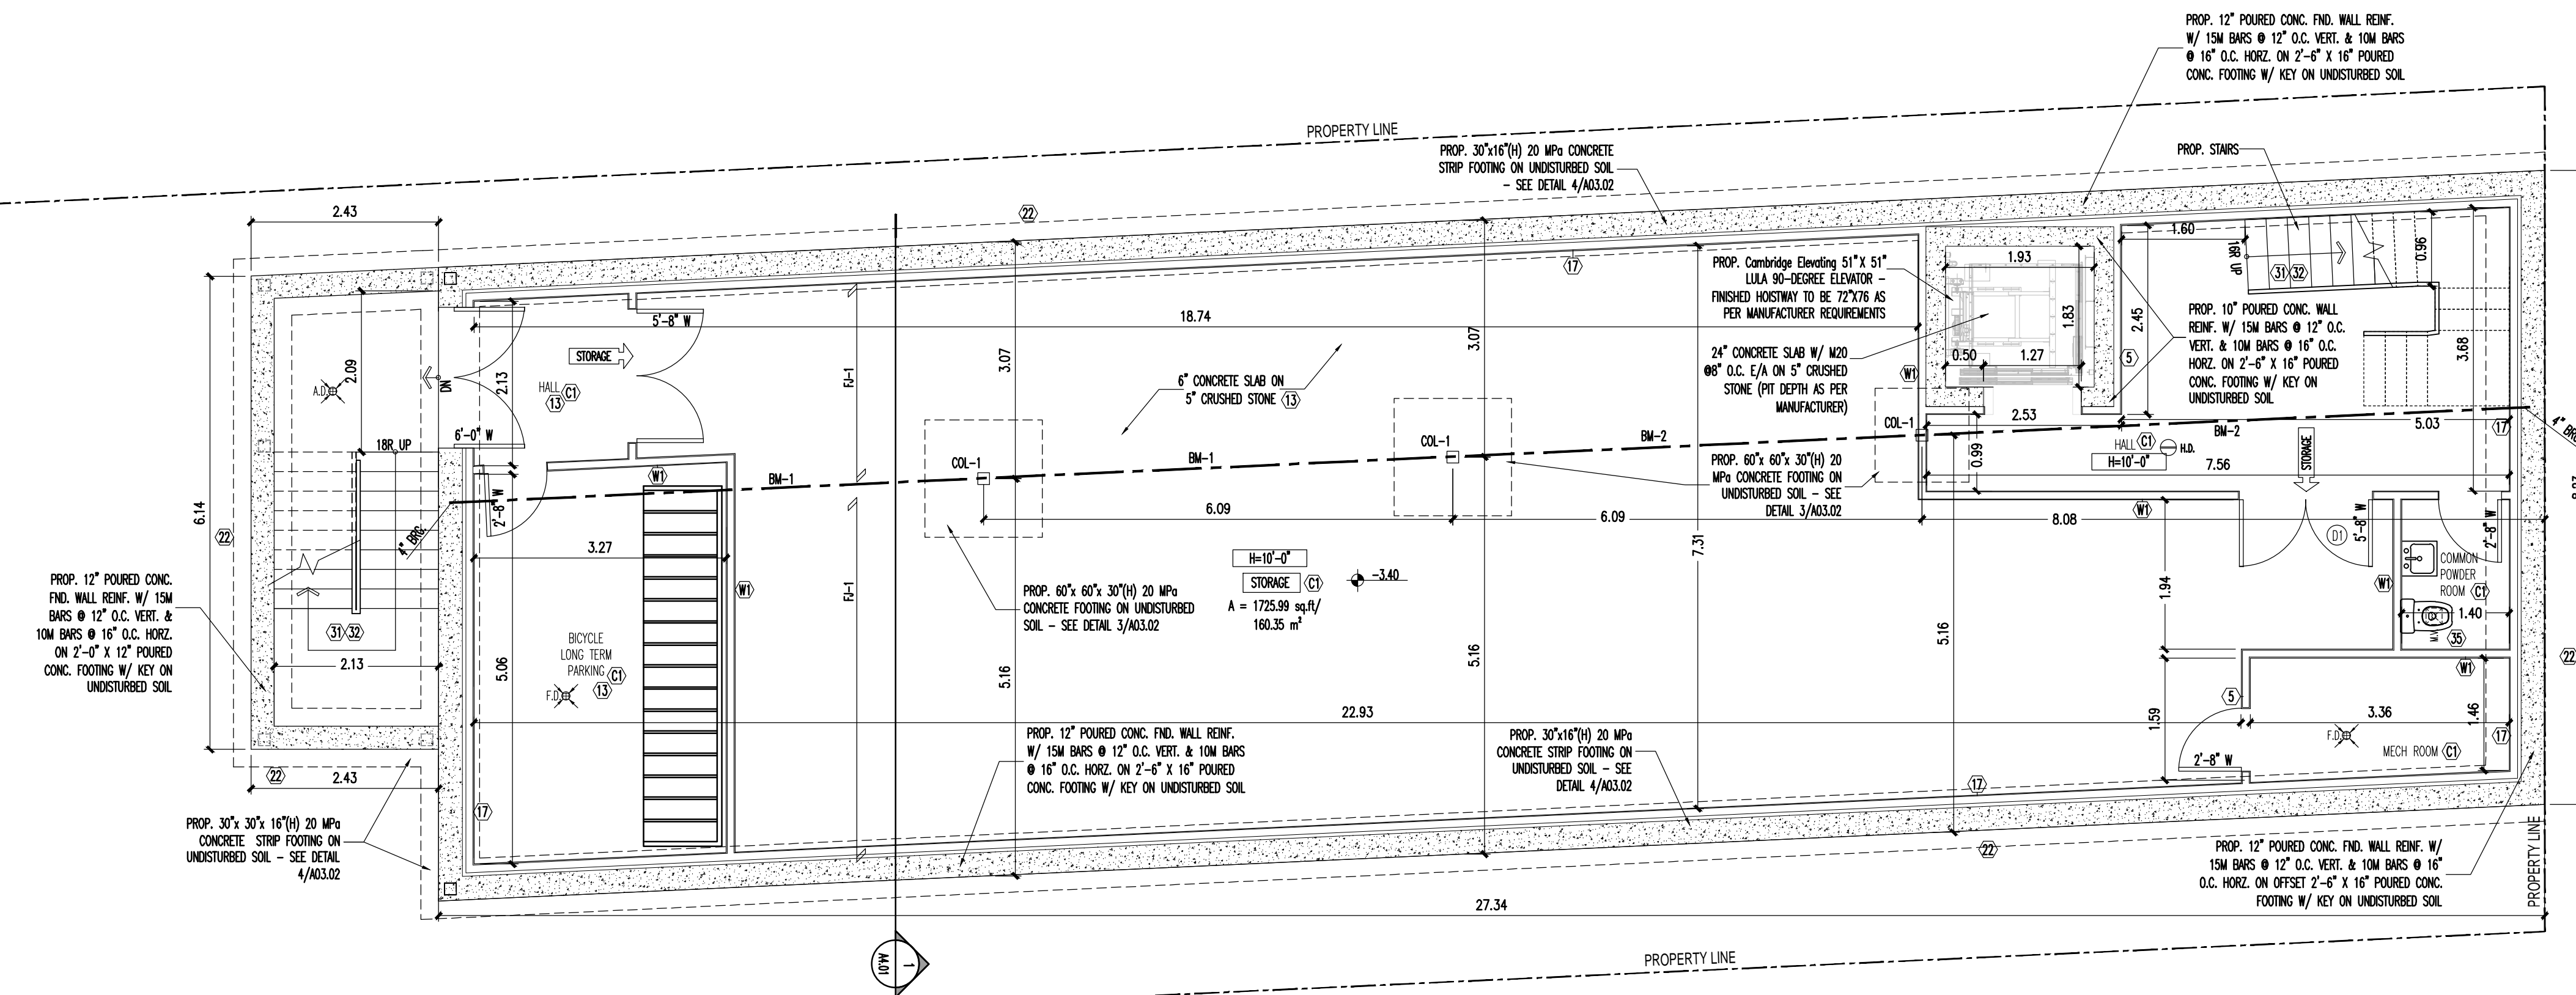

BASEMENT PLAN

SCALE: 1:60

NO.	DESCRIPTION OF ISSUE	DATE	NO.	DESCRIPTION OF ISSUE	DATE
1	CITY COMMENTS REV01 SUBMISSION	02/22/2020	5	CITY COMMENTS REVIEW SUBMISSION	03/30/2021
2	CITY COMMENTS REV02 SUBMISSION	05/12/2020	6	CITY COMMENTS REVIEW SUBMISSION	08/02/2021
3	ISSUED FOR BUILDING PERMIT APPLICATION	08/11/2020	7		
4	REVIEWED FOR BUILDING PERMIT APPLICATION	08/28/2020	8		

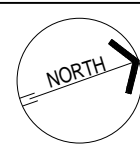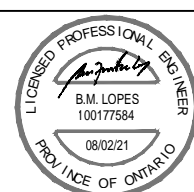

PROJECT 642 CONCESSION ST		SCALE 1 : 60	
TITLE BASEMENT PLAN		DATE AUGUST 2021	
JOB No. 36-319	FILE No. DA-19-176	DRAWING No. A01.01	

BEAM SCHEDULE:

- BM-1 W12X40 STEEL BEAM
- BM-2 W12X53 STEEL BEAM
- BM-3 W12X30 STEEL BEAM

FLOOR JOISTS SCHEDULE:

- FJ-1 11 7/8" S47 FLR. JSTS @12" O.C. W/ 3/4" OSB SUBFLOOR (GLUED-NAILED)
- FJ-2 14" TJI S47 JSTS @ 16" O.C.

COLUMN SCHEDULE:

- COL-1 W12X22 STEEL COLUMN W/ 10"x10"x 1/2" TOP PLATE WELDED TO COL. & 12"x12"x 1/2" BOTTOM PLATE WELDED TO COL. ANCHORED W/ 2- 1/2" DIA. X 12" LONG X 2" HOOK ANCHORS TO 60"x 60"x 20"(H) 20 MPa CONCRETE FOOTING ON UNDISTURBED SOIL.
- COL-2 W12X22 STEEL COLUMN W/ 10"x10"x 1/2" TOP PLATE WELDED TO COL. & 10"x10"x 1/2" BOTTOM PLATE WELDED TO COL.
- COL-3 W12X22 STEEL COLUMN W/ 8"x8"x 3/8" TOP PLATE WELDED TO COL. & 8"x8"x 3/8" BOTTOM PLATE WELDED TO COLUMN TO FOUND WALL W/ 2- 1/2" DIA. X 12" LONG X 2" HOOK ANCHORS
- COL-4 W12X22 STEEL COLUMN W/ 8"x8"x 3/8" TOP PLATE WELDED TO COL. & 8"x8"x 3/8" BOTTOM PLATE WELDED TO COLUMN

(W) NEW RATED LOAD BEARING PARTITION WALL


1 HOUR FIRE RATED, WITH MIN. STC RATING 51, AS PER SB-3 W46
 2 LAYERS 5/8" TYPE "X" GYP. WALL BRD. APPLIED TO RESILIENT MET. CHANNELS @ 16" O.C. INSIDE OF 2" X 4" OR 2"x6" MTL. STUDS @ 16" O.C. (48 GAUGE), ONE LAYER 5/8" TYPE "X" GYP. WALL BRD. ON THE OTHER SIDE OF STUDS C/W 5 1/2" SOUND ABSORPTIVE INSUL. TO U/S OF SUB-FLOOR ABOVE.

(C) NEW CEILING

1 HOUR FIRE RATED WITH STCS2 REFER TO ULC DESIGN NO. M501
 FILL JOIST CAVITY W/ SOUND PROOF INSUL. (SOUND TRANSMISSION TO CONFORM TO O.B.C. 9.11.21.) C/W 5/8" RESILIENT MTL. FURRING CHANNELS @ 16" O.C. PERPENDICULAR TO FLOOR JOISTS W/ 1/2" TYPE "X" GYP. WALL BRD. W/ PAINTED FINISH (TYP.)



LEGEND

- SA SMOKE ALARM
- C.M.D. CARBON MONOXIDE DETECTOR
- M.V. MECHANICAL VENTILATION
- HB HOSE BIB
- S.B. SOLID WOOD BEARING
- PL POINT LOAD
- EXIST'G WALL TO REMAIN
- F.D. FLOOR DRAIN
- A.D. AREA DRAIN

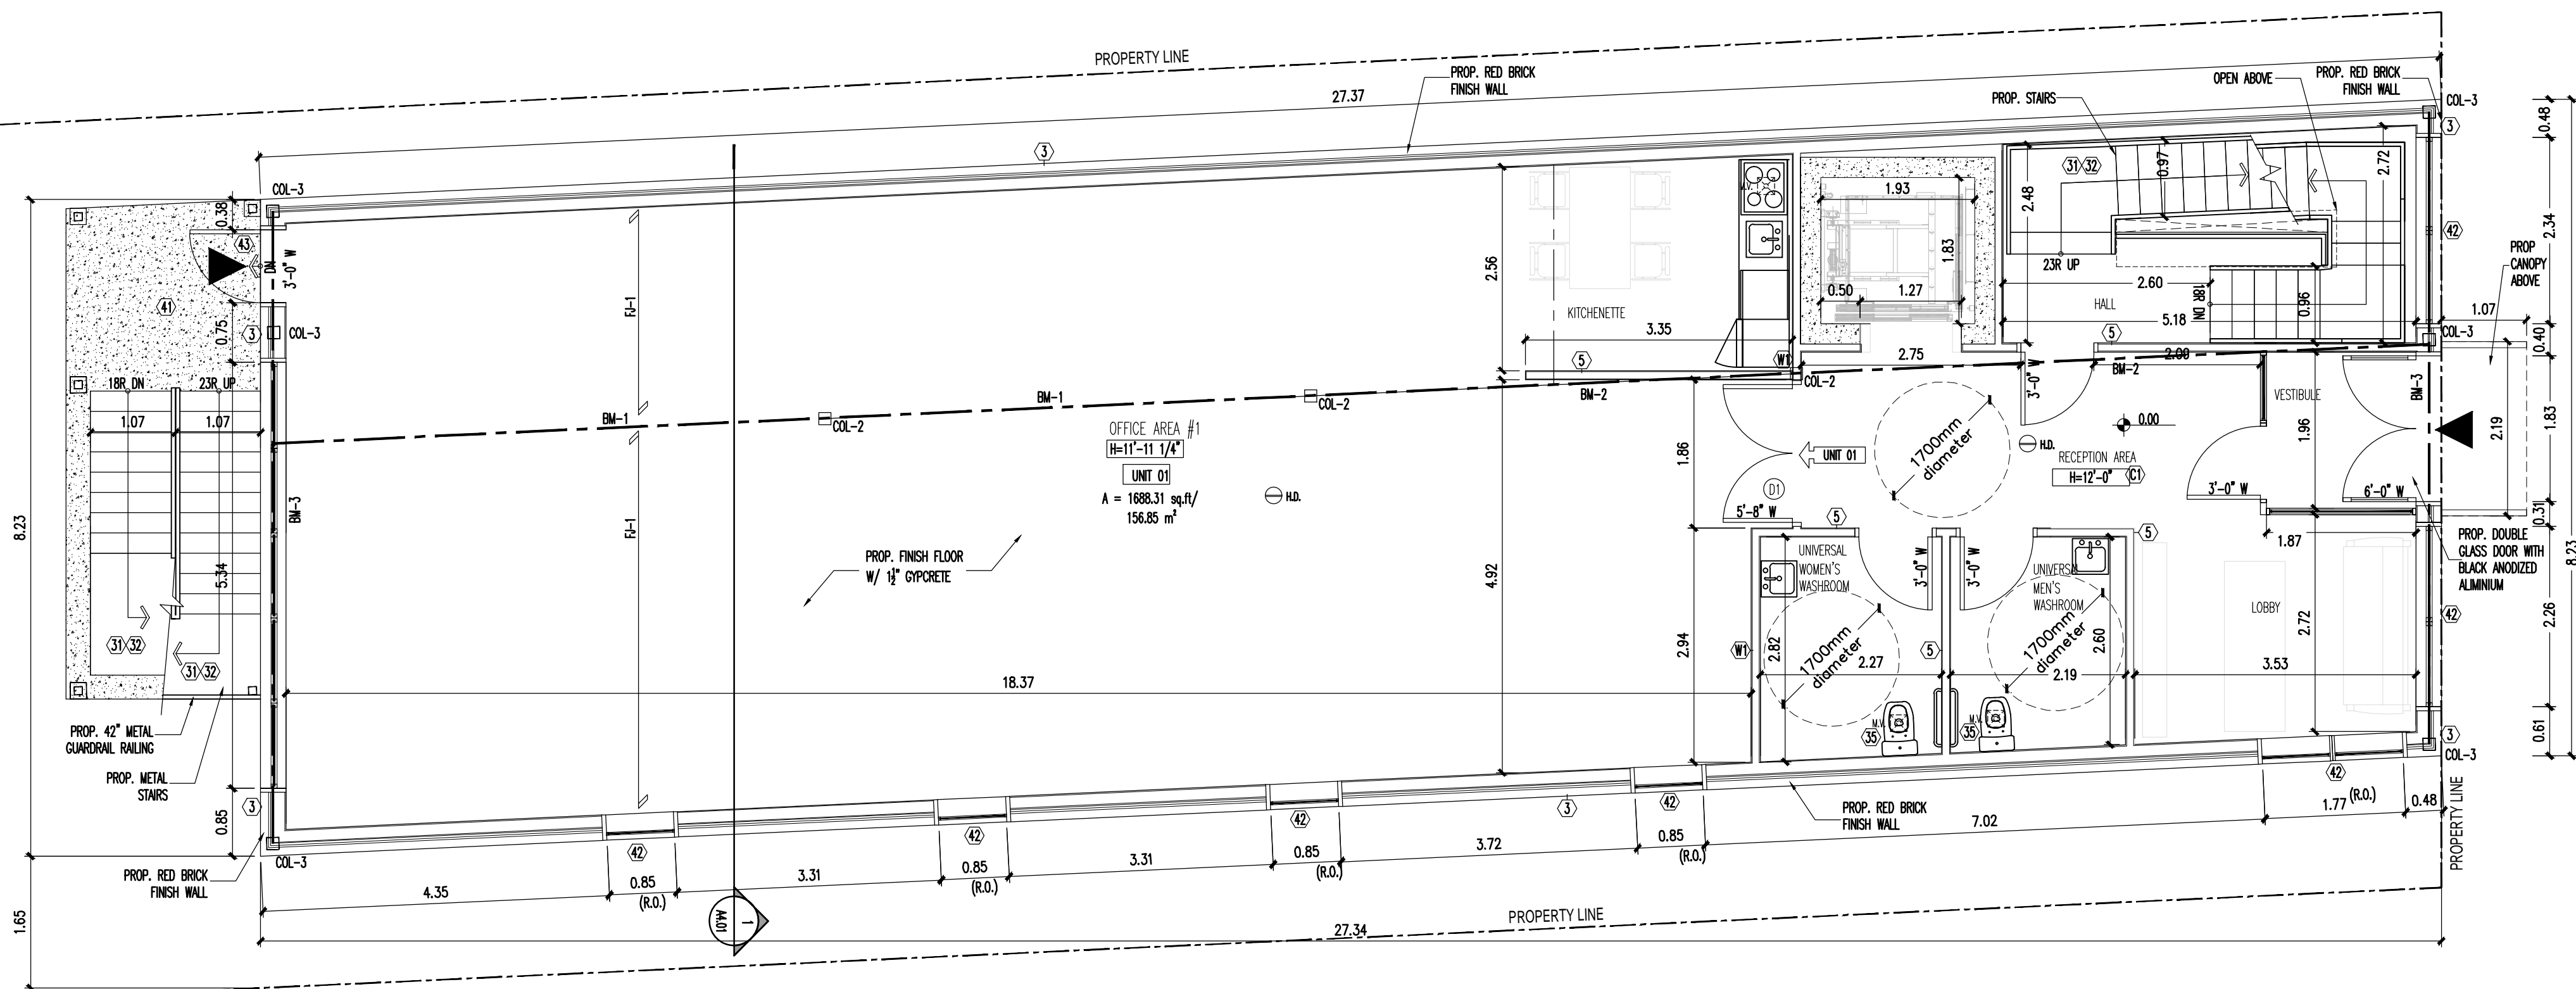

FIRST FLOOR PLAN
SCALE: 1:60

NO.	DESCRIPTION OF ISSUE	DATE	NO.	DESCRIPTION OF ISSUE	DATE
1	CITY COMMENTS REV01 SUBMISSION	02/22/2020	5	CITY COMMENTS REVIEW SUBMISSION	03/30/2021
2	CITY COMMENTS REV02 SUBMISSION	05/12/2020	6	CITY COMMENTS REVIEW SUBMISSION	08/02/2021
3	ISSUED FOR BUILDING PERMIT APPLICATION	08/11/2020	7		
4	REVIEWED FOR BUILDING PERMIT APPLICATION	08/28/2020	8		

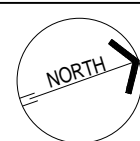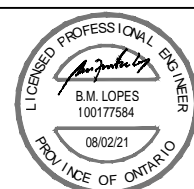

PROJECT 642 CONCESSION ST		SCALE 1 : 60	
TITLE FIRST FLOOR PLAN		DATE AUGUST 2021	
JOB No. 36-319	FILE No. DA-19-176	DRAWING No. A01.02	

BEAM SCHEDULE:

- BM-1 W12X40 STEEL BEAM
- BM-2 W12X53 STEEL BEAM
- BM-3 W12X30 STEEL BEAM

FLOOR JOISTS SCHEDULE:

- FJ-1 11 7/8" S47 FLR. JSTS @ 12" O.C. W/ 3/4" OSB SUBFLOOR (GLUED-NAILED)
- FJ-1 14" TJI S47 JSTS @ 16" O.C.

COLUMN SCHEDULE:

- COL-1 W12X22 STEEL COLUMN W/ 10"x10"x 1/2" TOP PLATE WELDED TO COL. & 12"x12"x 1/2" BOTTOM PLATE WELDED TO COL. ANCHORED W/ 2- 1/2" DIA. X 12" LONG X 2" HOOK ANCHORS TO 60"x 60"x 20"(H) 20 MPa CONCRETE FOOTING ON UNDISTURBED SOIL.
- COL-2 W12X22 STEEL COLUMN W/ 10"x10"x 1/2" TOP PLATE WELDED TO COL. & 10"x10"x 1/2" BOTTOM PLATE WELDED TO COL.
- COL-3 W12X22 STEEL COLUMN W/ 8"x8"x 3/8" TOP PLATE WELDED TO COL. & 8"x8"x 3/8" BOTTOM PLATE WELDED TO COLUMN TO FOUND WALL W/ 2- 1/2" DIA. X 12" LONG X 2" HOOK ANCHORS
- COL-4 W12X22 STEEL COLUMN W/ 8"x8"x 3/8" TOP PLATE WELDED TO COL. & 8"x8"x 3/8" BOTTOM PLATE WELDED TO COLUMN

(W) NEW RATED LOAD BEARING PARTITION WALL


1 HOUR FIRE RATED, WITH MIN. STC RATING 51, AS PER SB-3 W46
 2 LAYERS 5/8" TYPE "X" GYP. WALL BRD. APPLIED TO RESILIENT MET. CHANNELS @ 16" O.C. INSIDE OF 2" X 4" OR 2"x6" MTL. STUDS @ 16" O.C., (48 GAUGE), ONE LAYER 5/8" TYPE "X" GYP. WALL BRD. ON THE OTHER SIDE OF STUDS C/W 5 1/2" SOUND ABSORPTIVE INSUL. TO U/S OF SUB-FLOOR ABOVE.

(C) NEW CEILING

1 HOUR FIRE RATED WITH STCS2 REFER TO ULC DESIGN NO. M501
 FILL JOIST CAVITY W/ SOUND PROOF INSUL. (SOUND TRANSMISSION TO CONFORM TO O.B.C. 9.11.21.) C/W 5/8" RESILIENT MTL. FURRING CHANNELS @ 16" O.C. PERPENDICULAR TO FLOOR JOISTS W/ 1/2" TYPE "X" GYP. WALL BRD. W/ PAINTED FINISH (TYP.)


LEGEND

- SA SMOKE ALARM
- C.M.D. CARBON MONOXIDE DETECTOR
- M.V. MECHANICAL VENTILATION
- HB HOSE BIB
- S.B. SOLID WOOD BEARING
- PL POINT LOAD
- EXIST'G WALL TO REMAIN
- F.D. FLOOR DRAIN
- A.D. AREA DRAIN

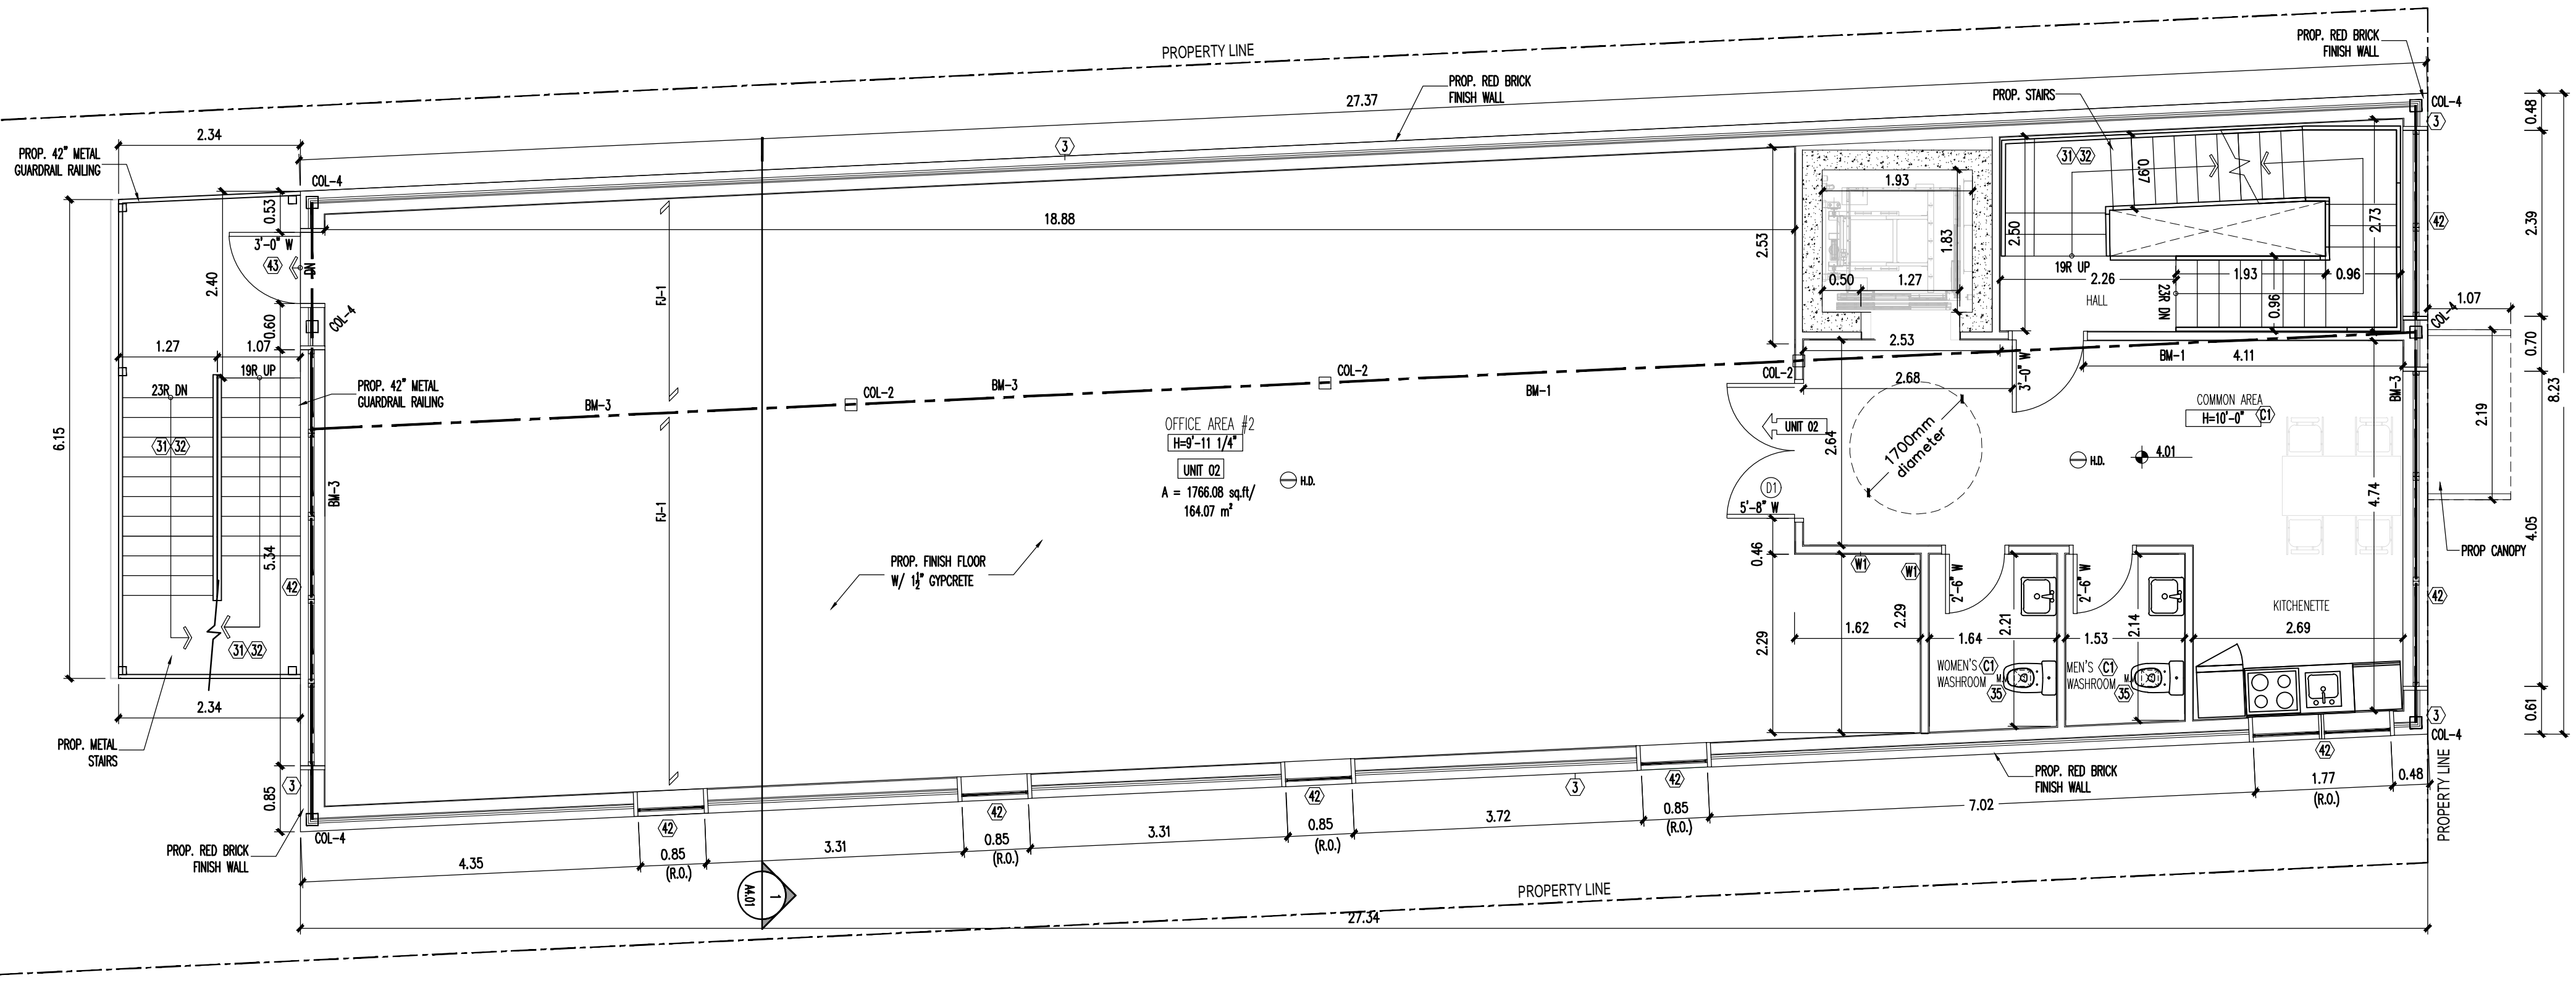

SECOND FLOOR PLAN
 SCALE: 1:60

NO.	DESCRIPTION OF ISSUE	DATE	NO.	DESCRIPTION OF ISSUE	DATE
1	CITY COMMENTS REV01 SUBMISSION	02/22/2020	5	CITY COMMENTS REVIEW SUBMISSION	03/30/2021
2	CITY COMMENTS REV02 SUBMISSION	05/12/2020	6	CITY COMMENTS REVIEW SUBMISSION	08/02/2021
3	ISSUED FOR BUILDING PERMIT APPLICATION	08/11/2020	7		
4	REVIEWED FOR BUILDING PERMIT APPLICATION	08/28/2020	8		

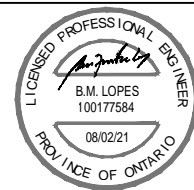

PROJECT 642 CONCESSION ST		SCALE 1 : 60	
TITLE SECOND FLOOR PLAN		DATE AUGUST 2021	
JOB No. 36-319	FILE No. DA-19-176	DRAWING No. A01.03	

BEAM SCHEDULE:

- BM-1 W12X40 STEEL BEAM
- BM-2 W12X53 STEEL BEAM
- BM-3 W12X30 STEEL BEAM

FLOOR JOISTS SCHEDULE:

- FJ-1 11 7/8" S47 FLR. JSTS @12" O.C. W/ 3/4" OSB SUBFLOOR (GLUED-NAILED)
- RJ-1 14" TJI S47 JSTS @ 16" O.C.

COLUMN SCHEDULE:

- COL-1 W12X22 STEEL COLUMN W/ 10"x10"x 1/2" TOP PLATE WELDED TO COL. & 12"x12"x 1/2" BOTTOM PLATE WELDED TO COL. ANCHORED W/ 2- 1/2" DIA. X 12" LONG X 2" HOOK ANCHORS TO 60"x 60"x 20"(H) 20 MPa CONCRETE FOOTING ON UNDISTURBED SOIL.
- COL-2 W12X22 STEEL COLUMN W/ 10"x10"x 1/2" TOP PLATE WELDED TO COL. & 10"x10"x 1/2" BOTTOM PLATE WELDED TO COL.
- COL-3 W12X22 STEEL COLUMN W/ 8"x8"x 3/8" TOP PLATE WELDED TO COL. & 8"x8"x 3/8" BOTTOM PLATE WELDED TO COLUMN TO FOUND WALL W/ 2- 1/2" DIA. X 12" LONG X 2" HOOK ANCHORS
- COL-4 W12X22 STEEL COLUMN W/ 8"x8"x 3/8" TOP PLATE WELDED TO COL. & 8"x8"x 3/8" BOTTOM PLATE WELDED TO COLUMN

(W) NEW RATED LOAD BEARING PARTITION WALL


- 1 HOUR FIRE RATED, WITH MIN. STC RATING 51, AS PER SB-3 W46
- 2 LAYERS 5/8" TYPE "X" GYP. WALL BRD. APPLIED TO RESILIENT MET. CHANNELS @ 16" O.C. INSIDE OF 2" X 4" OR 2"x6" MTL. STUDS @ 16" O.C. (48 GAUGE), ONE LAYER 5/8" TYPE "X" GYP. WALL BRD. ON THE OTHER SIDE OF STUDS C/W 5/8" SOUND ABSORPTIVE INSUL. TO U/S OF SUB-FLOOR ABOVE.

(C) NEW CEILING

- 1 HOUR FIRE RATED WITH STCS2 REFER TO ULC DESIGN NO. M501
- FILL JOIST CAVITY W/ SOUND PROOF INSUL. (SOUND TRANSMISSION TO CONFORM TO O.B.C. 9.11.21.) C/W 5/8" RESILIENT MTL. FURRING CHANNELS @ 16" O.C. PERPENDICULAR TO FLOOR JOISTS W/ 1/2" TYPE "X" GYP. WALL BRD. W/ PAINTED FINISH (TYP.)


LEGEND

- SA SMOKE ALARM
- C.M.D. CARBON MONOXIDE DETECTOR
- M.V. MECHANICAL VENTILATION
- HB HOSE BIB
- S.B. SOLID WOOD BEARING
- PL POINT LOAD
- EXIST'G WALL TO REMAIN
- F.D. FLOOR DRAIN
- A.D. AREA DRAIN

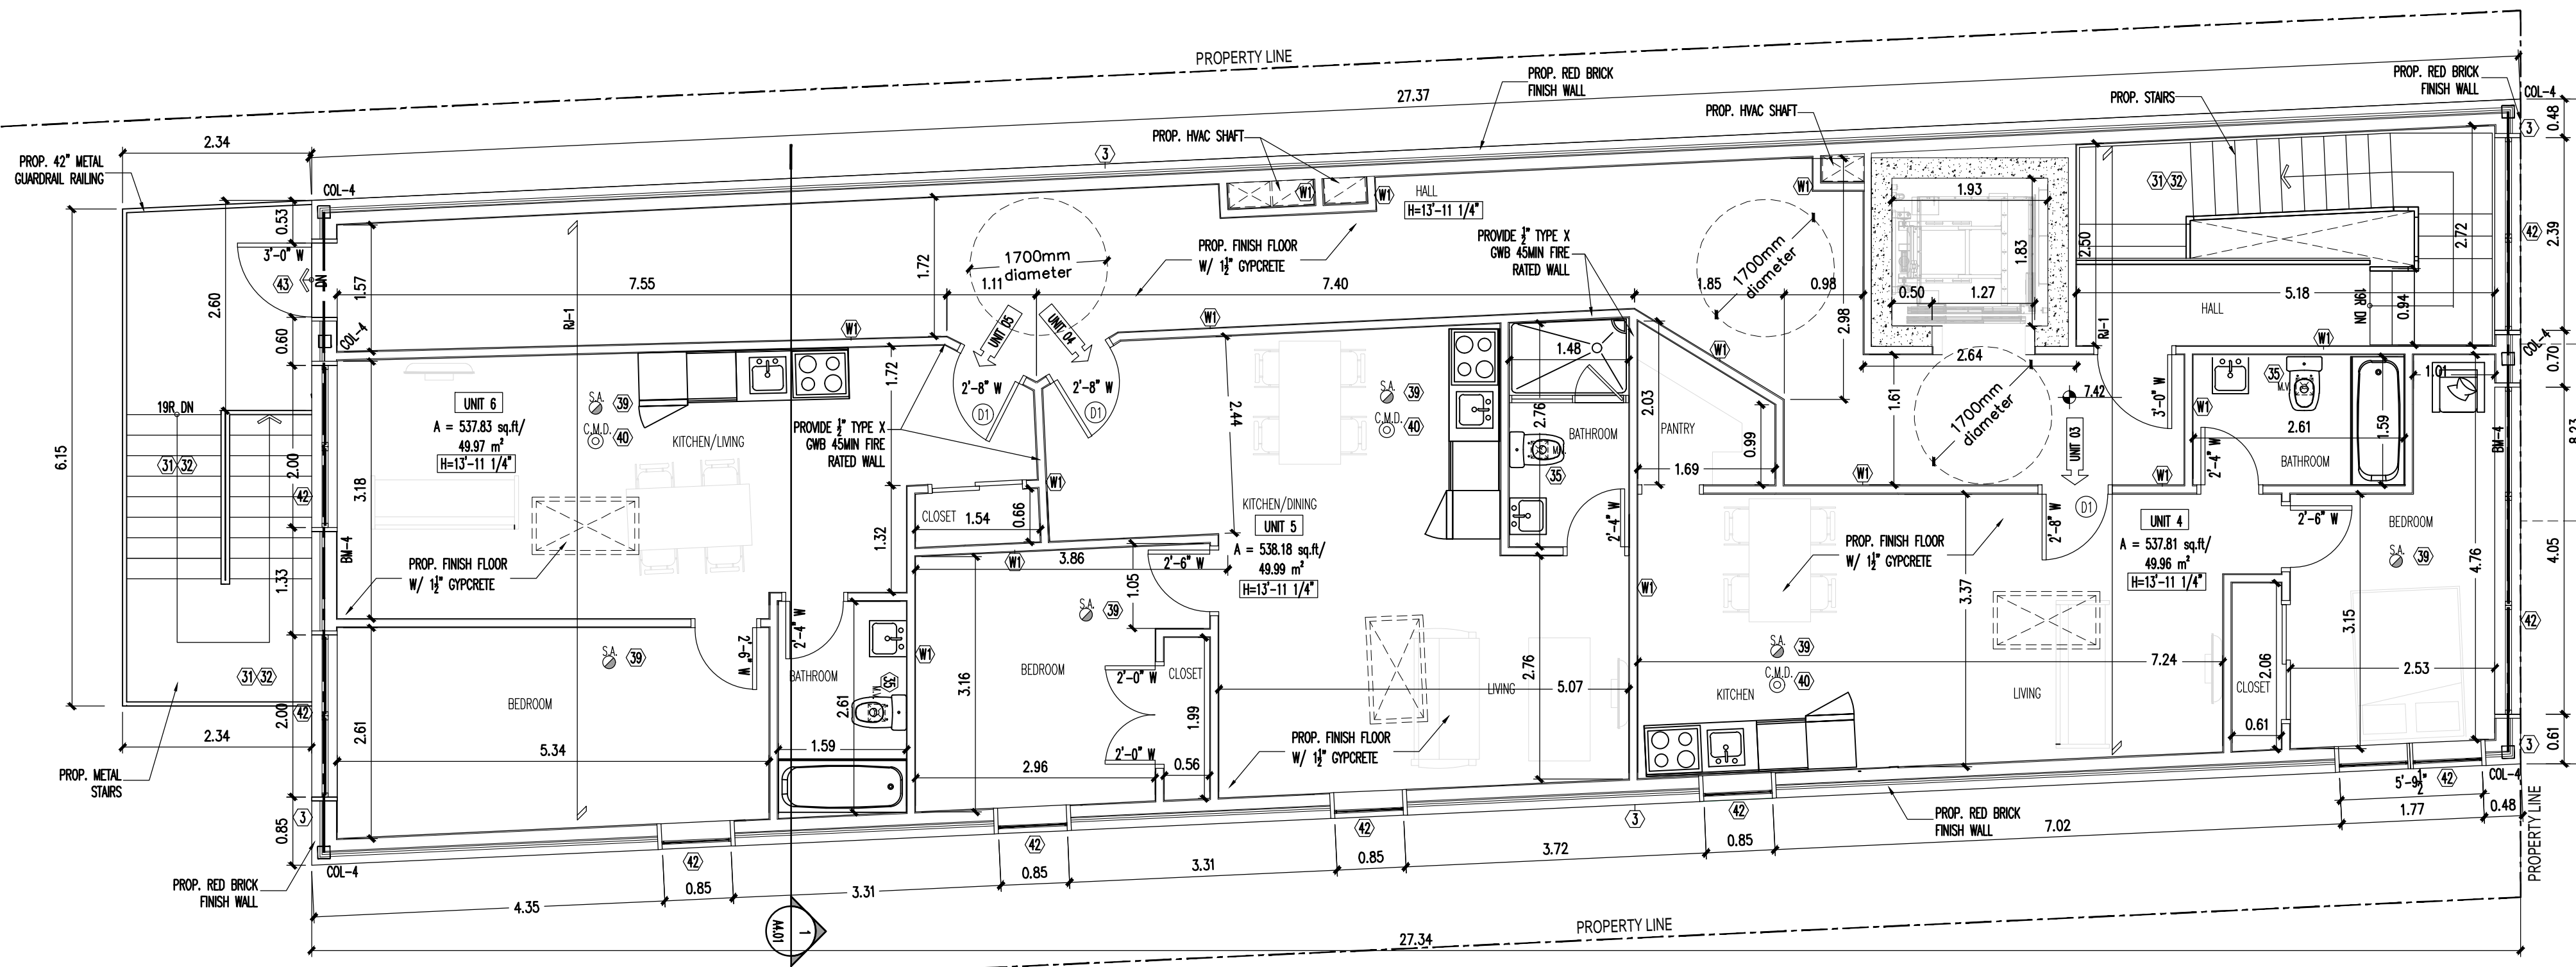


THIRD FLOOR PLAN
SCALE: 1:60

NO.	DESCRIPTION OF ISSUE	DATE	NO.	DESCRIPTION OF ISSUE	DATE
1	CITY COMMENTS REV01 SUBMISSION	02/22/2020	5	CITY COMMENTS REVIEW SUBMISSION	03/30/2021
2	CITY COMMENTS REV02 SUBMISSION	05/12/2020	6	CITY COMMENTS REVIEW SUBMISSION	08/02/2021
3	ISSUED FOR BUILDING PERMIT APPLICATION	08/11/2020	7		
4	REVIEWED FOR BUILDING PERMIT APPLICATION	08/28/2020	8		

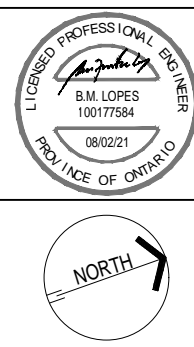


PROJECT 642 CONCESSION ST		SCALE 1 : 60	
TITLE THIRD FLOOR PLAN		DATE AUGUST 2021	
JOB No. 36-319	FILE No. DA-19-176	DRAWING No. A01.04	

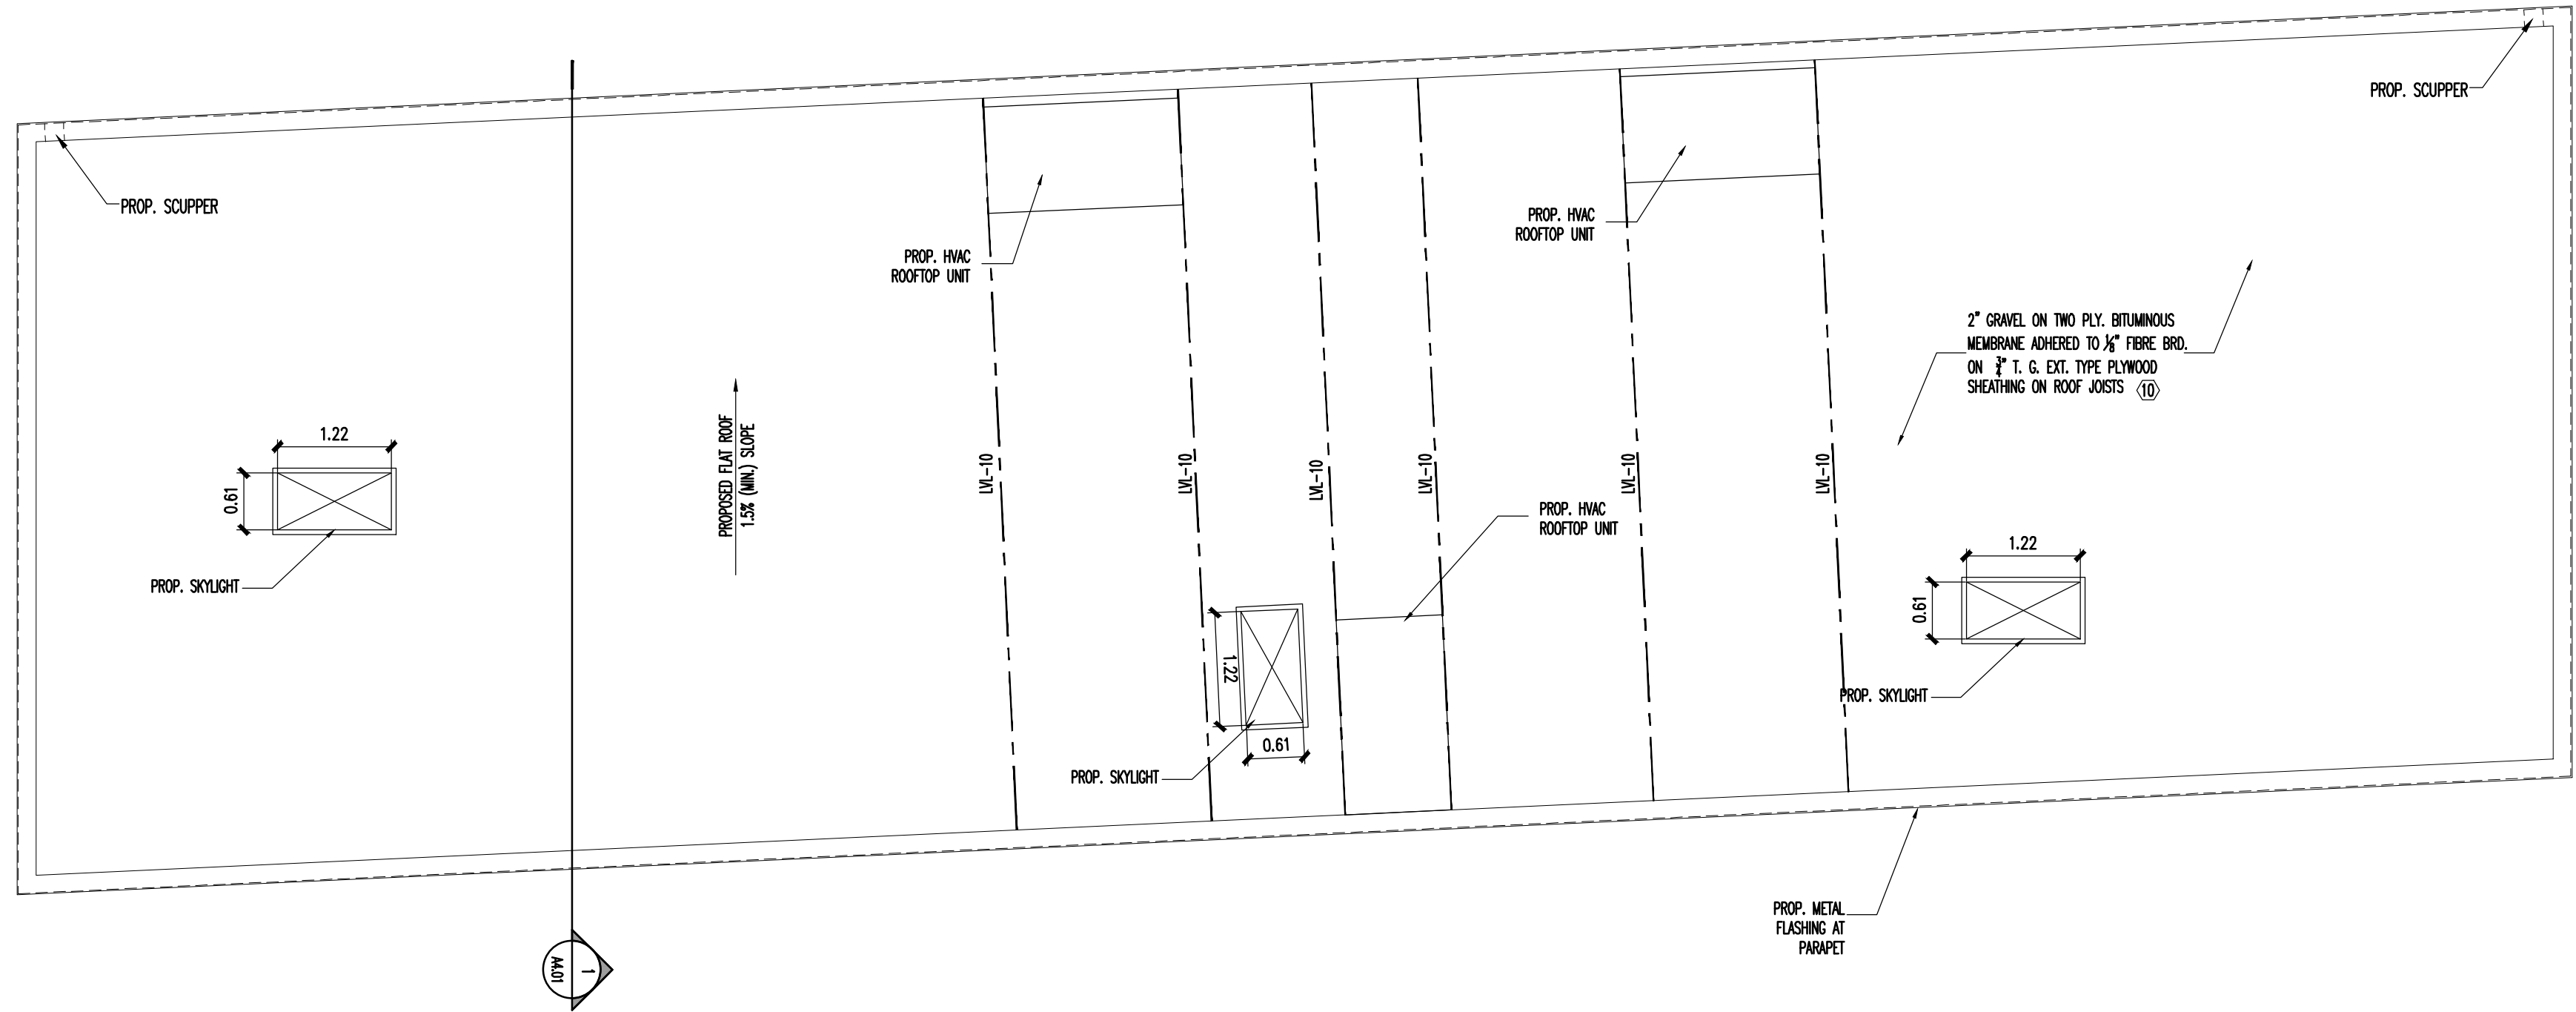

ROOF PLAN
SCALE: 1:60

NO.	DESCRIPTION OF ISSUE	DATE	NO.	DESCRIPTION OF ISSUE	DATE
1	CITY COMMENTS REV01 SUBMISSION	02/22/2020	5	CITY COMMENTS REVIEW SUBMISSION	03/30/2021
2	CITY COMMENTS REV02 SUBMISSION	05/12/2020	6	CITY COMMENTS REVIEW SUBMISSION	08/02/2021
3	ISSUED FOR BUILDING PERMIT APPLICATION	08/11/2020	7		
4	REVIEWED FOR BUILDING PERMIT APPLICATION	08/28/2020	8		

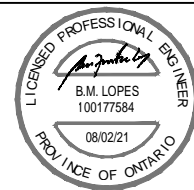

PROJECT 642 CONCESSION ST	SCALE 1 : 60
TITLE ROOF PLAN	DATE AUGUST 2021
	JOB No. 36-319
	FILE No. DA-19-176
	DRAWING No. A01.05


FENESTRATION NOTE:

WINDOWS (GENERAL NOTES 42):

- ALL WINDOWS TO BE BLACK COLOUR WITH ALUMINIUM FRAME AND SILL
- ALL WINDOWS TO BE DOUBLE GLAZED WITH LOW E COATING


DOORS (GENERAL NOTES 43):

- ALL WINDOWS TO BE BLACK COLOUR WITH ALUMINIUM FRAME AND SILL

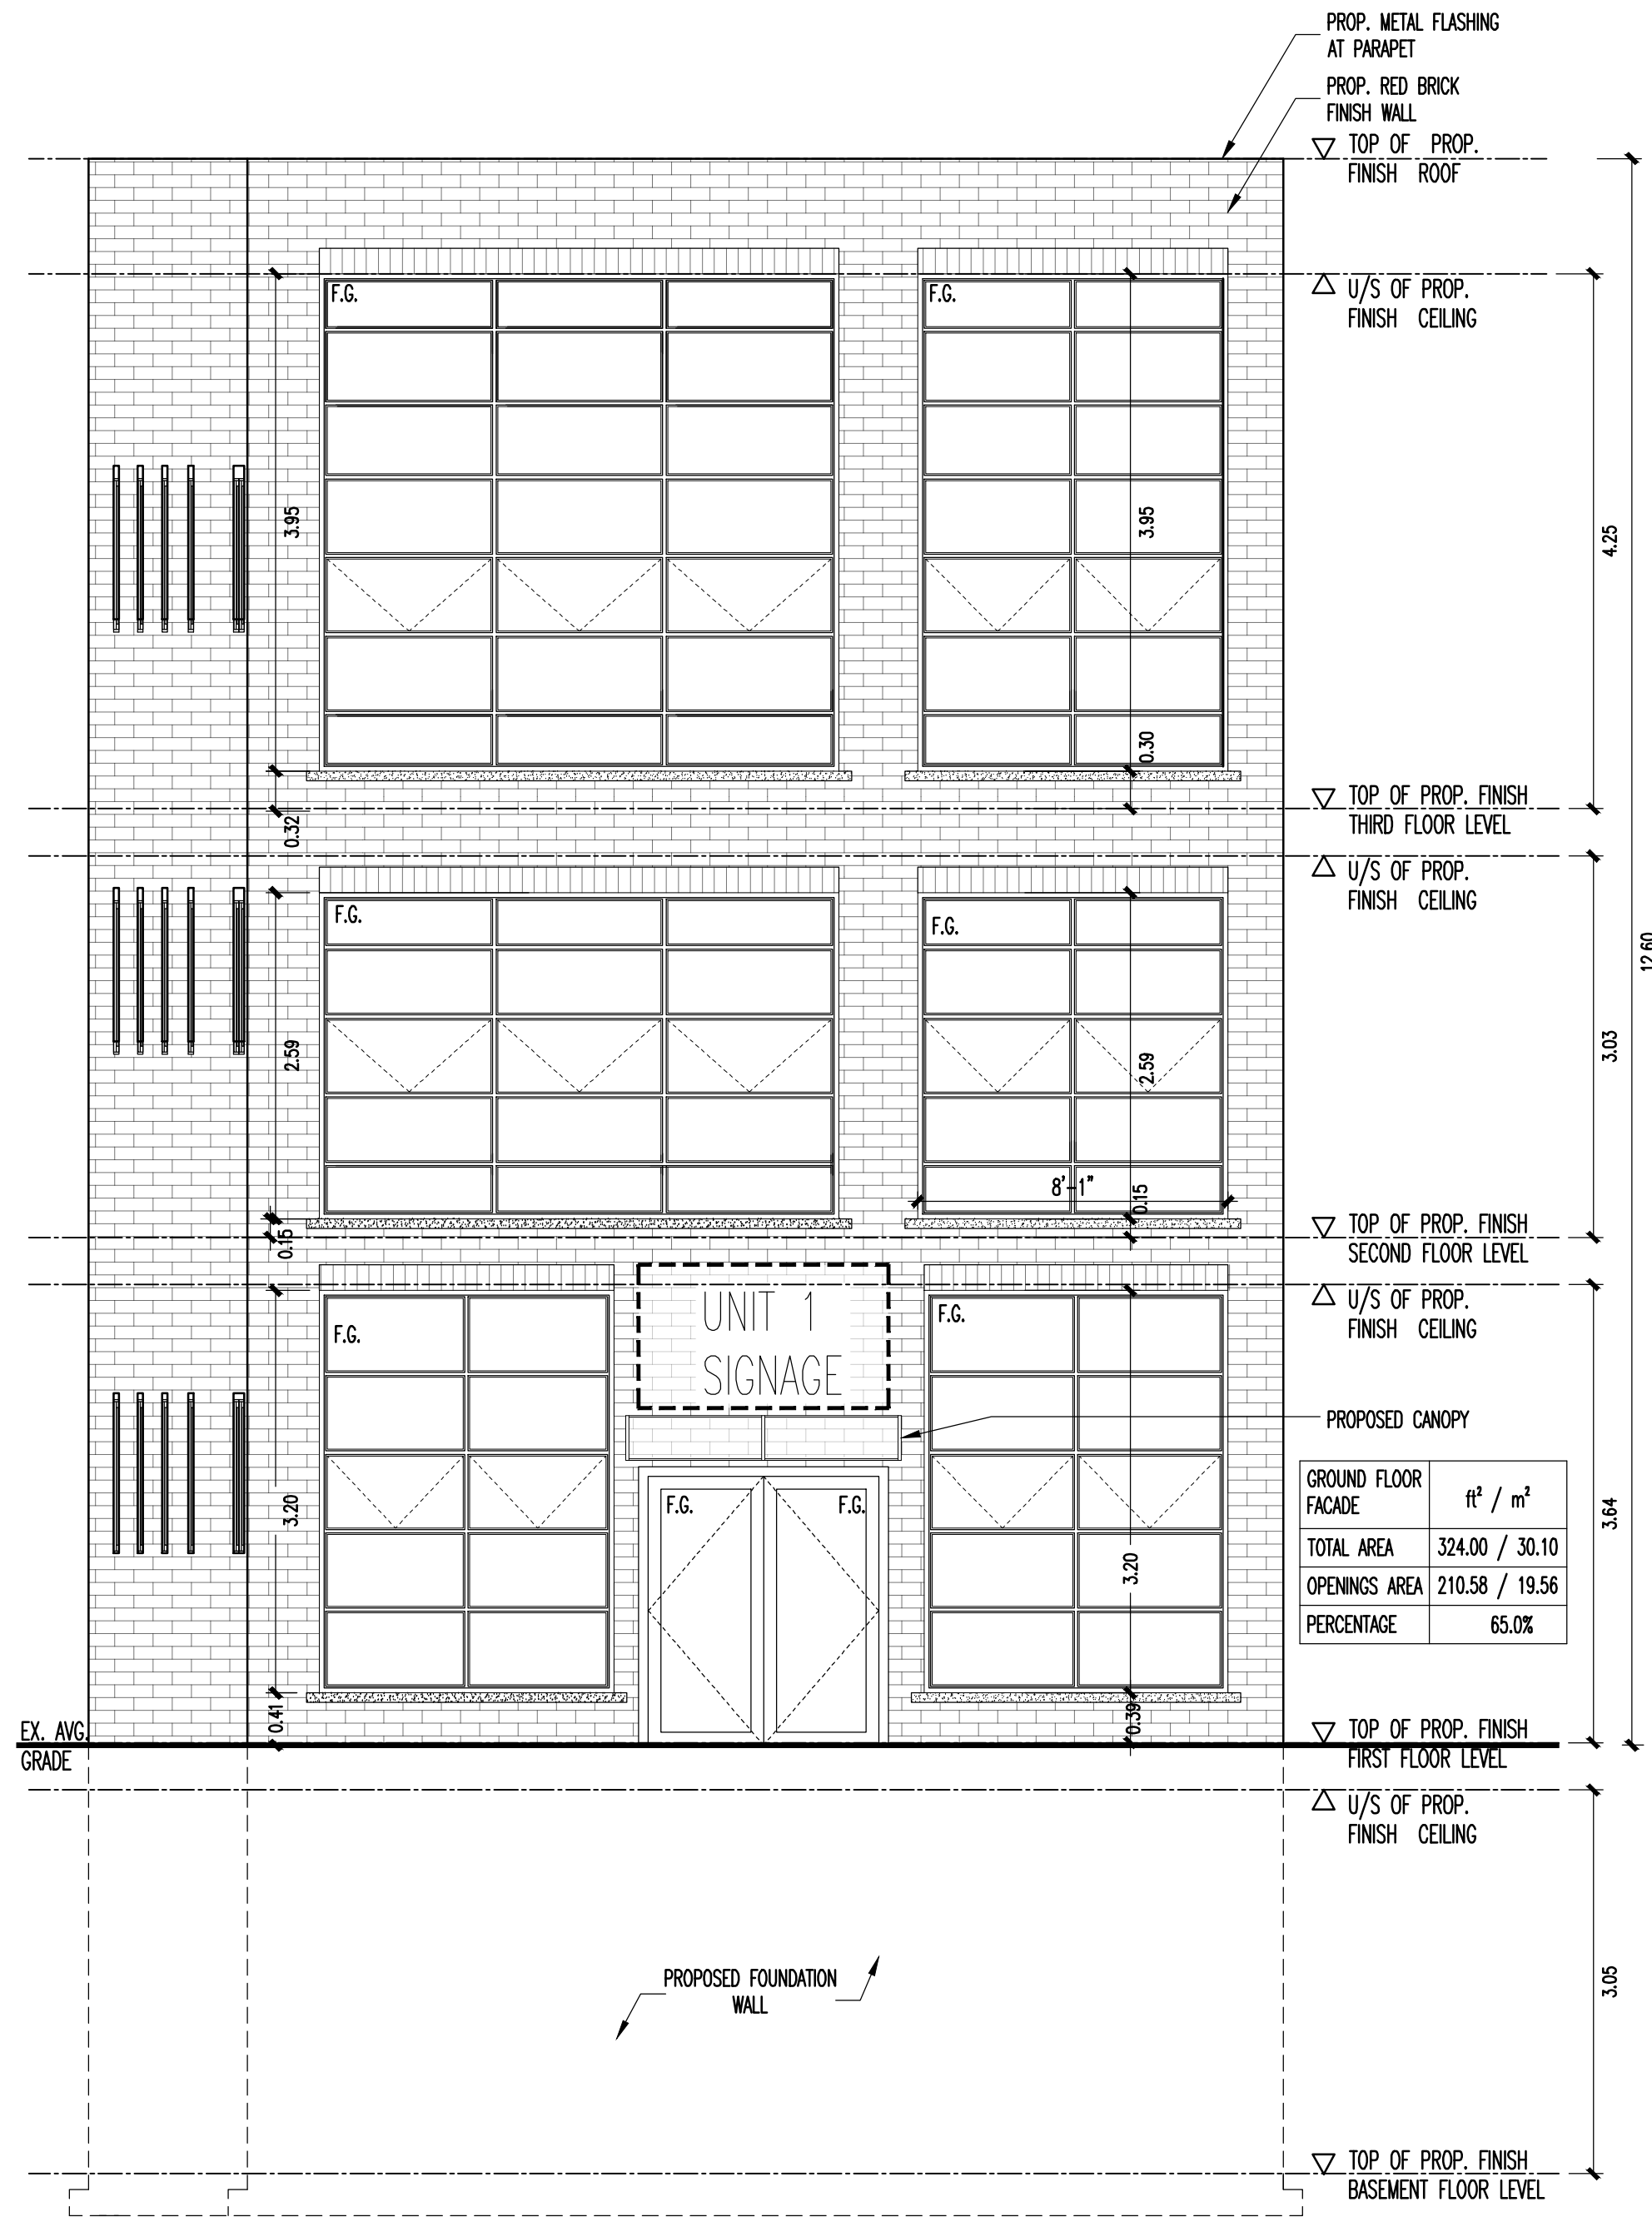

NORTH ELEVATION
SCALE: 1:50

NO.	DESCRIPTION OF ISSUE	DATE	NO.	DESCRIPTION OF ISSUE	DATE
1	CITY COMMENTS REV01 SUBMISSION	02/22/2020	5	CITY COMMENTS REVIEW SUBMISSION	03/30/2021
2	CITY COMMENTS REV02 SUBMISSION	05/12/2020	6	CITY COMMENTS REVIEW SUBMISSION	08/02/2021
3	ISSUED FOR BUILDING PERMIT APPLICATION	08/11/2020	7		
4	REVIEWED FOR BUILDING PERMIT APPLICATION	08/28/2020	8		

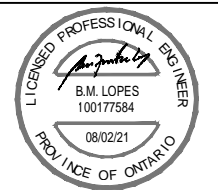

PROJECT 642 CONCESSION ST		SCALE 1 : 50	
TITLE NORTH ELEVATION		DATE AUGUST 2021	
JOB No. 36-319	FILE No. DA-19-176	DRAWING No. A02.01	


FENESTRATION NOTE:

WINDOWS (GENERAL NOTES 42):

- ALL WINDOWS TO BE BLACK COLOUR WITH ALUMINIUM FRAME AND SILL
- ALL WINDOWS TO BE DOUBLE GLAZED WITH LOW E COATING


DOORS (GENERAL NOTES 43):

- ALL WINDOWS TO BE BLACK COLOUR WITH ALUMINIUM FRAME AND SILL

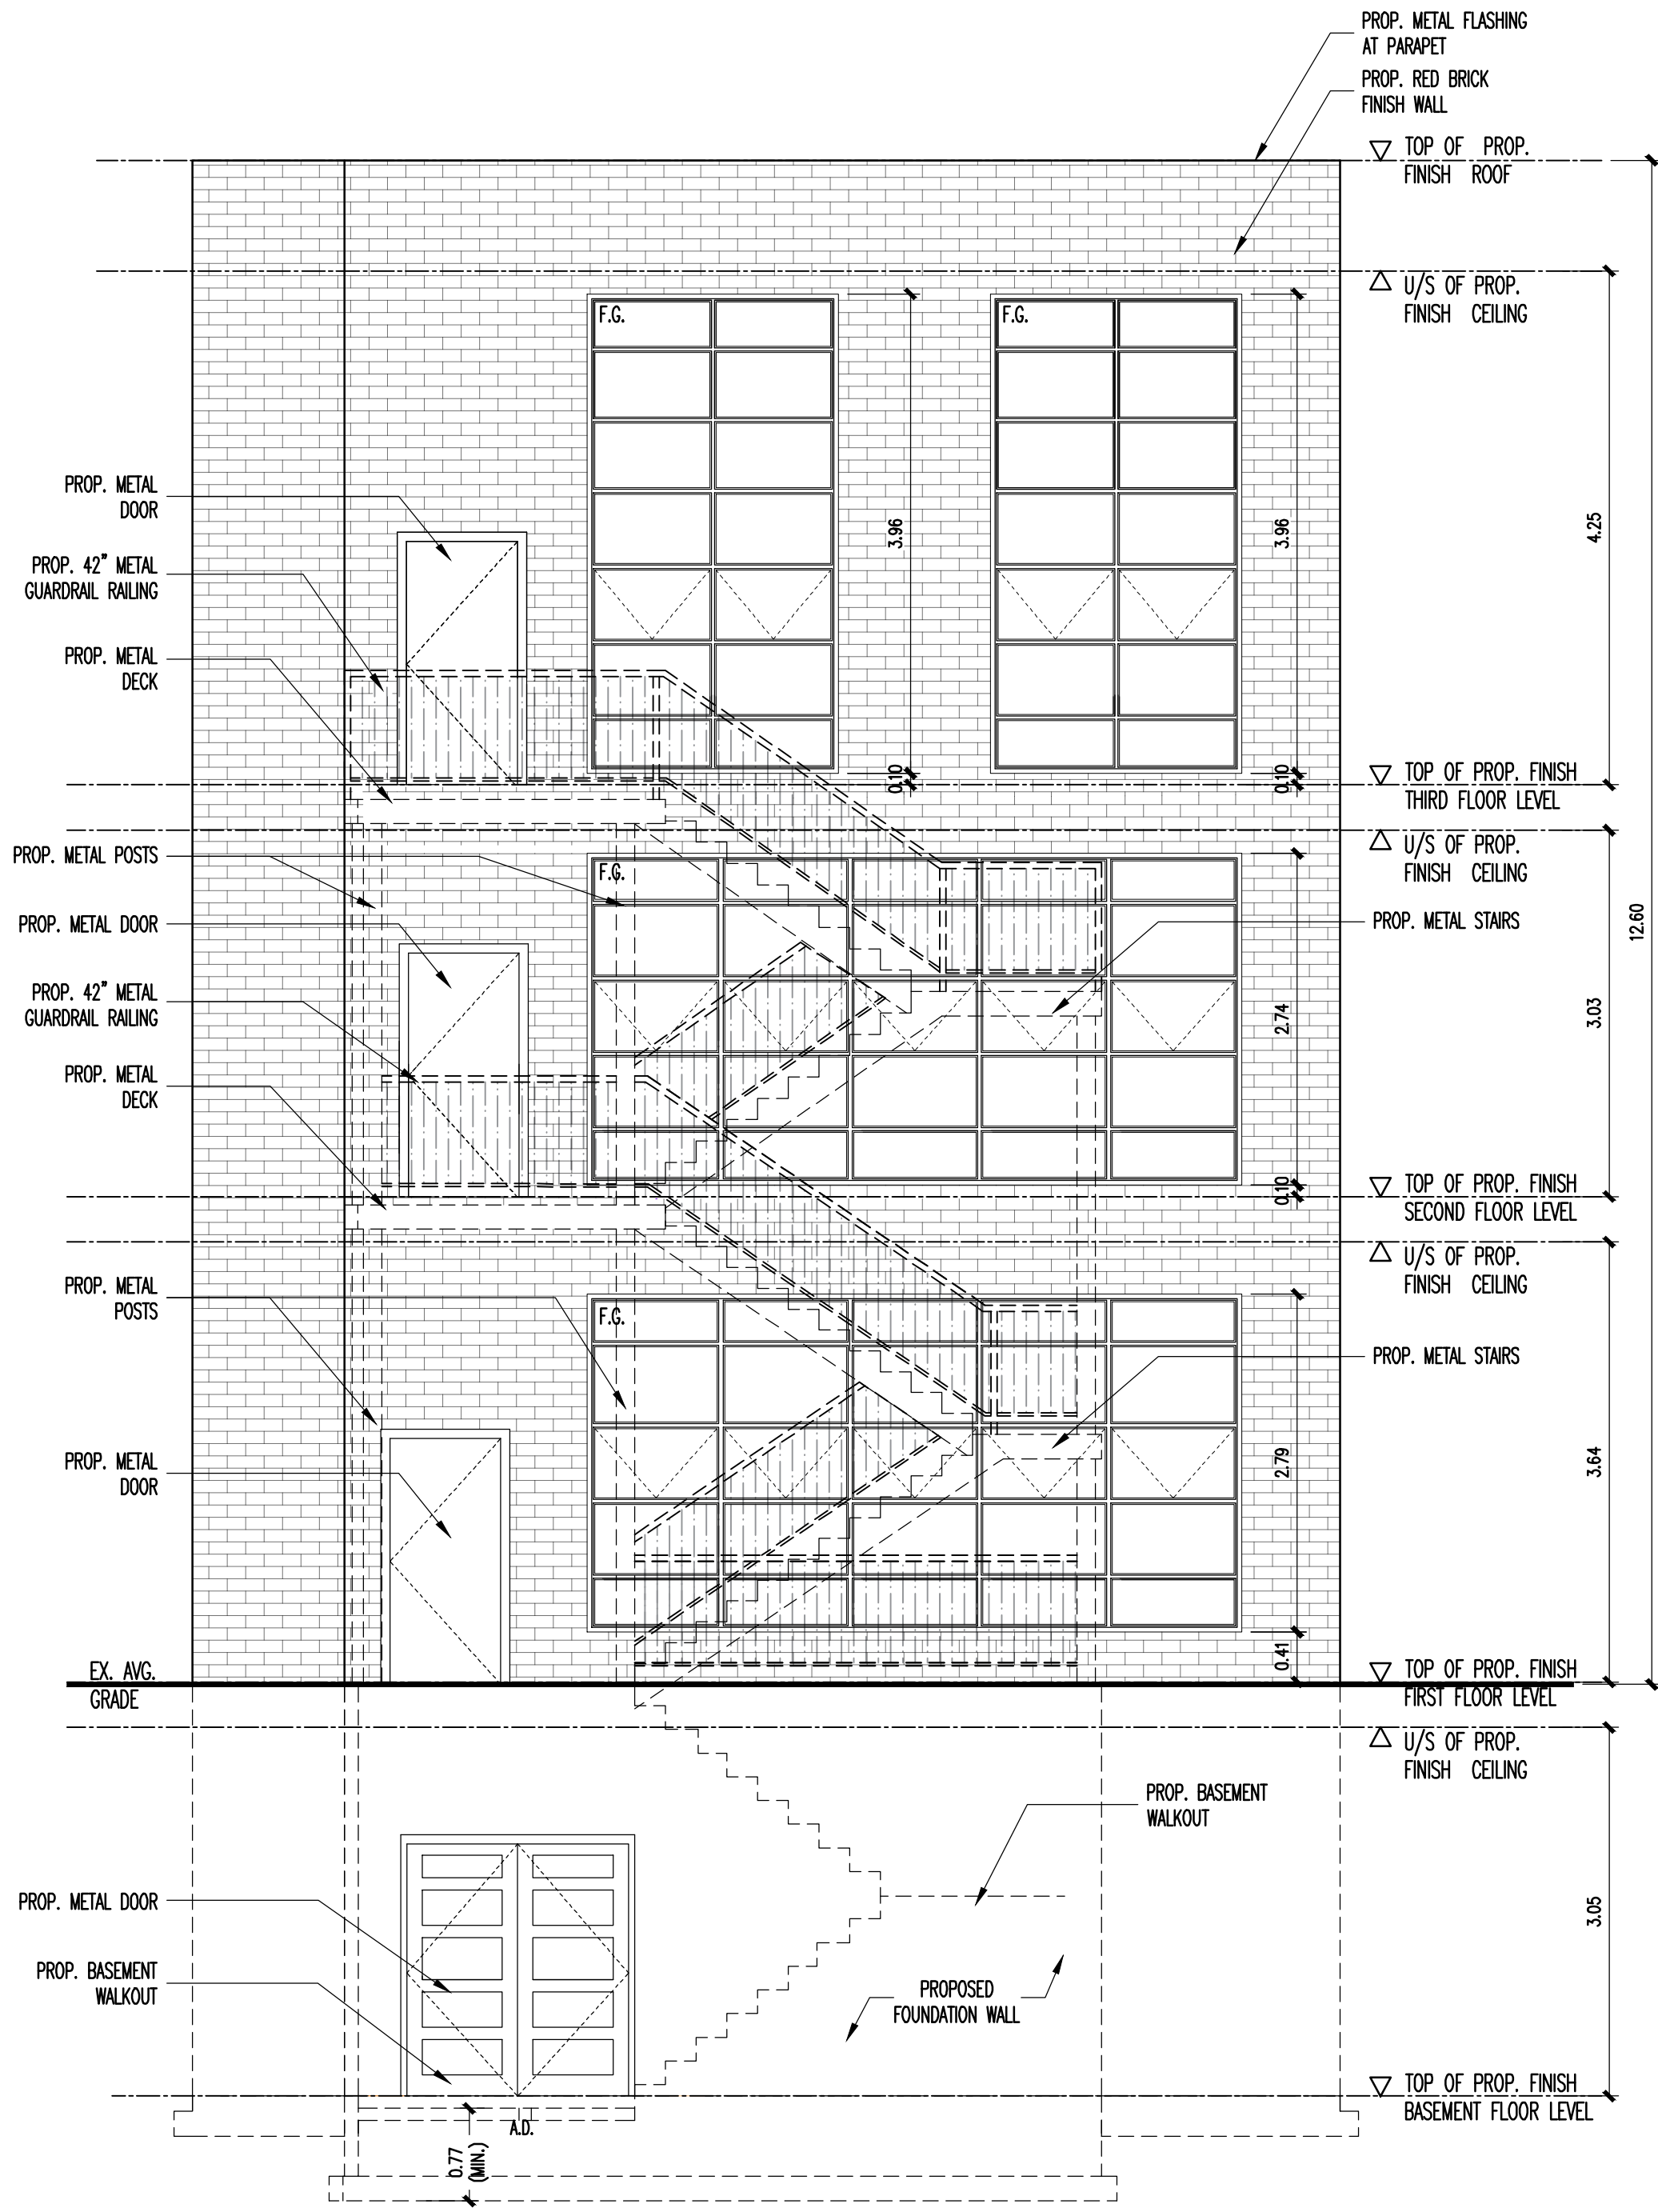

SOUTH ELEVATION
SCALE: 1:50

NO.	DESCRIPTION OF ISSUE	DATE	NO.	DESCRIPTION OF ISSUE	DATE
1	CITY COMMENTS REV01 SUBMISSION	02/22/2020	5	CITY COMMENTS REVIEW SUBMISSION	03/30/2021
2	CITY COMMENTS REV02 SUBMISSION	05/12/2020	6	CITY COMMENTS REVIEW SUBMISSION	08/02/2021
3	ISSUED FOR BUILDING PERMIT APPLICATION	08/11/2020	7		
4	REVIEWED FOR BUILDING PERMIT APPLICATION	08/28/2020	8		

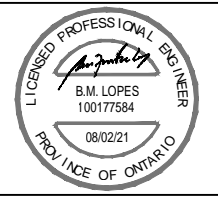

PROJECT 642 CONCESSION ST	SCALE 1 : 50
TITLE SOUTH ELEVATION	DATE AUGUST 2021
JOB No. 36-319	FILE No. DA-19-176
DRAWING No. A02.02	


FENESTRATION NOTE:

WINDOWS (GENERAL NOTES 42):

- ALL WINDOWS TO BE BLACK COLOUR WITH ALUMINIUM FRAME AND SILL
- ALL WINDOWS TO BE DOUBLE GLAZED WITH LOW E COATING


DOORS (GENERAL NOTES 43):

- ALL WINDOWS TO BE BLACK COLOUR WITH ALUMINIUM FRAME AND SILL

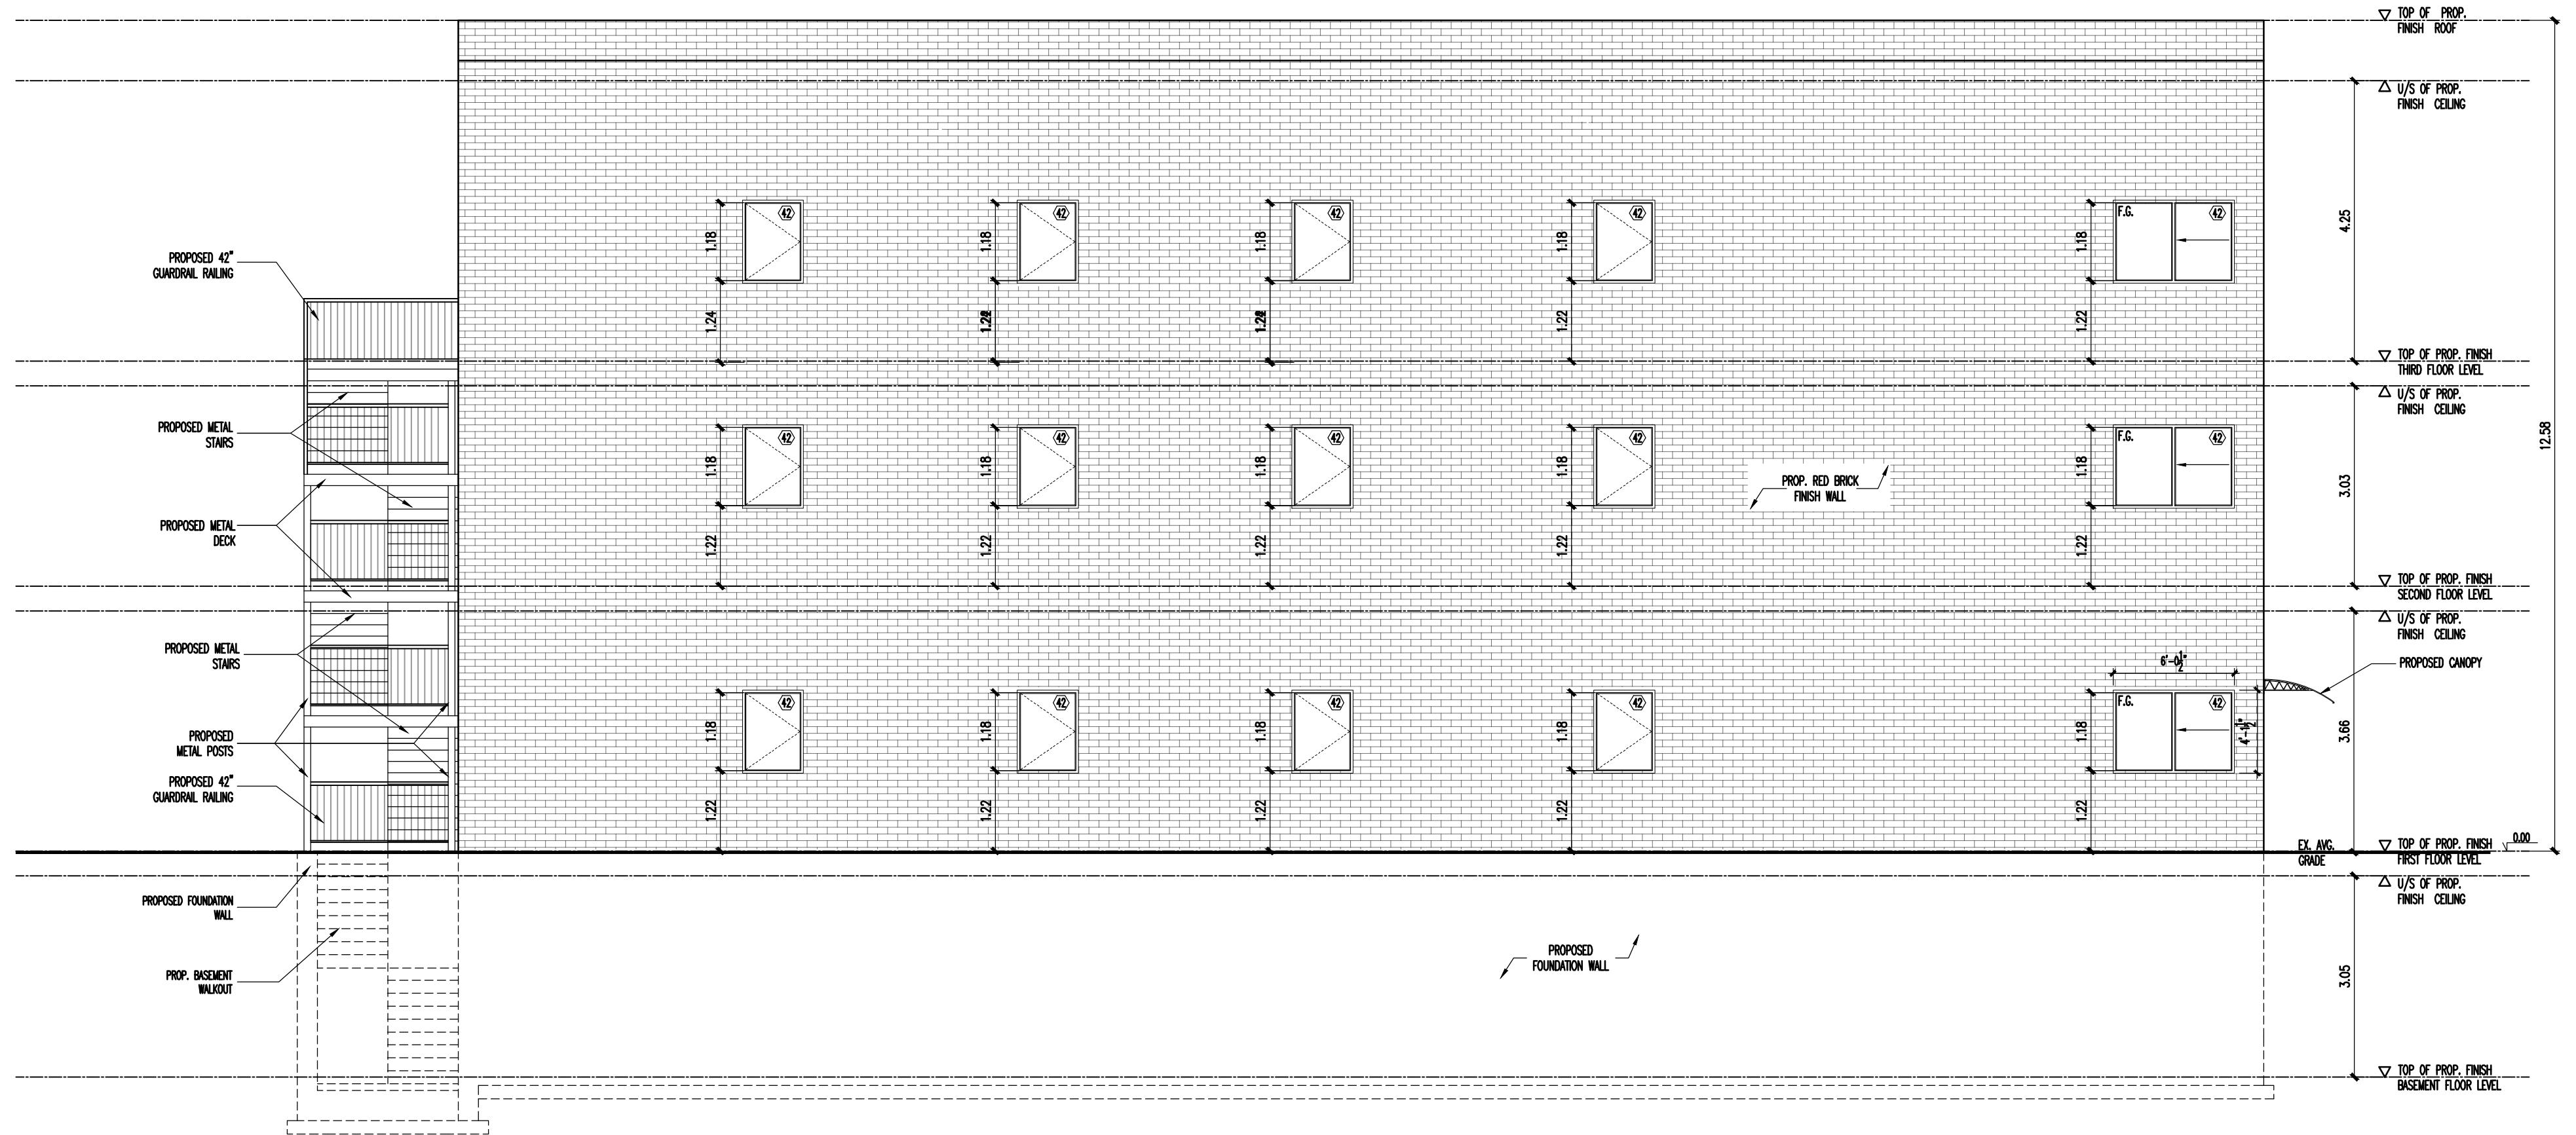


EAST ELEVATION
SCALE: 1:75

NO.	DESCRIPTION OF ISSUE	DATE	NO.	DESCRIPTION OF ISSUE	DATE
1	CITY COMMENTS REV01 SUBMISSION	02/22/2020	5	CITY COMMENTS REVIEW SUBMISSION	03/30/2021
2	CITY COMMENTS REV02 SUBMISSION	05/12/2020	6	CITY COMMENTS REVIEW SUBMISSION	08/02/2021
3	ISSUED FOR BUILDING PERMIT APPLICATION	08/11/2020	7		
4	REVIEWED FOR BUILDING PERMIT APPLICATION	08/28/2020	8		

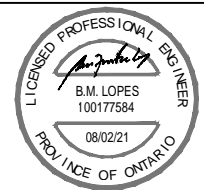


PROJECT 642 CONCESSION ST		SCALE 1 : 75	
TITLE EAST ELEVATION		DATE AUGUST 2021	
JOB No. 36-319	FILE No. DA-19-176	DRAWING No. A02.03	

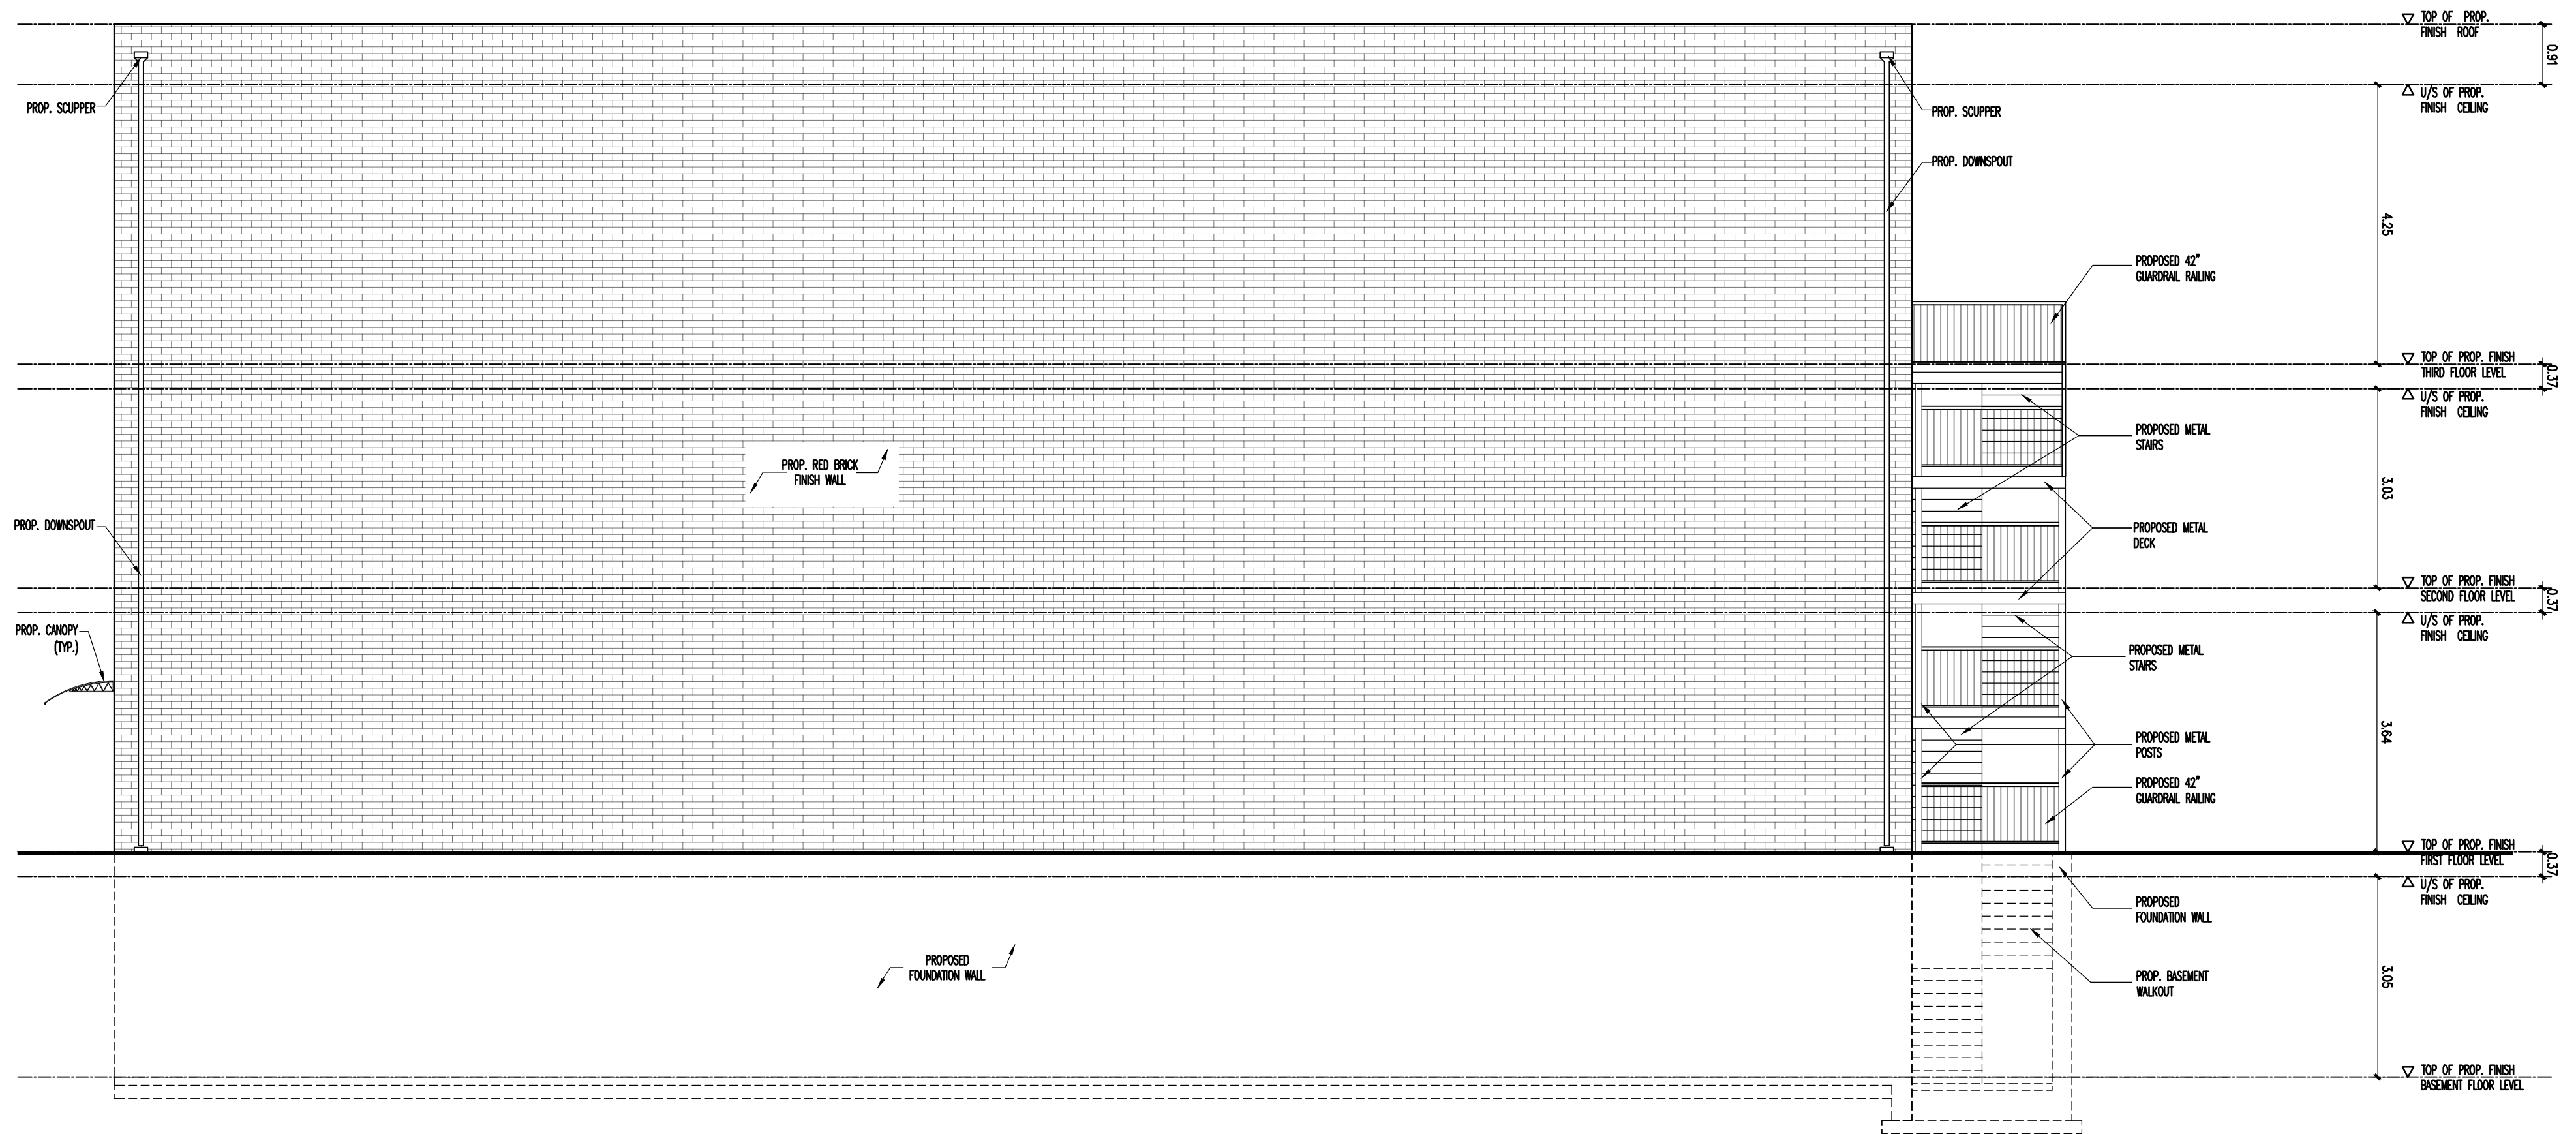


WEST ELEVATION
SCALE: 1:75

NO.	DESCRIPTION OF ISSUE	DATE	NO.	DESCRIPTION OF ISSUE	DATE
1	CITY COMMENTS REV01 SUBMISSION	02/22/2020	5	CITY COMMENTS REVIEW SUBMISSION	03/30/2021
2	CITY COMMENTS REV02 SUBMISSION	05/12/2020	6	CITY COMMENTS REVIEW SUBMISSION	08/02/2021
3	ISSUED FOR BUILDING PERMIT APPLICATION	08/11/2020	7		
4	REVIEWED FOR BUILDING PERMIT APPLICATION	08/28/2020	8		

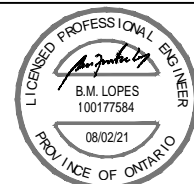

PROJECT 642 CONCESSION ST		SCALE 1:75	
TITLE WEST ELEVATION		DATE AUGUST 2021	
JOB No. 36-319	FILE No. DA-19-176	DRAWING No. A02.04	

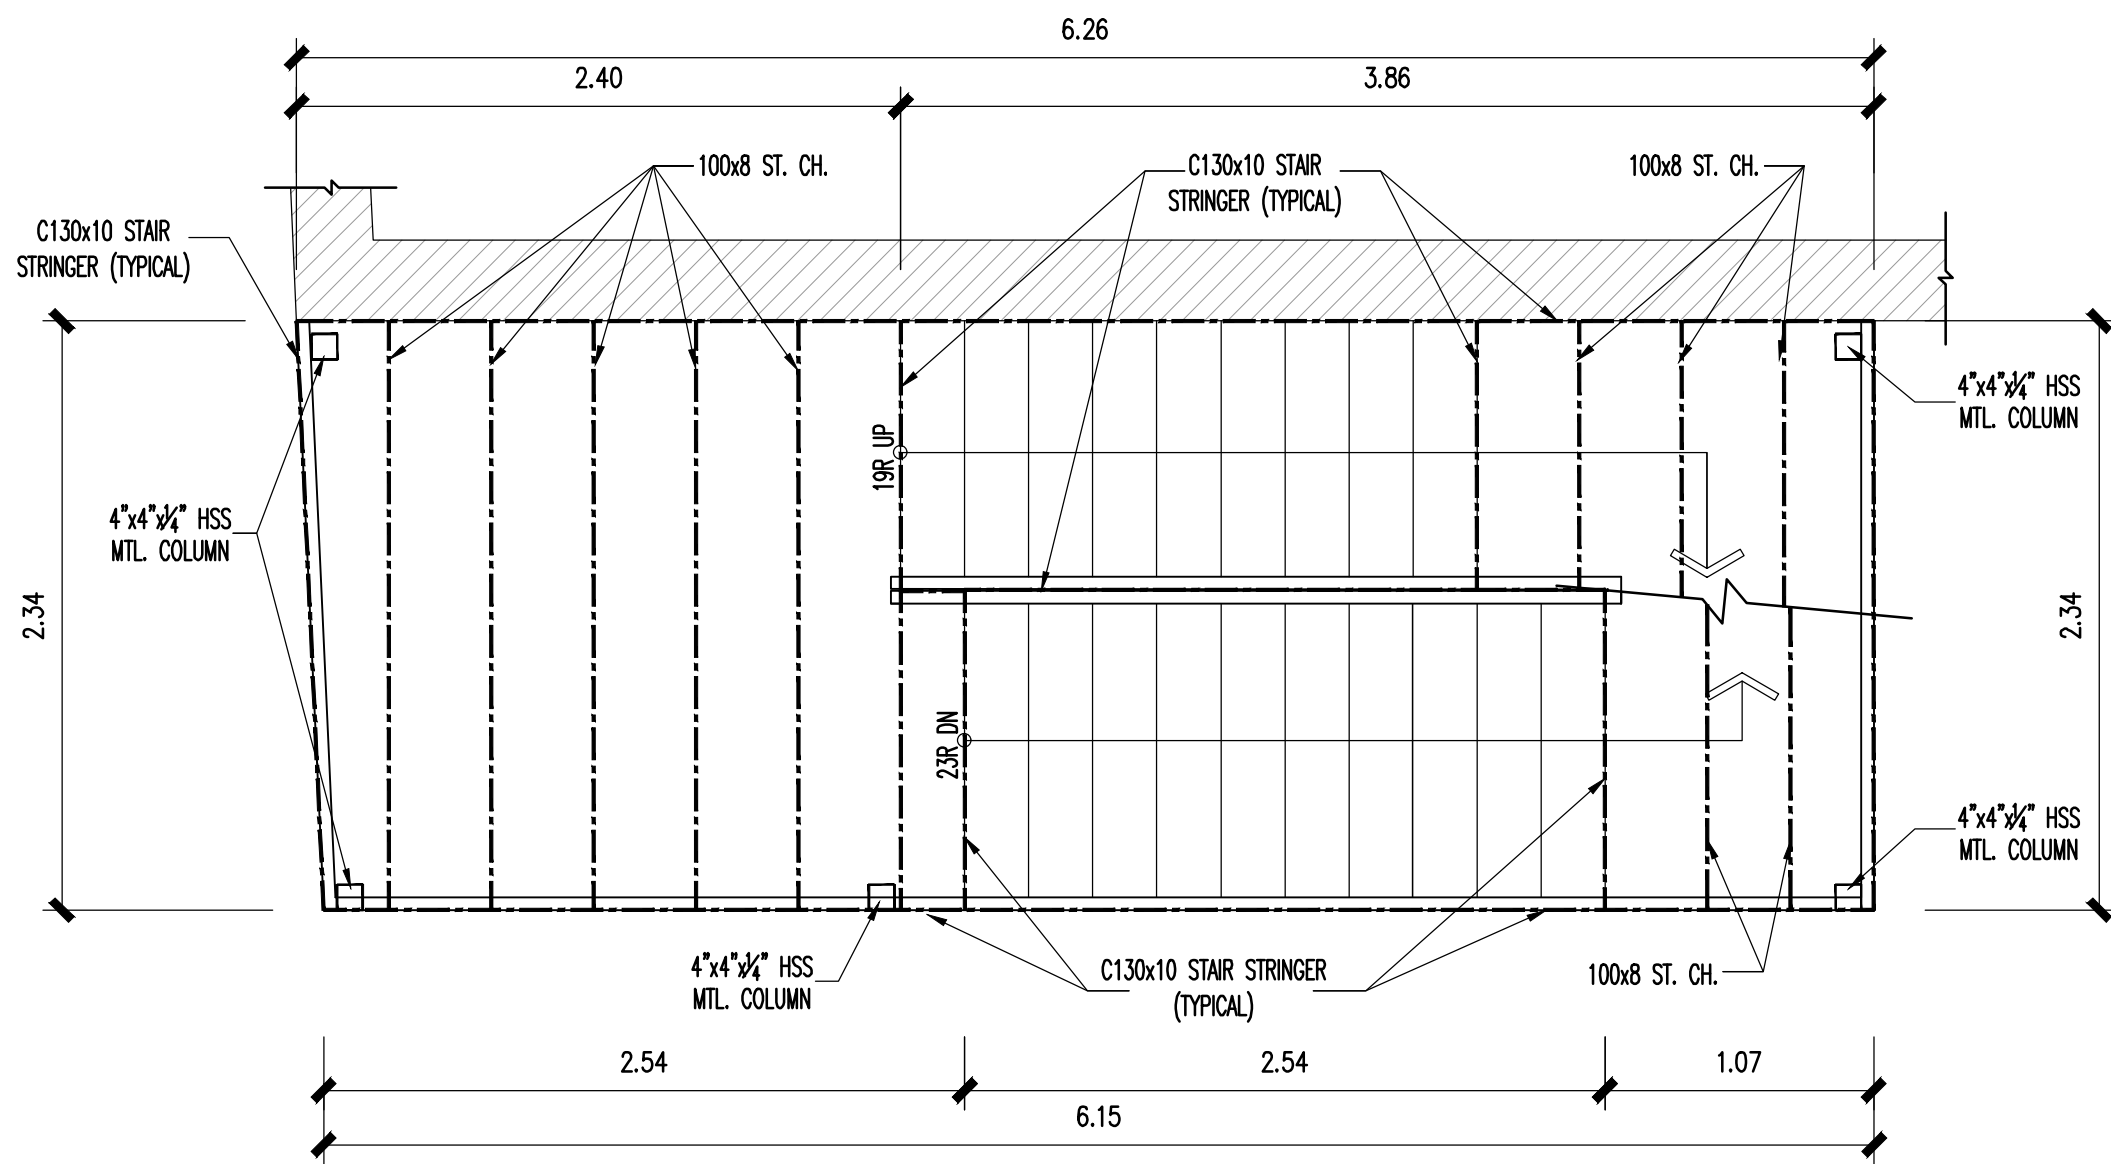


1 - STEEL STAIRS DETAIL PLAN
SCALE: 1 : 30

REAR STAIRS

typical note for exterior fire escape all openings in exterior walls within 9'-10" horizontally, all openings in exterior walls within 32'-10" vertically below proposed fire escape shall be protected with metal covered solid core wood door and frame with self closing and latching device. metal sash and frames and wired glass o/c sec. 3.4.7.4

- steel thickness of metal minimum g36 or equivalent.
- brackets 1/2" for brackets, purins, Columns, stair hangers. 3/16" for all other members shall not project more than 4 1/2" times the thickness of the wall to which they are attached.
- bolts bolts anchoring brackets to be kept 9" clear of all openings. bolts maybe used for field connections where shown on details
- walls where the exterior wall is not solid masonry, the structure must be supported by independent construction.
- cutting all holes cut in exterior masonry walls shall be well filled with mortar and made water tight.
- welding all welding shall conform to csa w59 latest revision, and shall be done by a fabricator qualified under csa w47 latest revision

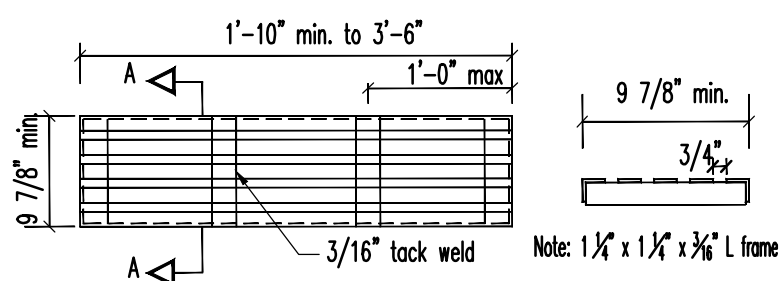

1 - TREAD CONSTRUCTION
SCALE: NTS

Section "A-A"

PROPOSED STAIR FRAMING


DESIGN OF GUARDS TO PREVENT CLIMBING

GUARDS AROUND EXTERIOR BALCONIES, PORCHES AND DECKS SHALL BE DESIGNED AND INSTALLED SO THAT NO MEMBER, ATTACHMENT OR OPENING LOCATED BETWEEN 4" (100mm) AND 2'-11" (600mm) ABOVE THE FLOOR OF THE BALCONY, PORCH OR DECK WILL FACILITATE CLIMBING.

LOADS ON GUARDS AND RAILING


THE MINIMUM SPECIFIED LOAD APPLIED HORIZONTALLY TO THE SPAN AT THE TOP OF EVERY REQUIRED GUARD SHALL BE:

- a. 3.0 kN/m (200 lb/ft) FOR MEANS OF EGRESS IN GRANDSTANDS, STADIUM BLEACHERS AND ARENAS
- b. A CONCENTRATED LOAD OF 1.0 kN (225 lbs) APPLIED AT ANY POINT FOR ACCESS WALKWAYS TO EQUIPMENT PLATFORMS, CONTIGUOUS STAIRS AND SIMILAR AREAS WHERE THE GATHERING OF MANY PEOPLE IS IMPROBABLE.
- c. 0.75 kN/m (50 lb/ft) OR A CONCENTRATED LOAD OF 1.0 kN (225 lbs) APPLIED AT ANY POINT, WHICHEVER GOVERNS, FOR LOCATIONS OTHER THAN DESCRIBED IN CLAUSES (a) AND (b). INDIVIDUAL ELEMENTS WITHIN THE GUARD, INCLUDING SOLID PANELS AND PICKETS, SHALL BE DESIGNED FOR A CONCENTRATED LOAD OF 0.5 kN (113 lbs) AT ANY POINT ON THE ELEMENT. THE MINIMUM SPECIFIED LOAD APPLIED VERTICALLY AT THE TOP OF EVERY REQUIRED GUARD SHALL BE 1.5 kN/m (100 lbs/ft) AND NEED NOT BE CONSIDERED TO ACT SIMULTANEOUSLY WITH THE HORIZONTAL LOAD.

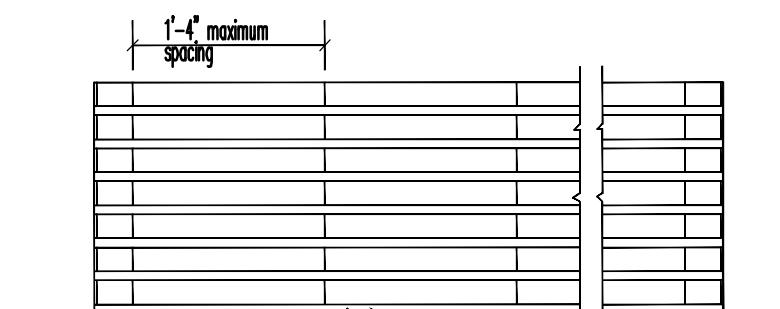


Note: 2" x 2" purins for span up to 4'-0" 1 1/2" flats max. span 1'-4" 3/4" spaces


FLOOR CONSTRUCTION

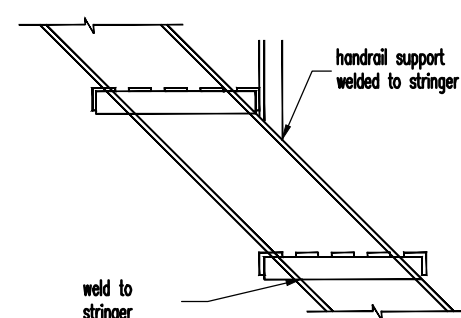

3 - TREAD & HANDRAIL SUPPORT
SCALE: NTS

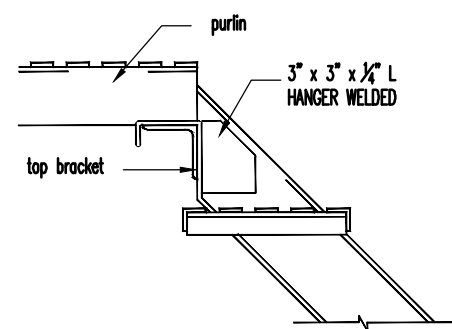


2 - DETAIL OF HANGER AT LANDING
SCALE: NTS

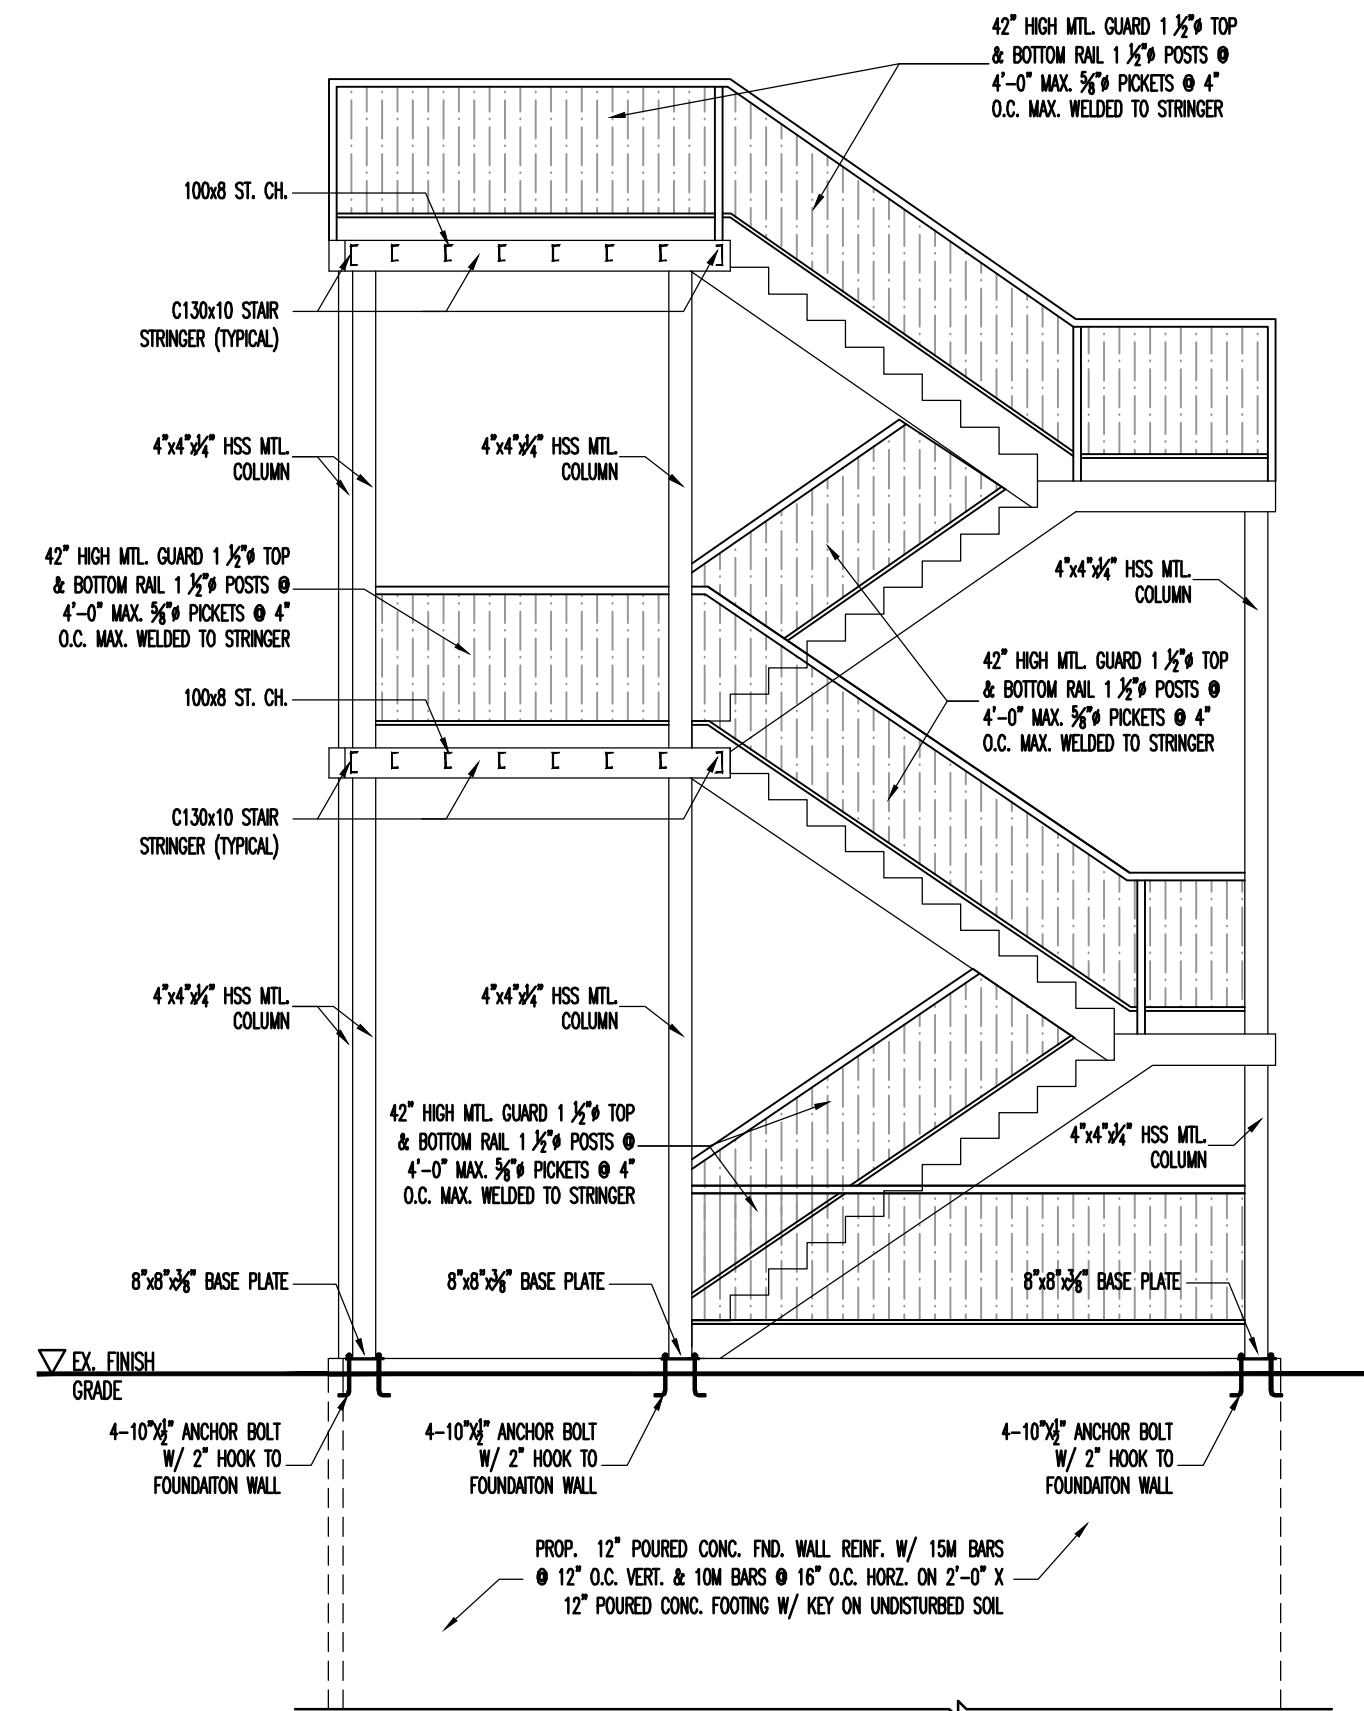


4 - STEEL STAIRS DETAIL ELEVATION
SCALE: 1 : 50

NO.	DESCRIPTION OF ISSUE	DATE	NO.	DESCRIPTION OF ISSUE	DATE
1	CITY COMMENTS REV01 SUBMISSION	02/22/2020	5	CITY COMMENTS REVIEW SUBMISSION	03/30/2021
2	CITY COMMENTS REV02 SUBMISSION	05/12/2020	6	CITY COMMENTS REVIEW SUBMISSION	08/02/2021
3	ISSUED FOR BUILDING PERMIT APPLICATION	08/11/2020	7		
4	REVIEWED FOR BUILDING PERMIT APPLICATION	08/28/2020	8		

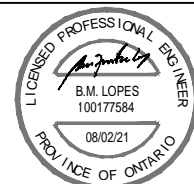

PROJECT 642 CONCESSION ST		SCALE AS SHOWN	
TITLE METAL STAIRS DETAIL		DATE AUGUST 2021	
JOB No. 36-319	FILE No. DA-19-176	DRAWING No. A03.01	

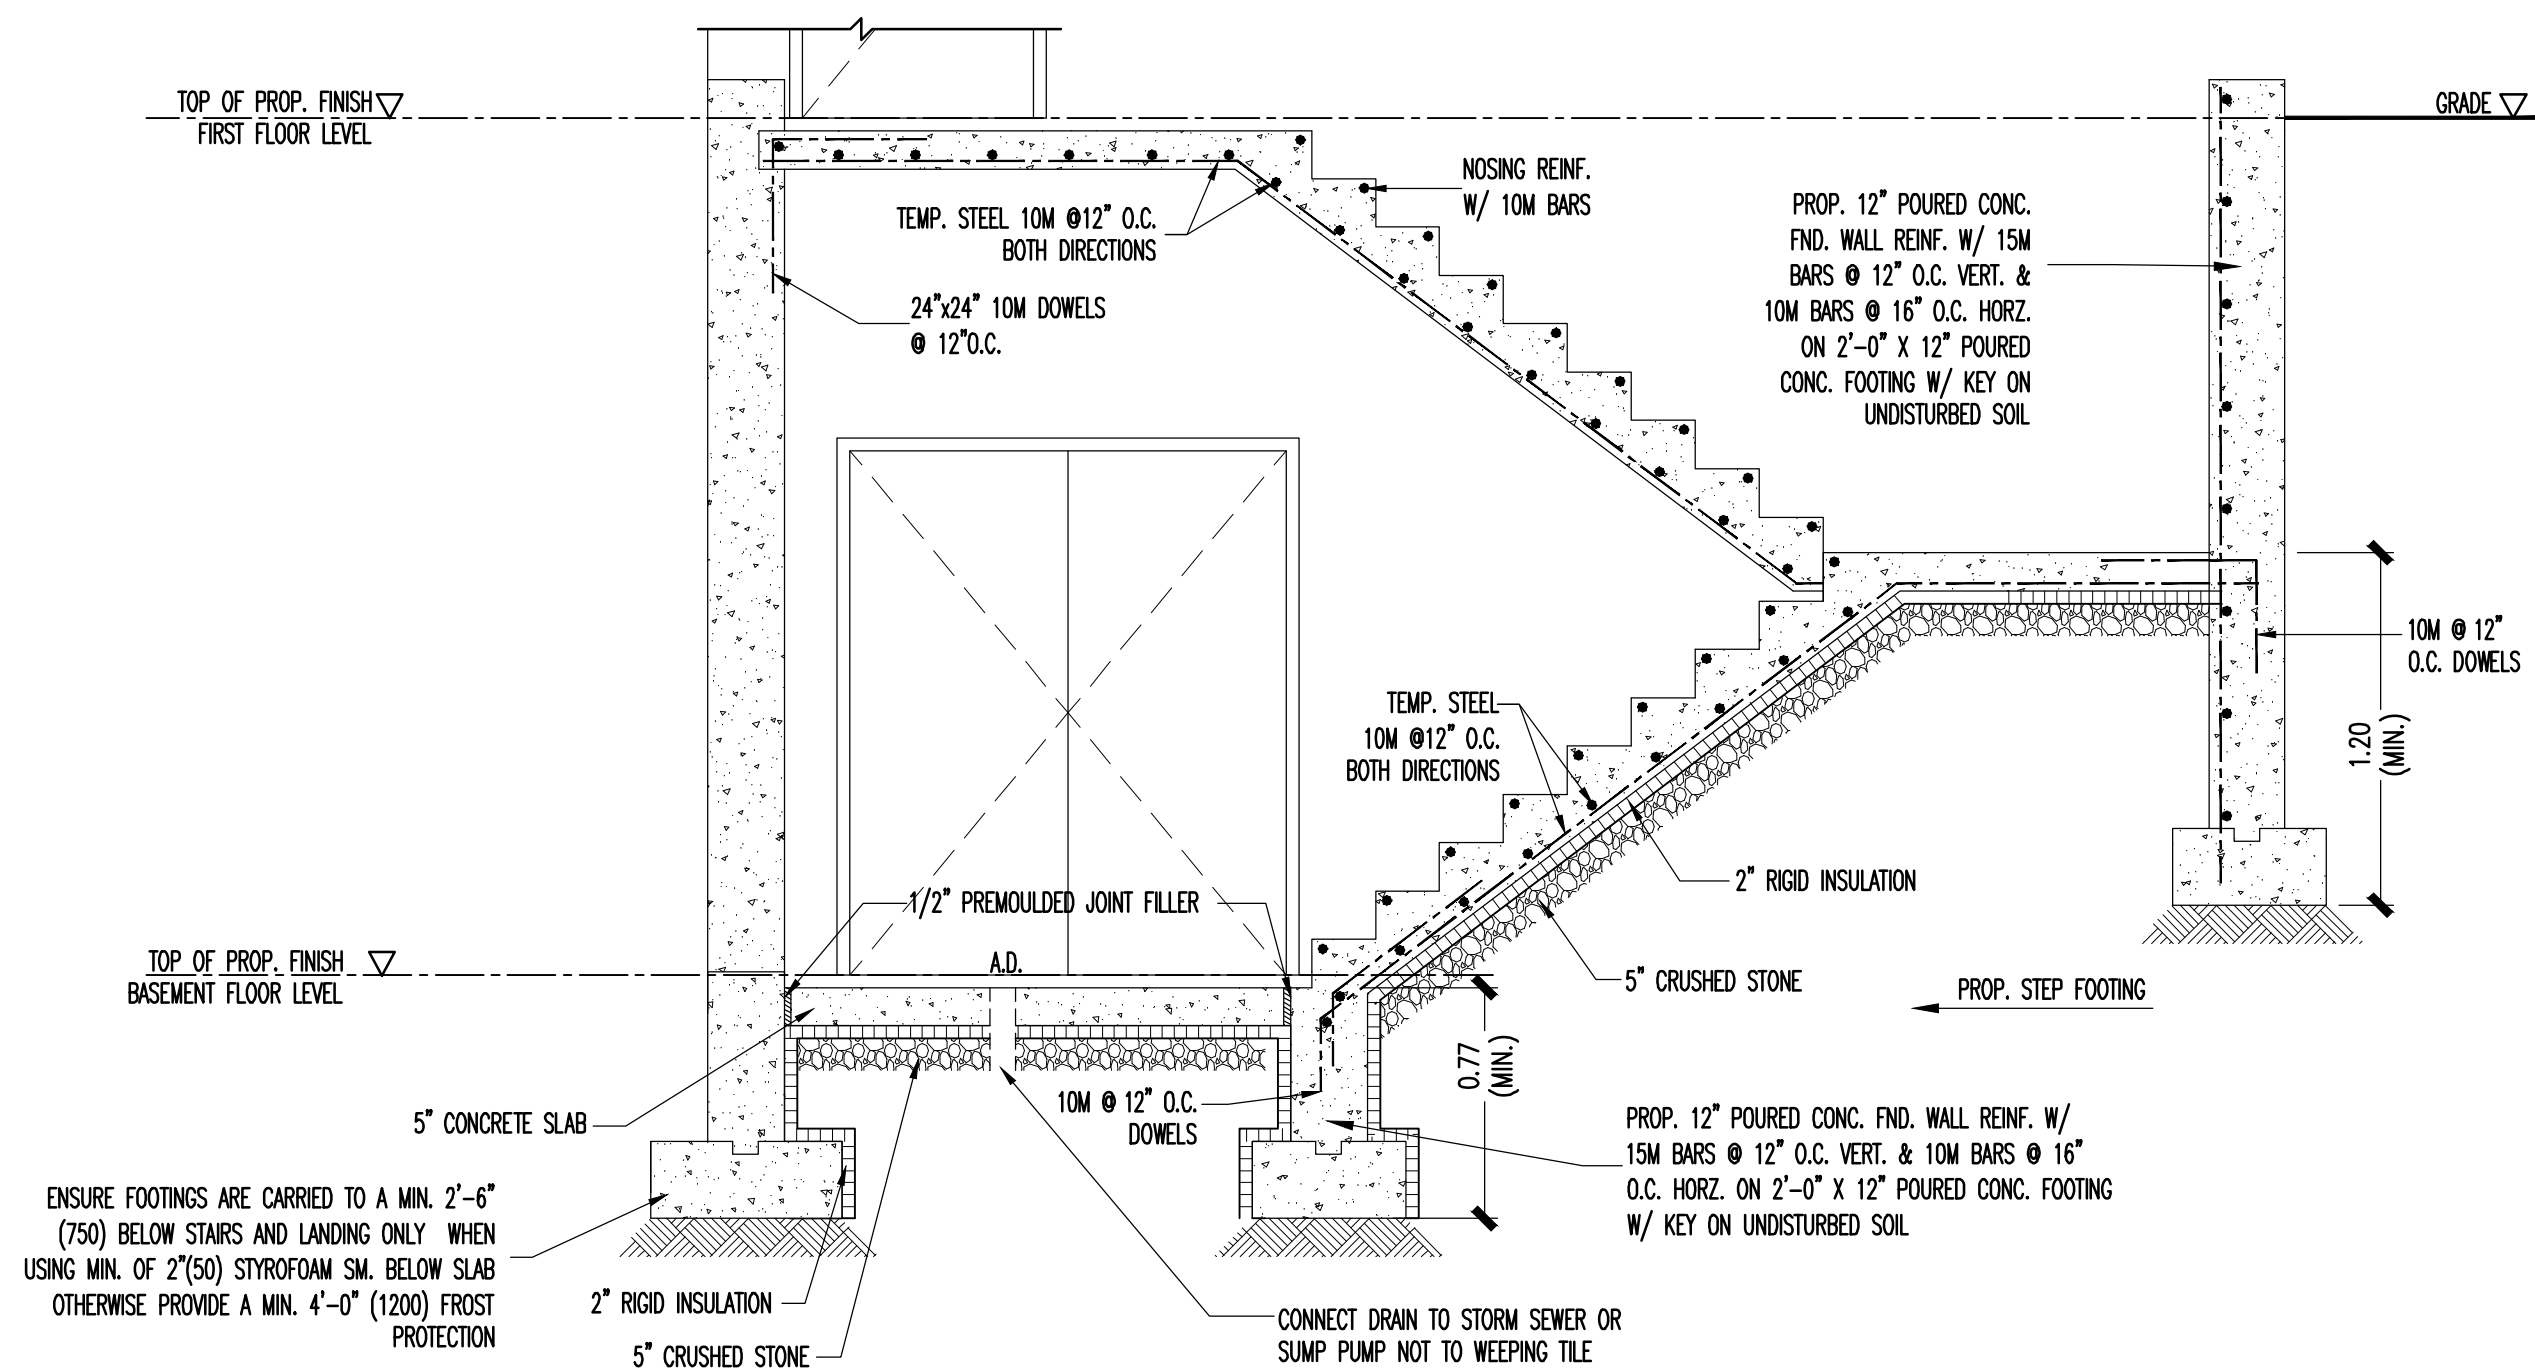

1-BASEMENT WALKOUT
SCALE: 1:30

OBC 4.1.5.15 AND 9.8.8.2 THE MINIMUM SPECIFIED LOAD APPLIED HORIZONTALLY AND NORMAL TO THE SPAN AT THE TOP OF EVERY REQUIRED GUARD SHALL BE: (A) 34 lb/ft (0.5 kN/m) FOR EXTERIOR BALCONIES OF INDIVIDUAL RESIDENTIAL UNITS AND A CONCENTRATED LOAD OF 224 lb. (1.0 kN) APPLIED CONCURRENTLY AT ANY POINT (B) 224 lb (1.0 kN/m) FOR EXITS AND STAIRS ADJULIED AT ANY POINT (C) 52 lb/ft (0.75 kN/m) FOR LOCATIONS OTHER THAN DESCRIBED ABOVE.

INDIVIDUAL ELEMENTS WITHIN THE GUARD, INCLUDING SOLID PANELS AND PICKETS, SHALL BE DESIGNED FOR 20 psf. OR 100 lb. OF CONCENTRATED LOAD AT ANY POINT IN THE ELEMENT, WHICH RESULTS IN THE MORE CRITICAL LOADING CONDITION.

THE MINIMUM SPECIFIED LOAD APPLIED VERTICALLY AT THE TOP OF EVERY REQUIRED GUARD SHALL BE 100 lb/ft AND NEED NOT BE CONSIDERED TO ACT SIMULTANEOUSLY WITH THE HORIZONTAL LOAD.

GUARDS AROUND EXTERIOR BALCONIES, PORCHES, AND DECKS SHALL BE DESIGNED/INSTALLED SO THAT NO MEMBER, ATTACHMENT OR OPENING LOCATED BETWEEN 4"(100) AND 2'11"(900) ABOVE THE FLOOR OF THE BALCONY, PORCH OR DECK WILL FACILITATE CLIMBING.

GENERAL NOTES

1. EXTERIOR STAIRS

- 7 7/8" RISE MAXIMUM
- 8 1/4" RUN MINIMUM
- 9 1/4" TREAD MINIMUM
- 1" NOSING MINIMUM

2. HANDRAIL

ARE REQUIRED WHERE STEPS HAVE MORE THAN 3 RISERS . HANDRAIL HEIGHT 31" - 38".

3. FOUNDATION WALLS

THICKNESS OF FOUNDATION WALLS IS DEPENDANT UPON HEIGHT OF FINISH GRADE ABOVE BASEMENT FLOOR .

- UNIT MASONRY THICKNESS 8" - MAX. HEIGHT 3'-11"
- UNIT MASONRY THICKNESS 10" - MAX. HEIGHT 5'-11"
- UNIT MASONRY THICKNESS 12" - MAX. HEIGHT 7'-3"


4. CONCRETE

MINIMUM CONCRETE STRENGTH SHALL BE 32 MPa W/ 5%-8% AIR ENTRAINMENT CONCRETE SLAB THICKNESS 4" UP TO 6'-8" SPAN CONCRETE SLAB THICKNESS 5" UP TO 8'-4" SPAN CONCRETE SLAB THICKNESS 6" UP TO 10'-0" SPAN


5. PROVIDE MINIMUM 1 3/4" CLEAR CONCRETE COVER TO REINFORCING BARS

6. GUARDS

ARE REQUIRED AROUND CONCRETE SLAB IF MORE THAN 2'-0" ABOVE GRADE & ON BOTH SIDES OF STAIRS CONTAINING MORE THAN 3 RISERS. MINIMUM 31" HIGH FOR STAIRS, MINIMUM 35" HIGH FOR PORCHES UP TO 5'-11" ABOVE GRADE, MINIMUM 42" HIGH FOR GREATER HTS.

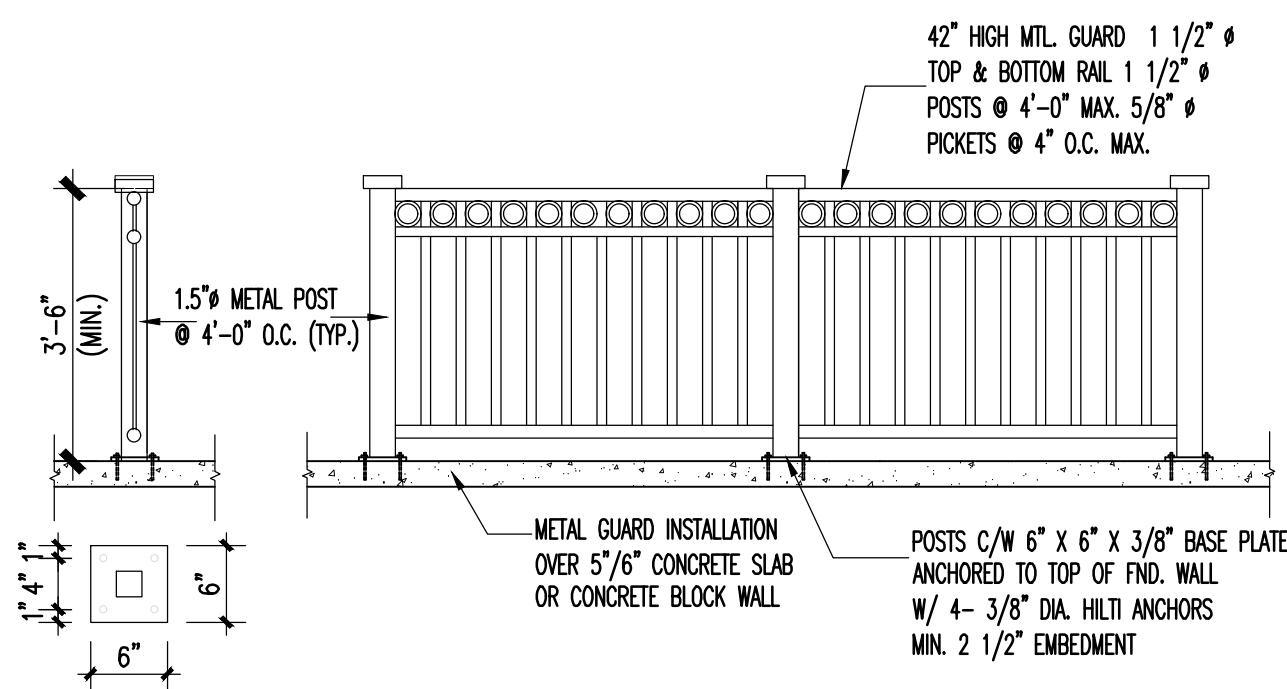


2-METAL GUARD DETAIL
SCALE: N/A

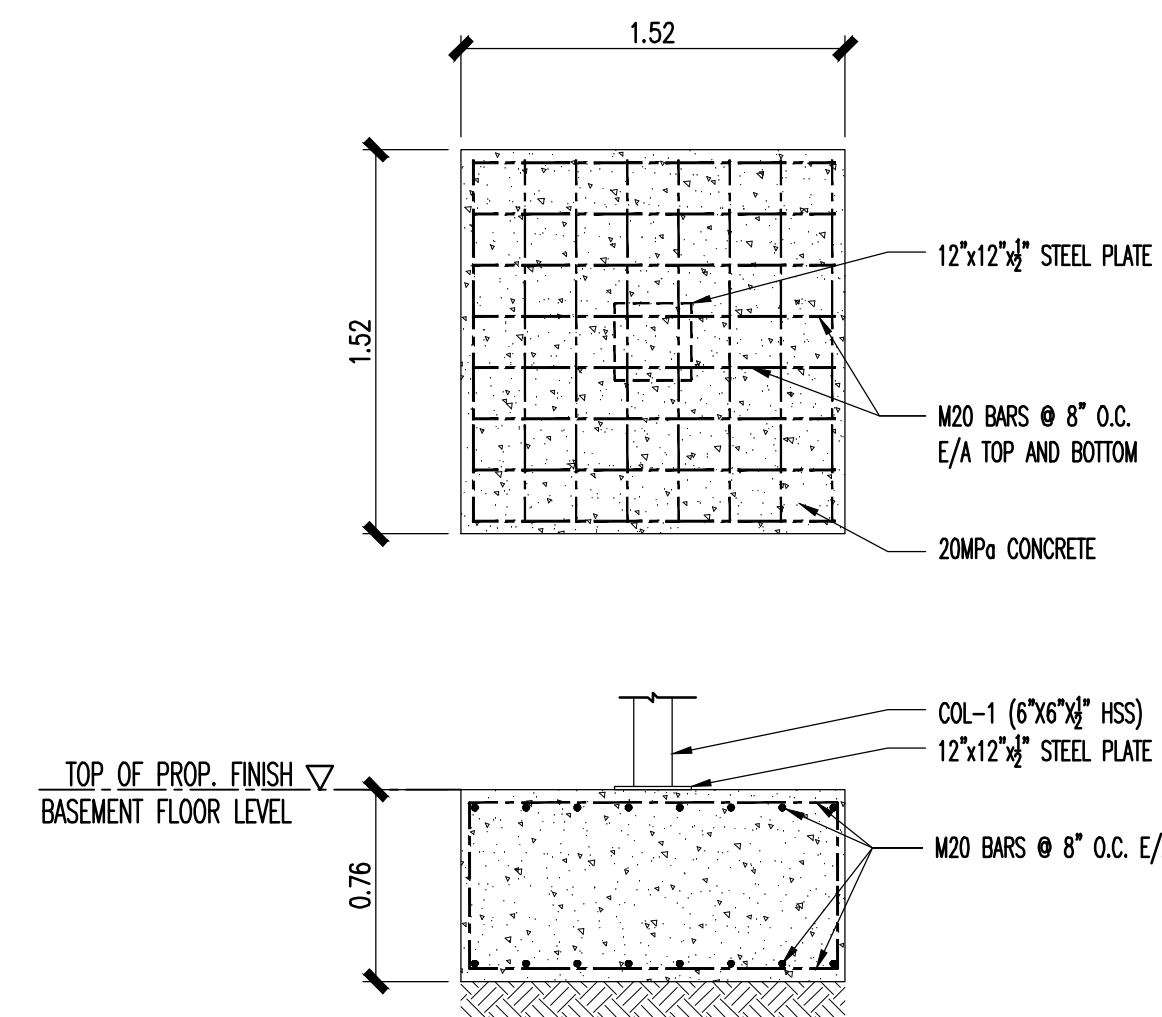

3-COLUMN FOOTING DETAIL
SCALE: 1:30


NOTE:

1. ALL STRUCTURAL STEEL TO CONFORM TO CON 3-S 16.1 LATEST ADDITION.
2. ALL H.S.S. SECTION FY-350
3. MIN. STRENGTH OF CONCRETE -32.5 MPa
4. FINISH TO STRUCTURAL STEEL
5. GUARD DESIGN IN COMPLIANCE W/ O.B.C. 4.1.10.1
6. ALL GUARDS TO BE PRIMED & PAINTED W/ 2 FINISH COATS (CO- ORIDINATE COLOUR W/ OWNER)

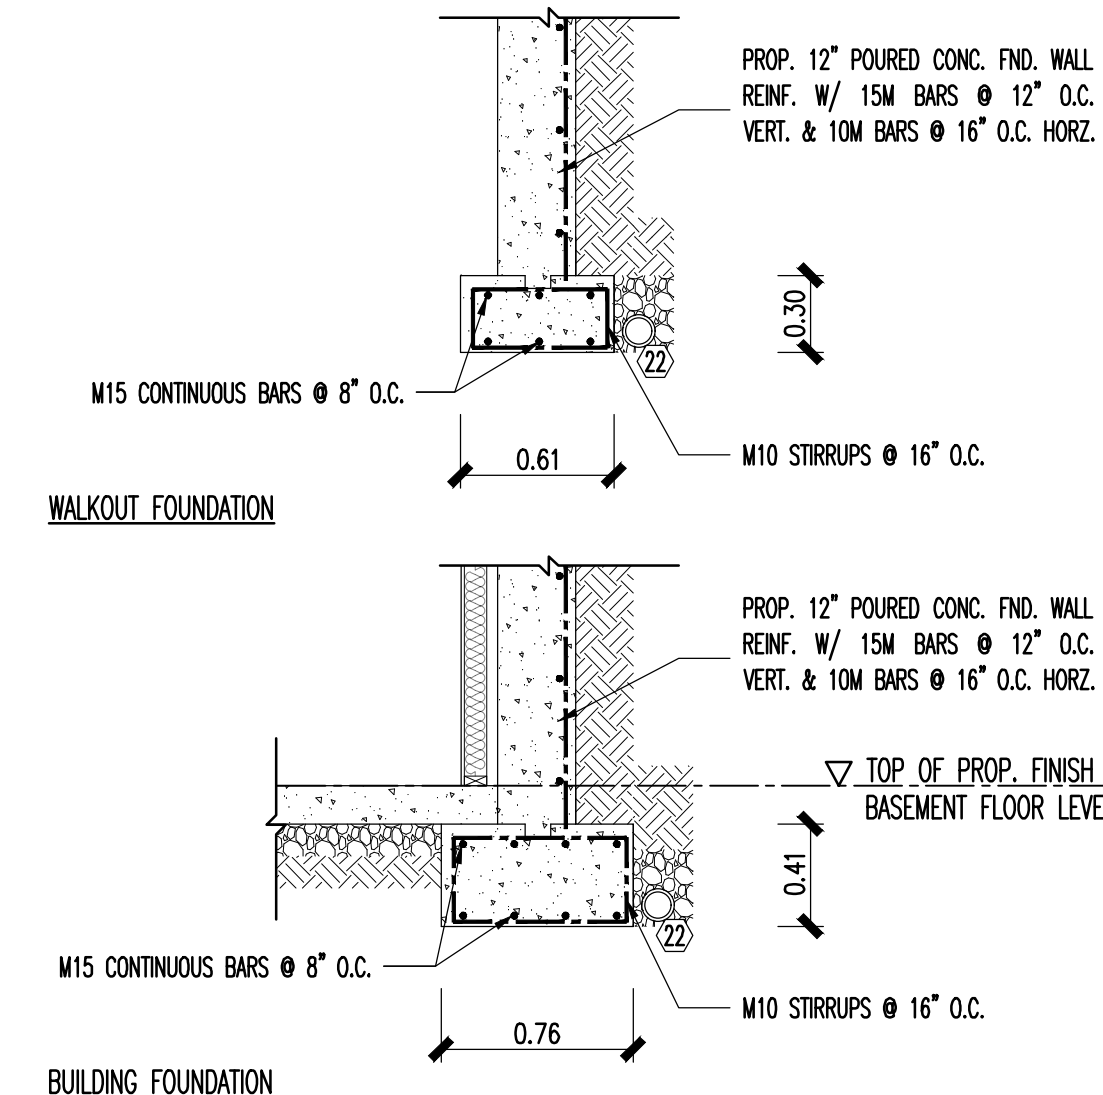


4-STRIP FOOTING DETAILS
SCALE: 1:30

NO.	DESCRIPTION OF ISSUE	DATE	NO.	DESCRIPTION OF ISSUE	DATE
1	CITY COMMENTS REV01 SUBMISSION	02/22/2020	5	CITY COMMENTS REVIEW SUBMISSION	03/30/2021
2	CITY COMMENTS REV02 SUBMISSION	05/12/2020	6	CITY COMMENTS REVIEW SUBMISSION	08/02/2021
3	ISSUED FOR BUILDING PERMIT APPLICATION	08/11/2020	7		
4	REVIEWED FOR BUILDING PERMIT APPLICATION	08/28/2020	8		

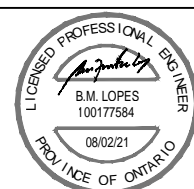


PROJECT 642 CONCESSION ST		SCALE AS SHOWN	
TITLE BASEMENT WALKOUT, RAILINGS, AND FOOTINGS DETAILS		DATE AUGUST 2021	
JOB No. 36-319	FILE No. DA-19-176	DRAWING No. A03.02	

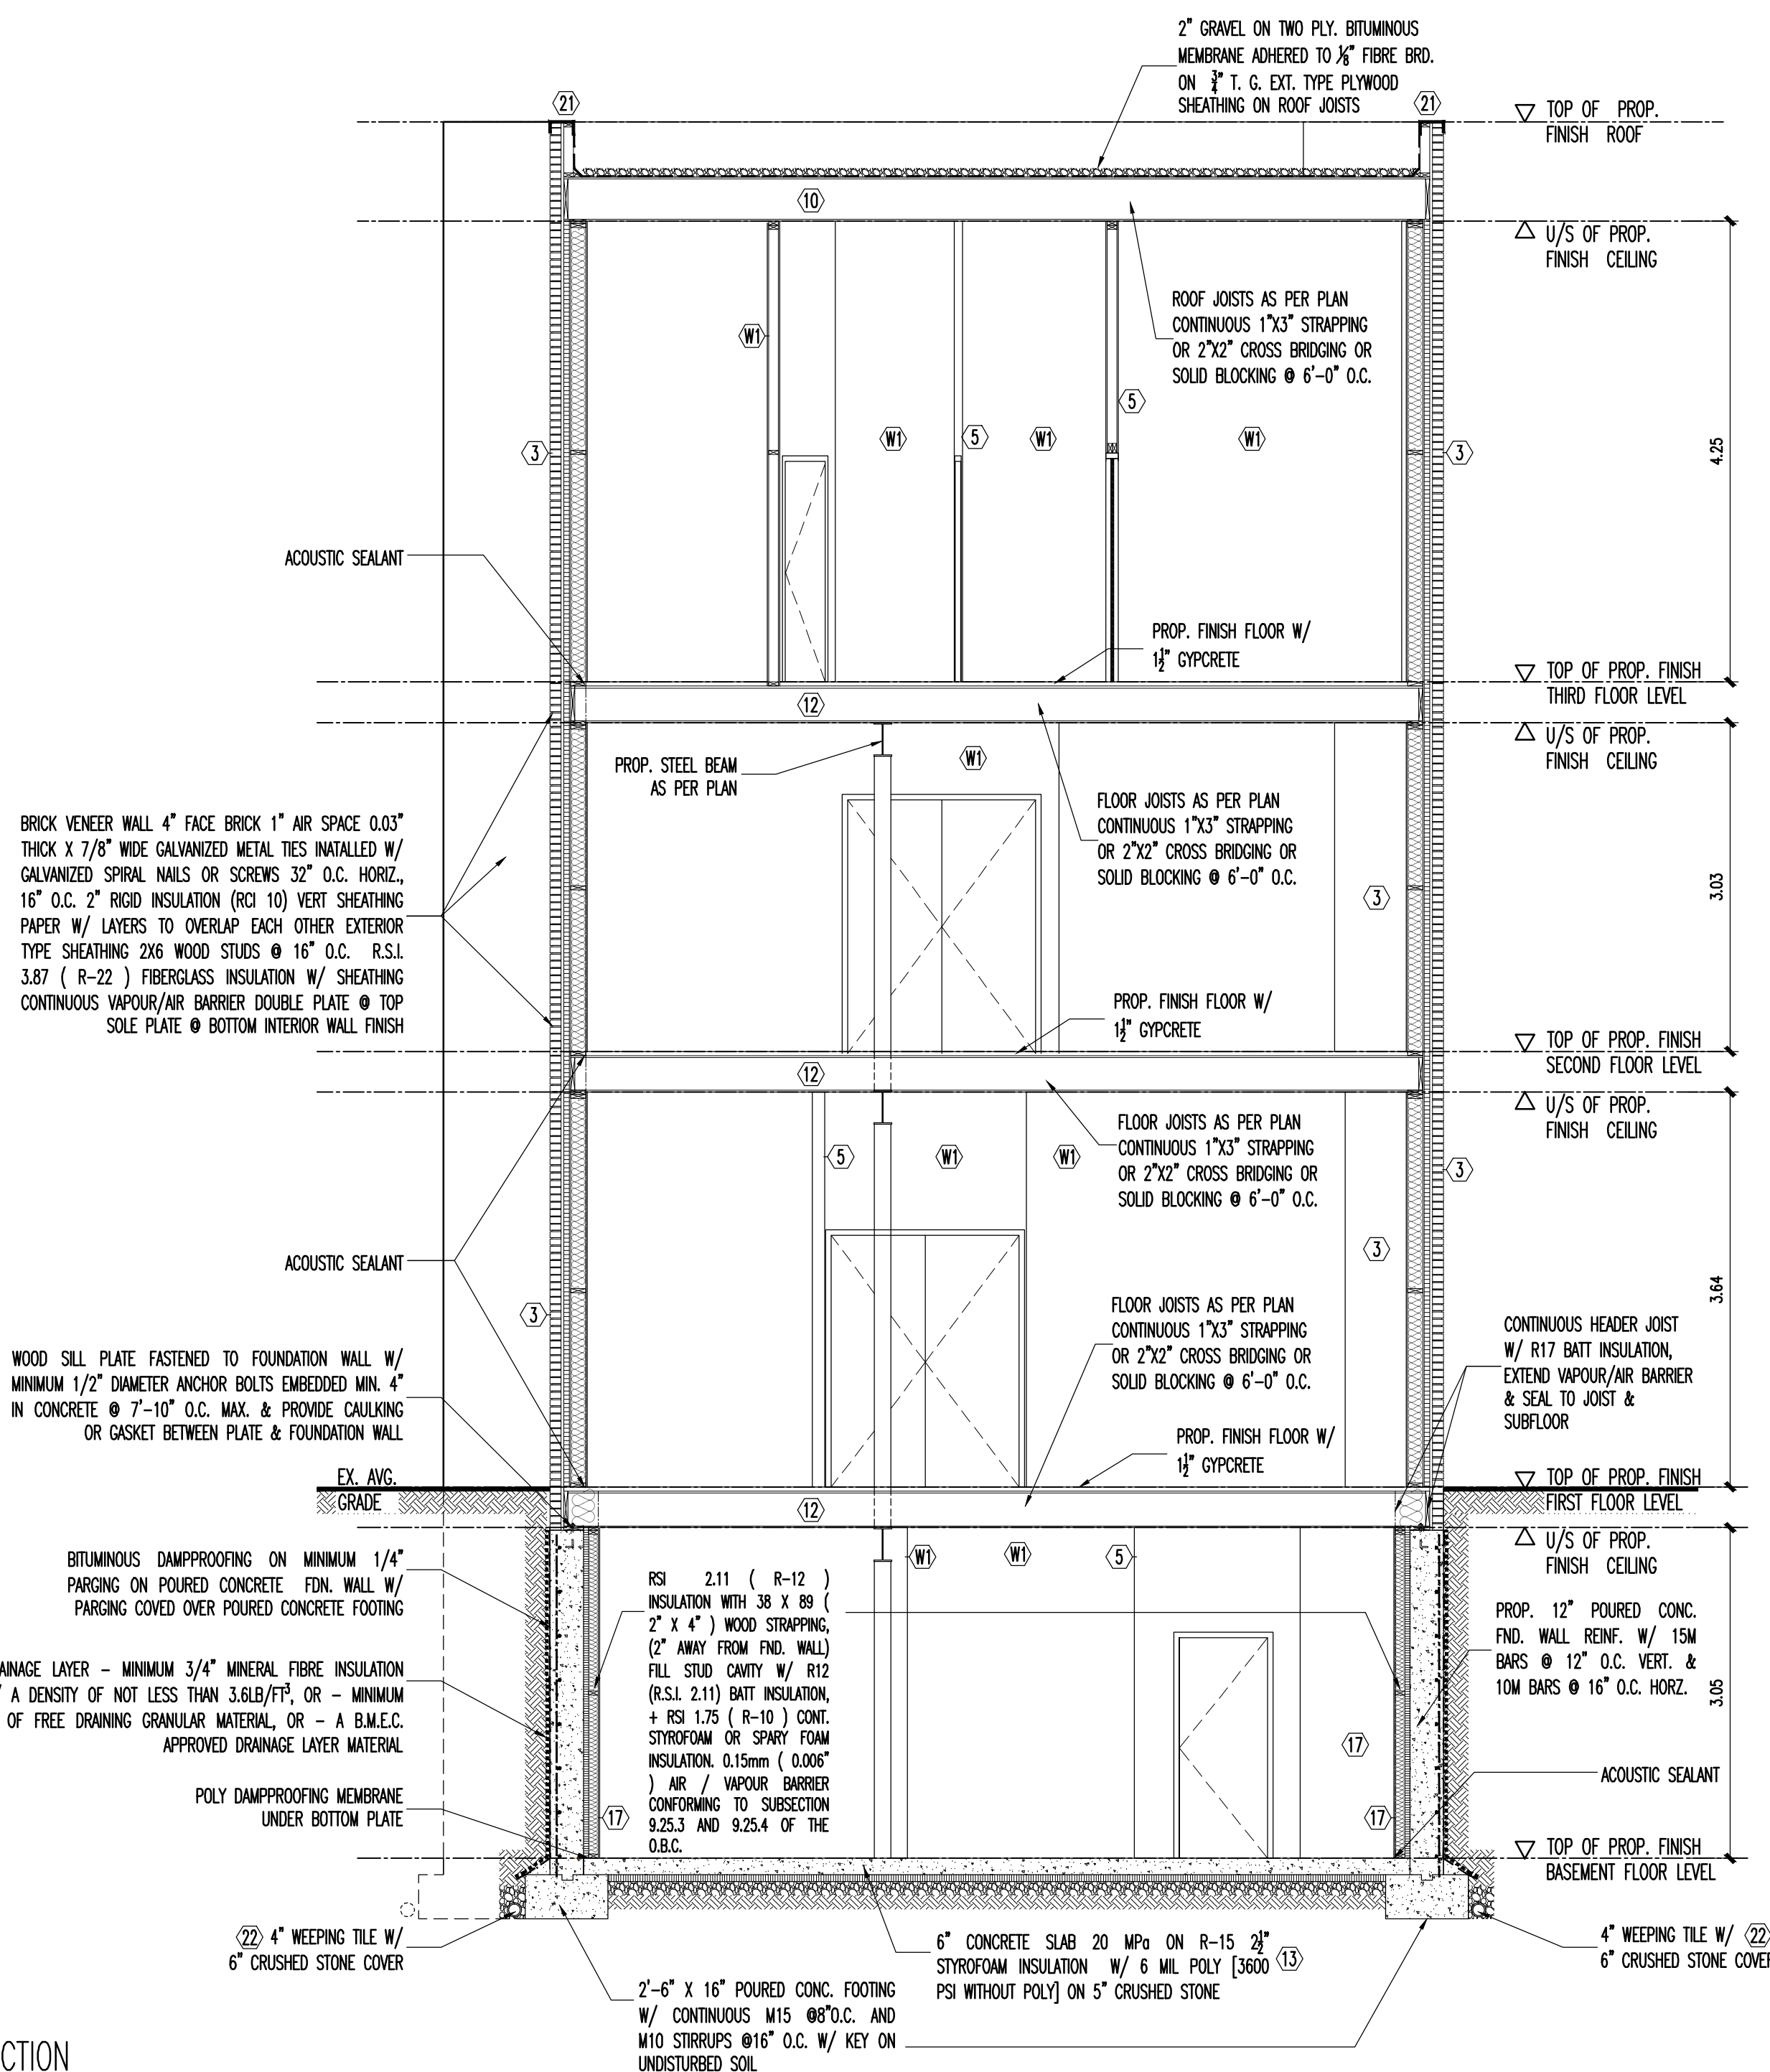

1-SECTION
SCALE: 1:50

- (W1) NEW RATED LOAD BEARING PARTITION WALL
1 HOUR FIRE RATED, WITH MIN. STC RATING 51, AS PER SB-3 W46
2 LAYERS 5/8" TYPE "X" GYP. WALL BRD. APPLIED TO RESILIENT MET. CHANNELS @ 16" O.C. INSIDE OF 2" X 4" OR 2"x6" MTL. STUDS @ 16" O.C., (48 GAUGE), ONE LAYER 5/8" TYPE "X" GYP. WALL BRD. ON THE OTHER SIDE OF STUDS C/W 5 1/2" SOUND ABSORPTIVE INSUL. TO U/S OF SUB-FLOOR ABOVE.
- (C1) NEW CEILING
1 HOUR FIRE RATED WITH STCS2 REFER TO ULC DESIGN NO. M501
FILL JOIST CAVITY W/ SOUND PROOF INSUL. (SOUND TRANSMISSION TO CONFORM TO O.B.C. 9.11.21.) C/W 5/8" RESILIENT MTL. FURRING CHANNELS @ 16" O.C. PERPENDICULAR TO FLOOR JOISTS W/ 1/2" TYPE "X" GYP. WALL BRD. W/ PAINTED FINISH (TYP.)

NO.	DESCRIPTION OF ISSUE	DATE	NO.	DESCRIPTION OF ISSUE	DATE
1	CITY COMMENTS REV01 SUBMISSION	02/22/2020	5	CITY COMMENTS REVIEW SUBMISSION	03/30/2021
2	CITY COMMENTS REV02 SUBMISSION	05/12/2020	6	CITY COMMENTS REVIEW SUBMISSION	08/02/2021
3	ISSUED FOR BUILDING PERMIT APPLICATION	08/11/2020	7		
4	REVIEWED FOR BUILDING PERMIT APPLICATION	08/28/2020	8		

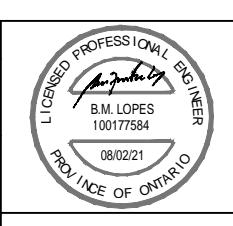

PROJECT 642 CONCESSION ST		SCALE 1 : 50	
TITLE CROSS SECTION		DATE AUGUST 2021	
JOB No. 36-319	FILE No. DA-19-176	DRAWING No. A04.01	

BEAM SCHEDULE:

- BM-1 W12X40 STEEL BEAM
- BM-2 W12X53 STEEL BEAM
- BM-3 W12X30 STEEL BEAM

FLOOR JOISTS SCHEDULE:

- FJ-1 11 7/8" S47 FLR. JSTS @12" O.C. W/ 3/4" OSB SUBFLOOR (GLUED-NAILED)
- FJ-2 14" TJI S47 JSTS @ 16" O.C.

COLUMN SCHEDULE:

- COL-1 W12X22 STEEL COLUMN W/ 10"x10"x 1/2" TOP PLATE WELDED TO COL. & 12"x12"x 1/2" BOTTOM PLATE WELDED TO COL. ANCHORED W/ 2- 1/2" DIA. X 12" LONG X 2" HOOK ANCHORS TO 60"x 60"x 20"(H) 20 MPa CONCRETE FOOTING ON UNDISTURBED SOIL.
- COL-2 W12X22 STEEL COLUMN W/ 10"x10"x 1/2" TOP PLATE WELDED TO COL. & 10"x10"x 1/2" BOTTOM PLATE WELDED TO COL.
- COL-3 W12X22 STEEL COLUMN W/ 8"x8"x 3/8" TOP PLATE WELDED TO COL. & 8"x8"x 3/8" BOTTOM PLATE WELDED TO COLUMN TO FOUND WALL W/ 2- 1/2" DIA. X 12" LONG X 2" HOOK ANCHORS
- COL-4 W12X22 STEEL COLUMN W/ 8"x8"x 3/8" TOP PLATE WELDED TO COL. & 8"x8"x 3/8" BOTTOM PLATE WELDED TO COLUMN

UNIT NUMBERING SCHEDULE				
Floor	Unit Number			
1	100			
2	200			
3	301	302	303	

(W) NEW RATED LOAD BEARING PARTITION WALL


- 1 HOUR FIRE RATED, WITH MIN. STC RATING 51, AS PER SB-3 W46
- 2 LAYERS 5/8" TYPE "X" GYP. WALL BRD. APPLIED TO RESILIENT MET. CHANNELS @ 16" O.C. INSIDE OF 2" X 4" OR 2"x6" MTL. STUDS @ 16" O.C. (48 GAUGE), ONE LAYER 5/8" TYPE "X" GYP. WALL BRD. ON THE OTHER SIDE OF STUDS C/W 5 1/2" SOUND ABSORPTIVE INSUL. TO U/S OF SUB-FLOOR ABOVE.

(C) NEW CEILING

- 1 HOUR FIRE RATED WITH STCS2 REFER TO ULC DESIGN NO. M501
- FILL JOIST CAVITY W/ SOUND PROOF INSUL. (SOUND TRANSMISSION TO CONFORM TO O.B.C. 9.11.21.) C/W 5/8" RESILIENT MTL. FURRING CHANNELS @ 16" O.C. PERPENDICULAR TO FLOOR JOISTS W/ 1/2" TYPE "X" GYP. WALL BRD. W/ PAINTED FINISH (TYP.)



LEGEND

- SMOKE ALARM
- CARBON MONOXIDE DETECTOR
- MECHANICAL VENTILATION
- HOSE BIB
- S.B. SOLID WOOD BEARING
- PL POINT LOAD
- EXIST'G WALL TO REMAIN
- F.D. FLOOR DRAIN
- AREA DRAIN

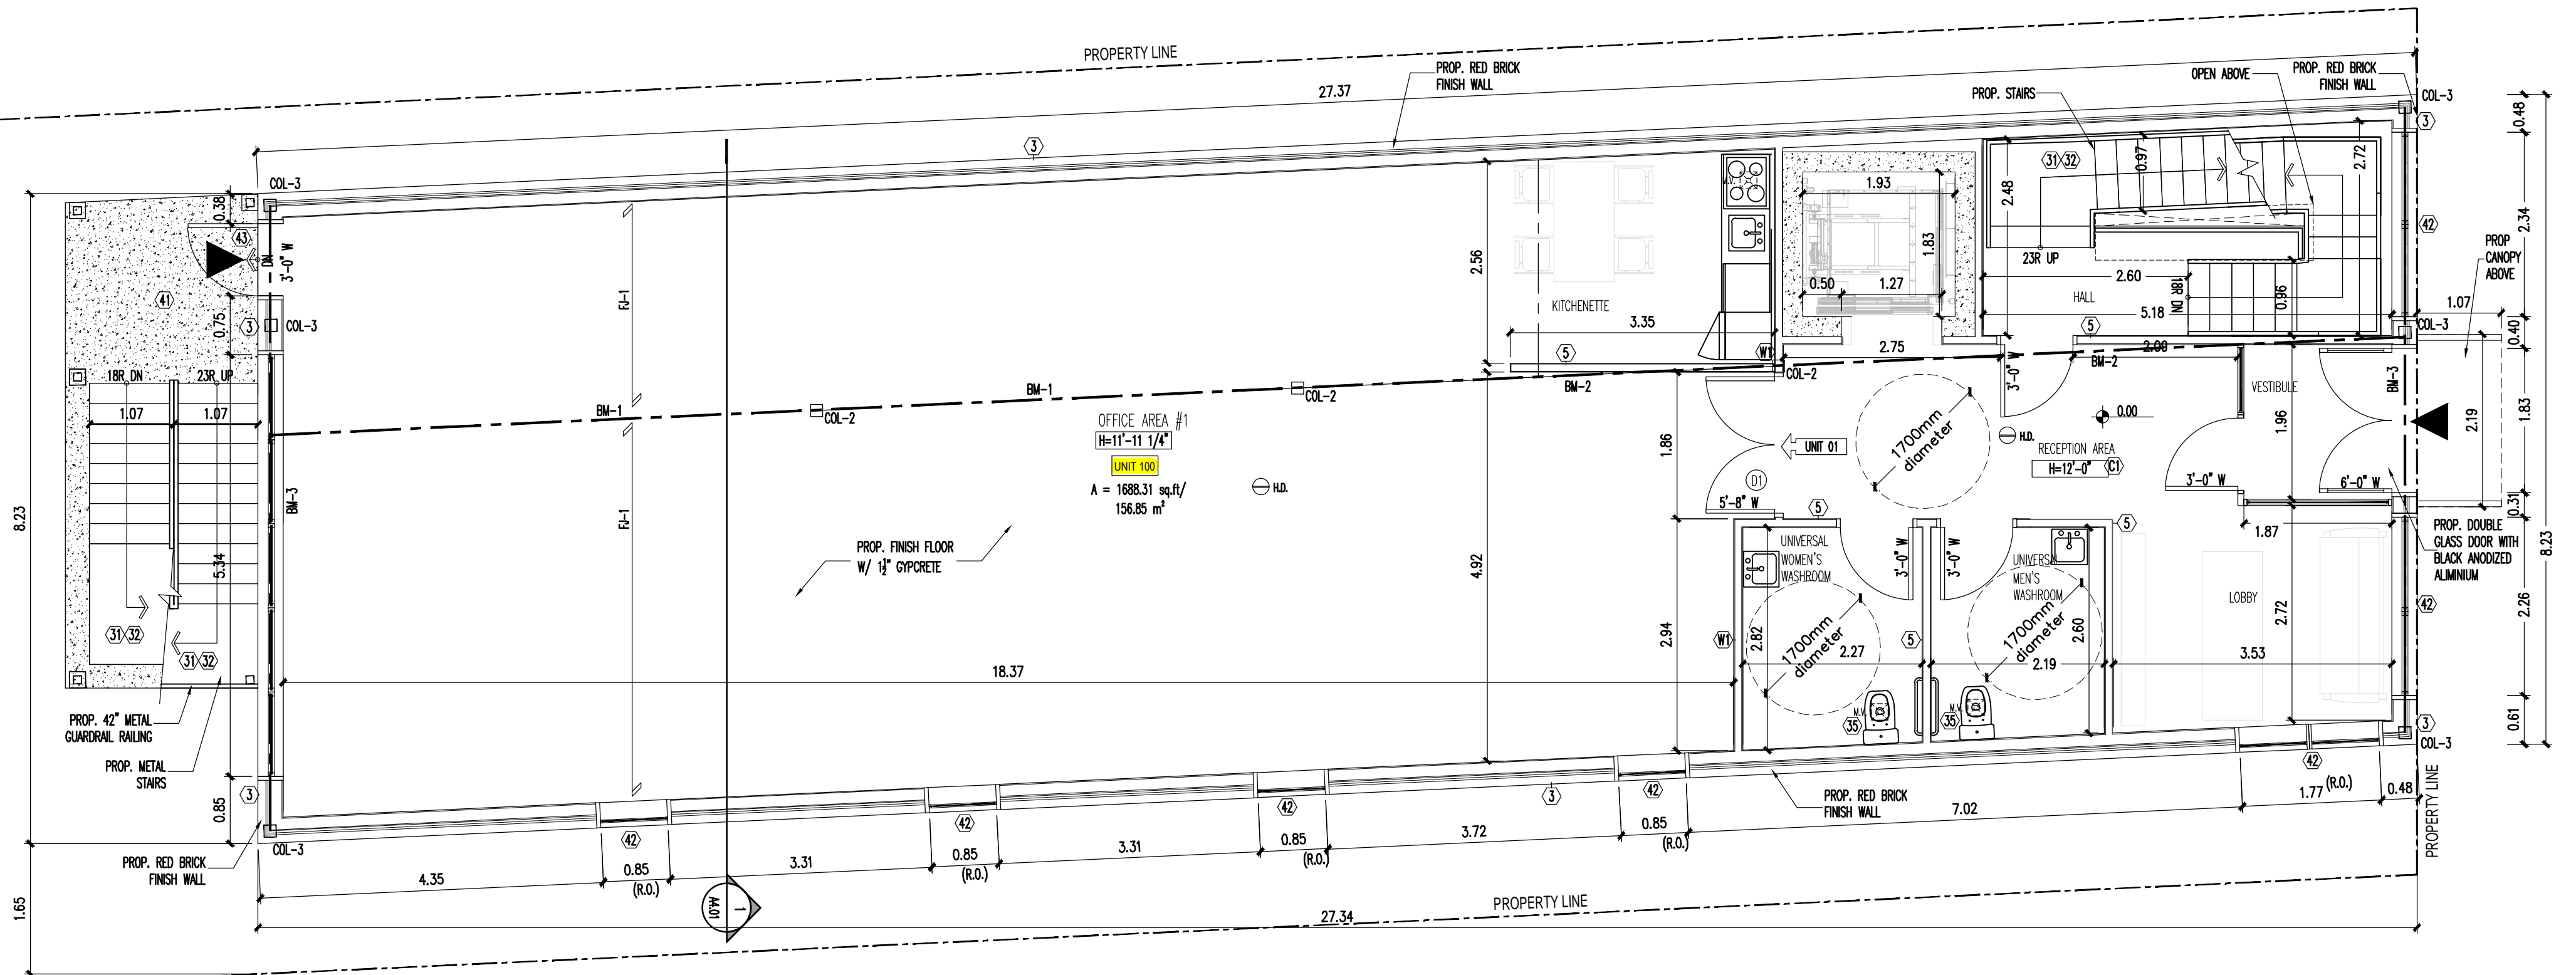

FIRST FLOOR PLAN
SCALE: 1:60

NO.	DESCRIPTION OF ISSUE	DATE	NO.	DESCRIPTION OF ISSUE	DATE
1	CITY COMMENTS REV01 SUBMISSION	02/22/2020	5	CITY COMMENTS REVIEW SUBMISSION	03/30/2021
2	CITY COMMENTS REV02 SUBMISSION	05/12/2020	6	CITY COMMENTS REVIEW SUBMISSION	08/02/2021
3	ISSUED FOR BUILDING PERMIT APPLICATION	08/11/2020	7		
4	REVIEWED FOR BUILDING PERMIT APPLICATION	08/28/2020	8		

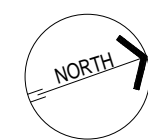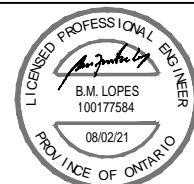

PROJECT 642 CONCESSION ST		SCALE 1 : 60	
TITLE FIRST FLOOR PLAN		DATE AUGUST 2021	
JOB No. 36-319	FILE No. DA-19-176	DRAWING No. A01.02	

BEAM SCHEDULE:

- BM-1 W12X40 STEEL BEAM
- BM-2 W12X53 STEEL BEAM
- BM-3 W12X30 STEEL BEAM

FLOOR JOISTS SCHEDULE:

- FJ-1 11 7/8" S47 FLR. JSTS @ 12" O.C. W/ 3/4" OSB SUBFLOOR (GLUED-NAILED)
- RJ-1 14" TJI S47 JSTS @ 16" O.C.

COLUMN SCHEDULE:

- COL-1 W12X22 STEEL COLUMN W/ 10"x10"x 1/2" TOP PLATE WELDED TO COL. & 12"x12"x 1/2" BOTTOM PLATE WELDED TO COL. ANCHORED W/ 2- 1/2" DIA. X 12" LONG X 2" HOOK ANCHORS TO 60"x 60"x 20"(H) 20 MPa CONCRETE FOOTING ON UNDISTURBED SOIL.
- COL-2 W12X22 STEEL COLUMN W/ 10"x10"x 1/2" TOP PLATE WELDED TO COL. & 10"x10"x 1/2" BOTTOM PLATE WELDED TO COL.
- COL-3 W12X22 STEEL COLUMN W/ 8"x8"x 3/8" TOP PLATE WELDED TO COL. & 8"x8"x 3/8" BOTTOM PLATE WELDED TO COLUMN TO FOUND WALL W/ 2- 1/2" DIA. X 12" LONG X 2" HOOK ANCHORS
- COL-4 W12X22 STEEL COLUMN W/ 8"x8"x 3/8" TOP PLATE WELDED TO COL. & 8"x8"x 3/8" BOTTOM PLATE WELDED TO COLUMN

(W) NEW RATED LOAD BEARING PARTITION WALL


1 HOUR FIRE RATED, WITH MIN. STC RATING 51, AS PER SB-3 W46
 2 LAYERS 5/8" TYPE "X" GYP. WALL BRD. APPLIED TO RESILIENT MET. CHANNELS @ 16" O.C. INSIDE OF 2" X 4" OR 2"x6" MTL STUDS @ 16" O.C., (48 GAUGE), ONE LAYER 5/8" TYPE "X" GYP. WALL BRD. ON THE OTHER SIDE OF STUDS C/W 5 1/2" SOUND ABSORPTIVE INSUL. TO U/S OF SUB-FLOOR ABOVE.

(C) NEW CEILING

1 HOUR FIRE RATED WITH STCS2 REFER TO ULC DESIGN NO. M501
 FILL JOIST CAVITY W/ SOUND PROOF INSUL. (SOUND TRANSMISSION TO CONFORM TO O.B.C. 9.11.21.) C/W 5/8" RESILIENT MTL. FURRING CHANNELS @ 16" O.C. PERPENDICULAR TO FLOOR JOISTS W/ 5/8" TYPE "X" GYP. WALL BRD. W/ PAINTED FINISH (TYP.)


LEGEND

- SA SMOKE ALARM
- C.M.D. CARBON MONOXIDE DETECTOR
- M.V. MECHANICAL VENTILATION
- HB HOSE BIB
- S.B. SOLID WOOD BEARING
- PL POINT LOAD
- EXIST'G WALL TO REMAIN
- F.D. FLOOR DRAIN
- A.D. AREA DRAIN

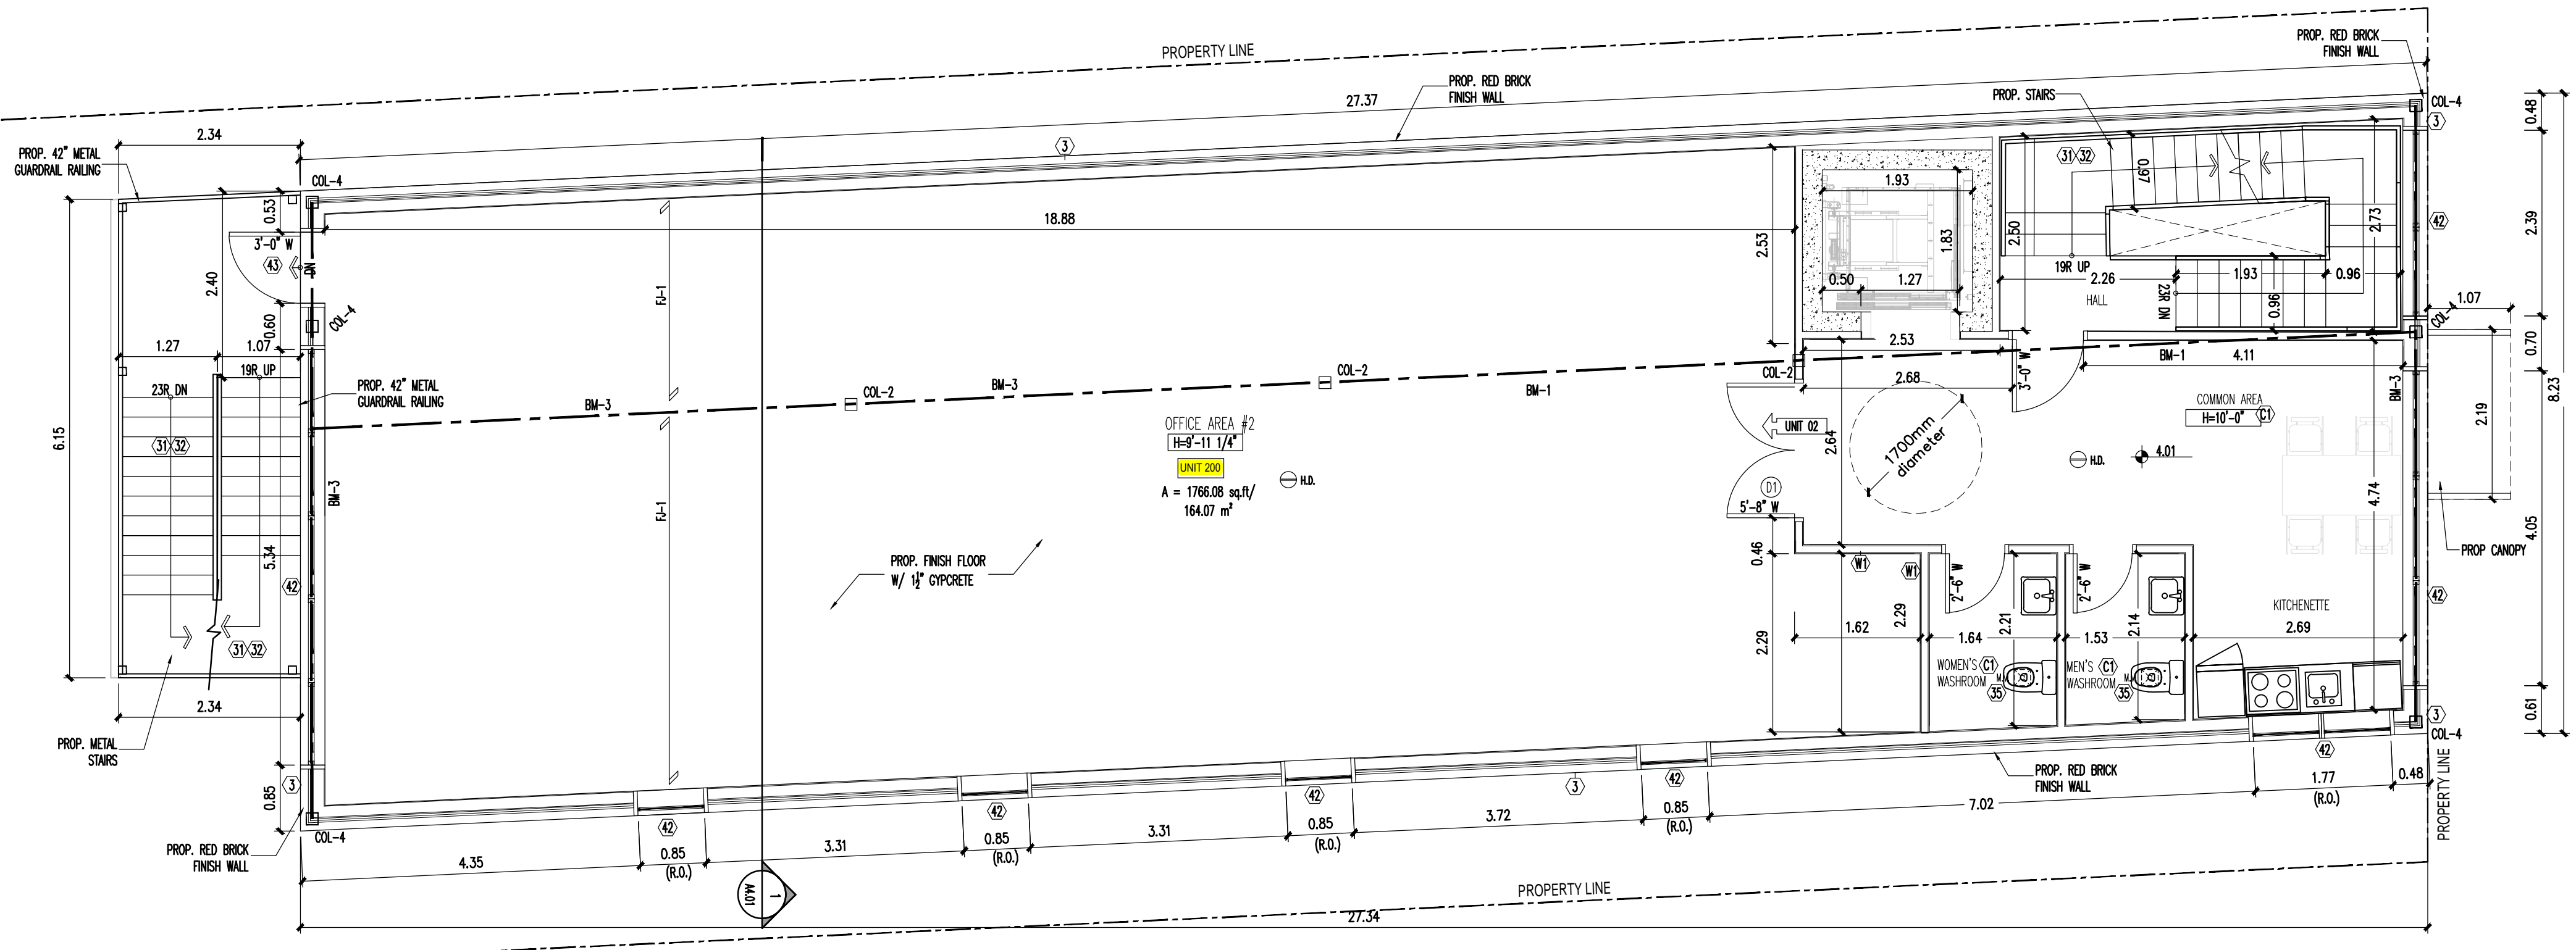

SECOND FLOOR PLAN
 SCALE: 1:60

NO.	DESCRIPTION OF ISSUE	DATE	NO.	DESCRIPTION OF ISSUE	DATE
1	CITY COMMENTS REV01 SUBMISSION	02/22/2020	5	CITY COMMENTS REVIEW SUBMISSION	03/30/2021
2	CITY COMMENTS REV02 SUBMISSION	05/12/2020	6	CITY COMMENTS REVIEW SUBMISSION	08/02/2021
3	ISSUED FOR BUILDING PERMIT APPLICATION	08/11/2020	7		
4	REVIEWED FOR BUILDING PERMIT APPLICATION	08/28/2020	8		

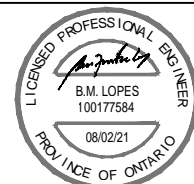

PROJECT 642 CONCESSION ST		SCALE 1 : 60	
TITLE SECOND FLOOR PLAN		DATE AUGUST 2021	
JOB No. 36-319	FILE No. DA-19-176	DRAWING No. A01.03	

BEAM SCHEDULE:

- BM-1 W12X40 STEEL BEAM
- BM-2 W12X53 STEEL BEAM
- BM-3 W12X30 STEEL BEAM

FLOOR JOISTS SCHEDULE:

- FJ-1 11 7/8" S47 FLR. JSTS @ 12" O.C. W/ 3/4" OSB SUBFLOOR (GLUED-NAILED)
- FJ-2 14" TJI S47 JSTS @ 16" O.C.

COLUMN SCHEDULE:

- COL-1 W12X22 STEEL COLUMN W/ 10"x10"x 1/2" TOP PLATE WELDED TO COL. & 12"x12"x 1/2" BOTTOM PLATE WELDED TO COL. ANCHORED W/ 2- 1/2" DIA. X 12" LONG X 2" HOOK ANCHORS TO 60" X 60" X 20"(H) 20 MPa CONCRETE FOOTING ON UNDISTURBED SOIL.
- COL-2 W12X22 STEEL COLUMN W/ 10"x10"x 1/2" TOP PLATE WELDED TO COL. & 10"x10"x 1/2" BOTTOM PLATE WELDED TO COL.
- COL-3 W12X22 STEEL COLUMN W/ 8"x8"x 3/8" TOP PLATE WELDED TO COL. & 8"x8"x 3/8" BOTTOM PLATE WELDED TO COLUMN TO FOUND WALL W/ 2- 1/2" DIA. X 12" LONG X 2" HOOK ANCHORS
- COL-4 W12X22 STEEL COLUMN W/ 8"x8"x 3/8" TOP PLATE WELDED TO COL. & 8"x8"x 3/8" BOTTOM PLATE WELDED TO COLUMN

(W) NEW RATED LOAD BEARING PARTITION WALL


- 1 HOUR FIRE RATED, WITH MIN. STC RATING 51, AS PER SB-3 W46
- 2 LAYERS 5/8" TYPE "X" GYP. WALL BRD. APPLIED TO RESILIENT MET. CHANNELS @ 16" O.C. INSIDE OF 2" X 4" OR 2"x6" MTL. STUDS @ 16" O.C. (48 GAUGE), ONE LAYER 5/8" TYPE "X" GYP. WALL BRD. ON THE OTHER SIDE OF STUDS C/W 5/8" SOUND ABSORPTIVE INSUL. TO U/S OF SUB-FLOOR ABOVE.

(C) NEW CEILING

- 1 HOUR FIRE RATED WITH STCS2 REFER TO ULC DESIGN NO. M501
- FILL JOIST CAVITY W/ SOUND PROOF INSUL. (SOUND TRANSMISSION TO CONFORM TO O.B.C. 9.11.21.) C/W 5/8" RESILIENT MTL. FURRING CHANNELS @ 16" O.C. PERPENDICULAR TO FLOOR JOISTS W/ 1/2" TYPE "X" GYP. WALL BRD. W/ PAINTED FINISH (TYP.)



LEGEND

- SA SMOKE ALARM
- C.M.D. CARBON MONOXIDE DETECTOR
- M.V. MECHANICAL VENTILATION
- HB HOSE BIB
- S.B. SOLID WOOD BEARING
- PL POINT LOAD
- EXIST'G WALL TO REMAIN
- F.D. FLOOR DRAIN
- A.D. AREA DRAIN

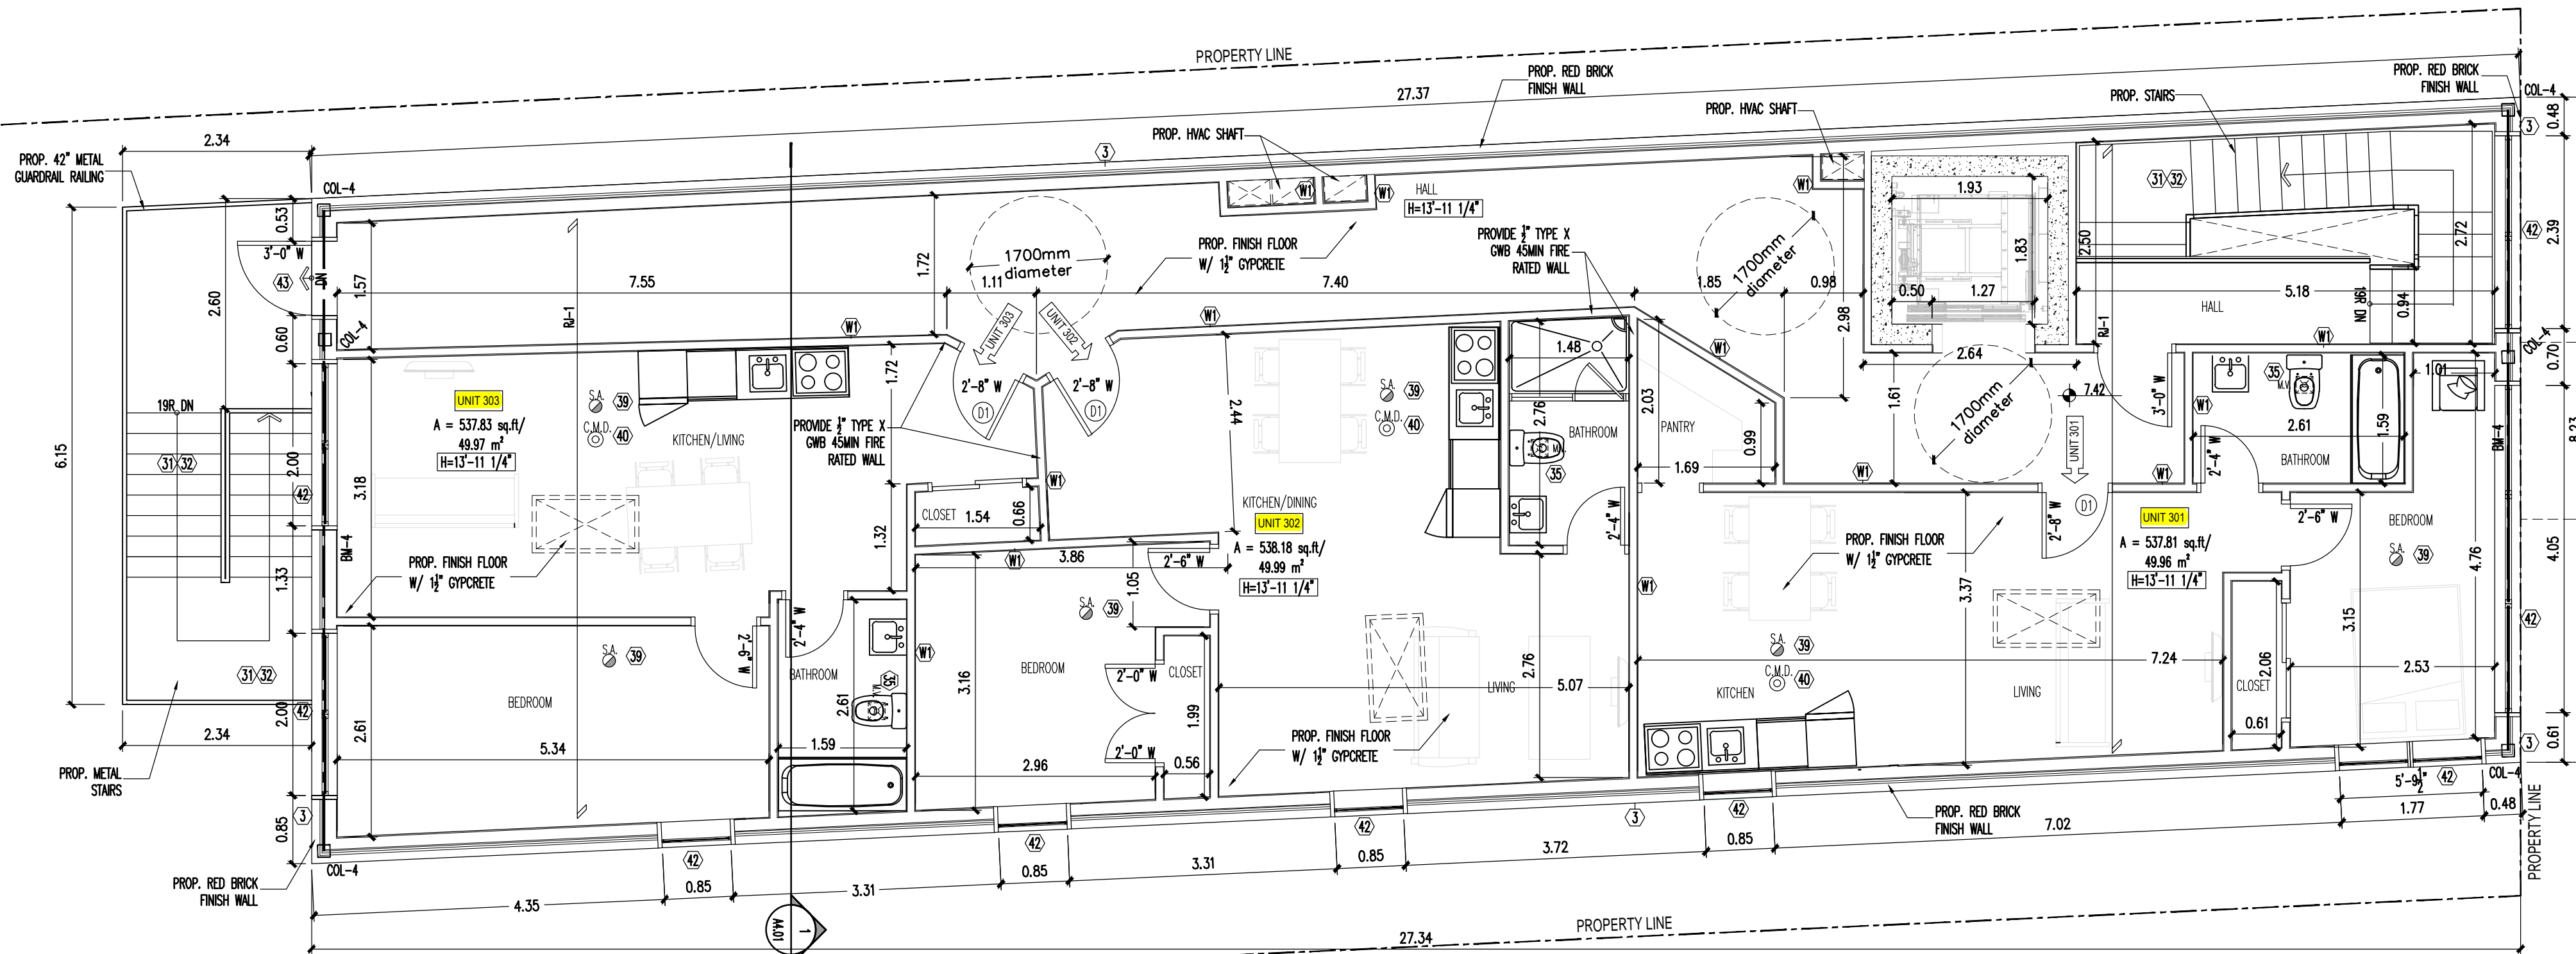

THIRD FLOOR PLAN
SCALE: 1:60

NO.	DESCRIPTION OF ISSUE	DATE	NO.	DESCRIPTION OF ISSUE	DATE
1	CITY COMMENTS REV01 SUBMISSION	02/22/2020	5	CITY COMMENTS REVIEW SUBMISSION	03/30/2021
2	CITY COMMENTS REV02 SUBMISSION	05/12/2020	6	CITY COMMENTS REVIEW SUBMISSION	08/02/2021
3	ISSUED FOR BUILDING PERMIT APPLICATION	08/11/2020	7		
4	REVIEWED FOR BUILDING PERMIT APPLICATION	08/28/2020	8		

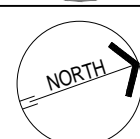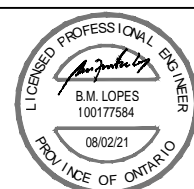

PROJECT 642 CONCESSION ST		SCALE 1 : 60	
TITLE THIRD FLOOR PLAN		DATE AUGUST 2021	
JOB No. 36-319	FILE No. DA-19-176	DRAWING No. A01.04	



Hamilton

Committee of Adjustment

City Hall, 5th Floor,
71 Main St. W.,
Hamilton, ON L8P4Y5

Phone: (905) 546-2424 ext. 4221
Email: cofa@hamilton.ca

APPLICATION FOR A MINOR VARIANCE

FOR OFFICE USE ONLY.

APPLICATION NO. _____ **DATE APPLICATION RECEIVED** _____

PAID _____ **DATE APPLICATION DEEMED COMPLETE** _____

SECRETARY'S SIGNATURE _____

The Planning Act

Application for Minor Variance or for Permission

The undersigned hereby applies to the Committee of Adjustment for the City of Hamilton under Section 45 of the *Planning Act*, R.S.O. 1990, Chapter P.13 for relief, as described in this application, from the Zoning By-law.

1, 2

Registered Owners(s)

Applicant(s)*

Agent or Solicitor



Note: Unless otherwise requested all communications will be sent to the agent, if any.

3. Names and addresses of any mortgagees, holders of charges or other encumbrances:
None

Additional sheets can be submitted if there is not sufficient room to answer the following questions. Additional sheets must be clearly labelled

4. Nature and extent of relief applied for:

Parking- 1) To permit a total of 0 parking spaces for the proposed commercial units, whereas a minimum 14 parking spaces are required.

2) To permit 0 barrier free parking spaces, whereas one barrier free parking space is required

Secondary Dwelling Unit Reconstruction of Existing Dwelling

5. Why it is not possible to comply with the provisions of the By-law?

Space restrictions. The size of the lot does not allow us to create the required amount of parking spaces.

6. Legal description and Address of subject lands (registered plan number and lot number or other legal description and where applicable, **street and street number**):

642 Concession street.

LT 2, PL700, S/T & T/W AB287892; HAMILTON

7. PREVIOUS USE OF PROPERTY

Residential Industrial Commercial

Agricultural Vacant Other

Other _____

8.1 If Industrial or Commercial, specify use (Previously)Commercial/Restaurant-- (Prop

8.2 Has the grading of the subject land been changed by adding earth or other material, i.e. has filling occurred?

Yes No Unknown

8.3 Has a gas station been located on the subject land or adjacent lands at any time?

Yes No Unknown

8.4 Has there been petroleum or other fuel stored on the subject land or adjacent lands?

Yes No Unknown

8.5 Are there or have there ever been underground storage tanks or buried waste on the subject land or adjacent lands?

Yes No Unknown

8.6 Have the lands or adjacent lands ever been used as an agricultural operation where cyanide products may have been used as pesticides and/or sewage sludge was applied to the lands?

Yes No Unknown

8.7 Have the lands or adjacent lands ever been used as a weapon firing range?

Yes No Unknown

8.8 Is the nearest boundary line of the application within 500 metres (1,640 feet) of the fill area of an operational/non-operational landfill or dump?

Yes No Unknown

8.9 If there are existing or previously existing buildings, are there any building materials remaining on site which are potentially hazardous to public health (eg. asbestos, PCB's)?

Yes No Unknown

8.10 Is there any reason to believe the subject land may have been contaminated by former uses on the site or adjacent sites?

Yes No Unknown

8.11 What information did you use to determine the answers to 8.1 to 8.10 above?

A Search in Land registry

8.12 If previous use of property is industrial or commercial or if YES to any of 8.2 to 8.10, a previous use inventory showing all former uses of the subject land, or if appropriate, the land adjacent to the subject land, is needed.

Is the previous use inventory attached? Yes No

9. ACKNOWLEDGEMENT CLAUSE

I acknowledge that the City of Hamilton is not responsible for the identification and remediation of contamination on the property which is the subject of this Application – by reason of its approval to this Application.

4 October 2021
Date


Signature Property Owner(s)

Reisha Dass
Print Name of Owner(s)

10. Dimensions of lands affected:

Frontage	10.9m
Depth	33,5m
Area	400.1m2
Width of street	

11. Particulars of all buildings and structures on or proposed for the subject lands: (Specify ground floor area, gross floor area, number of stories, width, length, height, etc.)

Existing: _

1 1/2 story residential building that was completely damaged in a fire, years ago.

Proposed

we propose a 3 story, mixed use building, that consists of 2 stories (ground+ 2nd floor) of shared commercial space and the upper floor (3rd floor) of modern residential space consisting of 3x 1 bedroom units.

12. Location of all buildings and structures on or proposed for the subject lands; (Specify distance from side, rear and front lot lines)

Existing:

North Front: 0m
East: 2.39m
West: 0.75m
South Rear: 8.99m

Proposed:

North Front: 0m
East: 1.65m
West: 1.09m
South Rear: 8.99m

13. Date of acquisition of subject lands:
November 8th 2018
-
14. Date of construction of all buildings and structures on subject lands:
ASAP
-
15. Existing uses of the subject property (single family, duplex, retail, factory etc.):
Currently the building is severely fire damaged and vacant. It was previously use
16. Existing uses of abutting properties (single family, duplex, retail, factory etc.):
Both adjoining buildings on each side are used as doctors/medical offices
17. Length of time the existing uses of the subject property have continued:
18. Municipal services available: (check the appropriate space or spaces)
- | | | | |
|----------------|-------------------------------------|-----------|-------------------------------------|
| Water | <input checked="" type="checkbox"/> | Connected | <input checked="" type="checkbox"/> |
| Sanitary Sewer | <input checked="" type="checkbox"/> | Connected | <input checked="" type="checkbox"/> |
| Storm Sewers | <input checked="" type="checkbox"/> | | |
19. Present Official Plan/Secondary Plan provisions applying to the land:
20. Present Restricted Area By-law (Zoning By-law) provisions applying to the land:
Zoning By-law 05-200 & 6593
21. Has the owner previously applied for relief in respect of the subject property?
Yes No
If the answer is yes, describe briefly.
22. Is the subject property the subject of a current application for consent under Section 53 of the *Planning Act*?
Yes No
23. Additional Information
24. The applicant shall attach to each copy of this application a plan showing the dimensions of the subject lands and of all abutting lands and showing the location, size and type of all buildings and structures on the subject and abutting lands, and where required by the Committee of Adjustment such plan shall be signed by an Ontario Land Surveyor.