### **COMMITTEE OF ADJUSTMENT**



City Hall, 5<sup>th</sup> floor, 71 Main Street West, Hamilton, ON L8P 4Y5 Telephone (905) 546-2424, ext. 4221, 3935 Fax (905) 546-4202

E-mail: cofa@hamilton.ca

# NOTICE OF PUBLIC HEARING Minor Variance

### You are receiving this notice because you are either:

- Assessed owner of a property located within 60 metres of the subject property
- Applicant/agent on file, or
- Person likely to be interested in this application

APPLICATION NO.: HM/A-21:437

**APPLICANTS:** Agent Batory Planning & Development c/o C. Langley

Owners J. & J. Franczuz

SUBJECT PROPERTY: Municipal address 237 Broadway Ave., Hamilton

**ZONING BY-LAW:** Zoning By-law 6593, as Amended 95-02, 95-33 & 80-274

**ZONING:** "C/S-1335 and S-1335a & S-720" (Urban Protected

Residential) district

**PROPOSAL:** To permit the construction of a 2nd full storey addition above the

existing single-family dwelling and a proposed 2 storey addition to the rear and exterior side yard of the existing Single-family dwelling and to convert the proposed 2 storey addition into a secondary dwelling

unit notwithstanding that;

- 1. A maximum height of 10.2 m shall be provided instead of the maximum permitted of 9.0 m as required per amending By-Law 95-02; and
- 2. A maximum Gross Floor Area of 379.0 m² shall be provided on site instead of the maximum permitted gross floor area of 233.05 m² permitted per amending By-Law 95-02; and
- 3. A minimum parking space size of 2.6 m in width x 5.5 m in length shall be provided instead of the minimum parking space size required of 2.7 m x 6.0 m; and

Notes: An eave or gutter may project into a required side yard not more than one-half of its width, or 1.0 metres, whichever is lesser. No details have been provided; therefore, further variances may be required.

An Encroachment Agreement with the Public Works Department may be required for existing frame shed and board fence shown to encroach on the Road Allowance (Willowcrest Avenue). For further information, please contact encroachment@hamilton.ca

This application will be heard by the Committee as shown below:

DATE: Thursday, February 3rd, 2022

TIME: 2:20 p.m.

PLACE: Via video link or call in (see attached sheet for details)

To be streamed at

www.hamilton.ca/committeeofadjustment

for viewing purposes only

HM/A-21: 437 Page 2

### **PUBLIC INPUT**

**Written:** If you would like to submit written comments to the Committee of Adjustment you may do so via email or hardcopy. Please see attached page for complete instructions, including deadlines for submitting to be seen by the Committee.

**Orally:** If you would like to speak to this item at the hearing you may do so via video link or by calling in. Please see attached page for complete instructions, including deadlines for registering to participate.

### **MORE INFORMATION**

For more information on this matter, including access to drawings illustrating this request:

- Visit www.hamilton.ca/committeeofadjustment
- Call 905-546-CITY (2489) or 905-546-2424 extension 4221, 4130, or 3935
- Email Committee of Adjustment staff at <a href="cofa@hamilton.ca">cofa@hamilton.ca</a>

DATED: January 18th, 2021.

Jamila Sheffield, Secretary-Treasurer Committee of Adjustment

Information respecting this application is being collected under the authority of the Planning Act, R.S.O., 1990, c. P. 13. All comments and opinions submitted to the City of Hamilton on this matter, including the name, address, and contact information of persons submitting comments and/or opinions, will become part of the public record and will be made available to the Applicant and the general public.

# DETACHED RENOVATION WITH NEW SECONDARY SUITE ADDITION

237 BROADWAY AVENUE

HAMILTON, ONT. L8S 2H9






PROPOSED FRONT

PROPOSED LEFT SIDE



EXISTING FRONT

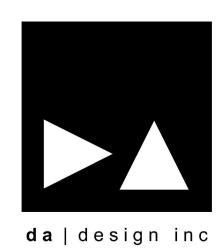

OWNER(S): JUSTIN & JOHN FRANCZUZ DECEMBER 2021



EXISTING REAR

# DETACHED RENOVATION WITH NEW SECONDARY SUITE ADDITION

237 BROADWAY AVENUE

HAMILTON, ONT. L8S 2H9










OWNER(S): JUSTIN & JOHN FRANCZUZ

DECEMBER 2021

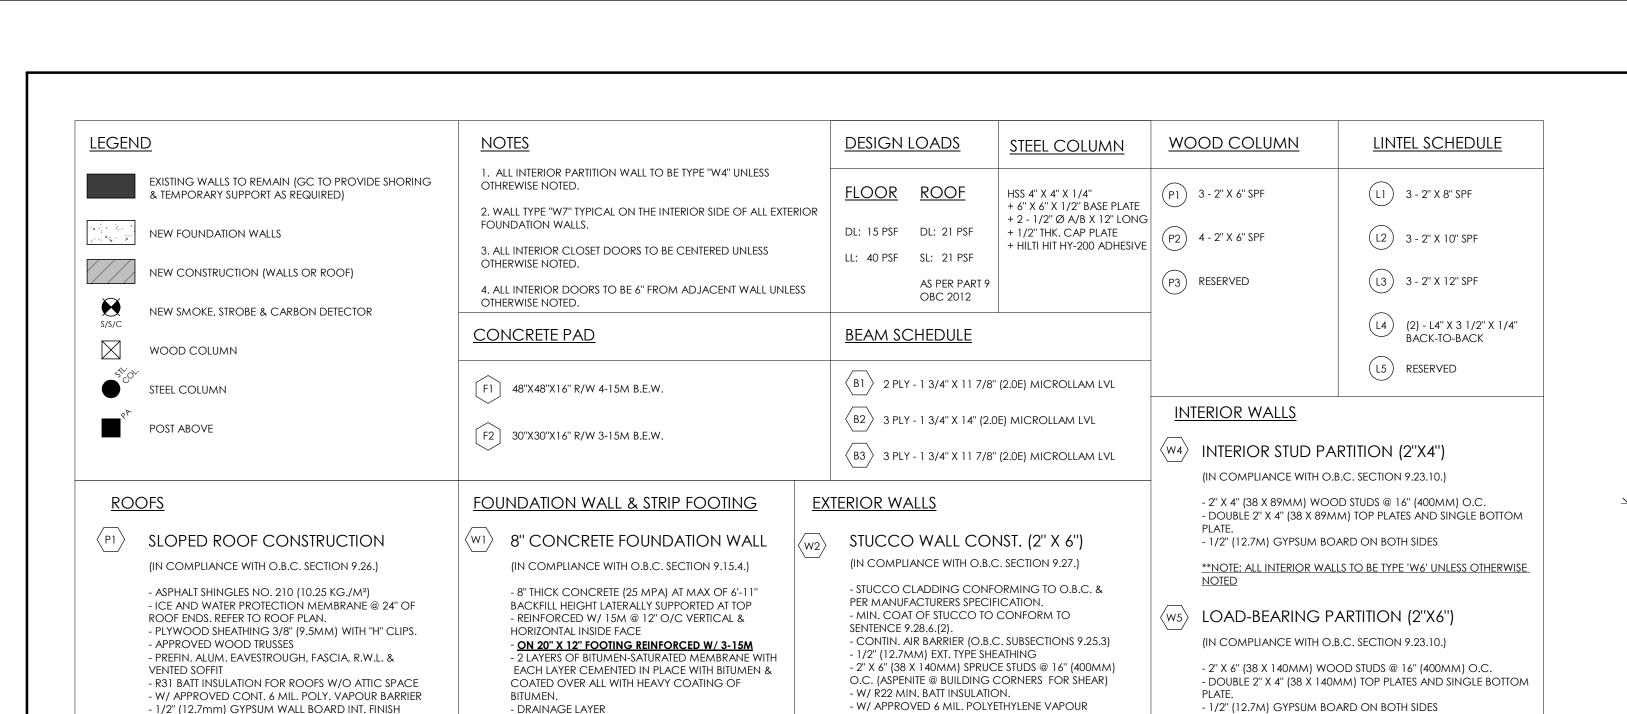

BARRIER (O.B.C. SUBSECTIONS 9.25.3 / 9.25.4)

- ATTACHMENT SHALL CONFORM TO O.B.C.

(IN COMPLIANCE WITH O.B.C. SECTION 9.27.)

- ON 1/2" VERTICAL STRAPPING (1/2" AIR SPACE)

- 1/2" (12.7MM) EXT. TYPE SHEATHING

- WITH R22 MIN. BATT INSULATION.

- CONTIN. AIR BARRIER (O.B.C. SUBSECTIONS 9.25.3)

- 2" X 6" (38 X 140MM) SPRUCE STUDS @ 16" (400MM)

O.C. (ASPENITE @ BUILDING CORNERS FOR SHEAR)

- WITH APPROVED 6 MIL. POLYETHYLENE VAPOUR

- 1/2" (12.7MM) GYPSUM WALL BOARD INT. FINISH.

BARRIER (O.B.C. SUBSECTIONS 9.25.3 / 9.25.4).

- ATTACHMENT SHALL CONFORM TO O.B.C.

SENTENCE 9.23.16.3(1)

- SIDING AS PER ELEVATION

SENTENCE 9.23.16.3(1)

- 1/2" (12.7mm) GYPSUM WALL BOARD INT. FINISH

SIDING WALL CONSTRUCTION (2" X 6")

(W6) INSULTED INTERIOR STUD PARTITION (2"X4")

- MIN R22 (RSI 3.52) SPRAY-FOAM INSULATION

WARM SIDE (O.B.C. SUBSECTIONS 9.25.3 / 9.25.4).

- 1/2" (12.7M) GYPSUM BOARD ON INTERIOR SIDE

\*\*NOTE: TYPICAL IN EXISTING EXTERIOR WALLS

 $\langle w_7 \rangle$  1-HR FIRE RATED PARTY WALL CONST.

- 1" AIR SPACE W/ DOUBLE LAYER OF 1/2" GYP TO

RESTRAIN INSULATION FROM FALLING OUT (REFER TO

(IN COMPLIANCE WITH O.B.C. SECTION 9.27.)

(BASEMENT & GROUND)

- 5/8" TYPE 'X' GYPSUM BOARD

- 2X4 WOOD STUDS @24" O.C.

- 2X4 WOOD STUDS @24" O.C.

5/8" TYPE 'X' GYPSUM BOARD

- R12 BATT INSULATION

- 2" X 4" (38 X 89MM) WOOD STUDS @ 16" (400MM) O.C.

- DOUBLE 2" X 4" (38 X 89MM) TOP PLATES AND SINGLE BOTTOM

- WITH APPROVED 6 MIL. POLYETHYLENE VAPOUR BARRIER ON THE

- 1/2" (12.7mm) GYPSUM WALL BOARD INT. FINISH

BASEMENT (SLAB ON GRADE)

- 6 MIL. POLYETHYLENE VAOUR BARRIER

- 4" (75MM) CONCRETE SLAB

SLAB AND FOOTING.

(IN COMPLIANCE WITH O.B.C. SUBSECTION 9.16.4.)

- 2" (50MM) RIGID INSULATION TO MIN R10 (RSI 1.76)

- 4" (100MM) OF COURSE GRANULAR MATERIAL

- PROVIDED BOND BREAKING MATERIAL BETWEEN

SHALL CONFIRM TO O.B.C. ARTICLE 9.13.3.6.

CONFORM TO O.B.C. ARTICLE 9.13.4.2.

- WHERE SLAB IS REQUIRED TO BE WATERPROOFED, IT

- SOIL GAS CONTROL, THE SLAB CONSTRUCTION SHALL

WITH 50% AT EAVES

<u>FLOORS</u>

- ATTIC VENTILATION 1:300 OF INSULATED CEILING AREA

- DRAINAGE LAYER

 $\langle F2 \rangle$  CONCRETE PORCH SLAB

 $\langle F3 \rangle$  WOOD FLOOR ASSEMBLY

O.B.C. SUBSECTION 9.30.6.

- 4" (100MM) DIA. WEEPING TILE, 6" (150MM)

- 6" THICK 32 MPA CLASS C2 CONCRETE SLAB

(IN COMPLIANCE WITH O.B.C. SUBSECTION 9.23.14.)

- MIN. 3/4" (19MM) T & G OSB (0-1 GRADE) AND/OR

- FOR CERAMIC TILE FLOOR, JOISTS TO BE INSTALLED @

12" (300MM) O.C. WITH PANEL - TYPE UNDERLAY SHALL

CONFORM TO (O.B.C. ARTICLES 9.30.2.1., 9.30.2.3. &

- CERAMIC TILES APPLIED TO MORTAR BED REFER TO

- 5/8" (15.9MM) TYPE 'X' GYPSUM BOARD

WAFERBOARD (R1 GRADE) GLUED & SCREWED

- REFER TO FLOOR PLANS FOR FLOOR JOIST SIZES.


- R/W 10M @ 12" O/C BOTTOM EACH WAY

CRUSHED STONE OVER AND AROUND WEEPING TILE.

34' - 8 1/2" (10.58 m) ALL EXISTING WINDOWS AND DOORS TO BE REMOVED AND DISPOSED OF -EXISITING SOLARIUM REMOVE AND DISPOSE OF ALL EXISTING OVERHEAD TO BE REMOVED AND DISPOSED OF FOUNDATIONS, FOOTINGS AND INTERIOR WALLS AS SHOWN EXISTING WINDOW TO BE -EXISTING DOOR TO BE REMOVED AND FILLED-IN REMOVED AND FILLED-IN 11' - 2" 4' - 4" 2' - 10" 13' - 5'' EXISTING WINDOW REMOVED - AND OPENING ENLARGED FOR NEW WINDOW \_ \_\_ \_ \_ \_ \_ \_ - + - - - - - - - - - - - - - - -· — — — — \_ \_ \_ 5' - 8" 8' - 6'' 10' - 8" 7' - 7 1/2" **BEDROOM 4** STORAGE L₹H — → ⊨ = |= UNEXÇAVATED <u>UP 12R</u>  $\vdash$  - - -BUILT-IN CLOSET L \_ \_ \_ \_ \_ \_ \_ \_ \_ \_ \_ \_ L — — — — — — — EXISTING BLOCKS TO BE REMOVED AND DISPOSED OF LAUNDRY 12'4" x 10'7" EXISTING WINDOW TO BE 12' - 4" 3' - 10'' REMOVED AND FILLED-IN — UNEX©AVATED **OPENINGS FOR** PROPOSED L -/ - - - \ -WINDOWS eq ----\_ \_′ \_\_ \_ \_ \_ \_ \_ \_ `\_ -10' - 11 1/2" 5' - 7 1/2'' 5' - 0'' 3' - 6"

> PROPOSED BASEMENT FLOOR 102 SM (45 SM SIDE A, 57 SM SIDE B)

@12" O.C. B.E.W.

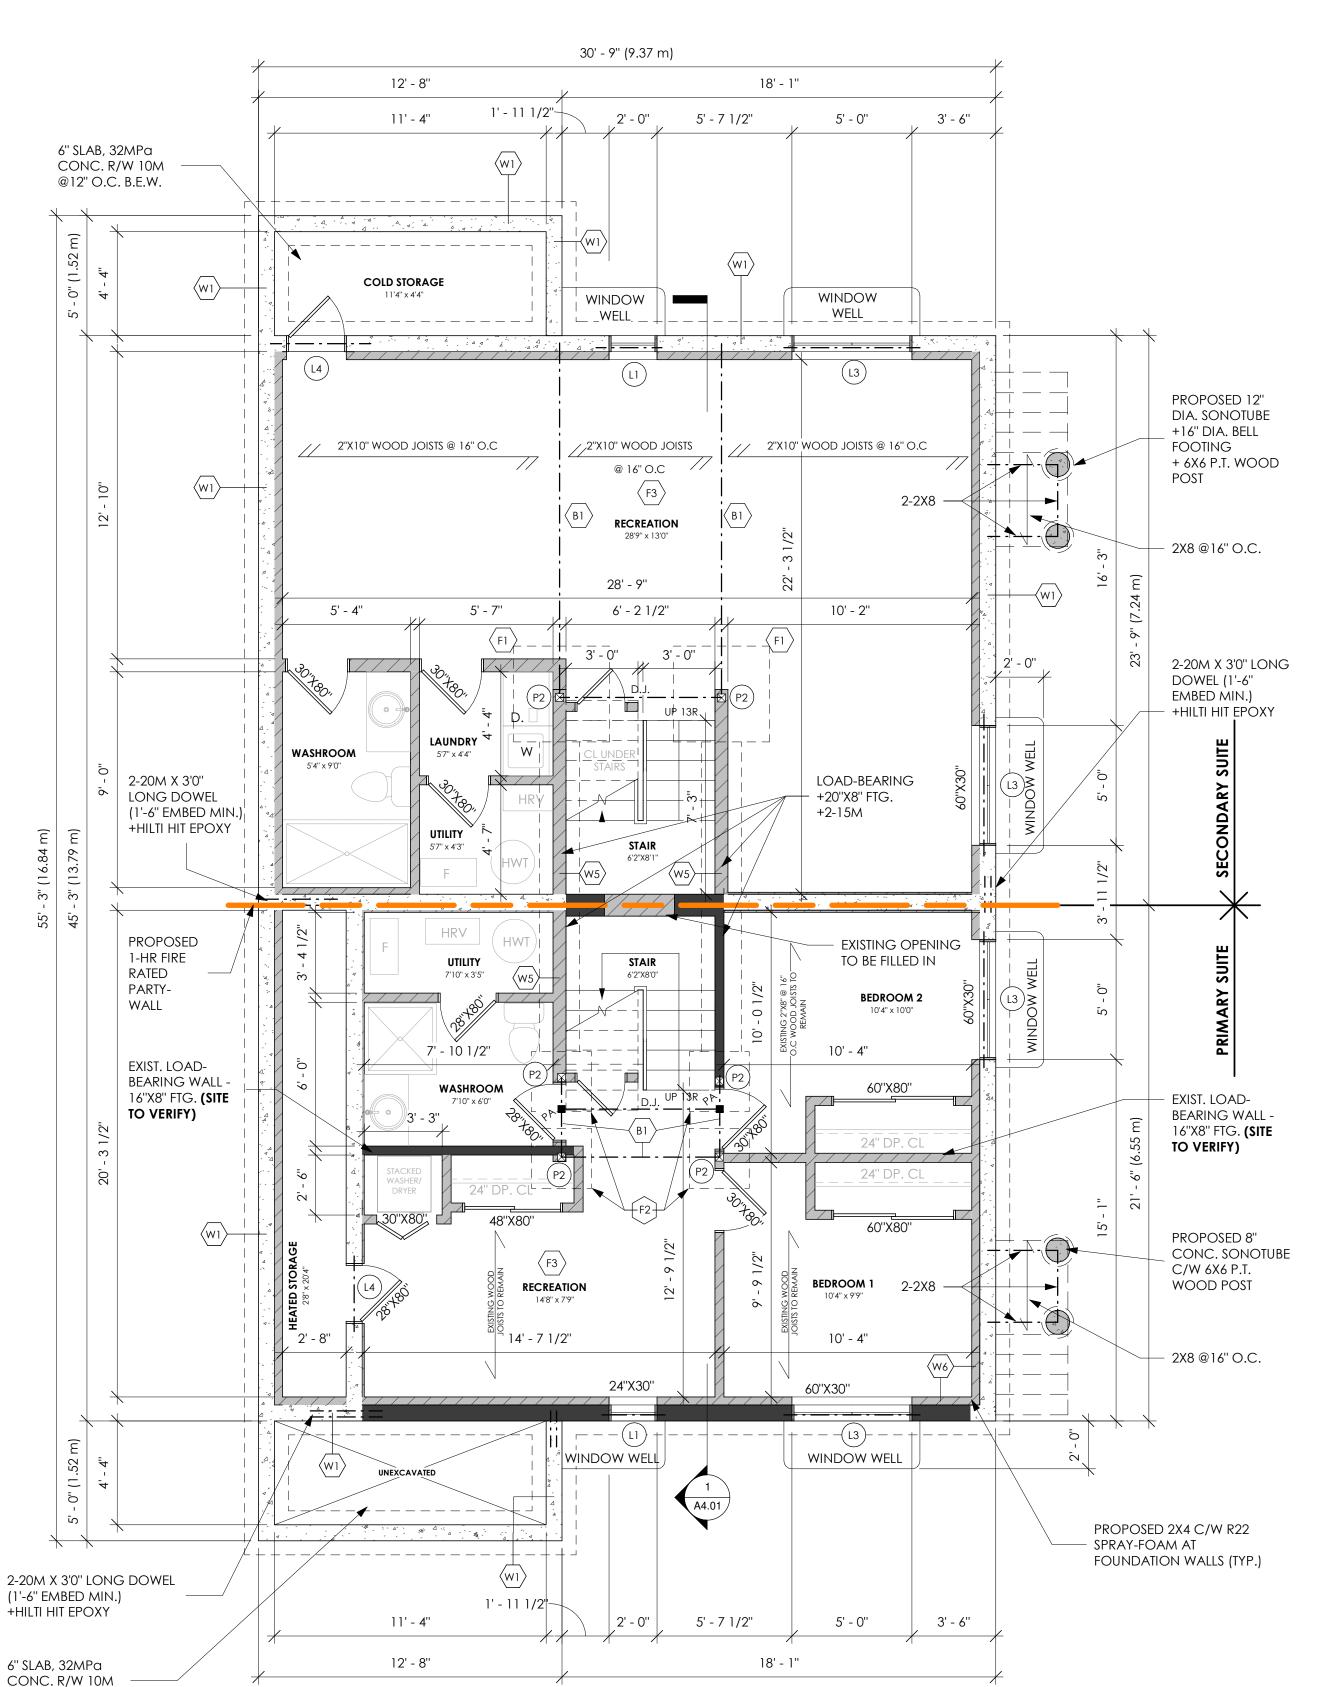

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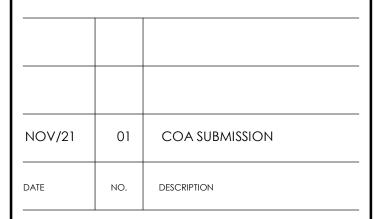
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- THE CONTRACTOR MUST VERIFY THAT ALL CONSTRUCTION IS IN COMPLIANCE WITH THE NATIONAL BUILDING CODE, THE ONTARIO BUIDLING CODE, LOCAL ZONING REQUIREMENTS, AND ANY OTHER GOVERNING AUTHORITIES.

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COMMENCEMENT OF CONSTRUCTION.

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da design inc. 1470 Hurontario Street Lower Suite Mississauga, Ontario L5G 3H4 647 242 0164

dan@dadesigninc.ca

da | design inc

CONSULTANT'S STAME ONTARIO ASSOCIATION OF ARCHITECTS LICENSED TECHNOLOGIST DRAGAN ACIMOVIC

STRUCTURAL CONSULTANT: PIVOT ENGINEERING INC.

HVAC CONSULTANT:

FARAZ FARZAM 201 MILLWAY AVE. - UNIT 10 CONCORD, ON L4K 5K8 TEL.: 416-858-3648 FARAZ@PIVOTENGINEERING.CA

OWNER CONTACT INFORMATION: JUSTIN FRANCZUZ & JOHN FRANCZUZ

E: jdfranczuz@gmail.com & john.franczuz@gmail.com

**REAR ADDITION FOR DUPLEX** 

**CONVERSION** 237 BROADWAY AVENUE HAMILTON, ONT. L8S 2H9

PROJECT NO. 2021-04-21 DRAWN BY CB/GC

**BASEMENT FLOOR** 

SCALE

DA


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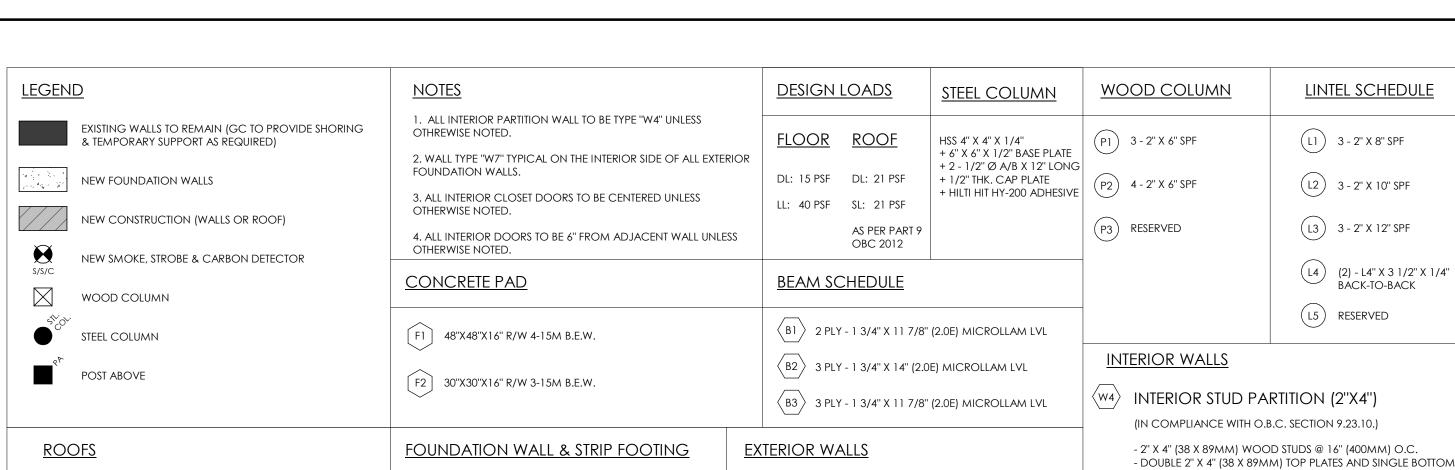
REVIEWED BY

DRAWING NO.

EXISTING BASEMENT FLOOR

1/4'' = 1'-0''



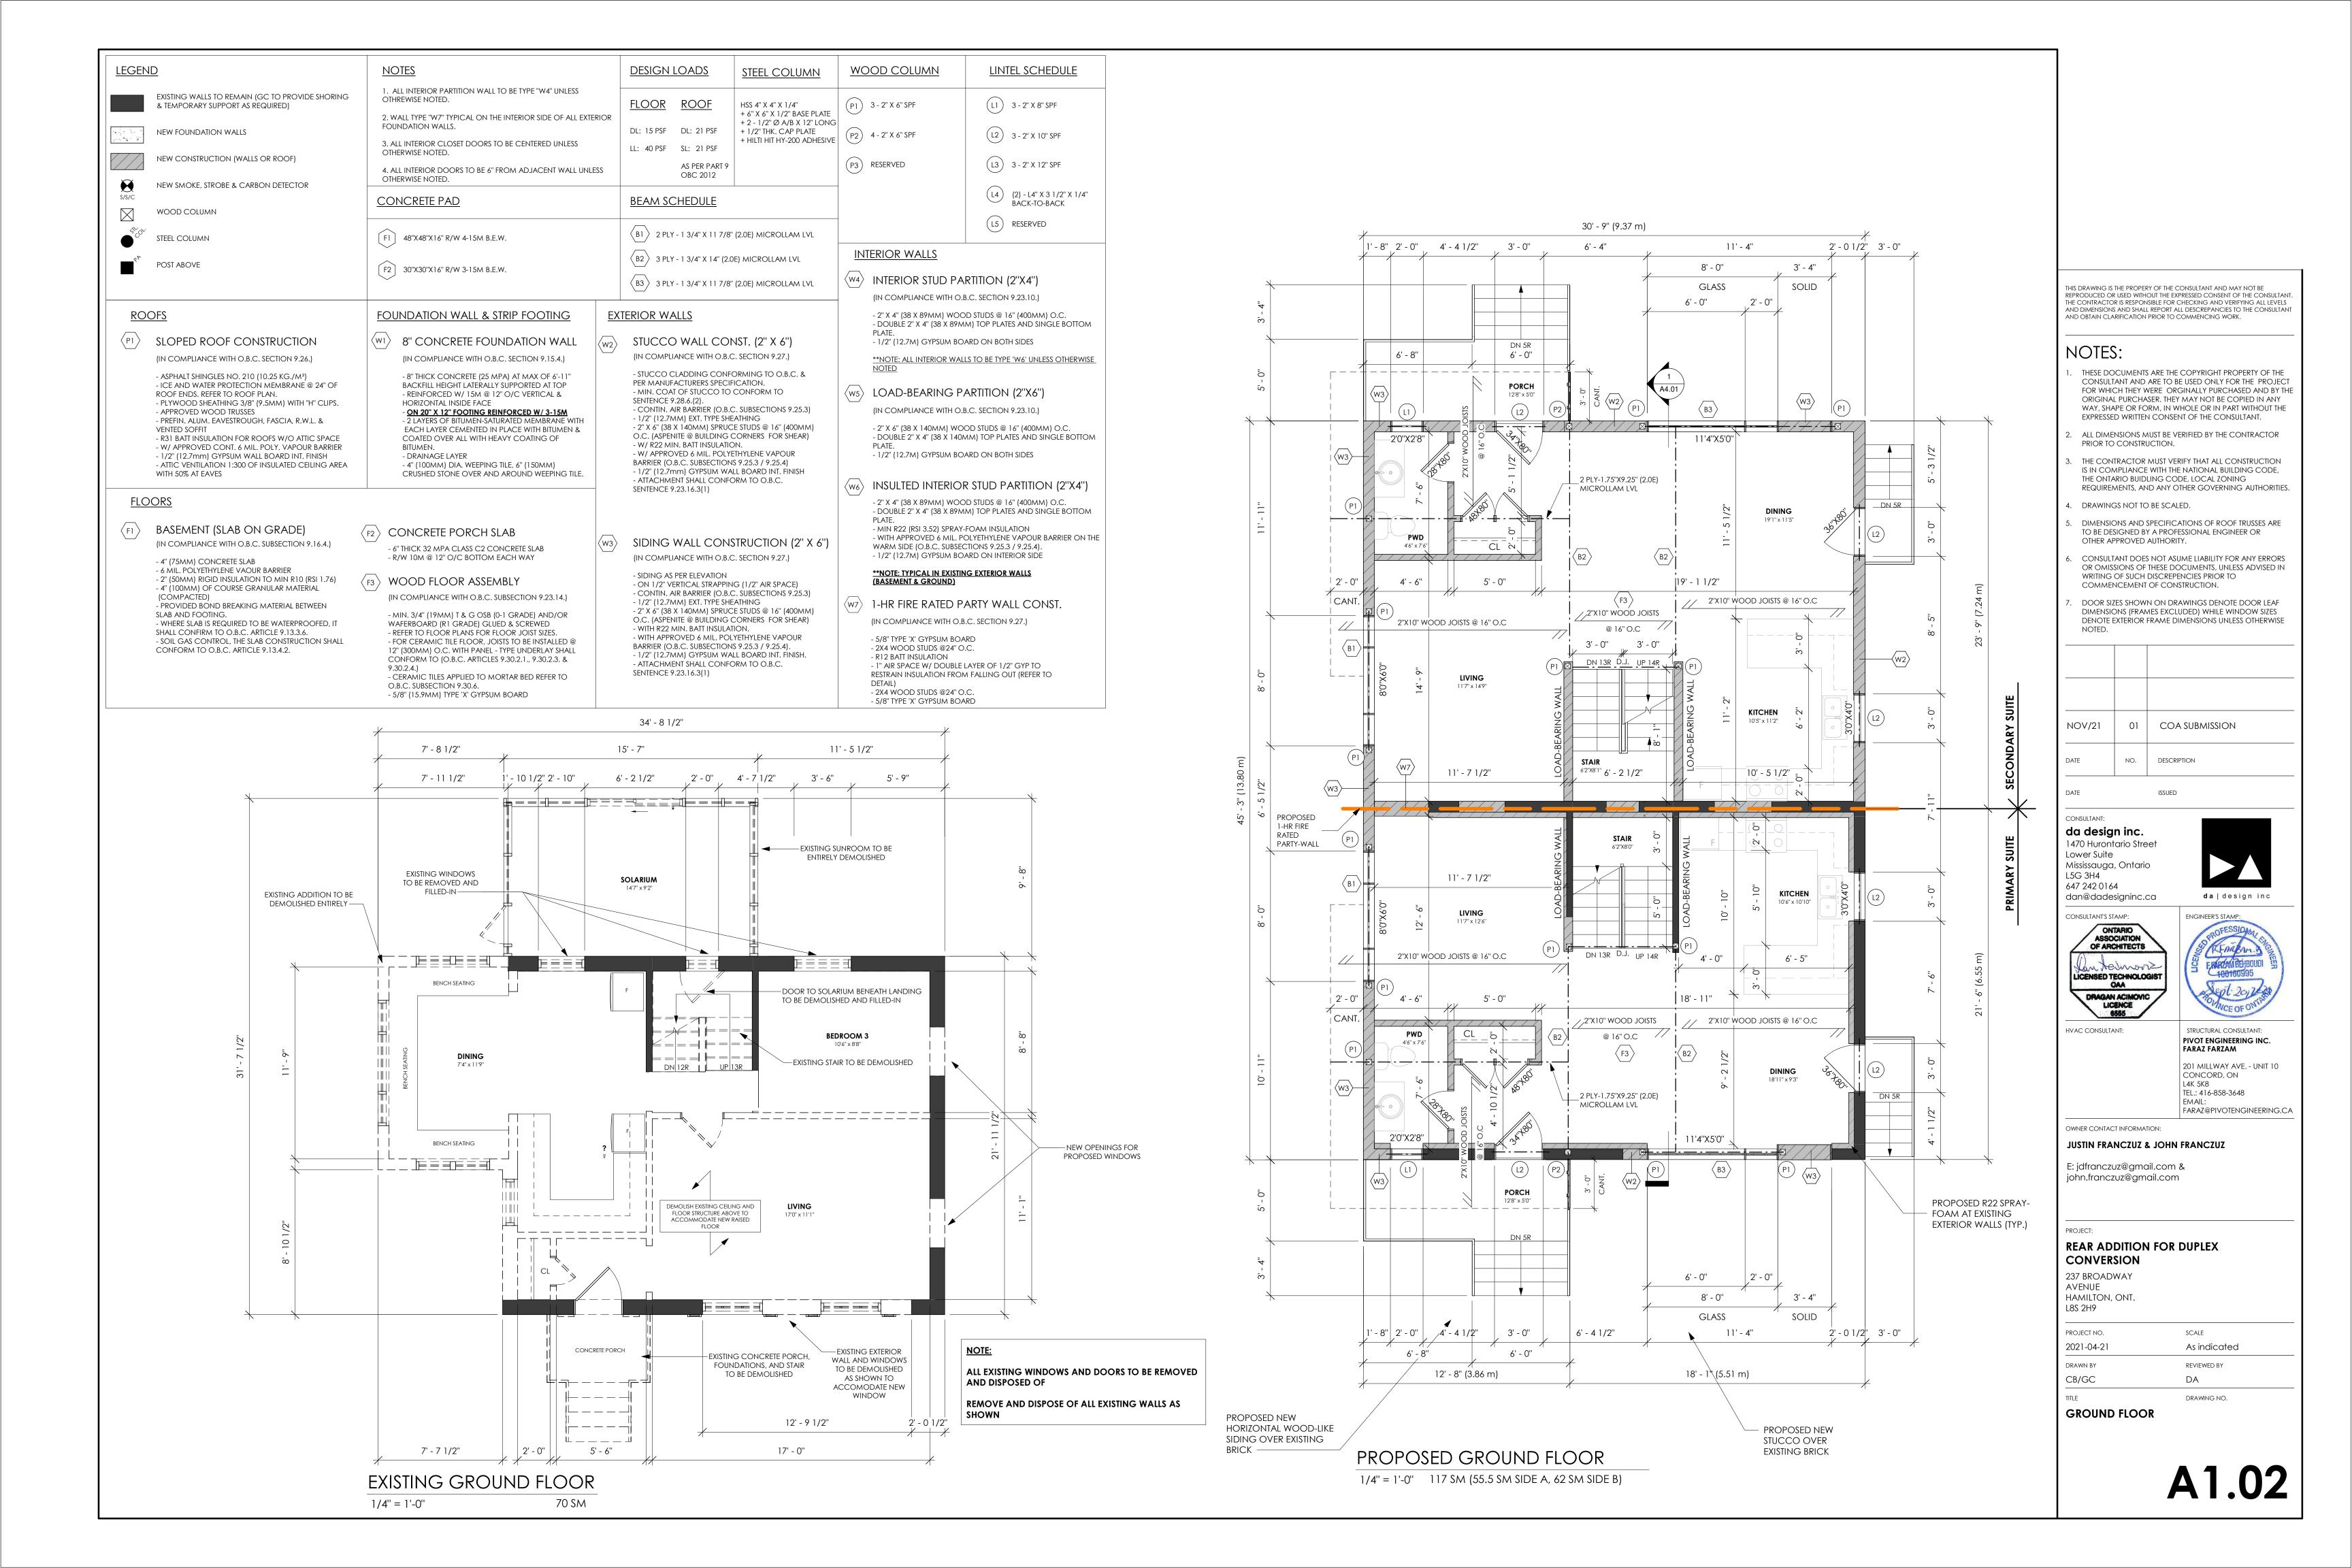

⟨P1⟩ SLOPED ROOF CONSTRUCTION (IN COMPLIANCE WITH O.B.C. SECTION 9.26.) - ASPHALT SHINGLES NO. 210 (10.25 KG./M²) - ICE AND WATER PROTECTION MEMBRANE @ 24" OF

BASEMENT (SLAB ON GRADE)

- 6 MIL. POLYETHYLENE VAOUR BARRIER

- 4" (75MM) CONCRETE SLAB

SLAB AND FOOTING.

(IN COMPLIANCE WITH O.B.C. SUBSECTION 9.16.4.)

- 2" (50MM) RIGID INSULATION TO MIN R10 (RSI 1.76)

- 4" (100MM) OF COURSE GRANULAR MATERIAL

SHALL CONFIRM TO O.B.C. ARTICLE 9.13.3.6.

CONFORM TO O.B.C. ARTICLE 9.13.4.2.

- PROVIDED BOND BREAKING MATERIAL BETWEEN

- WHERE SLAB IS REQUIRED TO BE WATERPROOFED, IT

- SOIL GAS CONTROL, THE SLAB CONSTRUCTION SHALL

ROOF ENDS. REFER TO ROOF PLAN.

<u>FLOORS</u>

- PLYWOOD SHEATHING 3/8" (9.5MM) WITH "H" CLIPS. - APPROVED WOOD TRUSSES - PREFIN. ALUM. EAVESTROUGH, FASCIA, R.W.L. & VENTED SOFFIT - R31 BATT INSULATION FOR ROOFS W/O ATTIC SPACE - W/ APPROVED CONT. 6 MIL. POLY. VAPOUR BARRIER - 1/2" (12.7mm) GYPSUM WALL BOARD INT. FINISH - ATTIC VENTILATION 1:300 OF INSULATED CEILING AREA WITH 50% AT EAVES

(W1) 8" CONCRETE FOUNDATION WALL (IN COMPLIANCE WITH O.B.C. SECTION 9.15.4.) - 8" THICK CONCRETE (25 MPA) AT MAX OF 6'-11" BACKFILL HEIGHT LATERALLY SUPPORTED AT TOP - REINFORCED W/ 15M @ 12" O/C VERTICAL & HORIZONTAL INSIDE FACE ON 20" X 12" FOOTING REINFORCED W/ 3-15M EACH LAYER CEMENTED IN PLACE WITH BITUMEN & COATED OVER ALL WITH HEAVY COATING OF

> - DRAINAGE LAYER - 4" (100MM) DIA. WEEPING TILE, 6" (150MM) CRUSHED STONE OVER AND AROUND WEEPING TILE.

### $\langle F2 \rangle$ CONCRETE PORCH SLAB - 6" THICK 32 MPA CLASS C2 CONCRETE SLAB - R/W 10M @ 12" O/C BOTTOM EACH WAY

 $\langle F3 \rangle$  WOOD FLOOR ASSEMBLY

(IN COMPLIANCE WITH O.B.C. SUBSECTION 9.23.14.) - MIN. 3/4" (19MM) T & G OSB (0-1 GRADE) AND/OR WAFERBOARD (R1 GRADE) GLUED & SCREWED - REFER TO FLOOR PLANS FOR FLOOR JOIST SIZES. - FOR CERAMIC TILE FLOOR, JOISTS TO BE INSTALLED @ 12" (300MM) O.C. WITH PANEL - TYPE UNDERLAY SHALL CONFORM TO (O.B.C. ARTICLES 9.30.2.1., 9.30.2.3. &

- CERAMIC TILES APPLIED TO MORTAR BED REFER TO O.B.C. SUBSECTION 9.30.6. - 5/8" (15.9MM) TYPE 'X' GYPSUM BOARD

EXISTING SECOND FLOOR

1/4" = 1'-0"

36 SM

STUCCO WALL CONST. (2" X 6") (IN COMPLIANCE WITH O.B.C. SECTION 9.27.) - STUCCO CLADDING CONFORMING TO O.B.C. & PER MANUFACTURERS SPECIFICATION. - MIN. COAT OF STUCCO TO CONFORM TO SENTENCE 9.28.6.(2). - 1/2" (12.7MM) EXT. TYPE SHEATHING

- CONTIN. AIR BARRIER (O.B.C. SUBSECTIONS 9.25.3) - 2" X 6" (38 X 140MM) SPRUCE STUDS @ 16" (400MM) O.C. (ASPENITE @ BUILDING CORNERS FOR SHEAR) - W/ R22 MIN. BATT INSULATION. - W/ APPROVED 6 MIL. POLYETHYLENE VAPOUR BARRIER (O.B.C. SUBSECTIONS 9.25.3 / 9.25.4) - 1/2" (12.7mm) GYPSUM WALL BOARD INT. FINISH - ATTACHMENT SHALL CONFORM TO O.B.C. SENTENCE 9.23.16.3(1)

SIDING WALL CONSTRUCTION (2" X 6") (IN COMPLIANCE WITH O.B.C. SECTION 9.27.)

- SIDING AS PER ELEVATION - ON 1/2" VERTICAL STRAPPING (1/2" AIR SPACE) - CONTIN. AIR BARRIER (O.B.C. SUBSECTIONS 9.25.3) - 1/2" (12.7MM) EXT. TYPE SHEATHING - 2" X 6" (38 X 140MM) SPRUCE STUDS @ 16" (400MM) O.C. (ASPENITE @ BUILDING CORNERS FOR SHEAR) - WITH R22 MIN. BATT INSULATION. - WITH APPROVED 6 MIL. POLYETHYLENE VAPOUR BARRIER (O.B.C. SUBSECTIONS 9.25.3 / 9.25.4). - 1/2" (12.7MM) GYPSUM WALL BOARD INT. FINISH. - ATTACHMENT SHALL CONFORM TO O.B.C. SENTENCE 9.23.16.3(1)

- DOUBLE 2" X 4" (38 X 89MM) TOP PLATES AND SINGLE BOTTOM - 1/2" (12.7M) GYPSUM BOARD ON BOTH SIDES \*\*NOTE: ALL INTERIOR WALLS TO BE TYPE 'W6' UNLESS OTHERWISE

(w<sub>5</sub>) LOAD-BEARING PARTITION (2"X6") (IN COMPLIANCE WITH O.B.C. SECTION 9.23.10.) - 2" X 6" (38 X 140MM) WOOD STUDS @ 16" (400MM) O.C. - DOUBLE 2" X 4" (38 X 140MM) TOP PLATES AND SINGLE BOTTOM - 1/2" (12.7M) GYPSUM BOARD ON BOTH SIDES

NOTED


(w6) INSULTED INTERIOR STUD PARTITION (2"X4") - 2" X 4" (38 X 89MM) WOOD STUDS @ 16" (400MM) O.C. - DOUBLE 2" X 4" (38 X 89MM) TOP PLATES AND SINGLE BOTTOM - MIN R22 (RSI 3.52) SPRAY-FOAM INSULATION - WITH APPROVED 6 MIL. POLYETHYLENE VAPOUR BARRIER ON THE WARM SIDE (O.B.C. SUBSECTIONS 9.25.3 / 9.25.4). - 1/2" (12.7M) GYPSUM BOARD ON INTERIOR SIDE


(BASEMENT & GROUND)

\*\*NOTE: TYPICAL IN EXISTING EXTERIOR WALLS

 $\langle w_7 \rangle$  1-HR FIRE RATED PARTY WALL CONST. (IN COMPLIANCE WITH O.B.C. SECTION 9.27.)

> - 5/8" TYPE 'X' GYPSUM BOARD - 2X4 WOOD STUDS @24" O.C. - R12 BATT INSULATION - 1" AIR SPACE W/ DOUBLE LAYER OF 1/2" GYP TO RESTRAIN INSULATION FROM FALLING OUT (REFER TO - 2X4 WOOD STUDS @24" O.C. - 5/8" TYPE 'X' GYPSUM BOARD

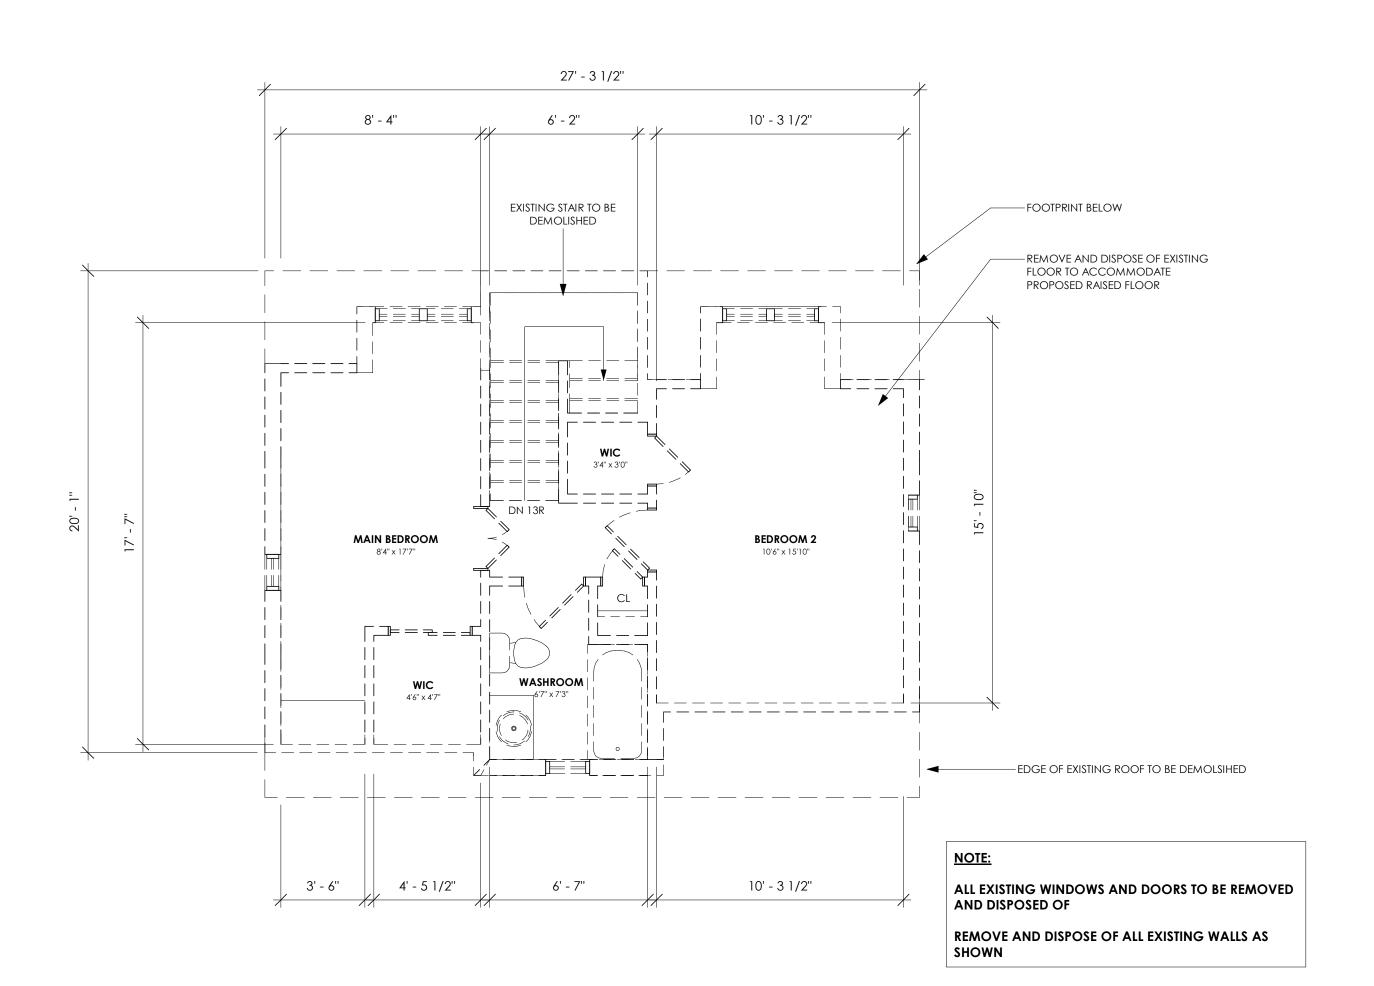

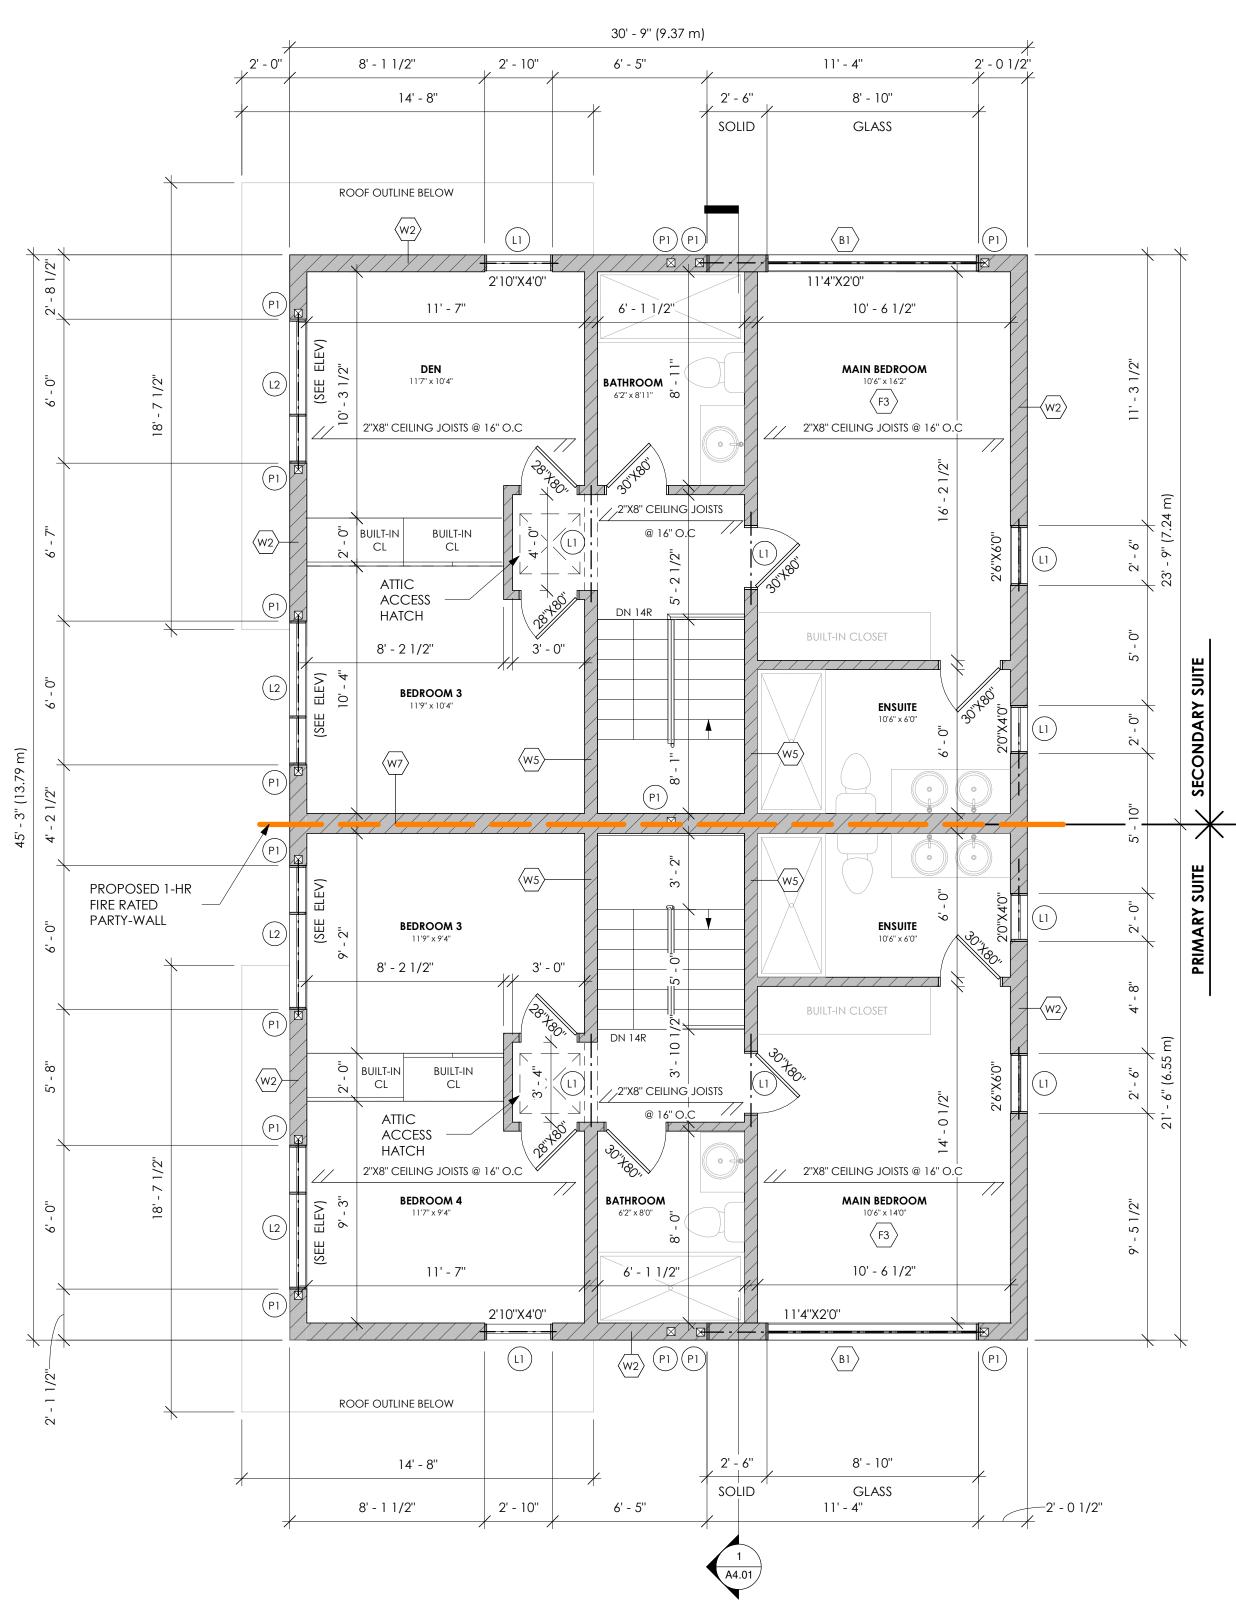

PROPOSED SECOND FLOOR

107 SM (51 SM SIDE A,

56 SM SIDE B)

1/4" = 1'-0"


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HVAC CONSULTANT:

STRUCTURAL CONSULTANT PIVOT ENGINEERING INC. FARAZ FARZAM 201 MILLWAY AVE. - UNIT 10

CONCORD, ON L4K 5K8

TEL.: 416-858-3648

FARAZ@PIVOTENGINEERING.CA OWNER CONTACT INFORMATION:

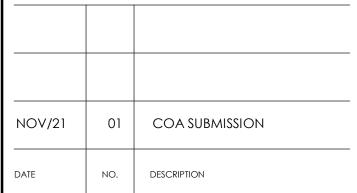JUSTIN FRANCZUZ & JOHN FRANCZUZ


E: jdfranczuz@gmail.com & john.franczuz@gmail.com

**REAR ADDITION FOR DUPLEX CONVERSION** 

237 BROADWAY **AVENUE** HAMILTON, ONT. L8S 2H9

PROJECT NO. SCALE 2021-04-21 As indicated DRAWN BY REVIEWED BY CB/GC DA DRAWING NO.

SECOND FLOOR

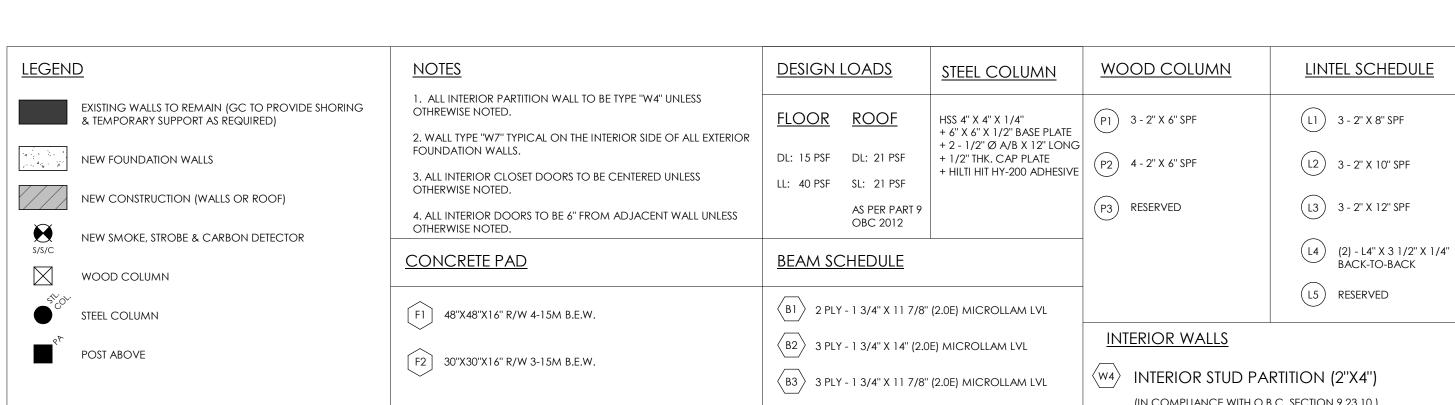

# <u>ROOFS</u>

<u>FLOORS</u>

 
 P1
 SLOPED ROOF CONSTRUCTION
 (IN COMPLIANCE WITH O.B.C. SECTION 9.26.) - ASPHALT SHINGLES NO. 210 (10.25 KG./M²) - ICE AND WATER PROTECTION MEMBRANE @ 24" OF ROOF ENDS. REFER TO ROOF PLAN.

> - PLYWOOD SHEATHING 3/8" (9.5MM) WITH "H" CLIPS. - APPROVED WOOD TRUSSES - PREFIN. ALUM. EAVESTROUGH, FASCIA, R.W.L. & VENTED SOFFIT - R31 BATT INSULATION FOR ROOFS W/O ATTIC SPACE - W/ APPROVED CONT. 6 MIL. POLY. VAPOUR BARRIER - 1/2" (12.7mm) GYPSUM WALL BOARD INT. FINISH - ATTIC VENTILATION 1:300 OF INSULATED CEILING AREA WITH 50% AT EAVES

# **FOUNDATION WALL & STRIP FOOTING**

(W1) 8" CONCRETE FOUNDATION WALL (IN COMPLIANCE WITH O.B.C. SECTION 9.15.4.) - 8" THICK CONCRETE (25 MPA) AT MAX OF 6'-11" BACKFILL HEIGHT LATERALLY SUPPORTED AT TOP - REINFORCED W/ 15M @ 12" O/C VERTICAL & HORIZONTAL INSIDE FACE ON 20" X 12" FOOTING REINFORCED W/ 3-15M

EACH LAYER CEMENTED IN PLACE WITH BITUMEN & COATED OVER ALL WITH HEAVY COATING OF - DRAINAGE LAYER - 4" (100MM) DIA. WEEPING TILE, 6" (150MM)

BASEMENT (SLAB ON GRADE)

(IN COMPLIANCE WITH O.B.C. SUBSECTION 9.16.4.) - 4" (75MM) CONCRETE SLAB - 6 MIL. POLYETHYLENE VAOUR BARRIER - 2" (50MM) RIGID INSULATION TO MIN R10 (RSI 1.76) - 4" (100MM) OF COURSE GRANULAR MATERIAL

(COMPACTED) - PROVIDED BOND BREAKING MATERIAL BETWEEN SLAB AND FOOTING. - WHERE SLAB IS REQUIRED TO BE WATERPROOFED, IT SHALL CONFIRM TO O.B.C. ARTICLE 9.13.3.6. - SOIL GAS CONTROL, THE SLAB CONSTRUCTION SHALL CONFORM TO O.B.C. ARTICLE 9.13.4.2.

CRUSHED STONE OVER AND AROUND WEEPING TILE.

 $\langle F2 \rangle$  CONCRETE PORCH SLAB - 6" THICK 32 MPA CLASS C2 CONCRETE SLAB - R/W 10M @ 12" O/C BOTTOM EACH WAY

 $\langle F3 \rangle$  WOOD FLOOR ASSEMBLY

- MIN. 3/4" (19MM) T & G OSB (0-1 GRADE) AND/OR WAFERBOARD (R1 GRADE) GLUED & SCREWED - REFER TO FLOOR PLANS FOR FLOOR JOIST SIZES. - FOR CERAMIC TILE FLOOR, JOISTS TO BE INSTALLED  $\ensuremath{@}$ 12" (300MM) O.C. WITH PANEL - TYPE UNDERLAY SHALL CONFORM TO (O.B.C. ARTICLES 9.30.2.1., 9.30.2.3. & - CERAMIC TILES APPLIED TO MORTAR BED REFER TO O.B.C. SUBSECTION 9.30.6.

- 5/8" (15.9MM) TYPE 'X' GYPSUM BOARD

(IN COMPLIANCE WITH O.B.C. SUBSECTION 9.23.14.)

# **EXTERIOR WALLS**

STUCCO WALL CONST. (2" X 6") (IN COMPLIANCE WITH O.B.C. SECTION 9.27.)

- STUCCO CLADDING CONFORMING TO O.B.C. & PER MANUFACTURERS SPECIFICATION. - MIN. COAT OF STUCCO TO CONFORM TO SENTENCE 9.28.6.(2). - CONTIN. AIR BARRIER (O.B.C. SUBSECTIONS 9.25.3) - 1/2" (12.7MM) EXT. TYPE SHEATHING - 2" X 6" (38 X 140MM) SPRUCE STUDS @ 16" (400MM) O.C. (ASPENITE @ BUILDING CORNERS FOR SHEAR) - W/ R22 MIN. BATT INSULATION. - W/ APPROVED 6 MIL. POLYETHYLENE VAPOUR BARRIER (O.B.C. SUBSECTIONS 9.25.3 / 9.25.4) - 1/2" (12.7mm) GYPSUM WALL BOARD INT. FINISH - ATTACHMENT SHALL CONFORM TO O.B.C. SENTENCE 9.23.16.3(1)

SIDING WALL CONSTRUCTION (2" X 6") (IN COMPLIANCE WITH O.B.C. SECTION 9.27.)

- SIDING AS PER ELEVATION - ON 1/2" VERTICAL STRAPPING (1/2" AIR SPACE) - CONTIN. AIR BARRIER (O.B.C. SUBSECTIONS 9.25.3) - 1/2" (12.7MM) EXT. TYPE SHEATHING - 2" X 6" (38 X 140MM) SPRUCE STUDS @ 16" (400MM) O.C. (ASPENITE @ BUILDING CORNERS FOR SHEAR) - WITH R22 MIN. BATT INSULATION. - WITH APPROVED 6 MIL. POLYETHYLENE VAPOUR BARRIER (O.B.C. SUBSECTIONS 9.25.3 / 9.25.4). - 1/2" (12.7MM) GYPSUM WALL BOARD INT. FINISH. - ATTACHMENT SHALL CONFORM TO O.B.C. SENTENCE 9.23.16.3(1)

(IN COMPLIANCE WITH O.B.C. SECTION 9.23.10.) - 2" X 4" (38 X 89MM) WOOD STUDS @ 16" (400MM) O.C. - DOUBLE 2" X 4" (38 X 89MM) TOP PLATES AND SINGLE BOTTOM - 1/2" (12.7M) GYPSUM BOARD ON BOTH SIDES

\*\*NOTE: ALL INTERIOR WALLS TO BE TYPE 'W6' UNLESS OTHERWISE <u>NOTED</u>

(w<sub>5</sub>) LOAD-BEARING PARTITION (2"X6") (IN COMPLIANCE WITH O.B.C. SECTION 9.23.10.) - 2" X 6" (38 X 140MM) WOOD STUDS @ 16" (400MM) O.C. - DOUBLE 2" X 4" (38 X 140MM) TOP PLATES AND SINGLE BOTTOM

- 1/2" (12.7M) GYPSUM BOARD ON BOTH SIDES


(W6) INSULTED INTERIOR STUD PARTITION (2"X4") - 2" X 4" (38 X 89MM) WOOD STUDS @ 16" (400MM) O.C. - DOUBLE 2" X 4" (38 X 89MM) TOP PLATES AND SINGLE BOTTOM - MIN R22 (RSI 3.52) SPRAY-FOAM INSULATION - WITH APPROVED 6 MIL. POLYETHYLENE VAPOUR BARRIER ON THE WARM SIDE (O.B.C. SUBSECTIONS 9.25.3 / 9.25.4). - 1/2" (12.7M) GYPSUM BOARD ON INTERIOR SIDE

### \*\*NOTE: TYPICAL IN EXISTING EXTERIOR WALLS (BASEMENT & GROUND)


 $\langle w_7 \rangle$  1-HR FIRE RATED PARTY WALL CONST.

(IN COMPLIANCE WITH O.B.C. SECTION 9.27.) - 5/8" TYPE 'X' GYPSUM BOARD - 2X4 WOOD STUDS @24" O.C. - R12 BATT INSULATION - 1" AIR SPACE W/ DOUBLE LAYER OF 1/2" GYP TO RESTRAIN INSULATION FROM FALLING OUT (REFER TO

- 2X4 WOOD STUDS @24" O.C. - 5/8" TYPE 'X' GYPSUM BOARD

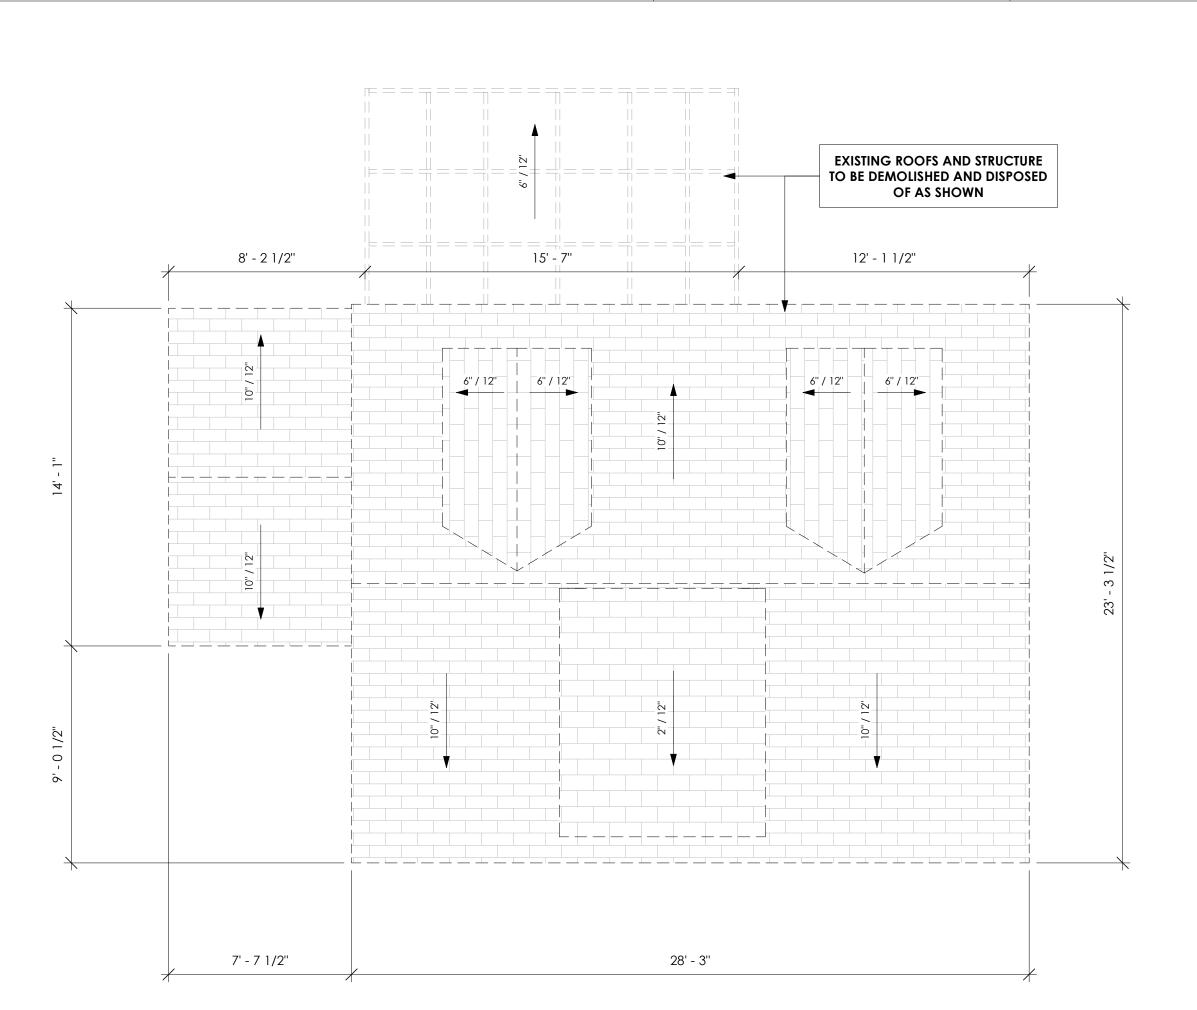

EXISTING ROOF PLAN 1/4" = 1'-0"

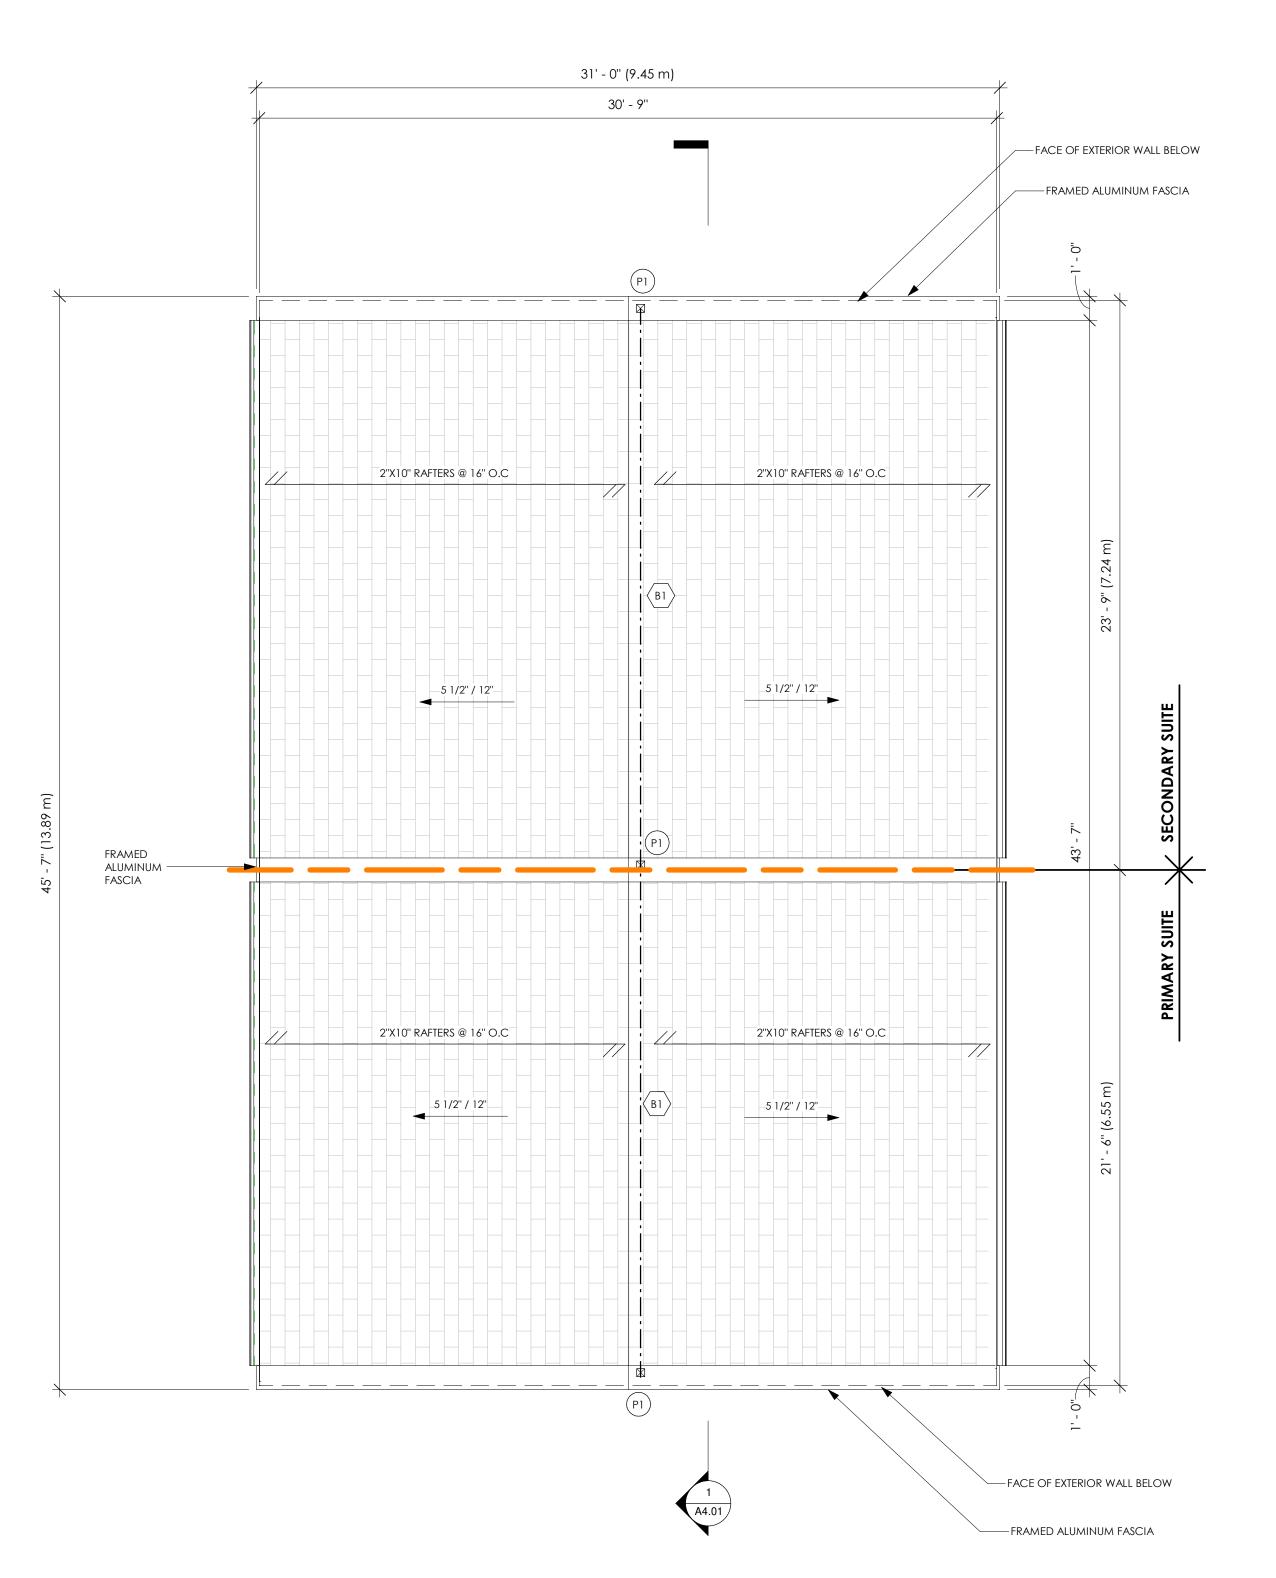

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NOV/21	01	COA SUBMISSION
DATE	NO.	DESCRIPTION

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**da** | design inc

dan@dadesigninc.ca CONSULTANT'S STAMP: LICENSED TECHNOLOGIST DRAGAN ACIMOVIC

HVAC CONSULTANT:

STRUCTURAL CONSULTANT:

PIVOT ENGINEERING INC. FARAZ FARZAM

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JUSTIN FRANCZUZ & JOHN FRANCZUZ

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OWNER CONTACT INFORMATION:

**REAR ADDITION FOR DUPLEX** CONVERSION


237 BROADWAY AVENUE HAMILTON, ONT. L8S 2H9


PROJECT NO. SCALE 2021-04-21 As indicated DRAWN BY REVIEWED BY CB/GC DA


**ROOF PLAN** 

DRAWING NO.

PROPOSED ROOF PLAN 1/4" = 1'-0"

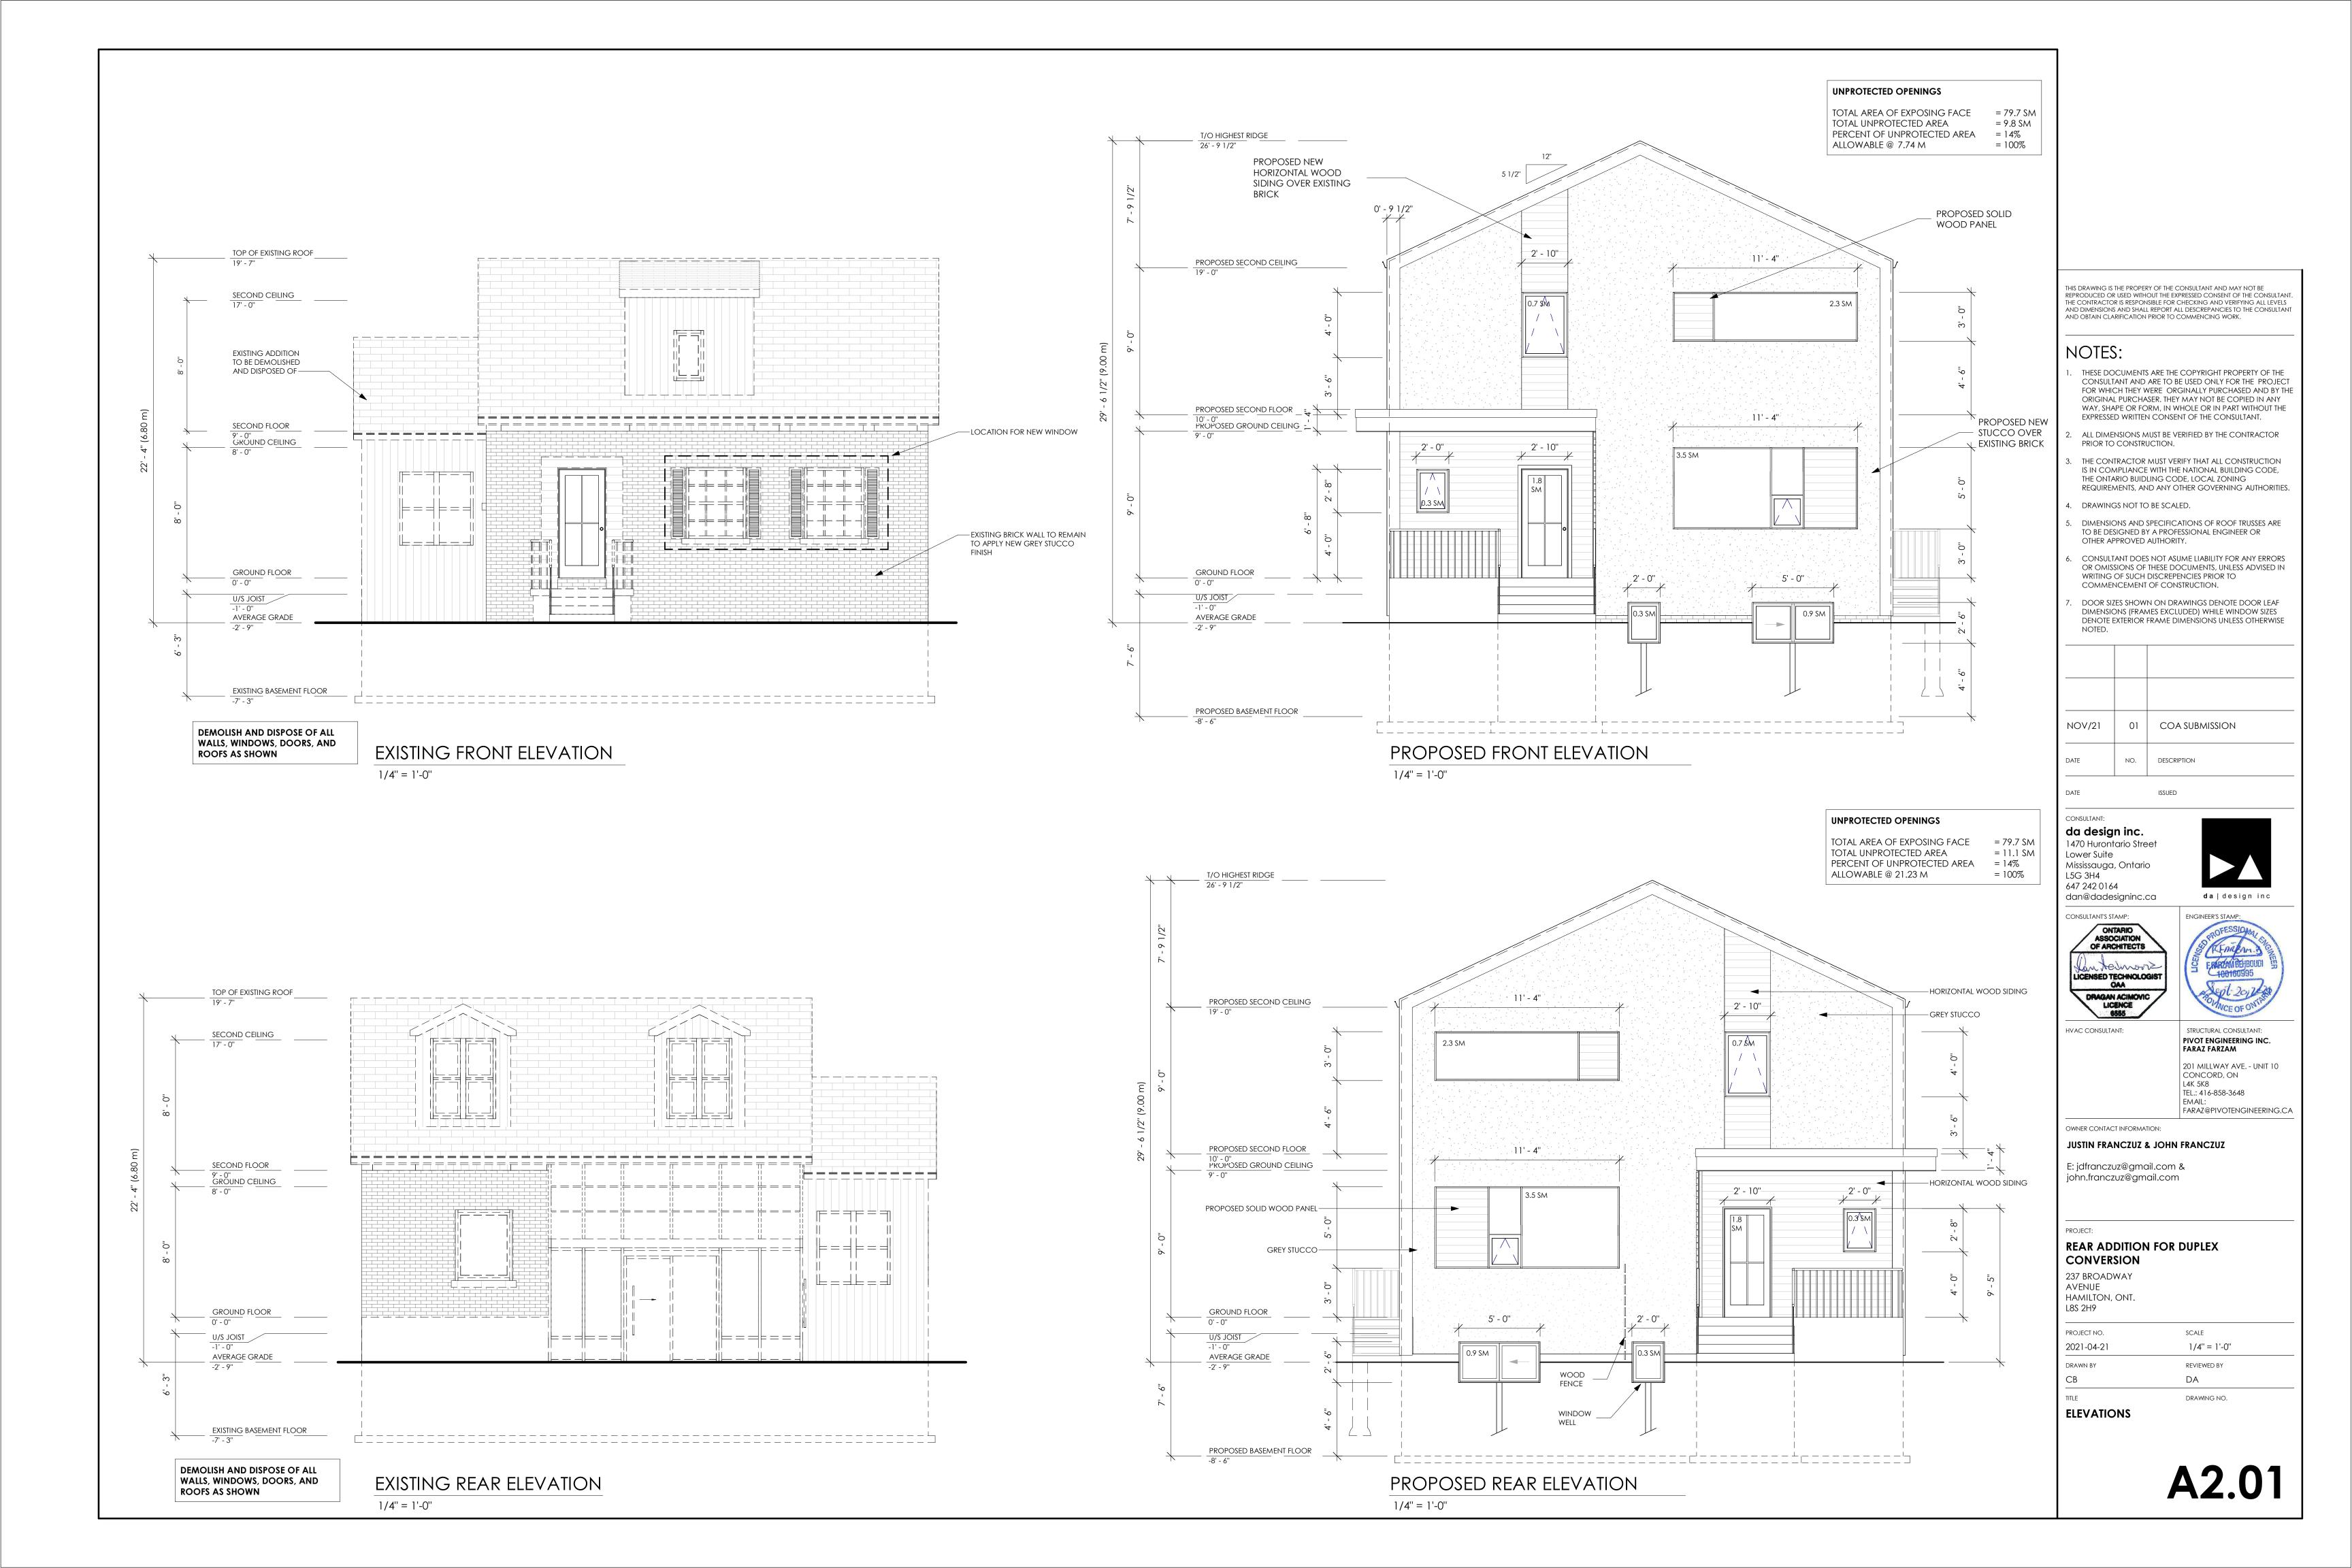

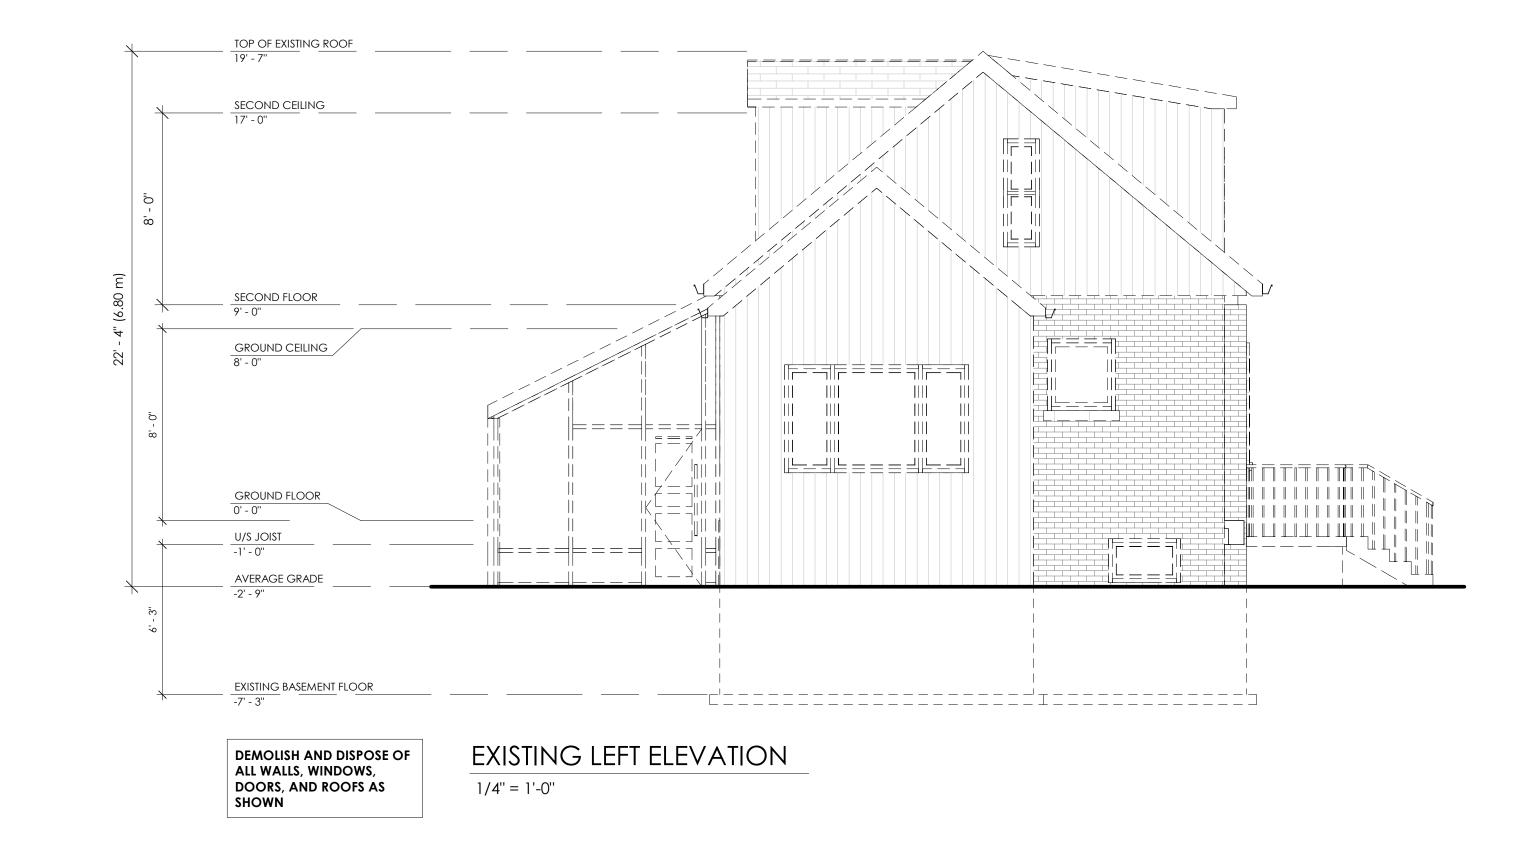

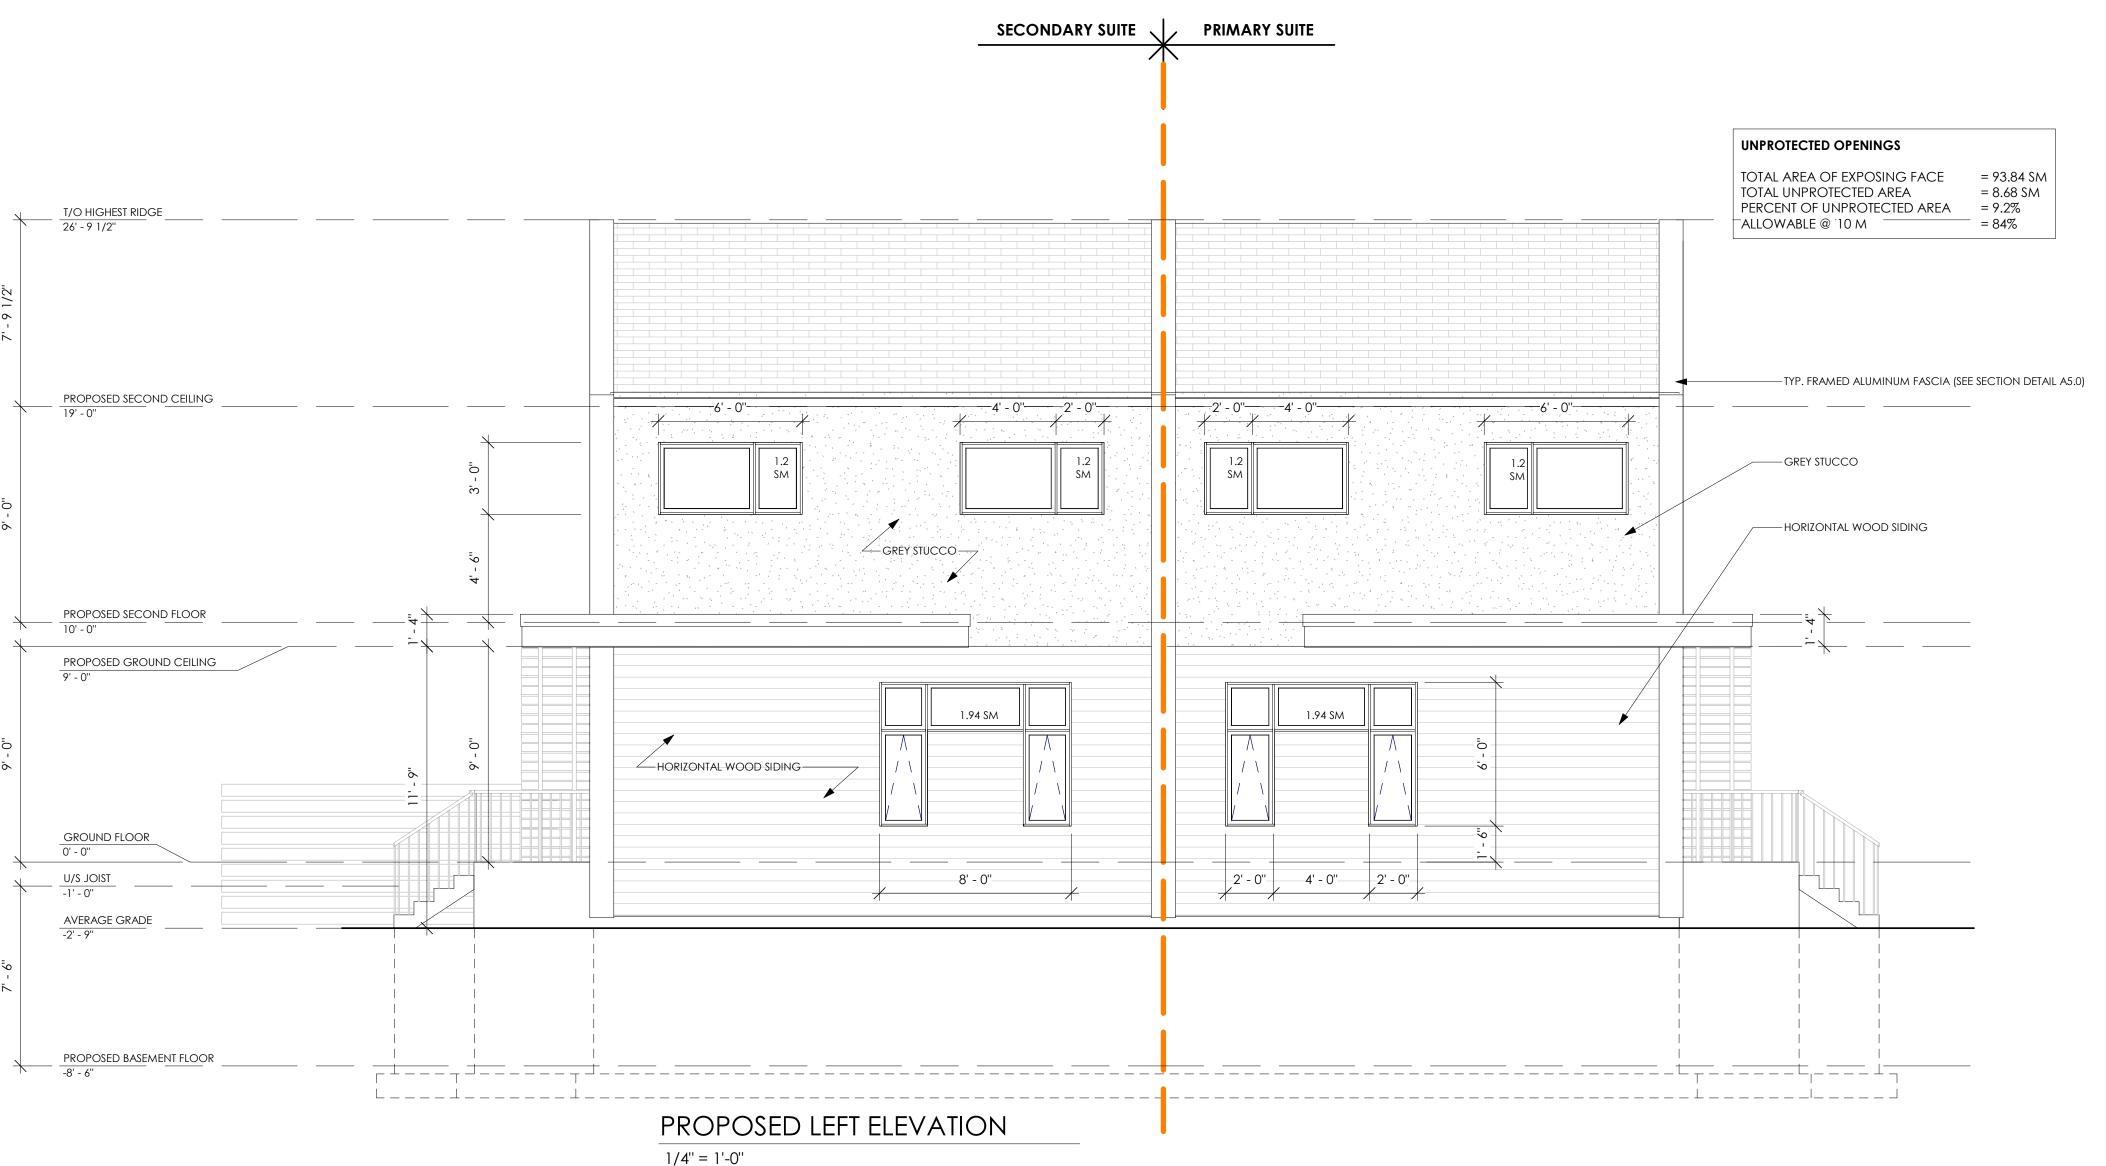

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- Door sizes shown on drawings denote door leaf dimensions (frames excluded) while window sizes DENOTE EXTERIOR FRAME DIMENSIONS UNLESS OTHERWISE

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# da design inc. 1470 Hurontario Street Lower Suite Mississauga, Ontario

L5G 3H4 647 242 0164



LICENSED TECHNOLOGIST

HVAC CONSULTANT:

STRUCTURAL CONSULTANT: PIVOT ENGINEERING INC. FARAZ FARZAM

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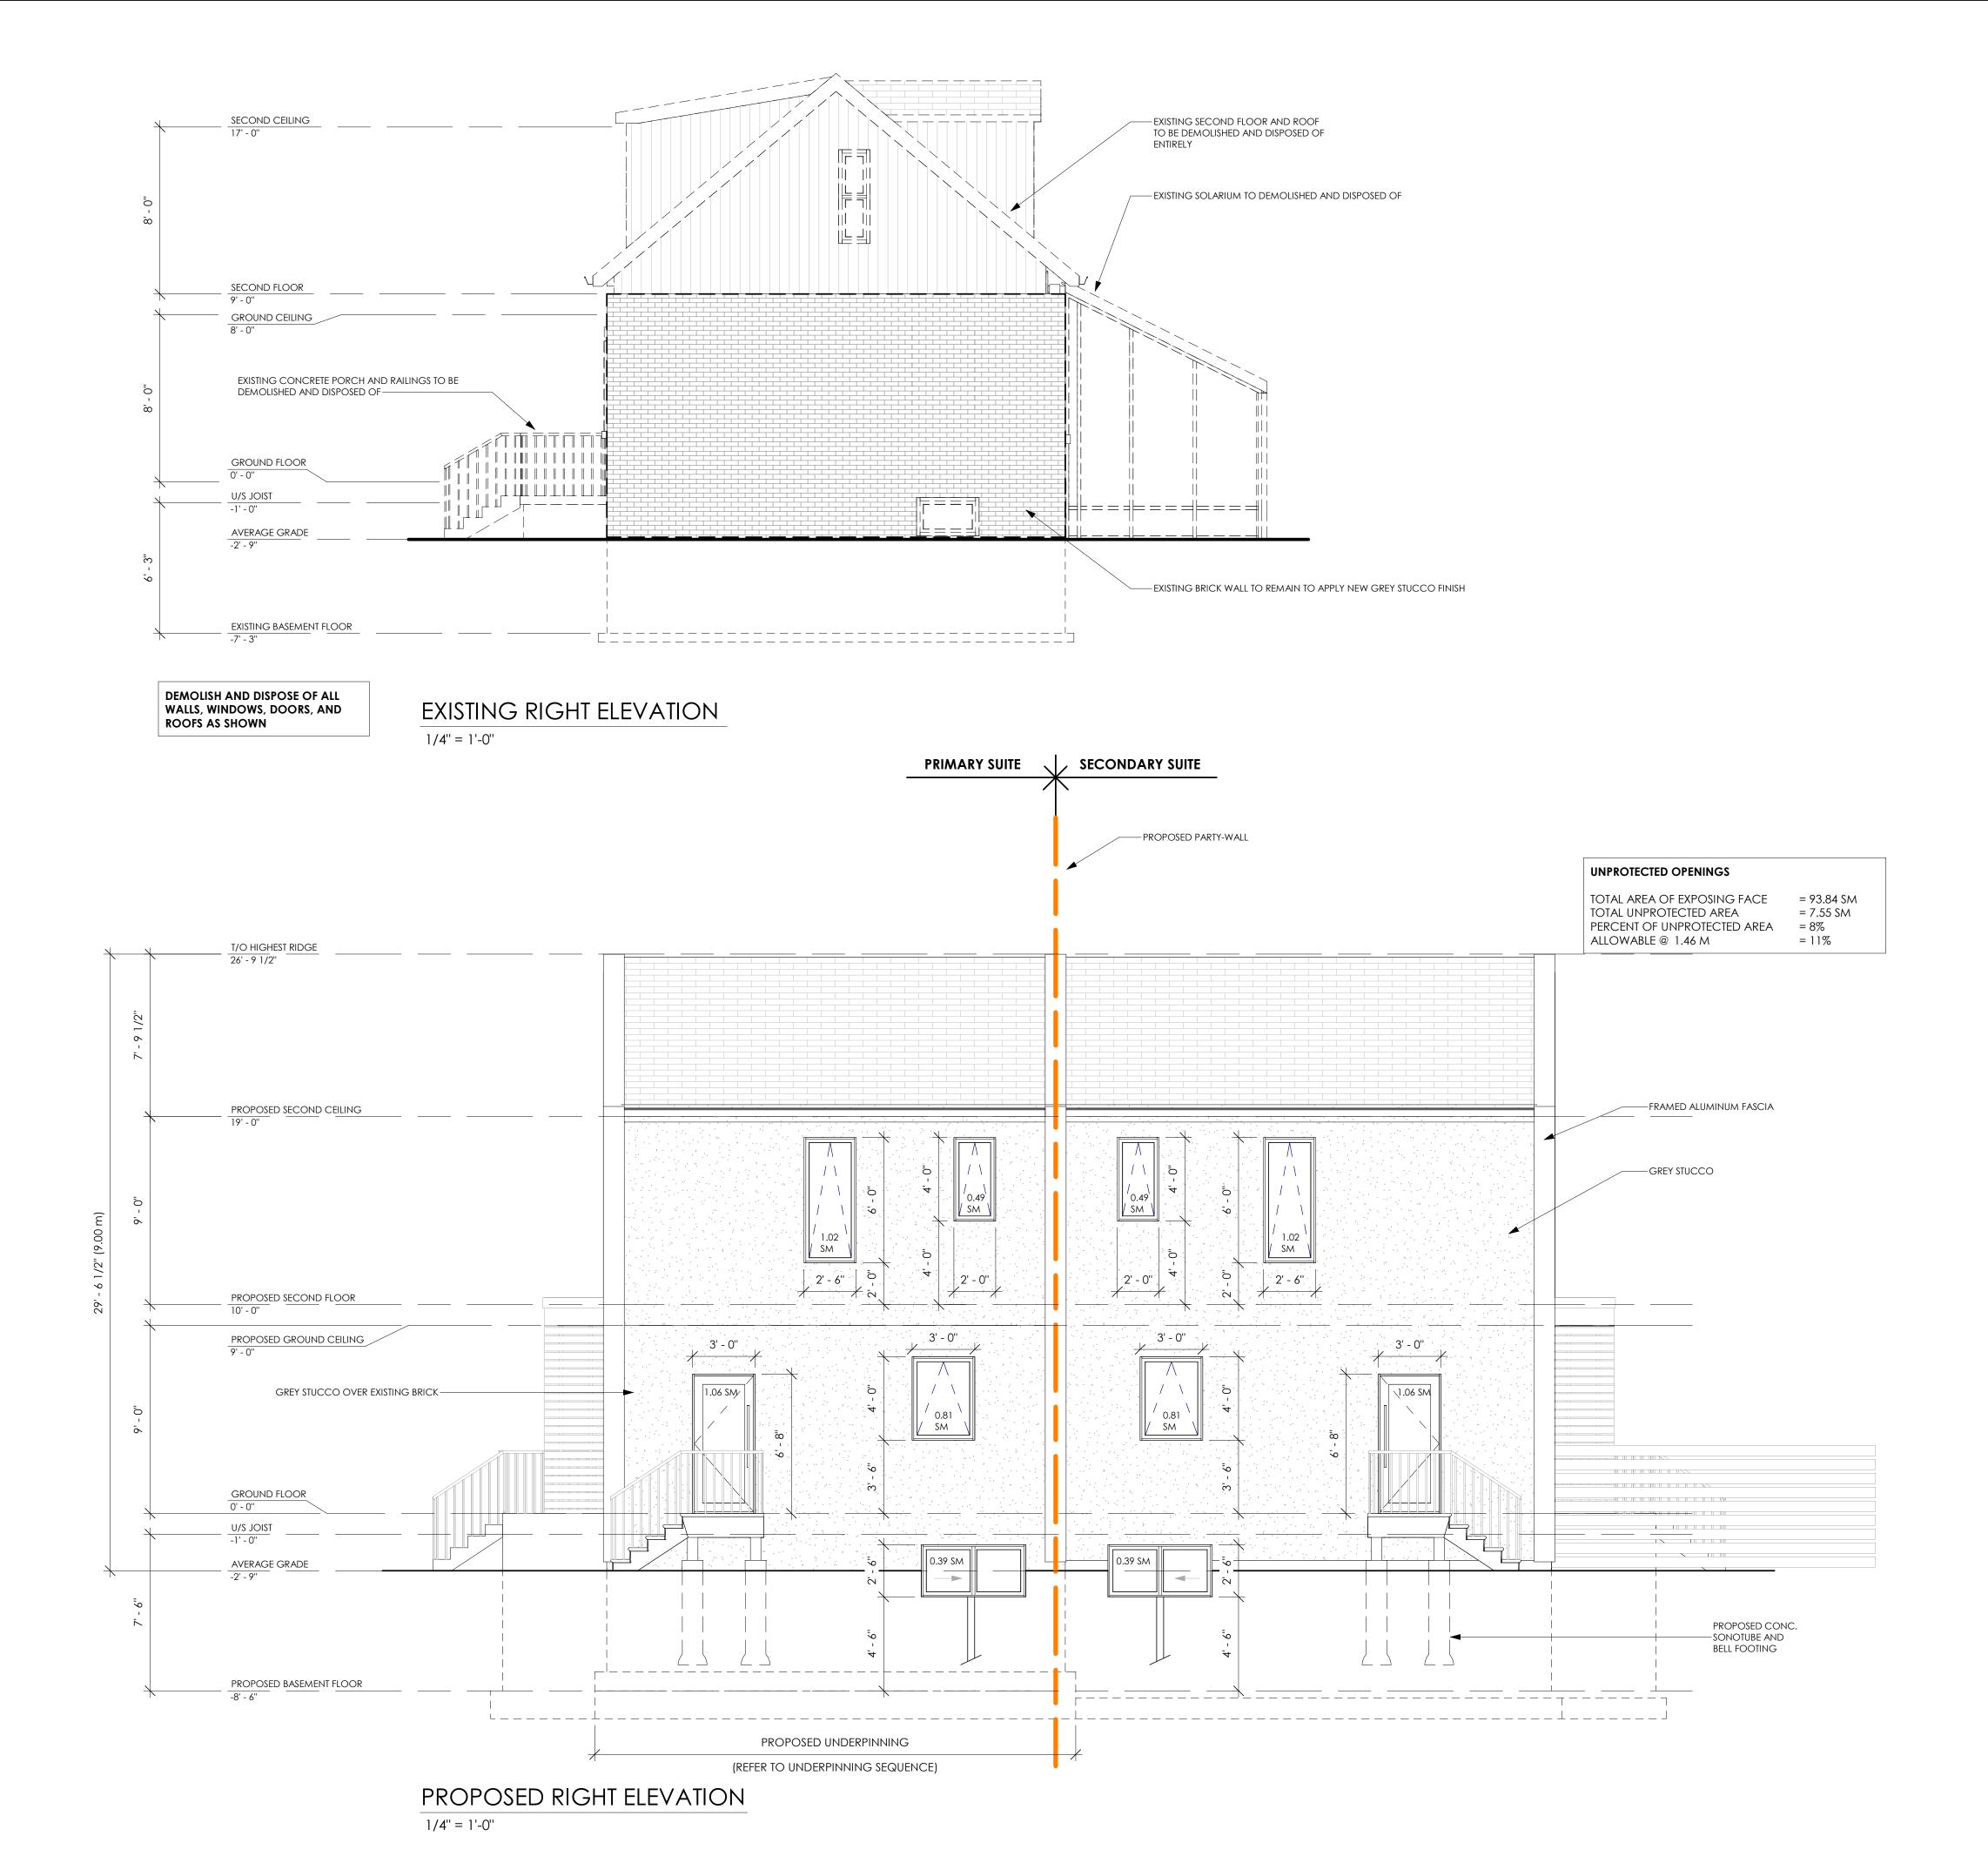
OWNER CONTACT INFORMATION:

# REAR ADDITION FOR DUPLEX CONVERSION

237 BROADWAY AVENUE HAMILTON, ONT. L8S 2H9

PROJECT NO.	SCALE
2021-04-21	1/4" = 1'-0"
DRAWN BY	REVIEWED BY
CB/GC	DA
TITLE	DRAWING NO

ELEVATIONS



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### NOTES:


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PROJECT:

# REAR ADDITION FOR DUPLEX CONVERSION

237 BROADWAY AVENUE HAMILTON, ONT. L8S 2H9

PROJECT NO. SCALE

2021-04-21 1/4" = 1'-0"

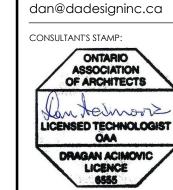
DRAWN BY REVIEWED BY

CB/GC DA

TITLE DRAWING NO.

ELEVATIONS

A 2 02

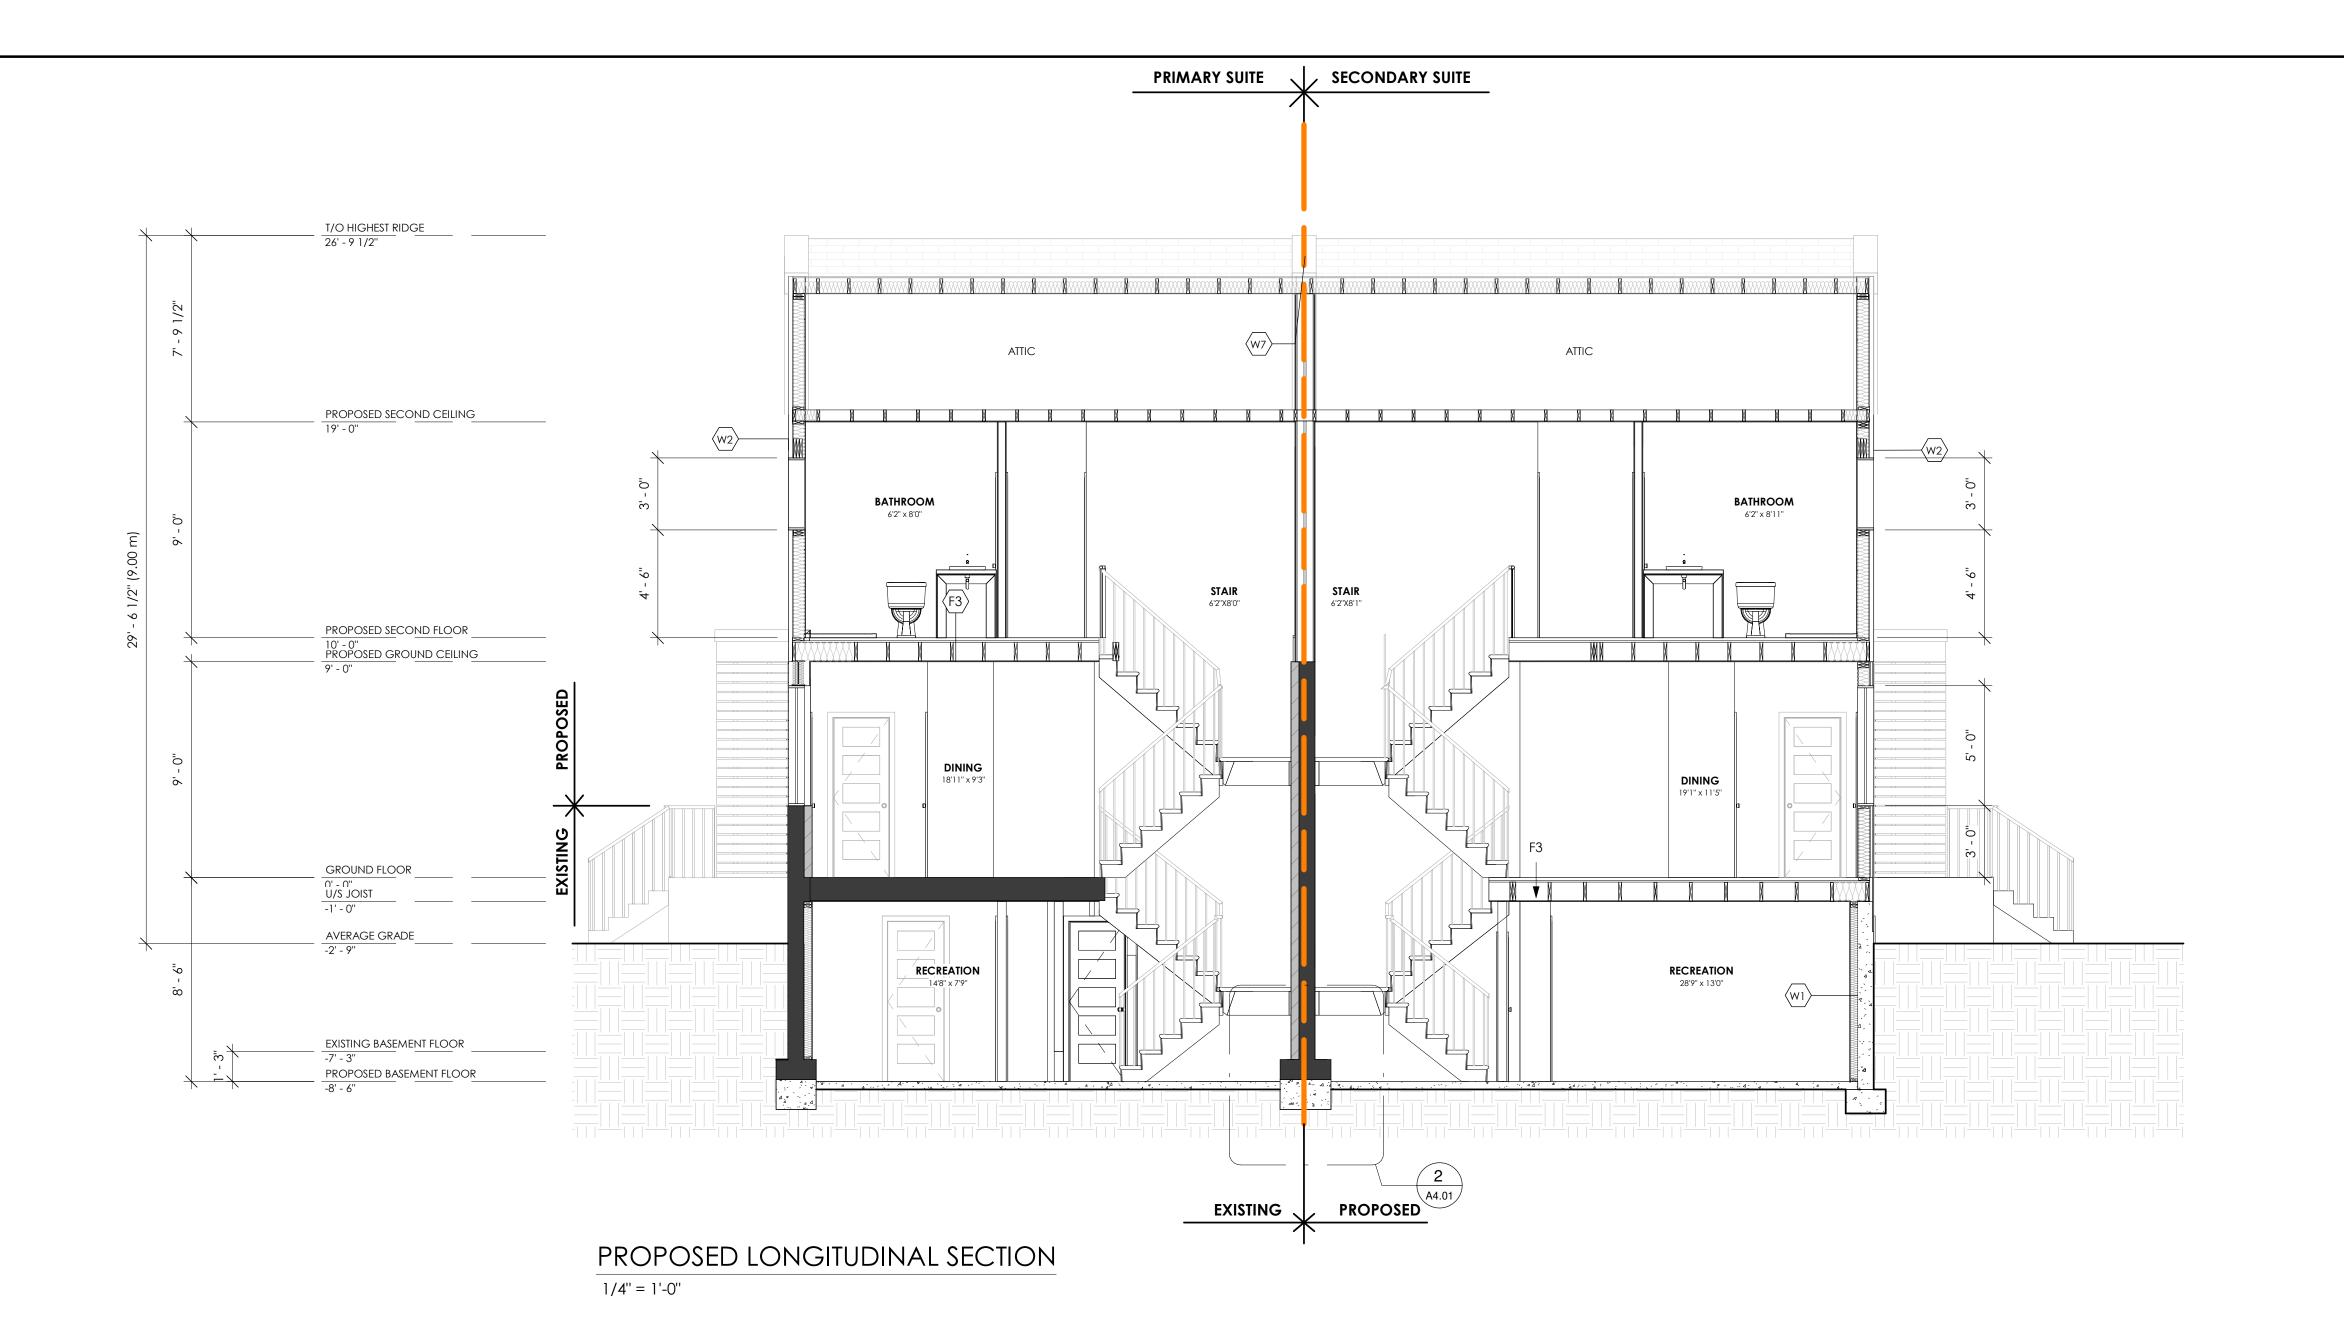

DESTING BASEMENT FLOOR

TO STAND BASEMENT FLOOR

TO STAND BASEMENT FLOOR

FROPOSED BASEMENT FLOOR

REAL CONCRETE SLAB

PROPOSED 4" DIA. WEEPER TILE W/ CRUSHED STONE COVER

UNDURFTHNING - TULL WIDTH OF EXISTING FOOTING

# UNDERPINNING @ PARTY WALL

3/4" = 1'-0"

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NOV/21	01	coa submission
DATE	NO.	DESCRIPTION

E ISSI

# CONSULTANT: da design inc. 1470 Hurontario Street Lower Suite Mississauga, Ontario

Lower Suite
Mississauga, Ontario
L5G 3H4
647 242 0164
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CONSULTANT'S STAMP:





HVAC CONSULTANT:

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OJECT:

REAR ADDITION FOR DUPLEX CONVERSION
237 BROADWAY

23/ BROADWAY
AVENUE
HAMILTON, ONT.
L8S 2H9

 PROJECT NO.
 SCALE

 2021-04-21
 As indicated


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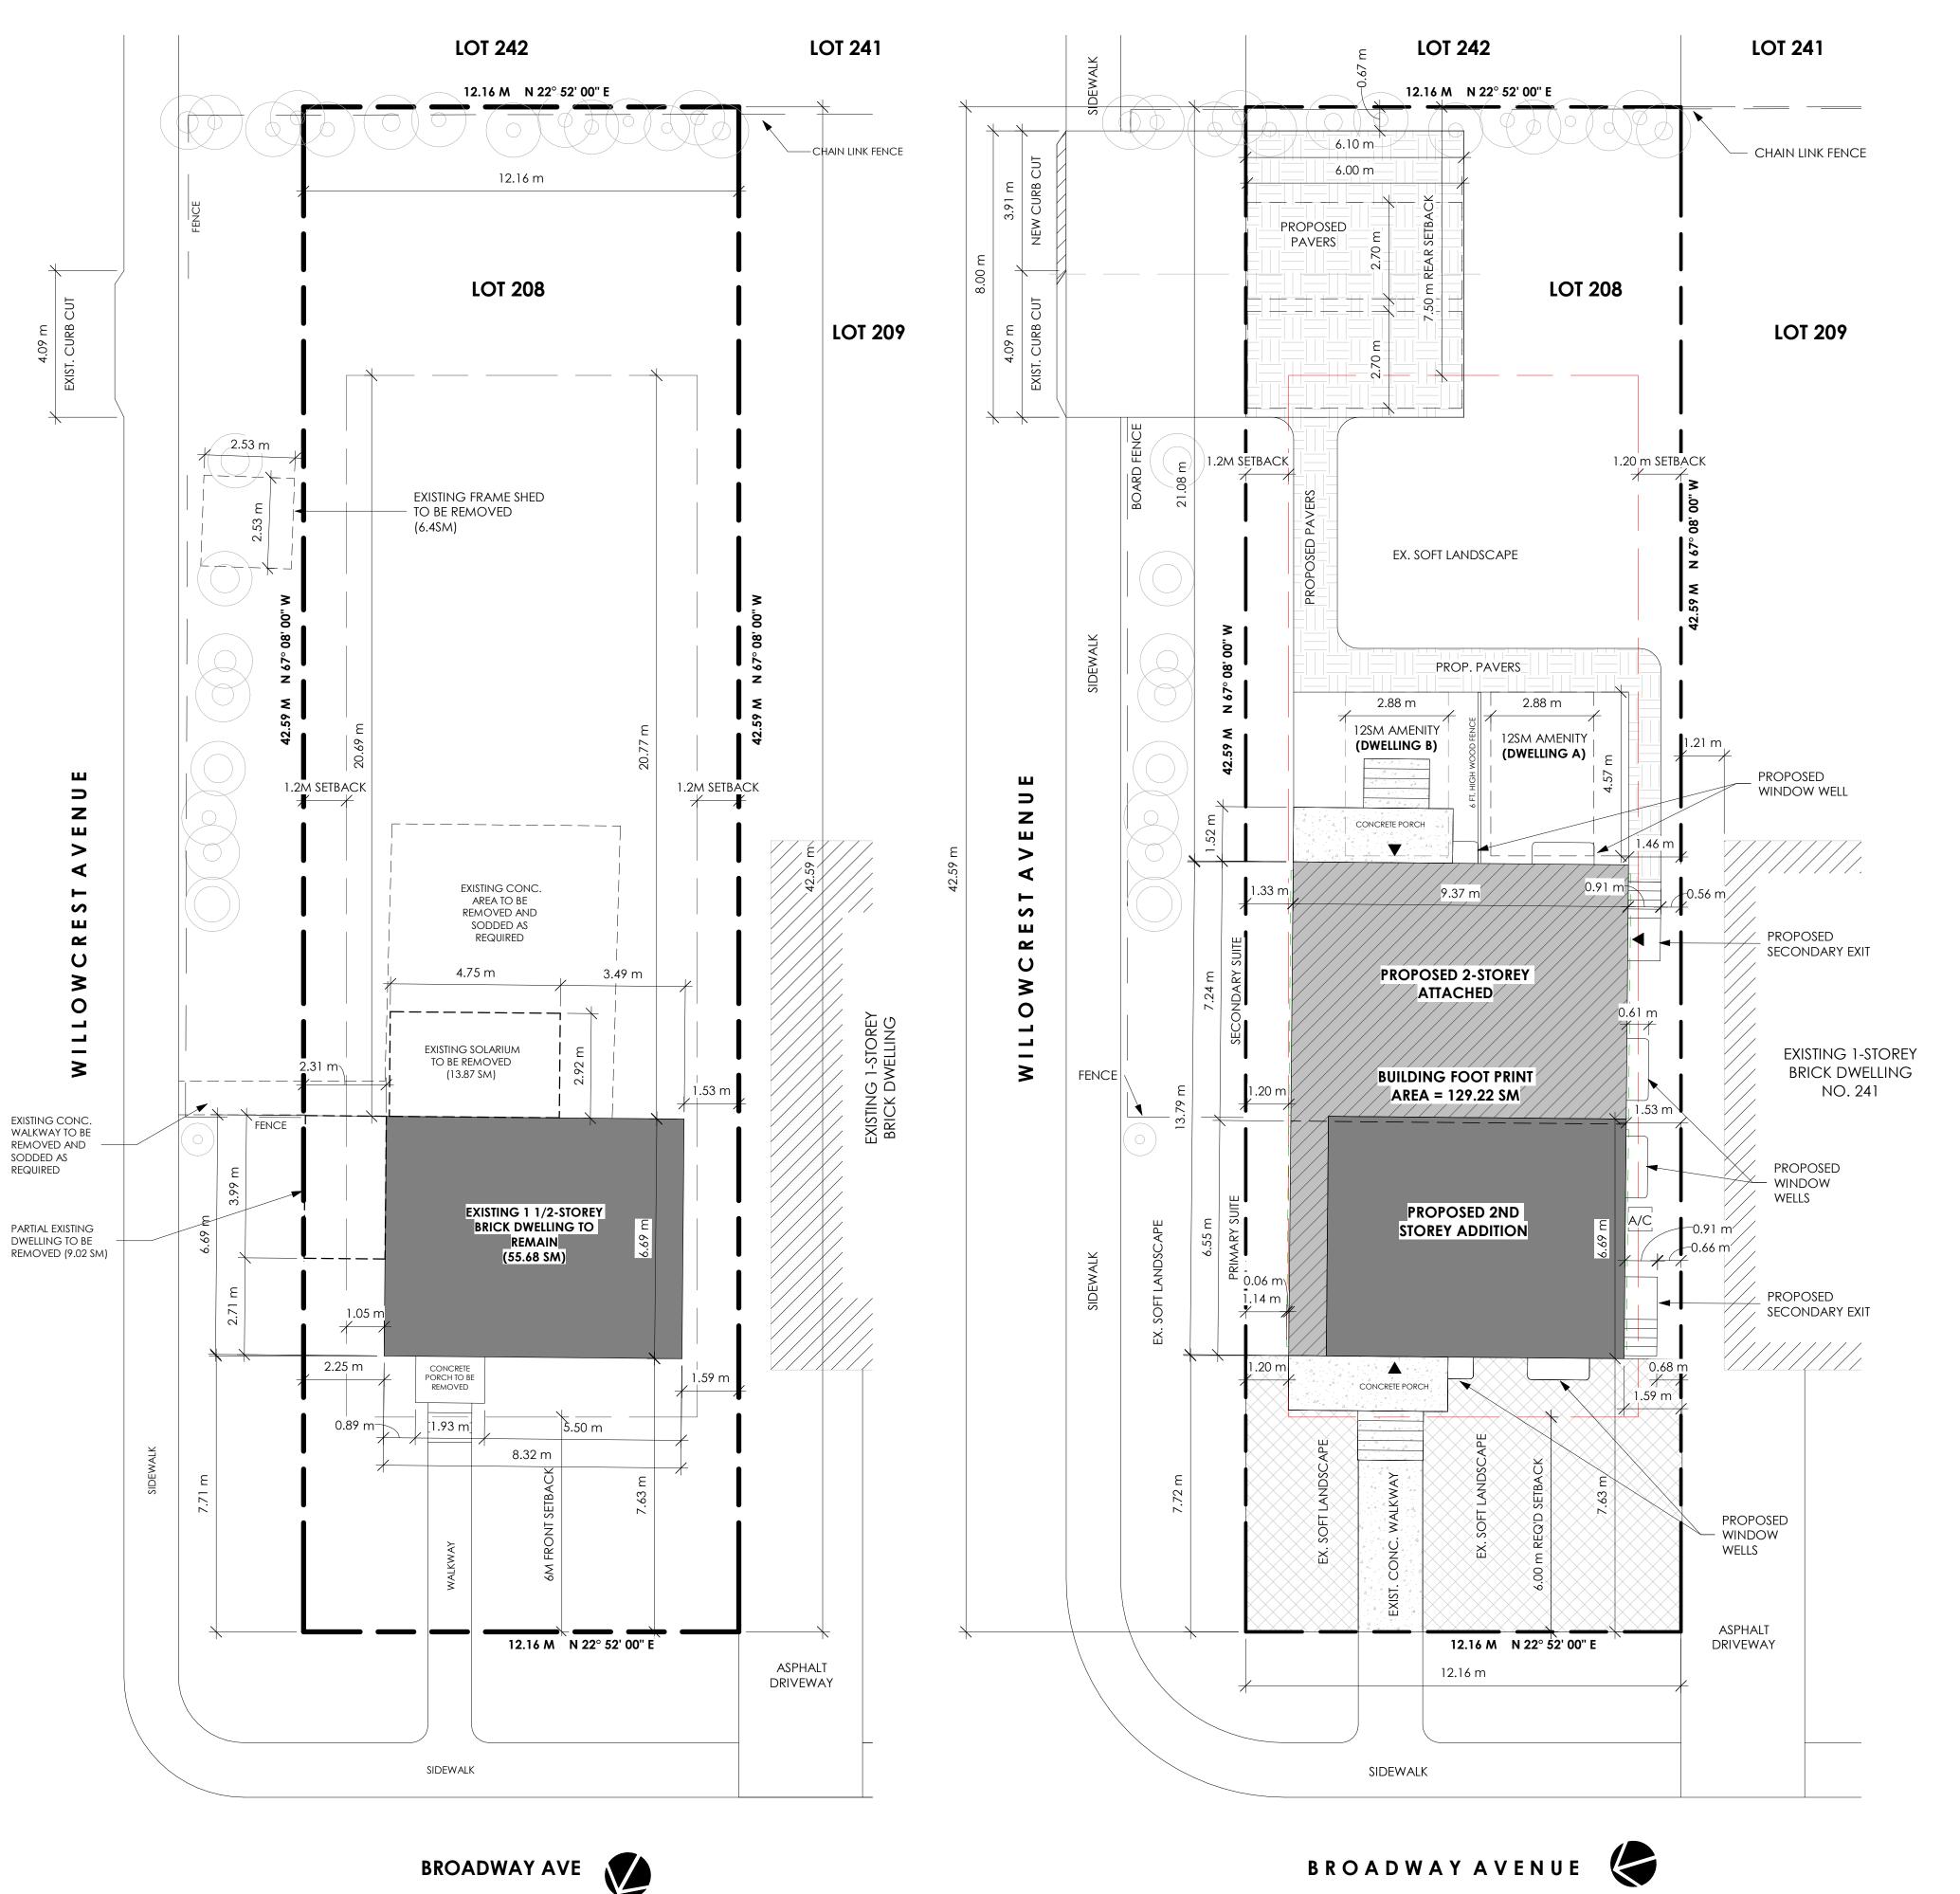
 CB/GC
 DA

 TITLE
 DRAWING NO.

SECTIONS

**A4.0**1



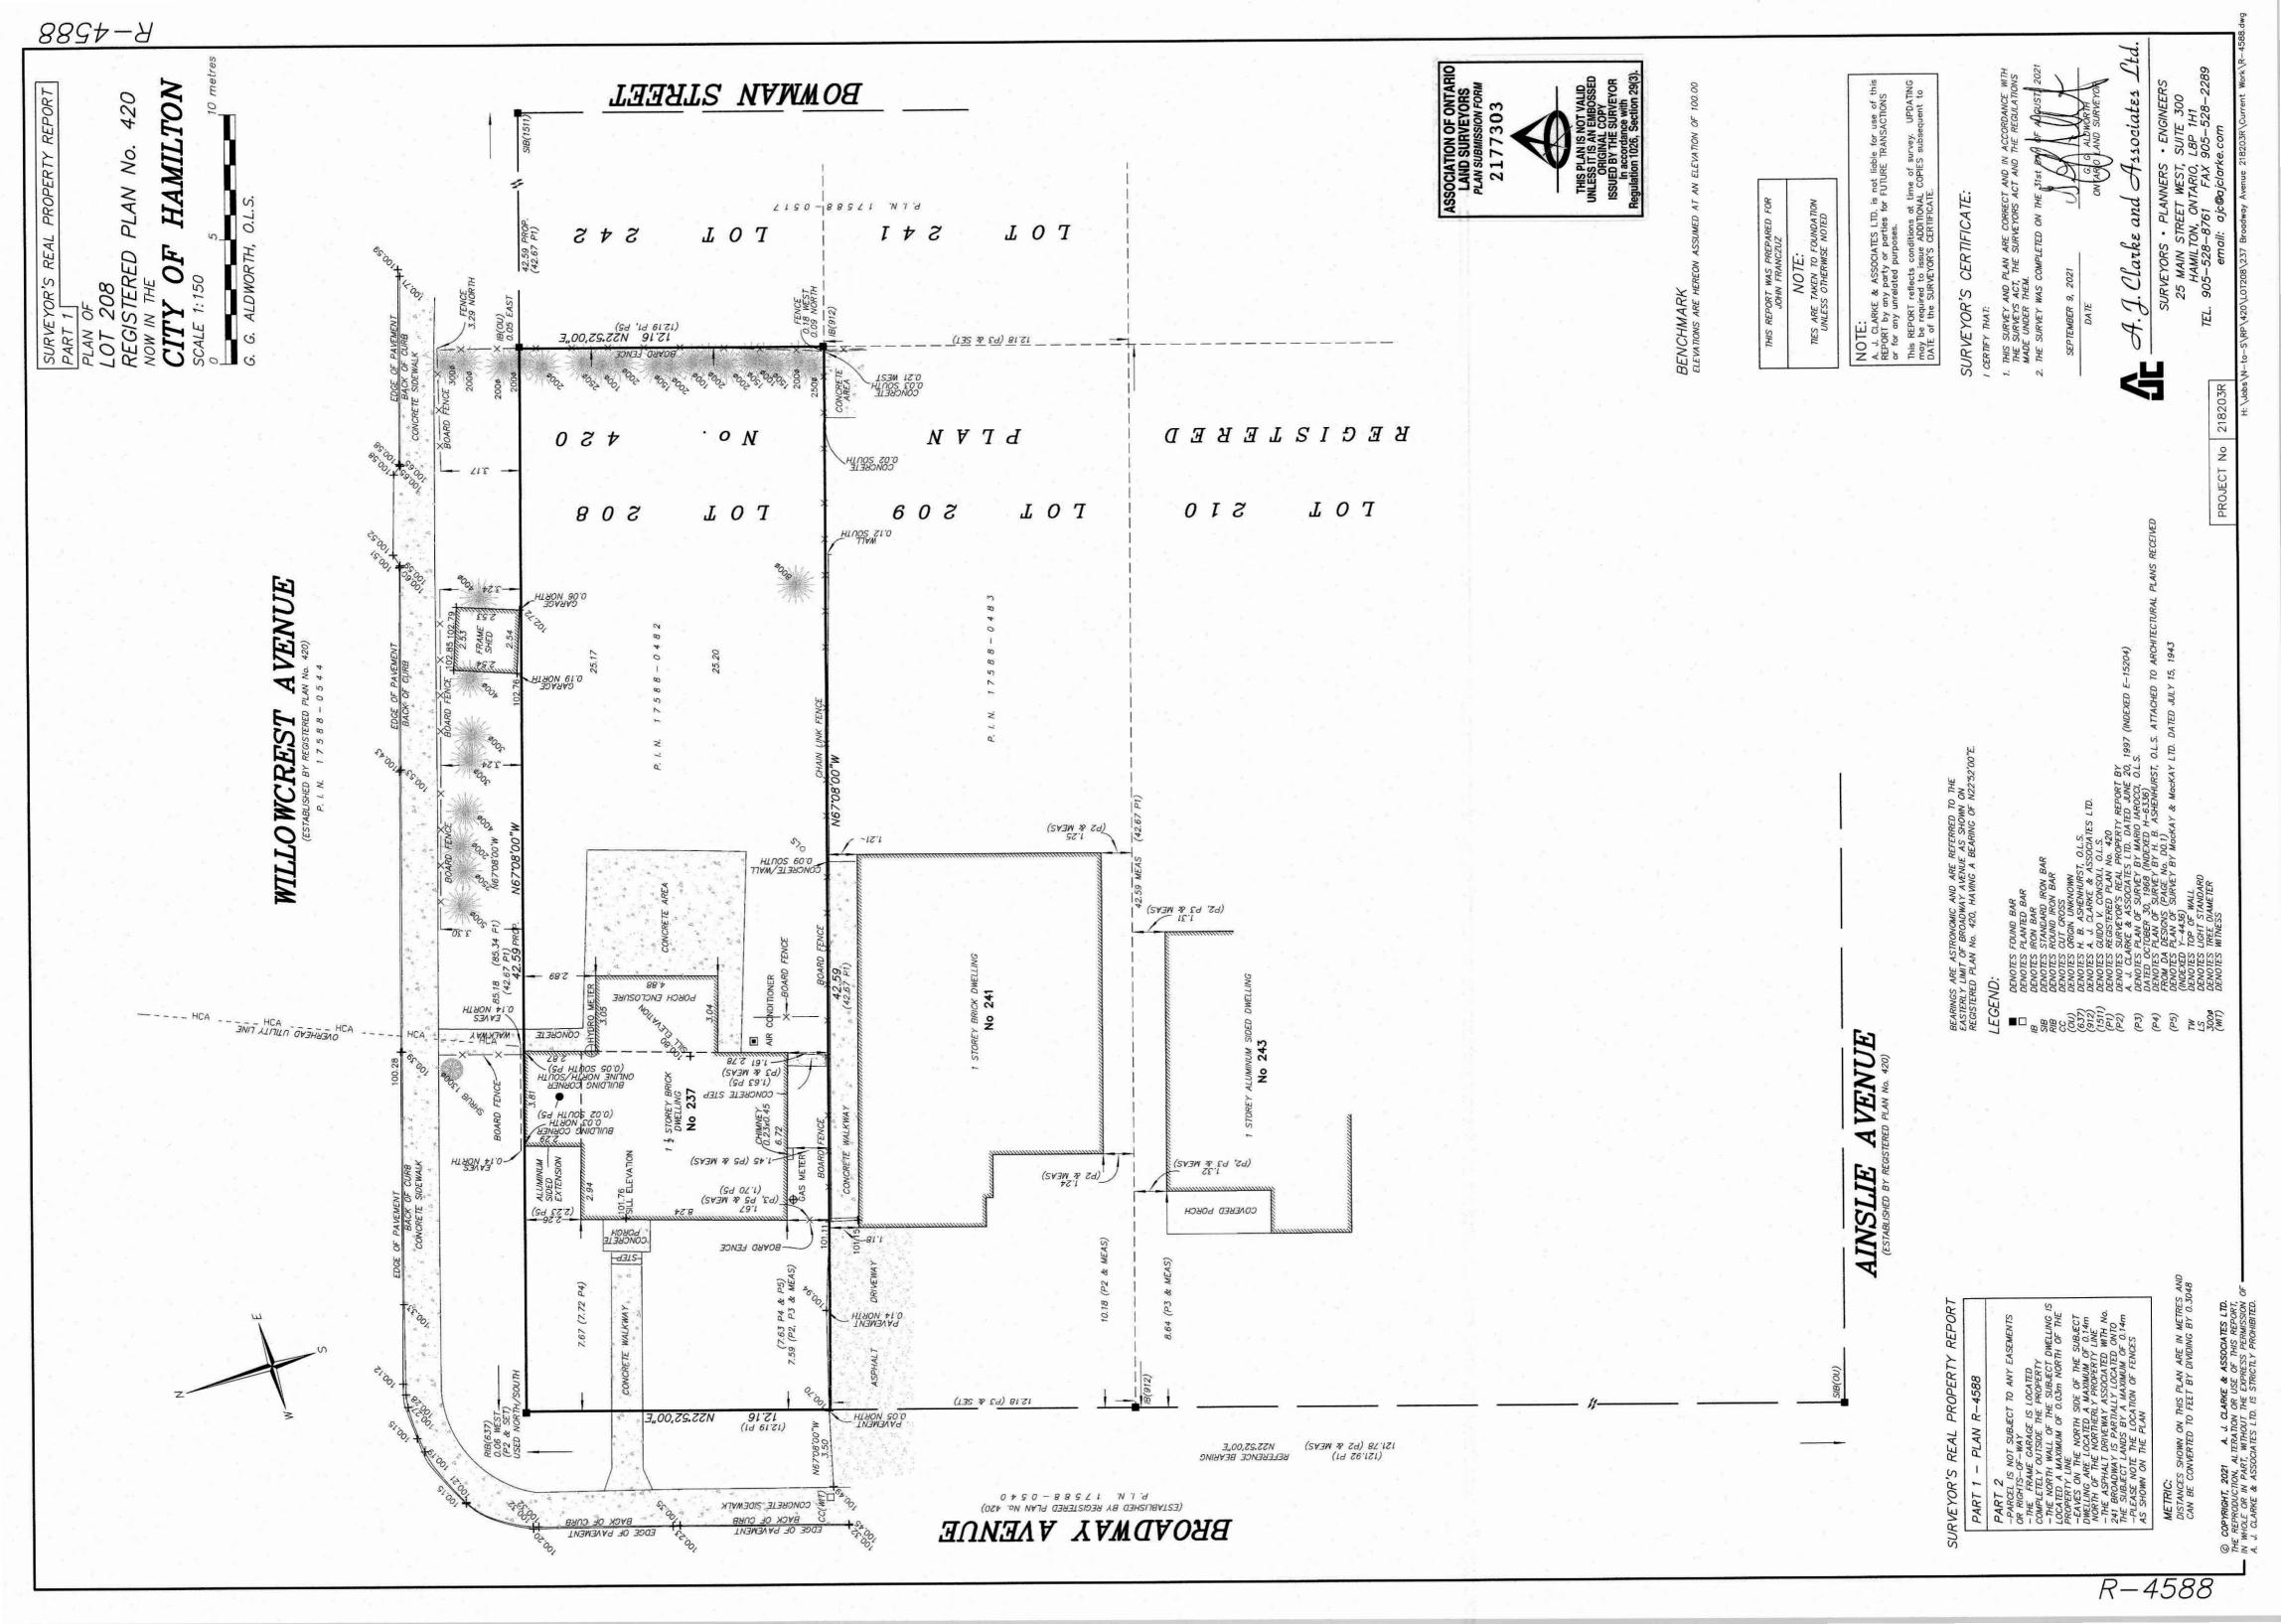

PROPOSED SITE PLAN

1:100

EXISTING SITE PLAN

1:100

PROJECT STATISTICS			
ADDRESS:	237 Broadway ave, Hamilton, Ontario, L8S 2H9		
ZONING:	IG: C/S - 1335, C/S - 1335a, and C/S-720		
		BY-LAW	EXISTING
MIN. LOT ARE	ĒA:	360 SM	517.90 SM
MIN. LOT FRO	ONTAGE:	12 M	12.16 M

GROSS FLOOR AREA		
	PRIMARY SUITE	SECONDARY SUITE
BASEMENT FLOOR	61.40 SM	67.82 SM
GROUND FLOOR	61.40 SM	67.82 SM
SECOND FLOOR (STAIR OPENING NOT INCL.)	56.77 SM	63.25 SM
TOTAL GFA:	179.57 SM	198.89 SM
OVERALL GFA:	378.46 SM	
Max. GFA calculated per Section 1(b) & 1(c) of A	Amending By-Law 95-0	2
BASEMENT FLOOR	60.61 SM	67.17 SM
GROUND FLOOR	61.40 SM	67.82 SM
SECOND FLOOR (STAIR OPENING NOT INCL.)	56.77 SM	63.25 SM
TOTAL GFA:	178.78 SM	198.24 SM
OVERALL GFA:		377.02 SM

SETBACKS			
	BY-LAW	PROPOSED	
FRONT - DWELLING	6 M	7.63 M	
REAR	7.5 M	21.08 M	
INTERIOR (FLANKAGE)	1.2 M	1.2 M	
INTERIOR	1.2 M	1.46 M	
MAX. HEIGHT	11 M	10.13 M	

LOT COVERAGE		
	AREA	PERCENTAGE
BUILDING FOOTPRINT	129.22 SM	24.95 %
PORCHES	13.58 SM	2.62 %
CONCRETE STEPS	5.03 SM	0.97 %
EXIST. CONC. WALKWAY	8.64 SM	1.67 %
PROPOSED PAVERS	74.10 SM	14.31 %
TOTAL LOT COVERAGE:	230.57 SM	44.52 %

LANDSCAPED SOFT AREA		
	AREA	PERCENTAGE
FRONT YARD AREA:	96.54 SM	
FRONT PORCH	6.79 SM	
CONC. STEPS	5.52 SM	
CONC. WALKWAY	8.64 SM	
WINDOW WELLS	1.48 SM	
TOTAL SOFT LANDSCAPE AREA:	74.11 SM	76.77 %

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# REAR ADDITION FOR DUPLEX CONVERSION

237 BROADWAY **AVENUE** HAMILTON, ONT.

L8S 2H9 PROJECT NO. SCALE 2021-04-21 1:100 DRAWN BY REVIEWED BY CB DA

SITE PLAN

SP1.02

DRAWING NO.

Complete reports available upon request

# Arborist Report and Tree Protection Plan

for

# 237 Broadway Avenue

**Prepared for:** 

Dan Acimovic

Dan@dadesigninc.ca

# Prepared by:

KENT NIELSEN
ISA CERTIFIED ON-0210A
FOREST TECHNICIAN, HORTICULTURAL JOURNEYMAN, TRAQ

P.O. Box 119
Acton, ON L7J 2M2

newworldarborist@gmail.com

416-540-5753

November 4, 2021



# PLANNING RATIONALE

November 2021

Subject Address:

237 Broadway Ave Hamilton, ON



**Committee of Adjustment** 

City Hall, 5<sup>th</sup> Floor, 71 Main St. W., Hamilton, ON L8P4Y5

Phone: (905) 546-2424 ext. 4221

Email: cofa@hamilton.ca


## APPLICATION FOR A MINOR VARIANCE

FOR OFFICE USE ONLY	ſ.
APPLICATION NO.	DATE APPLICATION RECEIVED
PAID	DATE APPLICATION DEEMED COMPLETE
SECRETARY'S SIGNATURE	

### The Planning Act

### **Application for Minor Variance or for Permission**

The undersigned hereby applies to the Committee of Adjustment for the City of Hamilton under Section 45 of the *Planning Act*, R.S.O. 1990, Chapter P.13 for relief, as described in this application, from the Zoning By-law.

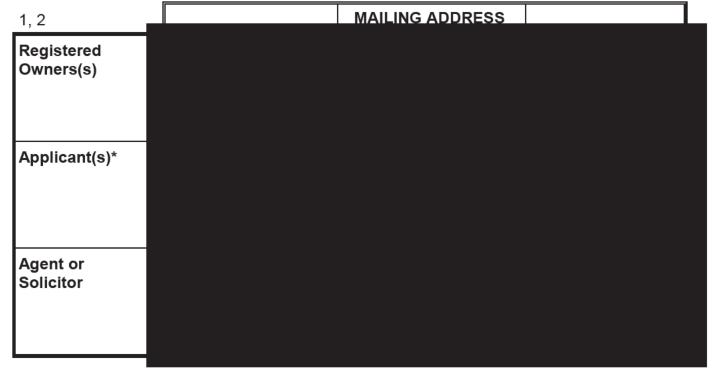

Note: Unless otherwise requested all communications will be sent to the agent, if any.

Names and addresses of any mortgagees, holders of charges or other encumbrances:
 N/A

# Additional sheets can be submitted if there is not sufficient room to answer the following questions. Additional sheets must be clearly labelled

4.	Nature and extent of relief applied for:					
	To permit a maximum Gross Floor Area, of 377.02 sq.m. whereas Hamilton Zoning By-Law 6593 and Section 1(b) & 1(c) of amending By-Law 95-02 permit a maximum Gross Floor Area of 233.05 sq.m.					
$\checkmark$	Secondary Dwelling Unit Reconstruction of Existing Dwelling					
5.	Why it is not possible to comply with the provisions of the By-law?					
	The current development built form requires a gross floor area as defined in amending By-law 95-02 Section 1(b) & 1(c) of 377.02 sq.m. Please see the Planning Justification Rationale included with this application for additional details.					
6.	Legal description and Address of subject lands (registered plan number and lot number or other legal description and where applicable, <b>street and street number</b> ):					
	Part 1, Plan of Lot 208, Registered Plan 420 now in the City of Hamilton 237 Broadway Avenue, Hamilton, ON.					
7.	PREVIOUS USE OF PROPERTY					
	Residential					
	Agricultural Vacant Other					
	Other					
8.1	If Industrial or Commercial, specify use					
8.2	Has the grading of the subject land been changed by adding earth or other material, i.e. has filling occurred?  Yes No Unknown					
8.3	Has a gas station been located on the subject land or adjacent lands at any time?  Yes O Unknown O					
8.4	Has there been petroleum or other fuel stored on the subject land or adjacent lands?  Yes No Unknown					
8.5	Are there or have there ever been underground storage tanks or buried waste on the subject land or adjacent lands?					
	Yes O No O Unknown					
8.6	Have the lands or adjacent lands ever been used as an agricultural operation where cyanide products may have been used as pesticides and/or sewage sludge was applied to the lands?					
	Yes O No Unknown					
8.7	Have the lands or adjacent lands ever been used as a weapon firing range?  Yes No Unknown					
8.8	Is the nearest boundary line of the application within 500 metres (1,640 feet) of the fill area of an operational/non-operational landfill or dump?  Yes  No  Unknown					
8.9	If there are existing or previously existing buildings, are there any building materials remaining on site which are potentially hazardous to public health (eg. asbestos, PCB's)?					
	Yes No Unknown O					

8.10	Is there any reason to believe the subject land may have been contaminated by former uses on the site or adjacent sites?				
	Yes O	No O Unkn	nown <u>O</u>		
8.11 8.12	What information did you use to determine the answers to 8.1 to 8.10 above?  Site observation.  If previous use of property is industrial or commercial or if YES to any of 8.2 to 8.10, a				
	previous use inventory showing all former uses of the subject land, or if appropriate, the land adjacent to the subject land, is needed.				
	Is the previous use inventory attached? Yes No				
9.	remediation of cor	at the City of Hamilton ntamination on the pro oval to this Application	perty which is the sub	the identification and oject of this Application – by  John Franczuz	
	Date		Signature Property	Owner(s)	
			Justin Franczuz, John Franczuz Print Name of Owner(s)		
10.	Dimensions of lands affected:				
	Frontage 12.16 m.				
	Depth	42.59 m.			
	Area	517.90			
	Width of street	approx. 8 m.			
11.	Particulars of all buildings and structures on or proposed for the subject lands: (Signound floor area, gross floor area, number of stories, width, length, height, etc. Existing:  A two-storey detached dwelling, approximately 100 sq.m. in size. The dwelling 10 m. x 9.44 m which includes a solarium in the rear yard, and an addition in the exterior side yard. The current dwelling currently has 3 bedrooms, 2 bathroom a kitchen, living room, and dining room.  Proposed				
	·				
	To partially demolish the existing two-storey residential dwelling and to construct a two-storey residential dwelling with a two-storey secondary suite attached to the main structure. The primary suite is proposed to be 179.57 sq.m. and the secondary suite 198.89 sq.m. for a total of 378.46 sq.m.				
12.	Location of all buildings and structures on or proposed for the subject lands; (Specify distance from side, rear and front lot lines)				
	Existing:				
	Existing Dwelling Setbacks: Front: 7.63 m., Rear: 28.27, Exterior SY: 0.00 m. Interior SY: 1.53m.				
	Proposed:				
	Proposed Dwelling Setbacks: Front: 7.63 m., Rear: 21.08 m. Exterior SY: 1.2. Interior SY: 1.46 m.				

22. Is the subject property the subject of a current application for consent under Section 53 of the *Planning Act*?

Yes No No

- 23. Additional Information
- 24. The applicant shall attach to each copy of this application a plan showing the dimensions of the subject lands and of all abutting lands and showing the location, size and type of all buildings and structures on the subject and abutting lands, and where required by the Committee of Adjustment such plan shall be signed by an Ontario Land Surveyor.