## NOTICE OF PUBLIC HEARING Minor Variance

## You are receiving this notice because you are either:

- Assessed owner of a property located within 60 metres of the subject property
- Applicant/agent on file, or
- Person likely to be interested in this application

APPLICATION	HM/A-22:127	SUBJECT	69 GLEN ROAD, HAMILTON
NO.:		PROPERTY:	
ZONE:	"E" (Multiple Dwellings,	<b>ZONING BY-</b>	Zoning By-law 6593 as Amended
	Lodges, Clubs and etc.)	LAW:	

## APPLICANTS: Owner Shih-Lung (Sean) Lee

The following variances are requested:

- 1. A minimum rear yard depth of 3.3m shall be permitted instead of the minimum 7.5m rear yard depth required.
- 2. A minimum landscaped area of 10.4% of the lot area shall be permitted instead of the minimum 25.0% of the lot area required to be maintained as landscaped area.
- 3. An uncovered porch including associated stairs shall be permitted to be located as close as 0.0m from a rear lot line and a side lot line instead of the minimum 0.5m setback required.

**PURPOSE & EFFECT:** To permit the construction of a rear yard sunroom addition as well as to permit the construction of a rear uncovered porch to the existing single family dwelling, notwithstanding that;

## Notes:

If the poured concrete patio on the easterly side is less than 0.15m in height it is considered landscaping and the requested variance to the side lot line is not required.

This Notice must be posted by the owner of any land which contains seven or more residential units so that it is visible to all residents.

This application will be heard by the Committee as shown below:

DATE:	Thursday, May 26, 2022
TIME:	2:05 p.m.
PLACE:	Via video link or call in (see attached sheet for details)
	To be streamed (viewing only) at
	www.hamilton.ca/committeeofadjustment

For more information on this matter, including access to drawings illustrating this request and other information submitted:

- Visit www.hamilton.ca/committeeofadjustment
- Email Committee of Adjustment staff at cofa@hamilton.ca

Call 905-546-CITY (2489) or 905-546-2424 extension 4221, 4130, or 3935

### **PUBLIC INPUT**

**Written:** If you would like to submit written comments to the Committee of Adjustment you may do so via email or hardcopy. Please see attached page for complete instructions, <u>including deadlines</u> for submitting to be seen by the Committee.

**Orally:** If you would like to speak to this item at the hearing you may do so via video link or by calling in. Please see attached page for complete instructions, including deadlines for registering to participate.



Subject Lands

DATED: May 10, 2022

Jamila Sheffield, Secretary-Treasurer Committee of Adjustment Information respecting this application is being collected under the authority of the Planning Act, R.S.O., 1990, c. P. 13. All comments and opinions submitted to the City of Hamilton on this matter, including the name, address, and contact information of persons submitting comments and/or opinions, will become part of the public record and will be made available to the Applicant and the general public, and may include posting electronic versions.

## PARTICIPATION PROCEDURES

### Written Submissions

Members of the public who would like to participate in a Committee of Adjustment meeting are able to provide comments in writing or via email in advance of the meeting. Comments can be submitted by emailing cofa@hamilton.ca or by mailing the Committee of Adjustment, City of Hamilton, 71 Main Street West, 5th Floor, Hamilton, Ontario, L8P 4Y5. Comments must be received by noon two days before the Hearing.

Comments can also be placed in the drop box which is located at the back of the 1st Floor of City Hall, 71 Main Street West. All comments received by noon two business days before the meeting will be forwarded to the Committee members.

Comments are available two days prior to the Hearing and are available on our website: www.hamilton.ca/committeeofadjustment

## **Oral Submissions During the Virtual Meeting**

Members of the public are also able to provide oral comments regarding Committee of Adjustment Hearing items by participating through Webex via computer or phone. Participation in this format requires pre-registration in advance. **Interested members of the public must register by noon the day before the hearing.** 

To register to participate by Webex either via computer or phone, please contact Committee of Adjustment staff by email cofa@hamilton.ca or by phone at 905-546-2424 ext. 4221. The following information is required to register: Committee of Adjustment file number that you wish to speak to, the hearing date, name and address of the person wishing to speak, if they will be connecting via phone or video, and if applicable the phone number they will be using to call in. A separate registration for each person wishing to speak is required. Upon registering for a meeting, members of the public will be emailed a link for the Webex meeting the Wednesday afternoon before the hearing. The link must not be shared with others as it is unique to the registrant.

All members of the public who register will be contacted by Committee Staff to confirm details of the registration prior to the Hearing and provide an overview of the public participation process.

We hope this is of assistance and if you need clarification or have any questions, please email cofa@hamilton.ca or by phone at 905-546-2424 ext. 4221.

Please note: Webex (video) participation requires either a compatible computer or smartphone and an application (app/program) must be downloaded by the interested party in order to participate. It is the interested party's responsibility to ensure that their device is compatible and operating correctly prior to the Hearing.

		Item
		1
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## Name of Practice: Two Row Architect New Porch & Sunroom Addition 1804 Sixth Line Ohsweken, Ontario NOA 1M0 (519) 445-2137 Name of Project: Name of Project: New Porch & Sunroom Addition Address: 69 Glen St, Hamilton, Ontario

tem			AKIO BU	ILDING COI	UE DATA MA	ATRIX PARTS	. J & 9				OE	BC REFER	KENCE
1	PROJECT DESC	RIPTION				<ul><li> New</li><li> Addition</li><li> Alteratio</li><li> Change</li></ul>	n	Part 11		P	art 3		Part 9
2	MAJOR OCCUPA	ANCY (S)				Group C - Res	sidential occupa	ancies		3.1.2.1.		9.10	0.2.
3	BUILDING AREA		Existin	g: -		New: 14.6 m <sup>2</sup>	(158 SF)			1.4.1.2.		1.1.	3.2.
	GROSS AREA		Existing			New: 14.6 m² (158 SF)			1.4.1.2. 1.4.1.2. & 3.2.1.1.		1.1.3.2. 2.1.1.3.		
	NUMBER OF ST	OREYS	Above	Grade: 2 St	tories	Below Grade: -						2.1.	
	HEIGHT OF BUIL	DING				7.32 m (24'-0"				3.1.13.7.		2.1.	.1.3.
	NUMBER OF STI	REETS/ACCES	SS ROUT	ES		Facing 2 Stree	ets			3.2.2.10 & 3	3.2.5		
3	BUILDING CLAS	SIFICATION			1	OBC 3.2.2.47	. Group C, up to	o 3 Storey's		3.2.2.47.			
)	SPRINKLER SYS	STEM PROPO	SED				base in lie	re building ement only eu of roof rating		3.2.2.47		9.10	0.8.
	CTANDDIDE DE	NUDED						required	NO	3.2.9.			
0	STANDPIPE REC					 Y □			NO	3.2.4.			
2	WATER SERVIC		ADEOUA	TF		Y			NO	3.2.5.7			
3	HIGH BUILDING	L/SUFFET IS	ADEQUA						NO	3.2.6.			
14	CONSTRUCTION	J PERMITTED		☐ Coml	bustible	□ Non-con		Both	110	3.2.2.42		9.10	0.6
	CONSTRUCTION				bustible	☐ Non-con		Both					
	MEZZANINE(S) A	D based on	N/A	m²/pe	erson		design of bu	uilding		3.1.17.1.			
	_	D based on			erson	NGED	design of bu	uilding		3.1.17.1.			
	_	D based on			><	NGED	design of bu	uilding		3.1.17.1.			
7	OCCUPANT LOA  BARRIER FREE	DESIGN		☐ m²/pe	><	■ NO	design of bu	uilding		3.8.		9.5.	2.
7 8	DOCCUPANT LOAD BARRIER FREE HAZARDOUS SU	DESIGN		☐ m²/pe	TING UNCHA		(explain)			3.8. 3.3.1.2.			
7 8	BARRIER FREE HAZARDOUS SU Required Fire Resistance	DESIGN	Horizonta	☐ m²/pe	TING UNCHA	■ NO		gn No.		3.8.		9.10 9.10	0.8. 0.9.
7 8	DCCUPANT LOA  BARRIER FREE  HAZARDOUS SU  Required	DESIGN	Horizonta	☐ m²/pe  EXIST  ☐ YES ☐ YES ☐ YES	TING UNCHA	■ NO	(explain)	gn No.		3.8. 3.3.1.2. 3.1.7.		9.10 9.10	0.8.
7 8	BARRIER FREE HAZARDOUS SU Required Fire Resistance	DESIGN JBSTANCES	Horizonta	☐ m²/pe  EXIST  ☐ YES ☐ YES ☐ YES	TING UNCHA	■ NO	(explain)	gn No.		3.8. 3.3.1.2. 3.1.7.		9.10 9.10	0.8. 0.9.
7 8	BARRIER FREE HAZARDOUS SU Required Fire Resistance	DESIGN JBSTANCES	Horizonta	☐ m²/pe  EXIST  ☐ YES ☐ YES ☐ YES	TING UNCHA	■ NO	(explain)	gn No.		3.8. 3.3.1.2. 3.1.7.		9.10 9.10	0.8. 0.9.
7 8	BARRIER FREE HAZARDOUS SU Required Fire Resistance	DESIGN JBSTANCES Floor Roof	Horizonta FRF	☐ m²/pe  EXIST  ☐ YES ☐ YES ☐ YES	S S	■ NO	(explain)	gn No. on (D-2) gn No.		3.8. 3.3.1.2. 3.1.7.		9.10 9.10	0.8. 0.9.
7 8	BARRIER FREE HAZARDOUS SU Required Fire Resistance	DESIGN JBSTANCES Floor Roof Mezzanine	Horizonta FRF	☐ m²/pe  ☐ m²/pe  EXIST  ☐ YES ☐ YES ☐ YES ☐ Hour)	S S	■ NO ■ NO	(explain)	gn No. on (D-2) gn No.		3.8. 3.3.1.2. 3.1.7.		9.10 9.10	0.8. 0.9.
7 8	BARRIER FREE HAZARDOUS SU Required Fire Resistance	DESIGN JESTANCES Floor Roof Mezzanine	Horizonta FRF	☐ m²/pe  ☐ m²/pe  EXIST  ☐ YES ☐ YES ☐ YES ☐ Hour)	S S	■ NO	(explain)	gn No. on (D-2) gn No.		3.8. 3.3.1.2. 3.1.7.		9.10 9.10	0.8. 0.9.
7 8	BARRIER FREE HAZARDOUS SU Required Fire Resistance	DESIGN JBSTANCES Floor Roof Mezzanine	Horizonta FRF	☐ m²/pe  ☐ m²/pe  EXIST  ☐ YES ☐ YES ☐ YES ☐ Hour)	S S	■ NO ■ NO	(explain)	gn No. on (D-2) gn No.		3.8. 3.3.1.2. 3.1.7.		9.10 9.10	0.8. 0.9.
7 8 9	BARRIER FREE HAZARDOUS SU Required Fire Resistance	DESIGN DESIGN DESTANCES Floor Roof Mezzanine Floor Roof Mezzanine	Horizonta FRF - - Supporti	☐ m²/pe ☐ m²/pe ☐ YES ☐ YES ☐ YES ☐ Hour)  RR of ing Members	S EXISTING	■ NO ■ NO	(explain)	gn No. on (D-2) gn No.		3.8. 3.3.1.2. 3.1.7.		9.10 9.10	0.8. 0.9.
7 8 9	BARRIER FREE HAZARDOUS SU Required Fire Resistance Rating (FRR)	DESIGN JBSTANCES Floor Roof Mezzanine Floor ATION - Cons Are	Horizonta FRF	☐ m²/pe ☐ m²/pe ☐ YES ☐ YES ☐ YES ☐ Hour)  RR of ing Members	S EXISTING	■ NO ■ NO ■ NO  GUNCHANGE	(explain)  Listed Designor Description  Listed Designor Description  ED  Proposed	gn No. gn No. in (D-2)  FRR	Listed	3.8. 3.3.1.2. 3.1.7. 3.2.3.7.	Comb.	9.10 9.10 9.10	0.8. 0.9. 0.10.6.
17 18 19	BARRIER FREE HAZARDOUS SU Required Fire Resistance Rating (FRR)  SPATIAL SEPAR	DESIGN IBSTANCES Floor Roof Mezzanine Floor Roof Mezzanine ATION - Cons	Horizonta FRF	☐ m²/pe ☐ m²/pe ☐ YES ☐ YES ☐ YES ☐ Hour)  RR of ing Members  f Exterior Wa	EXISTING	■ NO ■ NO  GUNCHANGE	(explain)	gn No. in (D-2)  gn No. in (D-2)  FRR (hours)	Listed Desig Descr	3.8. 3.3.1.2. 3.1.7. 3.2.3.7.	Comb. Const.	9.10 9.10	0.8. 0.9. 0.10.6.  Distribution Non-comb
17 18 19	BARRIER FREE HAZARDOUS SU Required Fire Resistance Rating (FRR)	DESIGN JBSTANCES Floor Roof Mezzanine Floor ATION - Cons Are EBF	Horizonta FRF	☐ m²/pe ☐ m²/pe ☐ YES ☐ YES ☐ YES ☐ Hour)  RR of ing Members  f Exterior Wa	EXISTING  L/H  or	NO NO NO Permitted Max % of	(explain)  Listed Designor Description  Listed Designor Description  Proposed % of	gn No. in (D-2)  gn No. in (D-2)  FRR (hours)	Desig	3.8. 3.3.1.2. 3.1.7. 3.2.3.7.		9.10 9.10 9.10	0.8. 0.9. 0.10.6.  Distribution Non-comb
15 16 17 18 19	BARRIER FREE HAZARDOUS SU Required Fire Resistance Rating (FRR)  SPATIAL SEPAR Wall North South	DESIGN JBSTANCES Floor Roof Mezzanine Floor ATION - Cons Are EBF	Horizonta FRF	☐ m²/pe ☐ m²/pe ☐ YES ☐ YES ☐ YES ☐ Hour)  RR of ing Members  f Exterior Wa	EXISTING  L/H  or	NO NO NO Permitted Max % of	(explain)  Listed Designor Description  Listed Designor Description  Proposed % of	gn No. in (D-2)  gn No. in (D-2)  FRR (hours)	Desig	3.8. 3.3.1.2. 3.1.7. 3.2.3.7.		9.10 9.10 9.10	0.8. 0.9. 0.10.6.  Distribution Non-comb
7 8 9	BARRIER FREE HAZARDOUS SURequired Fire Resistance Rating (FRR)  SPATIAL SEPAR Wall North	DESIGN JBSTANCES Floor Roof Mezzanine Floor ATION - Cons Are EBF	Horizonta FRF	☐ m²/pe ☐ m²/pe ☐ YES ☐ YES ☐ YES ☐ Hour)  RR of ing Members  f Exterior Wa	EXISTING  L/H  or	Permitted Max % of Openings	(explain)  Listed Designor Description  Listed Designor Description  Proposed % of	gn No. in (D-2)  gn No. in (D-2)  I FRR (hours)	Desig	3.8. 3.3.1.2. 3.1.7. 3.2.3.7.		9.10 9.10 9.10	0.8. 0.9. 0.10.6.  Distribution Non-comb

## ARCHITECTURAL DRAWINGS

A0.01 - COVER PAGE

SP1.01 - SITE PLAN

SP1.01A - SITE PLANS (CITY OF HAMILTON)

A1.01 - FLOOR PLAN

A1.02 - FOUNDATION PLAN

A2.01 - ELEVATIONS

A3.01 - SECTION DETAILS

A4.01 - BUILDING SECTION & DETAILS

## TWO ROW ARCHITECT

P.O. Box 77 - 1804 6th Line + Chiefswood Rd. Ohsweken, ON. NOA 1MO 519 445-2137 www.tworow.com info@tworow.com

## DRAWINGS ARE NOT TO BE SCALED

Contractor must verify all dimensions on the drawings and report any discrpancies to the architect before proceeding with the work.

All drawings and specifications are instruments of service and the property of the Architect, and must be returned at the completion of the work.

Revisions:
All previous issues of this drawing are superseded.



## Professional Certification

ect:

NEW PORCH & SUNROOM ADDITION


69 Glen Rd, Hamilton

COVER

scale: N.T.S.
drawn by: JH
reviewed by: BP
job number: 21080
plot date: 11 30 2021

drawing number:

A0.01

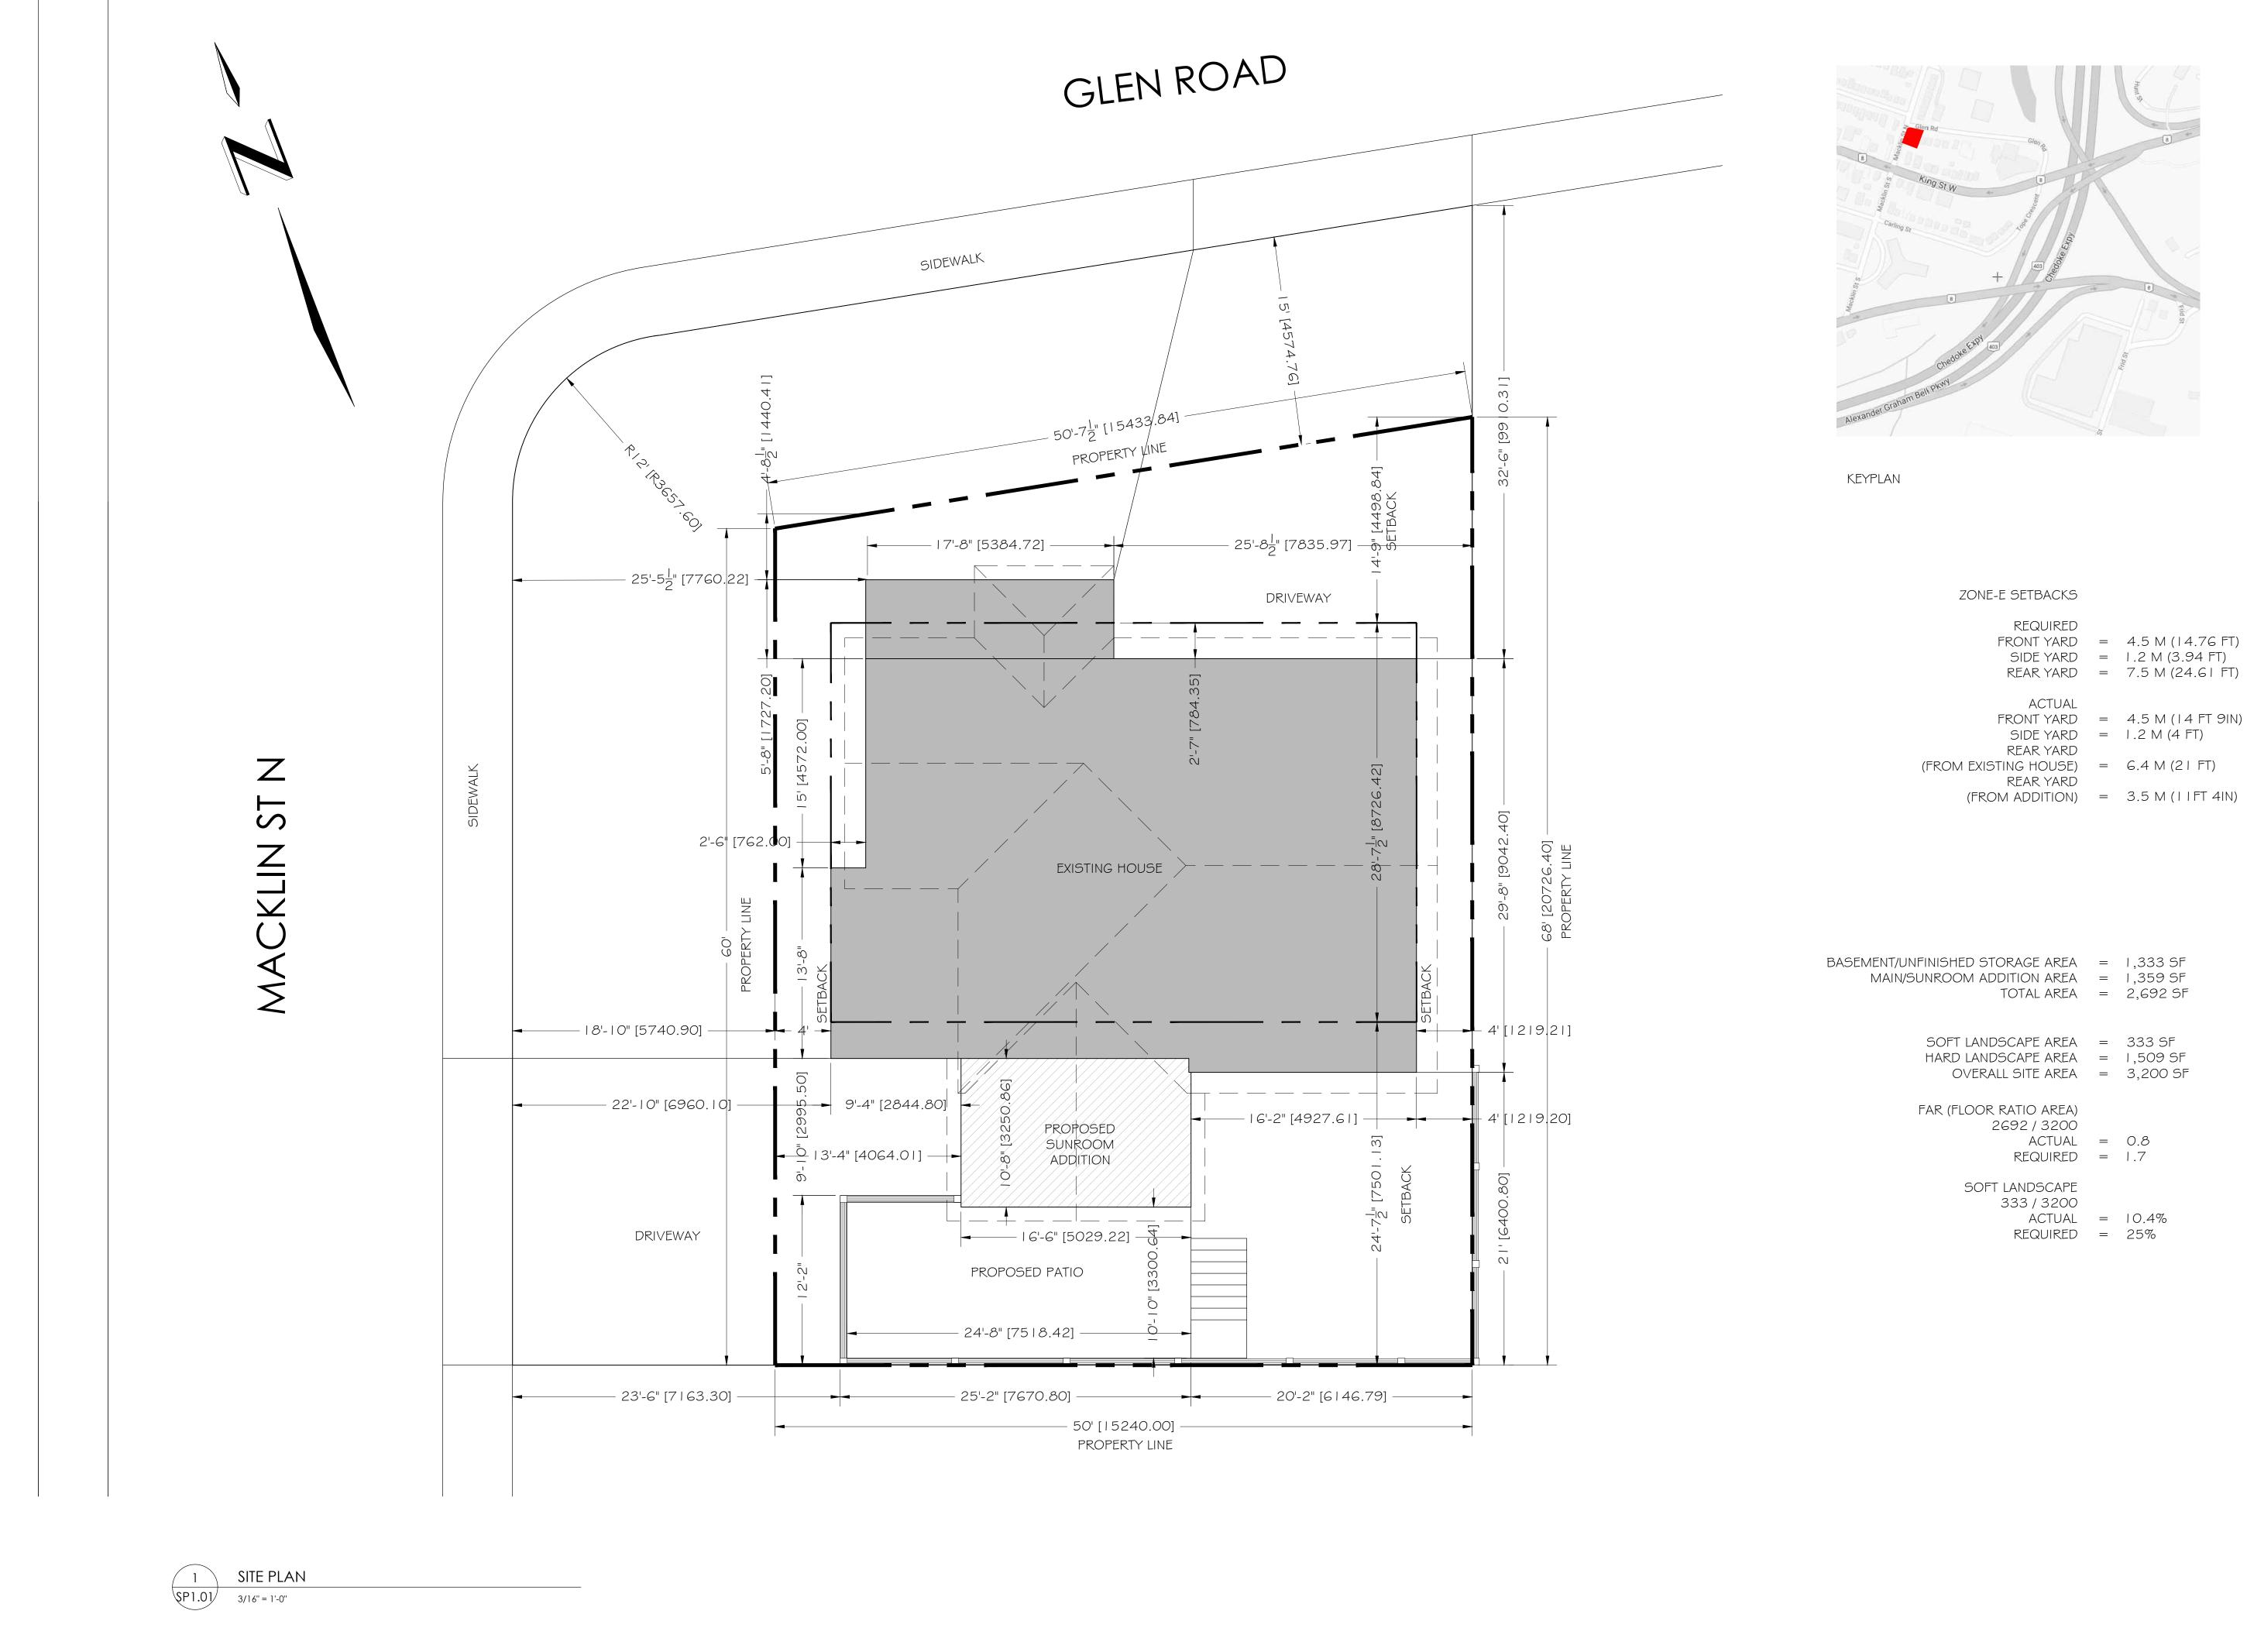

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HARD LANDSCAPE AREA = 1,509 SF OVERALL SITE AREA = 3,200 SF

REQUIRED = 1.7

Revisions: All previous issues of this drawing are superseded.



Professional Certification

NEW PORCH & SUNROOM ADDITION


69 Glen Rd, Hamilton sheet:


SITE PLAN

N.T.S. scale: drawn by: reviewed by: 21080 job number: 11 30 2021 plot date:

drawing number:

SP1.01

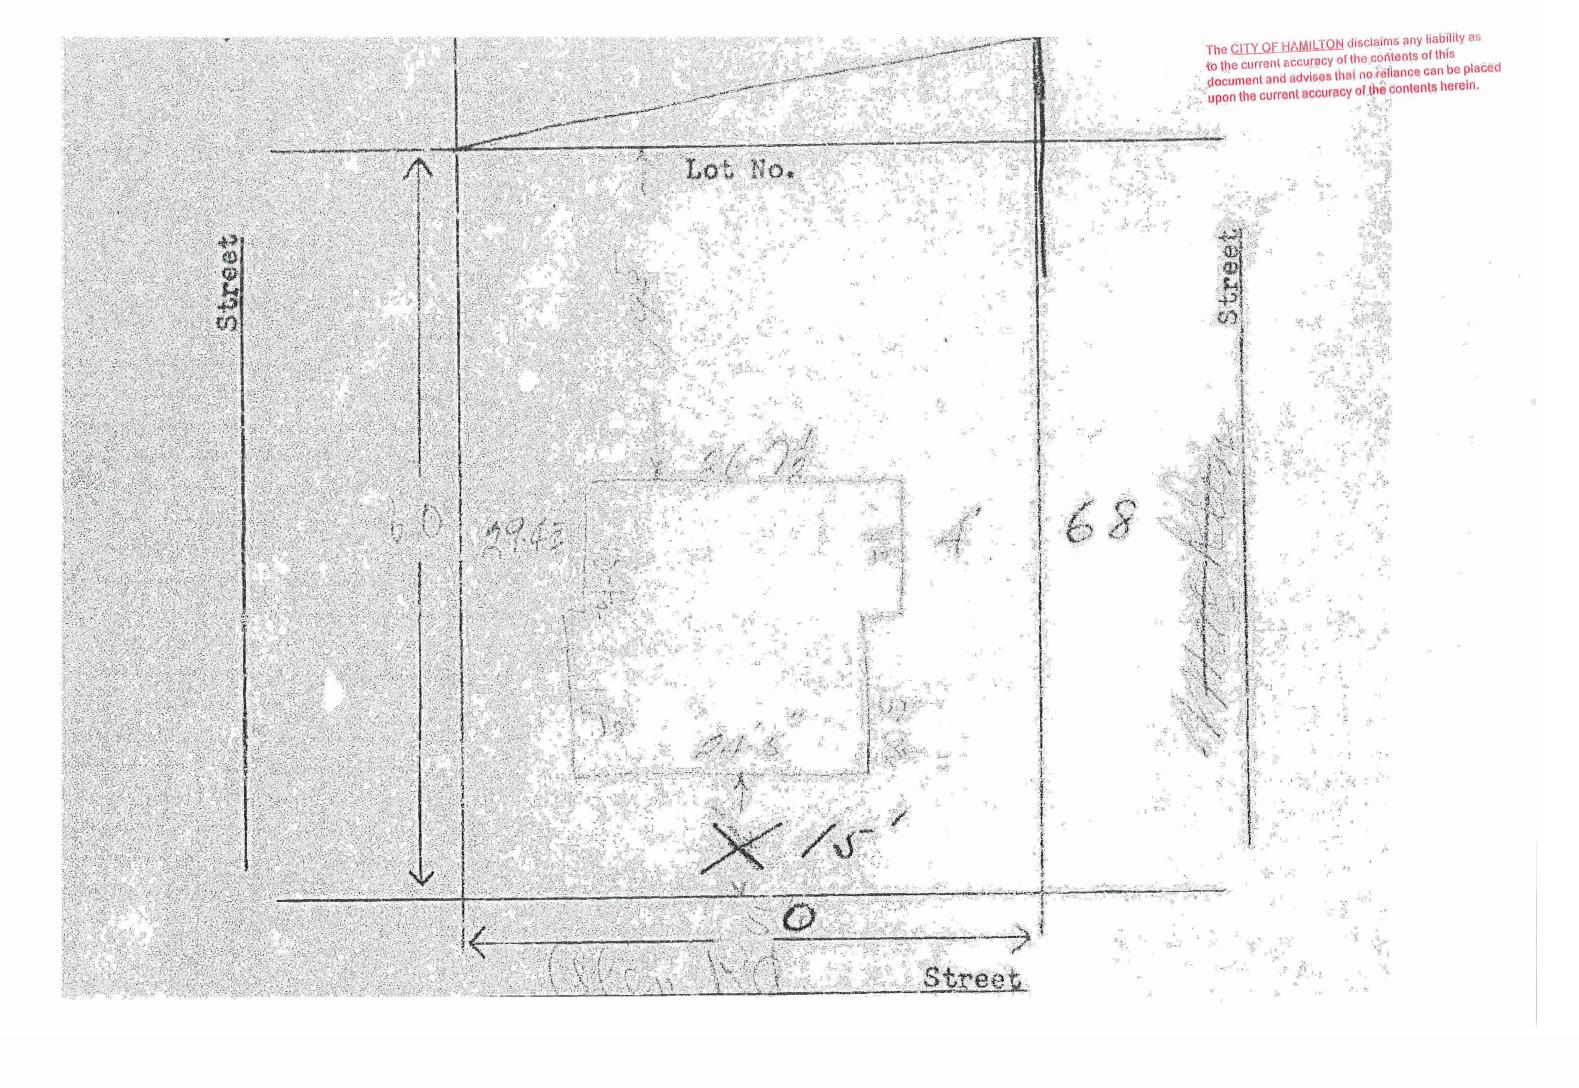

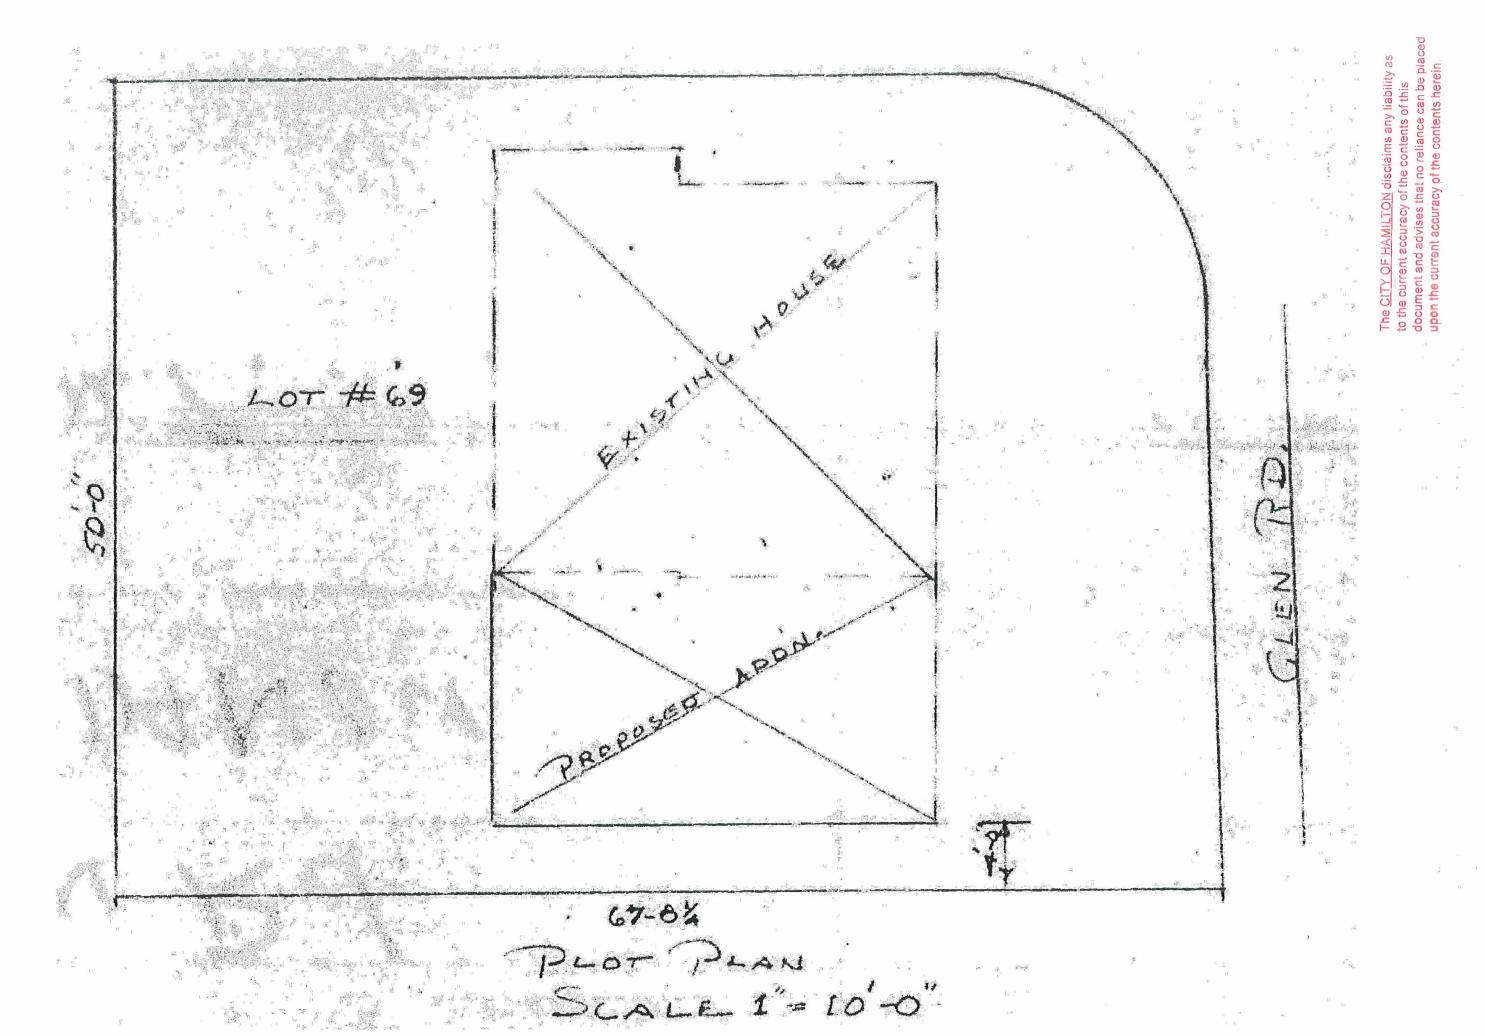

# TWO ROW ARCHITECT

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Revisions:

All previous issues of this drawing are superseded.

ASSOCIA



## Professional Certification

project:

NEW PORCH & SUNROOM ADDITION

69 Glen Rd, Hamilton

neet:

SITE PLAN (CITY OF HAMILTON)

scale:	N.T.S.
drawn by:	JH
reviewed by:	ВР
job number:	21080
plot date:	11 30 2021

drawing number:

SP1.01A

## GLEN ROAD DRIVEWAY PORCH 29" X 60" 75" X 33" 24" SILL HEIGHT 47" SILL HEIGHT BEDROOM 11'-3" J- DN 30"X80" KITCHEN 75" X 33" 72"X80" -47" SILL HEIGHT PROPOSED SUNROOM APPROX. 158 SF (UNHEATED) NEW WINDOWS TO BE CHOSEN BY OWNER, INSTALLED BY CONTRACTOR — I 5'-6" — 40"X54" 40"X54" 40"X54" DRIVEWAY PROPOSED NEW POURED CONCRETE PATIO APPROX. 413 SF 10'-10" PROPOSED NEW POURED CONCRETE RAISED PATIO APPROX. 267 SF — 24'-8" — NEW P.T. FENCE

FLOOR PLAN

3/16" = 1'-0"

WALL TYPE LEGEND

## W1 - WALL TYPE

- ½" (12.7 mm) TYPE X GYPSUM WALL BOARD
- 2X6 WOOD STUDS @ 16" (406 mm) O.C.
- 5/w 3" SPRAY FOAM INSULATION R20
   1" RIGID INSULATION R5
- ½" 2X2 VERTICAL STRAPPING @ 24" O.C.
- ½" VERTICAL BOARD & BATTEN SIDING

## W2 - WALL TYPE

- 2" POLY RIGID INSULATION
- WALL DAMP PROOFING (BITUMINOUS)
- OBC 9.13.4.2.(3), OF DIVISION B
- 8" POURED CONCRETE FOUNDATION

TWO ROW
ARCHITECT

P.O. Box 77 - 1804 6th Line + Chiefswood Rd. Ohsweken, ON. NOA 1MO 519 445-2137 www.tworow.com info@tworow.com

DRAWINGS ARE NOT TO BE SCALED

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Revisions :
All previous issues of this drawing are superseded.

ASSO



Professional Certification

project:

NEW PORCH & SUNROOM ADDITION

69 Glen Rd, Hamilton

FLOOR PLAN

scale: 3/16" = 1'- 0"

drawn by: JH

reviewed by: BP

job number: 21080

plot date: 11 30 2021

drawing number:

A1.01

## GLEN ROAD DRIVEWAY 96"X96" 36" x 24" 50" SILL HEIGHT 21'-9 1/2" — LIVING ROOM 14'-2" GARAGE 28'-4" WASHROOM - 14'-8" <del>--</del> UTILITY ROOM 7'-9"/1 24"X80" 9'-10" - DASHED LINE DENOTES FOOTINGS PROPOSED NEW POURED CONCRETE 11'-2" 12'-2" 24'-2" -

FOUNDATION PLAN

3/16" = 1'-0"

WALL TYPE LEGEND

## W1 - WALL TYPE

- ½" (12.7 mm) TYPE X GYPSUM WALL BOARD
- 2X6 WOOD STUDS @ 16" (406 mm) O.C.
- % 3" SPRAY FOAM INSULATION R20 - 1" RIGID INSULATION R5
- $\frac{1}{2}$ " 2X2 VERTICAL STRAPPING @ 24" O.C.
- ½" VERTICAL BOARD & BATTEN SIDING

## W2 - WALL TYPE

- 2" POLY RIGID INSULATION
- WALL DAMP PROOFING (BITUMINOUS)
- OBC 9.13.4.2.(3), OF DIVISION B - 8" POURED CONCRETE FOUNDATION

P.O. Box 77 - 1804 6th Line + Chiefswood Rd. Ohsweken, ON. NOA 1MO 519 445-2137 www.tworow.com info@tworow.com

TWO ROW ARCHITECT

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Revisions:

All previous issues of this drawing are superseded.



Professional Certification

NEW PORCH & SUNROOM ADDITION

69 Glen Rd, Hamilton


FOUNDATION PLAN


3/16" = 1'- 0" scale: drawn by: reviewed by: 21080 job number: 11 30 2021


drawing number:

plot date:

A1.02

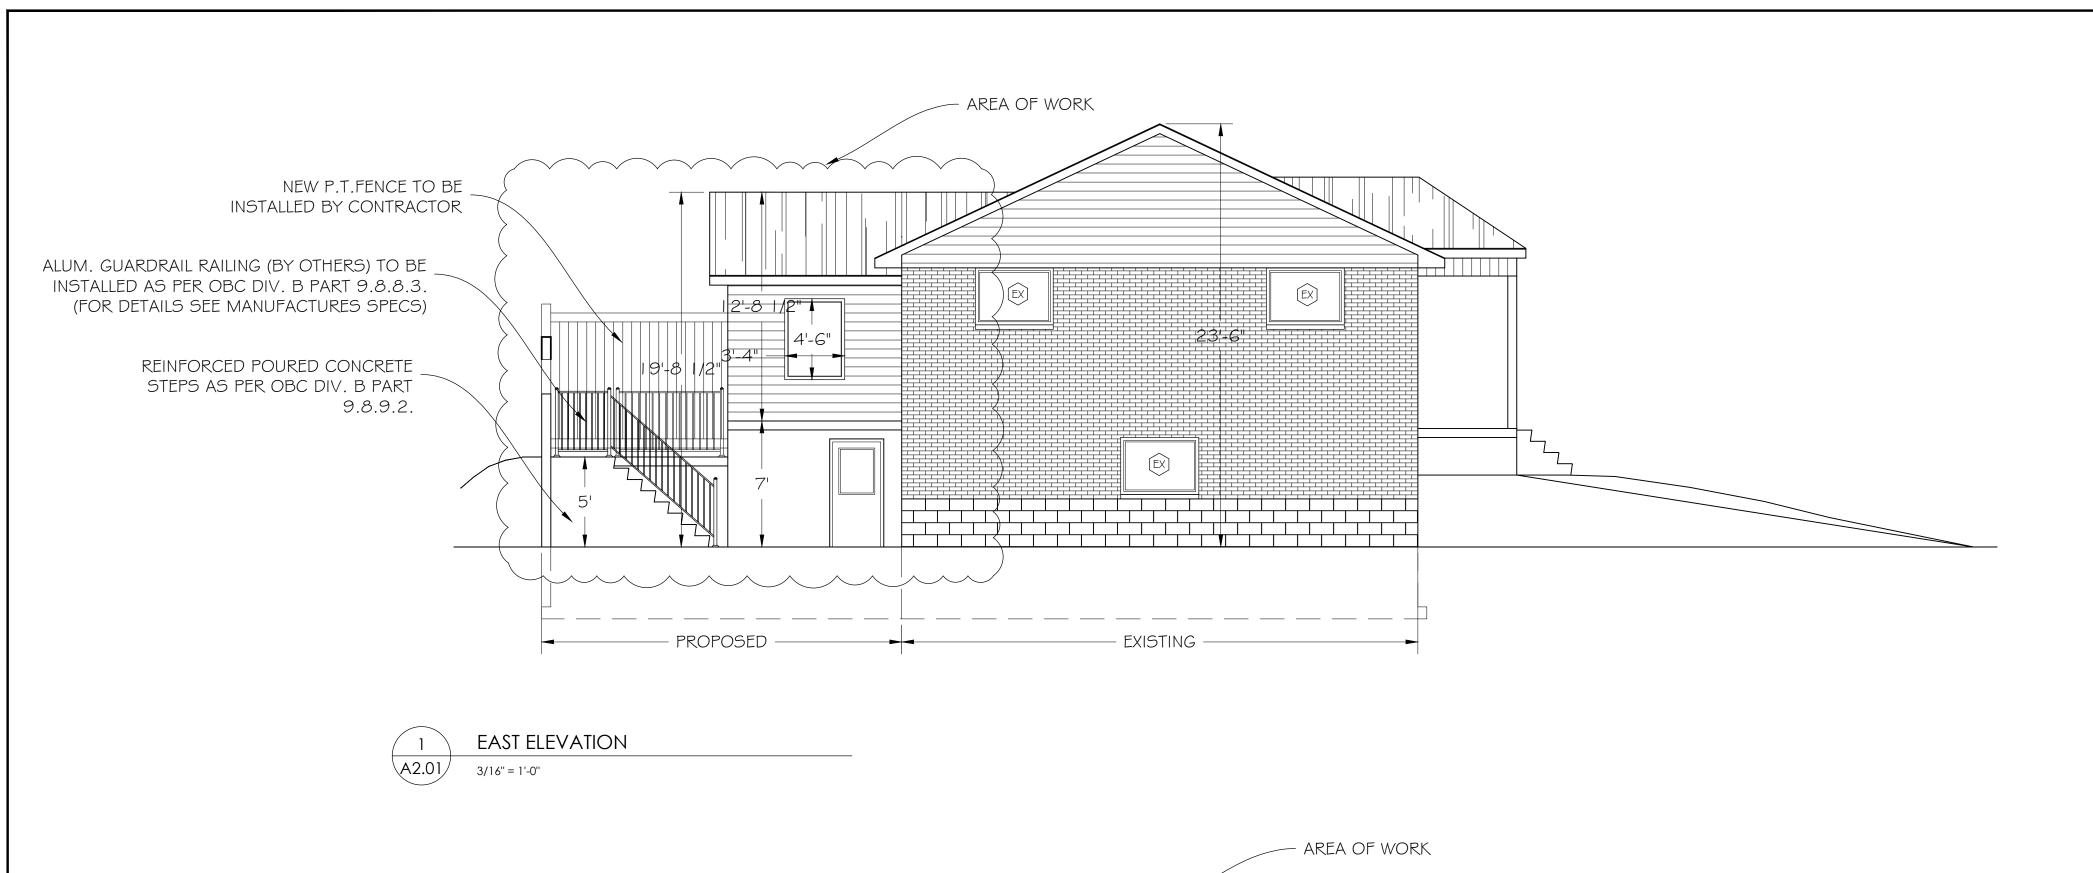

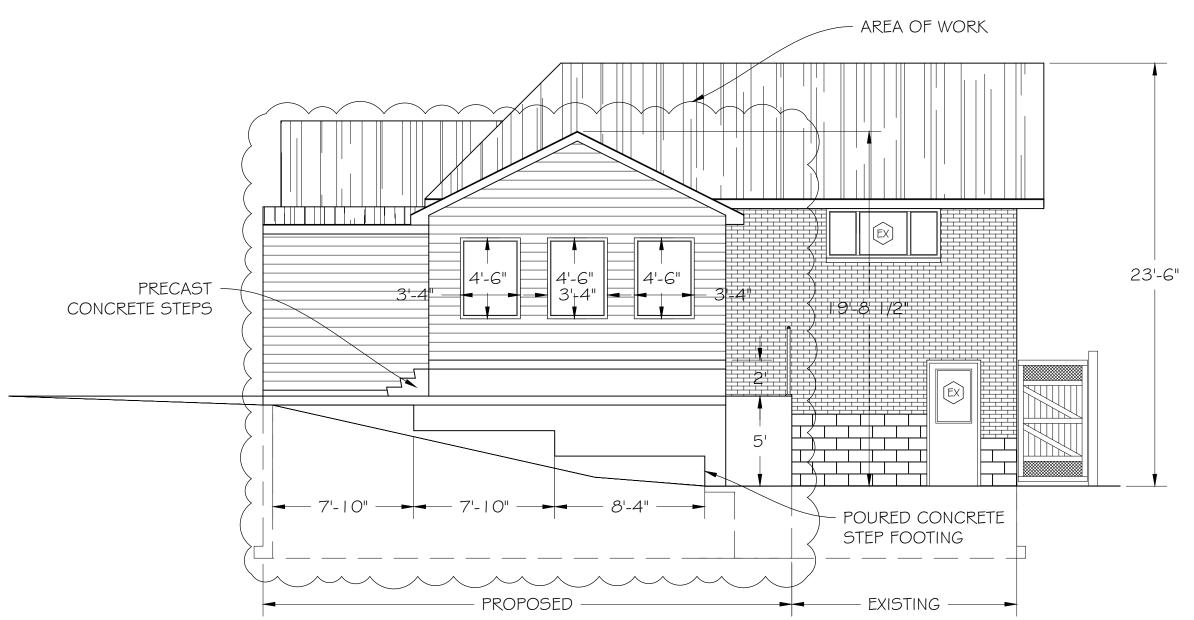

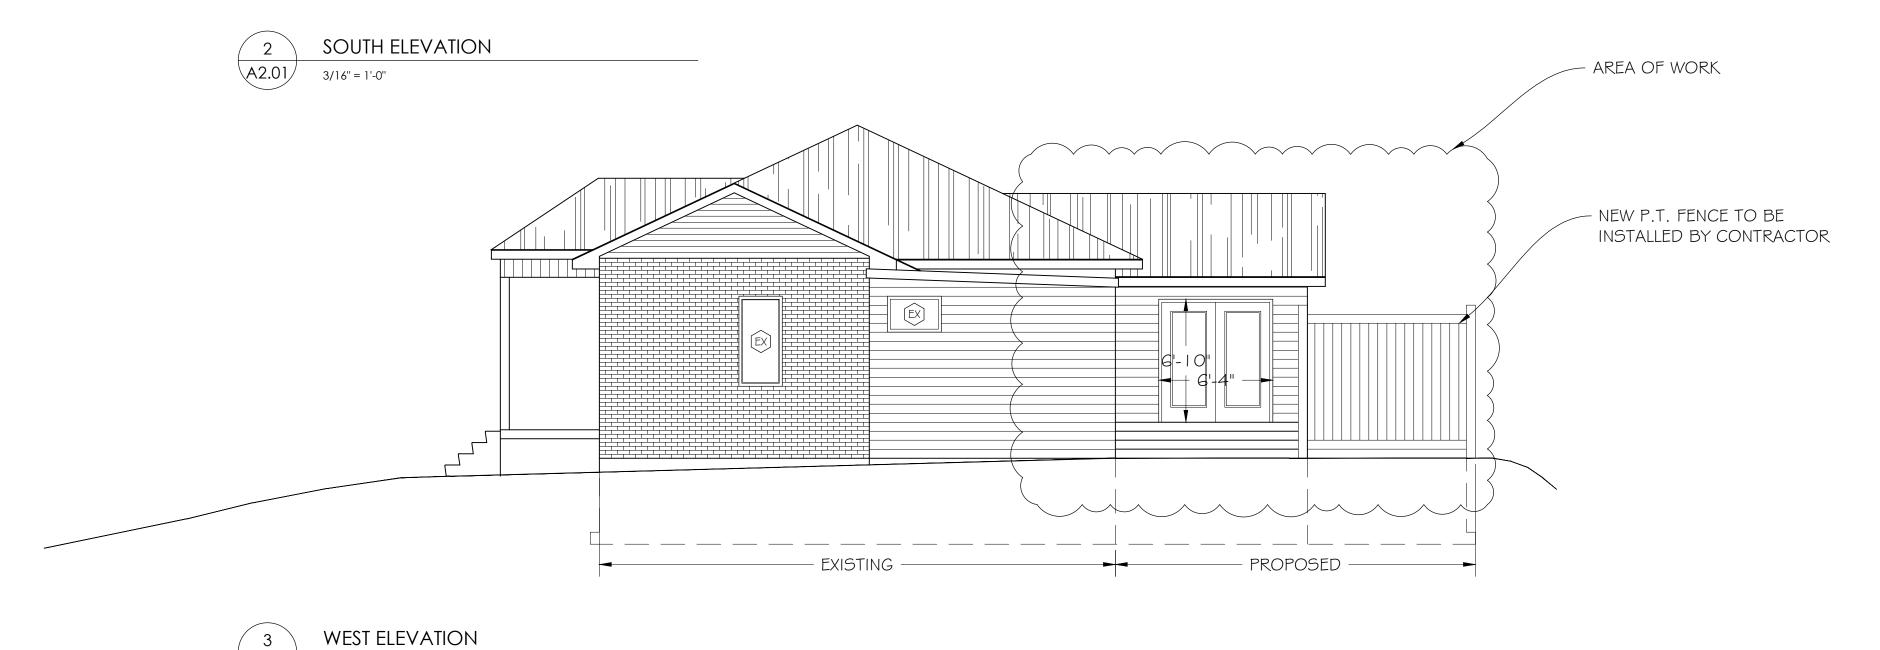

TWO ROW ARCHITECT hsweken, ON. NOA 1MO

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Revisions:
All previous issues of this drawing are superseded.



Professional Certification

project:

NEW PORCH & SUNROOM ADDITION

69 Glen Rd, Hamilton

sheet:

ELEVATIONS

scale: 3/16" = 1'- 0"

drawn by: JH


reviewed by: BP

job number: 21080

plot date: 11 30 2021

drawing number:


A2.01

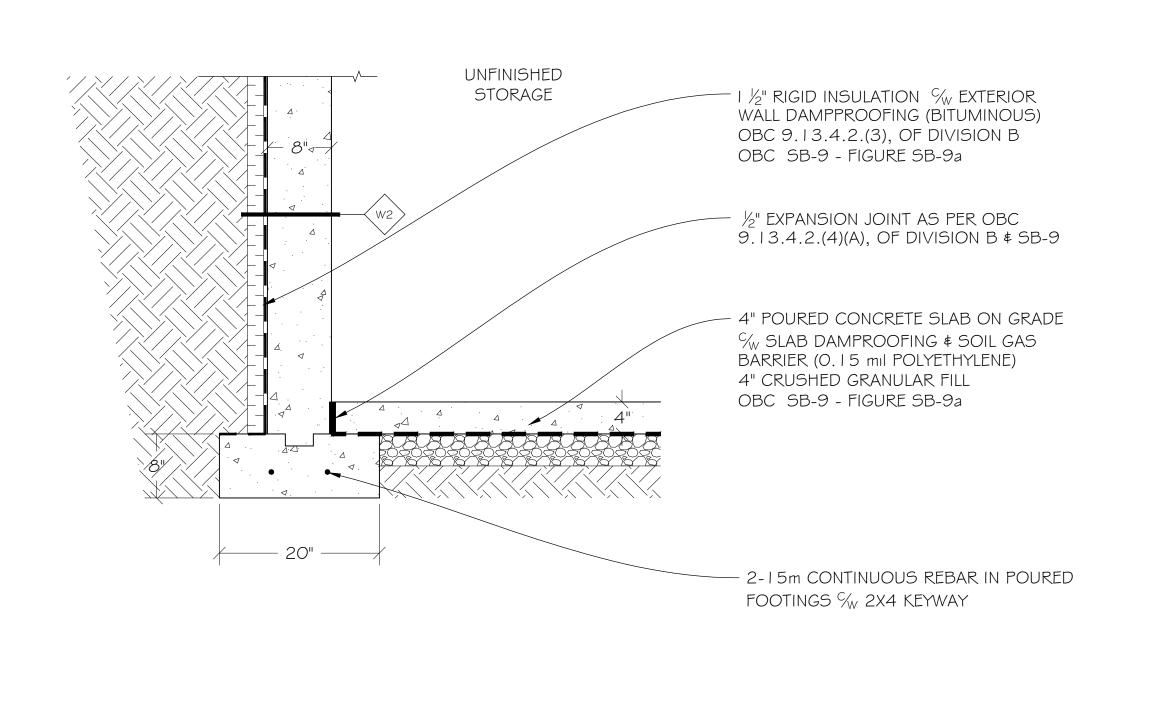

DETAIL AT FOOTING (RADAN REQUIREMENT)

A3.01

1" = 1'-0"

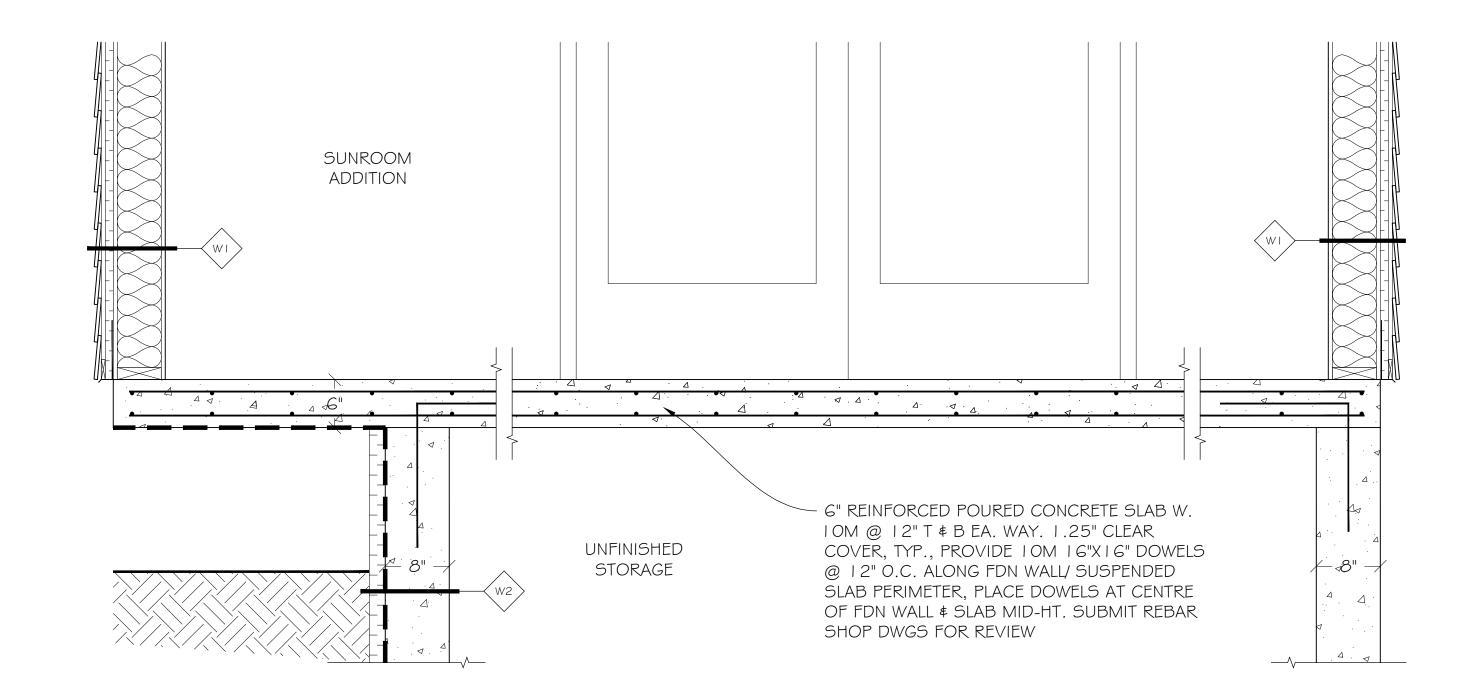

REINFORCED POURED CONCRETE STEPS AS PER OBC 9.8.9.2. I O" RUN TYP. - 2-15m CONTINUOUS REBAR IN POURED FOOTINGS % 2X4 KEYWAY

**--** | '-8" ---

SUSPENDED SLAB DETAIL

CONCRETE STAIR ON GRADE

A3.01

**--**8" -->

**AS NOTED** scale: drawn by: reviewed by: 21080 job number: 11 30 2021 plot date: drawing number:

A3.01

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DRAWINGS ARE NOT TO BE SCALED

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TWO ROW ARCHITECT

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Revisions: All previous issues of this drawing are superseded.





Professional Certification

NEW PORCH & SUNROOM ADDITION


69 Glen Rd, Hamilton

SECTION DETAILS

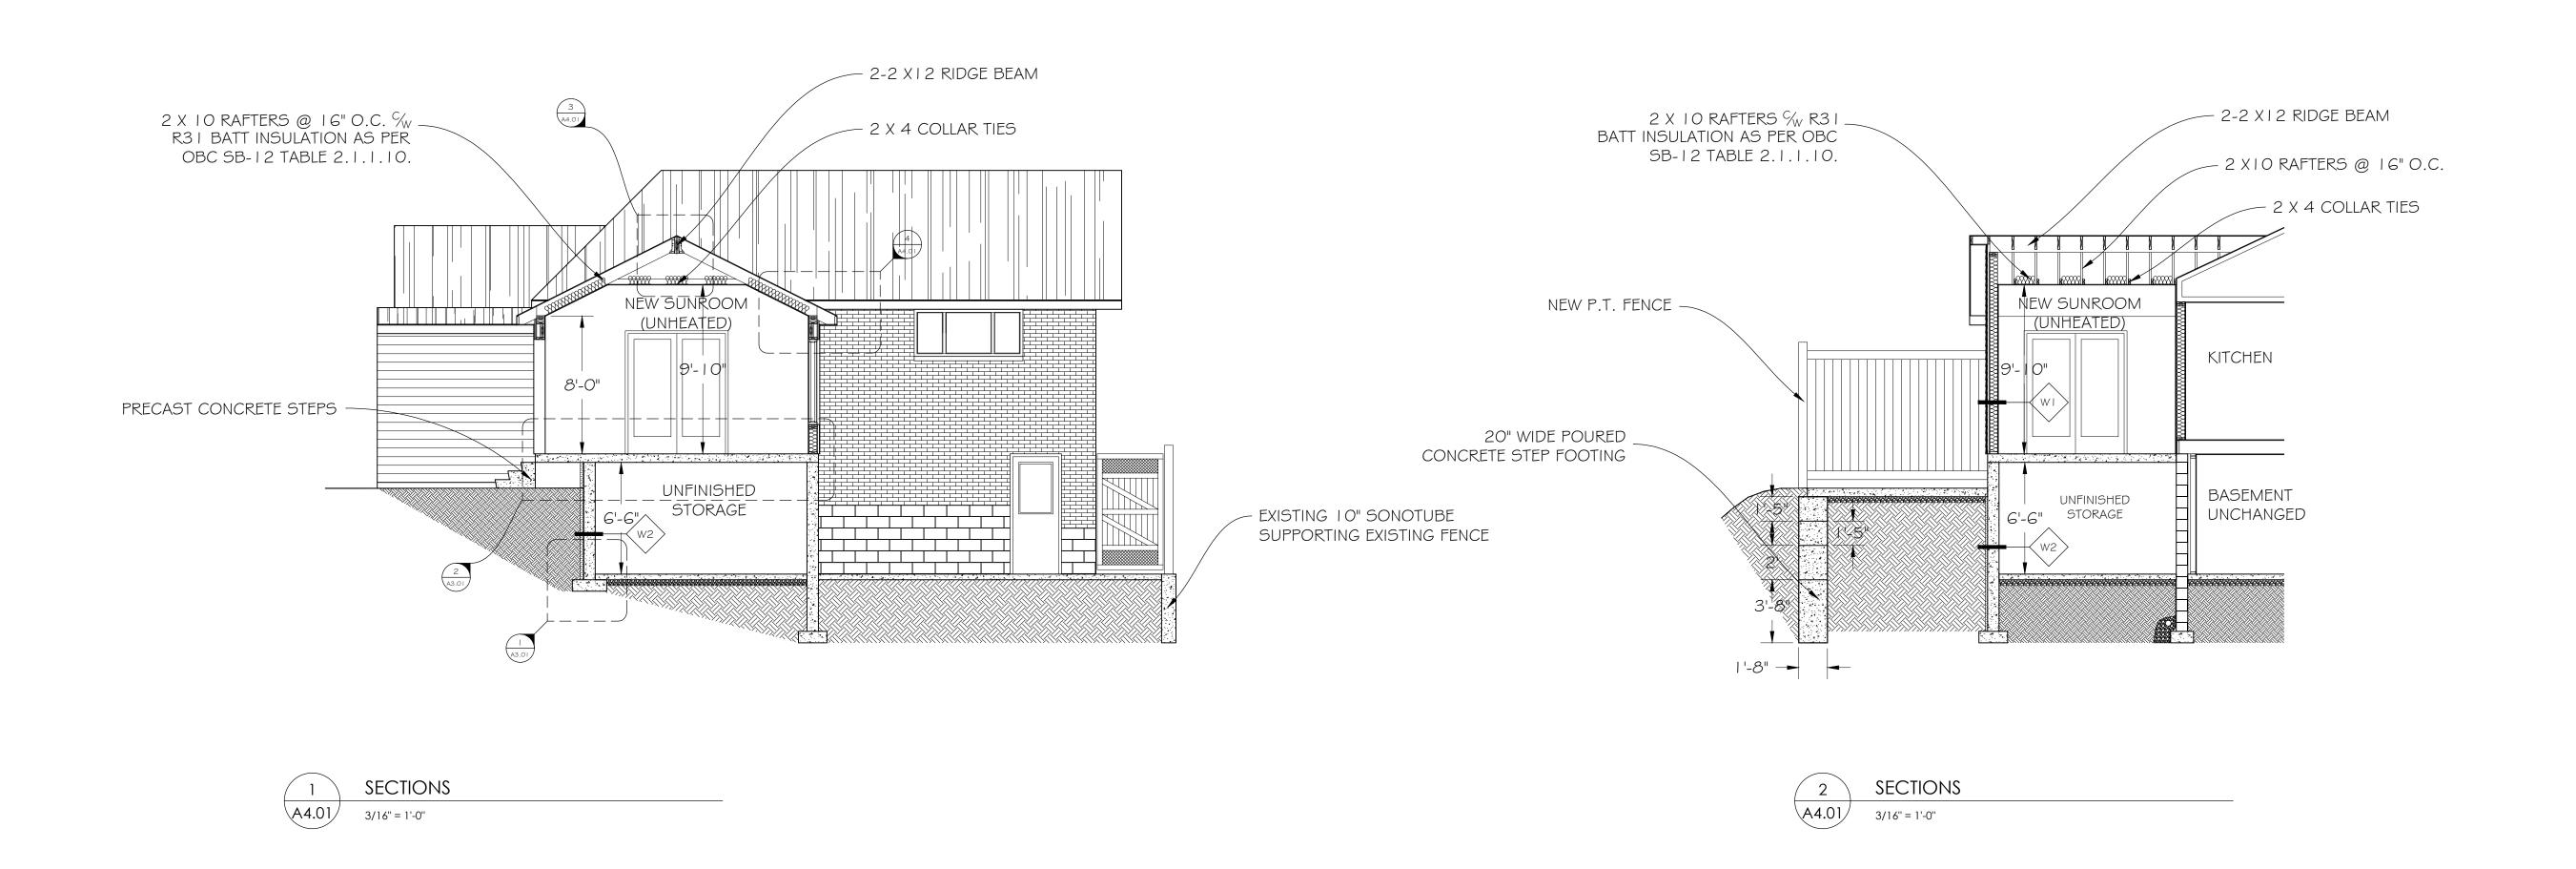

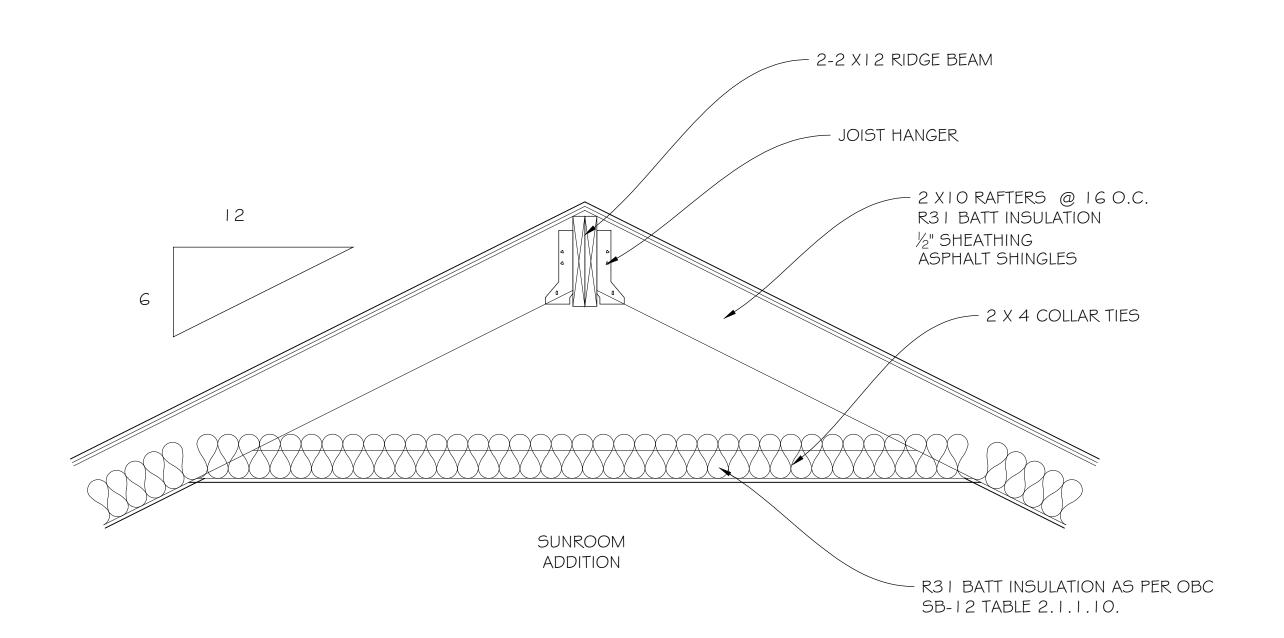



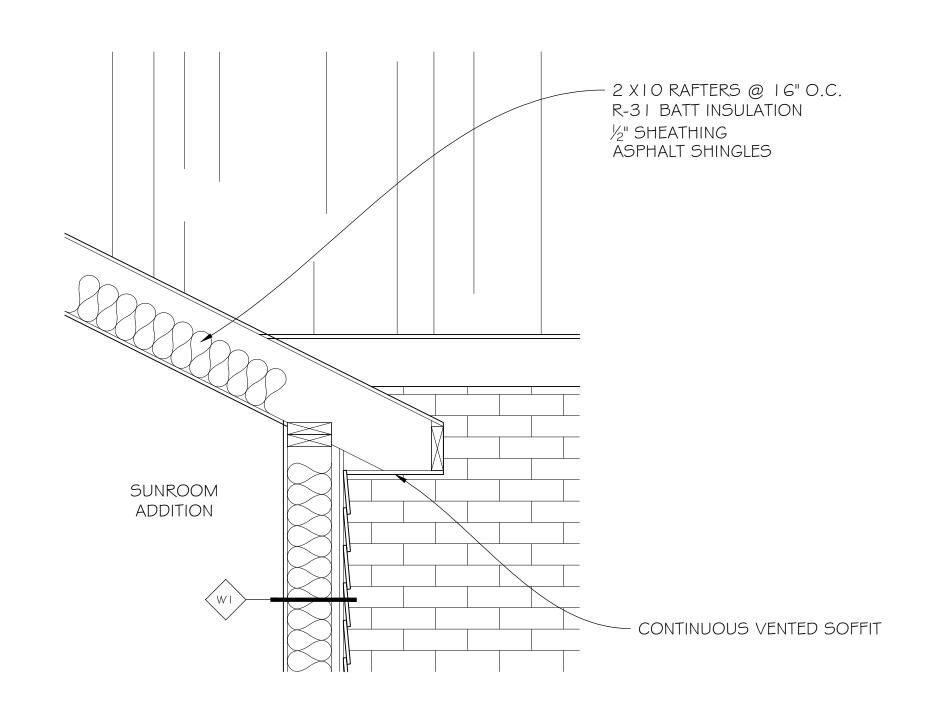

DETAIL AT SOFFIT A4.01

---------TWO ROW ARCHITECT

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Revisions: All previous issues of this drawing are superseded.

Professional Certification

project:

NEW PORCH & SUNROOM ADDITION

69 Glen Rd, Hamilton

BUILDING SECTION & DETAILS

**AS NOTED** scale: drawn by: reviewed by: job number: 21080 11 30 2021 plot date:

drawing number:

A4.01



Committee of Adjustment City Hall, 5<sup>th</sup> Floor, 71 Main St. W., Hamilton, ON L8P4Y5

Phone: (905) 546-2424 ext. 4221

Email: cofa@hamilton.ca

## APPLICATION FOR A MINOR VARIANCE

FOR OFFICE USE ONLY	
APPLICATION NO.	DATE APPLICATION RECEIVED
PAID	DATE APPLICATION DEEMED COMPLETE
SECRETARY'S SIGNATURE	

## The Planning Act

### Application for Minor Variance or for Permission

The undersigned hereby applies to the Committee of Adjustment for the City of Hamilton under Section 45 of the *Planning Act*, R.S.O. 1990, Chapter P.13 for relief, as described in this application, from the Zoning By-law.

1, 2	NAME	MAILING ADDRESS	
Registered Owners(s)			
Applicant(s)*			
Agent or Solicitor			

Note:

Unless otherwise requested all communications will be sent to the agent, if any.

3. Names and addresses of any mortgagees, holders of charges or other encumbrances:

RBC (21 King St. W Hamilton L8P 4W7) #01822-3868412-001

Shih-Lung, Lee Rebecca, Cheong

Additional sheets can be submitted if there is not sufficient room to answer the following questions. Additional sheets must be clearly labelled 4. Nature and extent of relief applied for: unheated sunroom addition Secondary Dwelling Unit Reconstruction of Existing Dwelling 5. Why it is not possible to comply with the provisions of the By-law? less the 25% soft landscape, existing setback deficiency 6. Legal description and Address of subject lands (registered plan number and lot number or other legal description and where applicable, street and street number): 69 Glen Rd, Hamilton ON, L8S 3M6 7. PREVIOUS USE OF PROPERTY Residential Industrial Commercial Agricultural Vacant Other Other 8.1 If Industrial or Commercial, specify use 8.2 Has the grading of the subject land been changed by adding earth or other material, i.e. has filling occurred? Yes (●) Unknown Has a gas station been located on the subject land or adjacent lands at any time? 8.3 Unknown 💽 8.4 Has there been petroleum or other fuel stored on the subject land or adjacent lands? No (•) Unknown ( Yes () Are there or have there ever been underground storage tanks or buried waste on the subject land or adjacent lands? Unknown (•) Have the lands or adjacent lands ever been used as an agricultural operation where 8.6 cyanide products may have been used as pesticides and/or sewage sludge was applied to the lands? Yes No ( Unknown ( 8.7 Have the lands or adjacent lands ever been used as a weapon firing range? No ( Unknown (•)

Is the nearest boundary line of the application within 500 metres (1,640 feet) of the fill area

Unknown (•)

If there are existing or previously existing buildings, are there any building materials remaining on site which are potentially hazardous to public health (eg. asbestos, PCB's)?

Unknown (

of an operational/non-operational landfill or dump?

No (

No ( )

8.8

8.9

Yes (

Yes (

8.10	uses on the site or adj	acent sites?	bject land may have been contaminated by former
	Yes <u> </u>	<u> </u>	nknown (•)
8.11	What information did y	ou use to dete	rmine the answers to 8.1 to 8.10 above?
	N/A		
8.12		showing all fo	al or commercial or if YES to any of 8.2 to 8.10, a armer uses of the subject land, or if appropriate, the needed.
	Is the previous use inv	entory attache	d? Yes ☐ No ☑
9.	ACKNOWLEDGEME	NT CLAUSE	
		ination on the	on is not responsible for the identification and property which is the subject of this Application – by ion.
	2022 01 20		· Constant
	Date		Signature/Property Owner(s)
			Shih-Lung (Sean) Lee
			Print Name of Owner(s)
10.	Dimensions of lands a	ffected:	
			n for proposed set backs
	Depth _		
	Area		
	Width of street		
11.	Particulars of all buildi	ss floor area, i	ures on or proposed for the subject lands: (Specify number of stories, width, length, height, etc.)
	Proposed		
	addition = 176 sf		
12.	Location of all building distance from side, rea		es on or proposed for the subject lands; (Specify lines)
	Existing:		
	sides = 4'-0" rear = 21'-0" front = 14'-9"		
	Proposed: sides = 4'-0" rear = 11-4" (addition	)	

Date of acquisition of subject lands: unknown
Date of construction of all buildings and structures on subject lands: unknown
Existing uses of the subject property (single family, duplex, retail, factory etc.):
single family
Existing uses of abutting properties (single family, duplex, retail, factory etc.):
single family
Length of time the existing uses of the subject property have continued:
Municipal services available: (check the appropriate space or spaces)  Water
Zoning E - by law# 6593
Present Restricted Area By-law (Zoning By-law) provisions applying to the land:
zoning E - by law# 6593
Has the owner previously applied for relief in respect of the subject property?  Yes  No  ✓ If the answer is yes, describe briefly.
Is the subject property the subject of a current application for consent under Section 53 of the <i>Planning Act</i> ?
Yes ○ No ● Additional Information
Additional mornation
N/A
The applicant shall attach to each copy of this application a plan showing the dimensions of the subject lands and of all abutting lands and showing the location, size and type of a buildings and structures on the subject and abutting lands, and where required by the Committee of Adjustment such plan shall be signed by an Ontario Land Surveyor.
REFER TO SITE PLAN & SURVEY(PROVIDED FROM CITY) SHOWN ON ARCHITECTURAL DRAWINGS