COMMITTEE OF ADJUSTMENT



City Hall, 5th floor, 71 Main Street West, Hamilton, ON L8P 4Y5 Telephone (905) 546-2424, ext. 4221, 3935 E-mail: <u>cofa@ham</u>ilton.ca

NOTICE OF PUBLIC HEARING Minor Variance

You are receiving this notice because you are either:

- Assessed owner of a property located within 60 metres of the subject property
- Applicant/agent on file, or
- Person likely to be interested in this application

APPLICATION NO.:	AN/A-22:175	SUBJECT PROPERTY:	376 PHILIP PLACE , ANCASTER
ZONE:	ER (Exisiting Residential)	ZONING BY- LAW:	Zoning By-law former Town of Ancaster 87-57, as Amended

APPLICANTS: Owners- D. Sohail, S. Daniel, S. & U. Daniel Agent- D. Sohail & S. Daniel

The following variances are requested:

- 1. A minimum front yard setback of 11.7m shall be permitted instead of the minimum 12.33m front yard setback required.
- 2. A minimum interior side yard setback of 4.1m shall be permitted instead of the minimum 4.65m interior side yard setback required.
- 3. A minimum flankage side yard setback of 15.3m shall be permitted instead of the minimum 15.93m flankage side yard setback required.
- 4. A minimum rear yard setback of 4.5m shall be permitted to the northerly rear lot line instead of the minimum 8.63m rear yard setback required to the northerly rear lot line and a minimum rear yard setback of 8.1m shall be permitted to the flankage rear lot line instead of the minimum 8.63m rear yard setback required to the flankage rear lot line.

PURPOSE & EFFECT: To permit the construction of a full second floor addition and a northwest ground floor addition to the existing single detached dwelling notwithstanding that;

Notes:

No setback dimension was shown to the front lot line; as such, variance #1 is based on an estimated value. Therefore, the applicant shall confirm that the requested variance #1 is correct; otherwise, further variances shall be required.

AN/A-22:175

The Zoning By-law states one metre within the side yard shall be unobstructed and shall not contain structures, walkways, sidewalks, hard surfaced material, and landscaping other than sod. No details were provided from which to determine compliance; therefore, further variances may be required.

The Zoning By-law permits a fence or gate to traverse the minimum one metre unobstructed area within a side yard or within the minimum one metre unobstructed area within a rear yard.

The elevation plans do not show the height dimension from grade as defined. The applicant shall ensure that maximum permitted 9.5m height is not exceed; otherwise, further variances may be required.

The Zoning By-law permits eaves or gutters that project into any minimum side yard a distance of not more than 60 centimetres, or into any minimum front or minimum rear yard a distance of not more than 1.5 metres. Insufficient details were shown on the submitted plans from which to determine compliance; therefore, further variances may be required.

This Notice must be posted by the owner of any land which contains seven or more residential units so that it is visible to all residents.

This application will be heard by the Committee as shown below:

DATE:	Thursday, June 23, 2022
TIME:	1:45 p.m.
PLACE:	Via video link or call in (see attached sheet for details)
	To be streamed (viewing only) at
	www.hamilton.ca/committeeofadjustment

For more information on this matter, including access to drawings illustrating this request and other information submitted:

- Visit <u>www.hamilton.ca/committeeofadjustment</u>
- Email Committee of Adjustment staff at <u>cofa@hamilton.ca</u>
- Call 905-546-CITY (2489) or 905-546-2424 extension 4221, 4130, or 3935

PUBLIC INPUT

Written: If you would like to submit written comments to the Committee of Adjustment you may do so via email or hardcopy. Please see attached page for complete instructions, <u>including deadlines</u> for submitting to be seen by the Committee.

Orally: If you would like to speak to this item at the hearing you may do so via video link or by calling in. Please see attached page for complete instructions, including deadlines for registering to participate.



DATED: June 7, 2022

Jamila Sheffield, Secretary-Treasurer Committee of Adjustment Information respecting this application is being collected under the authority of the Planning Act, R.S.O., 1990, c. P. 13. All comments and opinions submitted to the City of Hamilton on this matter, including the name, address, and contact information of persons submitting comments and/or opinions, will become part of the public record and will be made available to the Applicant and the general public, and may include posting electronic versions.

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PARTICIPATION PROCEDURES

Written Submissions

Members of the public who would like to participate in a Committee of Adjustment meeting are able to provide comments in writing or via email in advance of the meeting. Comments can be submitted by emailing cofa@hamilton.ca or by mailing the Committee of Adjustment, City of Hamilton, 71 Main Street West, 5th Floor, Hamilton, Ontario, L8P 4Y5. Comments must be received by noon two days before the Hearing.

Comments can also be placed in the drop box which is located at the back of the 1st Floor of City Hall, 71 Main Street West. All comments received by noon two business days before the meeting will be forwarded to the Committee members.

Comments are available two days prior to the Hearing and are available on our website: www.hamilton.ca/committeeofadjustment

Oral Submissions During the Virtual Meeting

Members of the public are also able to provide oral comments regarding Committee of Adjustment Hearing items by participating through Webex via computer or phone. Participation in this format requires pre-registration in advance. **Interested members of the public must register by noon the day before the hearing.**

To register to participate by Webex either via computer or phone, please contact Committee of Adjustment staff by email cofa@hamilton.ca or by phone at 905-546-2424 ext. 4221. The following information is required to register: Committee of Adjustment file number that you wish to speak to, the hearing date, name and address of the person wishing to speak, if they will be connecting via phone or video, and if applicable the phone number they will be using to call in. A separate registration for each person wishing to speak is required. Upon registering for a meeting, members of the public will be emailed a link for the Webex meeting the Wednesday afternoon before the hearing. The link must not be shared with others as it is unique to the registrant.

All members of the public who register will be contacted by Committee Staff to confirm details of the registration prior to the Hearing and provide an overview of the public participation process.

We hope this is of assistance and if you need clarification or have any questions, please email cofa@hamilton.ca or by phone at 905-546-2424 ext. 4221.

Please note: Webex (video) participation requires either a compatible computer or smartphone and an application (app/program) must be downloaded by the interested party in order to participate. It is the interested party's responsibility to ensure that their device is compatible and operating correctly prior to the Hearing.



PROPOSED ADDITION ALTERATION AT 376 PHILIP PLACE, ANCASTER,ON L9G 3G8.

OWNER: DEREK SOHAIL USHA DANIEL Structural Engineers:

EIDS CONSULTANTS INC. Engineering and Innovative Design Solutions

Shaukat Ali, M.Eng., P.Eng., LEED GA Director and Principal Structural Engineer 3121 Mission Hill Drive, Mississauga, ON. L5M 0B2 Phone: +1 905 399 5441 Email: <u>shaukat ali@eidsconsultants.com</u> www.eidsconsultants.com PROJECT ARCHITECTS:

ARCHISYSTEM INC. CONSULTING ARCHITECTS CERTIFICATE OF PRACTICE # 5465 80 Eastern Ave. Unit A9, Brampton, ON. Canada L6W 0B6 Tel:(O) 905 858-2565 (C) 647-295-2565 www.thearchisystem.com e-mail: archisystem@gmail.com

Mechanical Engineers: Gil Cofreros, P.Eng.	PERMIT BY:	SHEET TITLE: COVER SHEET
GAC Engineering Services Inc. 1080 Tapscott Road, Unit 18 Toronto, Ontario M1X 1E7 Tel. No. 416 292 0527 Cel. No. 416 710 8274 Fax. No. 416 292 4563		SHEET NO: A0.01
	HOME SOLUTIONS	

LIST OF DRAWINGS

(ISSUE FOR PERMIT)

ARCHITECTURAL:

A0.0 SP1.01 A1.01 A1.02 A1.03 A1.04 A1.05 A2.01 A2.02 A3.01 A4.01 A4.02 A0.02 MECHAM	AS BUILT FLOOR PLANS PROPOSED BASEMENT PLAN PROPOSED FIRST FLOOR PLAN PROPOSED 2ND FLOOR PLAN PROPOSED ROOF PLAN NORTH AND SOUTH ELEVATIONS EAST AND WEST ELEVATION DETAILS BUILDING SECTION WALL SECTIONS GENERAL NOTES & SCHEDULES
M1.01 M1.02	BASEMENT FLOOR MECH PLAN GROUND FLOOR MECH PLAN
M1.02	SECOND FLOOR MECH PLAN
M1.04	NOTES & SCHEDULE
STRUCT	TURAL:
S1.01	FOUNDATION PLAN
S1.02	FIRST FLOOR PLAN
S1.03	SECOND FLOOR FRAMING PLAN
S1.04	ROOF FLOOR FRAMING PLAN
S2.01	FRONT ELEVATION
S2.02	REAR ELEVATION
S2.03	LEFT AND RIGHT ELEVATION
S3.01	CONNECTION DETAILS
S3.02	STRUCTURAL ELEMENTS SCHEDULES
S3.03	GENERAL NOTES

1. GENERAL REQUIREMENTS

- 1. CONFORM TO REQUIREMENTS OF ALL AUTHORITIES HAVING JURISDICTION.
- 2. ALL MATERIALS SHALL BE FURNISHED AND ALL WORK SHALL BE PERFORMED IN STRICT ACCORDANCE WITH THE GRADES, OR STANDARDS OF MATERIALS, STANDARDS OF WORKMANSHIP AND MANUFACTURE'S SPECIFICATIONS LISTED OR MENTIONED.
- 3. CONTRACTOR TO VERIFY ALL DIMENSIONS AND SITE CONDITIONS AND REPORT ANY DISCREPANCIES TO THE ARCHITECT BEFORE COMMENCING THE WORK. CONTRACTOR TO VERIFY STRUCTURE OF WALLS, FLOOR AND CEILING AT NEW ENTRANCES, WINDOWS, CANOPY AND EXTERIOR CLADDING.
- 4. INSPECT THE EXISTING SITE AND NOTE ANY CONDITIONS WHICH WOULD AFFECT THE WORK. NO CLAIM FOR AN ADDITION TO THE CONTRACT AMOUNT WILL BE CONSIDERED RESULTING FROM FAILURE TO BECOME FAMILIAR WITH ALL, APPARENT EXISTING SITE CONDITIONS.
- UNLESS OTHERWISE SPECIFIED, PROVIDE AND MAINTAIN ALL NECESSARY PROTECTION INCLUDING HOARDING, BARRICADES, WARNING LIGHTS AND SIGNS, BEFORE AND DURING DEMOLITION WORK.
- PROTECT ALL MECHANICAL AND ELECTRICAL EQUIPMENT AND PIPING THAT IS TO REMAIN.
- 7. PROTECT ALL EXISTING FINISH SURFACES WHICH ARE NOT SUBJECT TO DEMOLITION.
- 8. MAINTAIN PROPER ACCESS TO PREMISES.
- MAKE GOOD DAMAGE TO SUCH STRUCTURES RESULTING FROM WORK UNDER THIS SECTION AT NO COST TO OWNER.
- 10 EXERCISE CAUTION IN DISMANTLING OR DISCONNECTING WORK ADJACENT TO EXISTING WORK DESIGNATED TO REMAIN.
- 11. MAKE GOOD ANY DEMOLITION TO THE EXISTING WORK BEYOND THAT NECESSARY FOR CARRYING OUT NEW WORK. AT NO EXPENSE TO THE OWNER.
- 12. CARRY OUT DEMOLITION AS SCHEDULED, IN A ORDERLY AND CAREFUL MANNER.
- 13. AT COMPLETION OF WORK, THE PREMISES SHALL BE LEFT BROOM CLEAN.
- 14. REPORT TO THE ARCHITECT AND INTERIOR DESIGNER ANY DISCREPANCIES BETWEEN ARCHITECTURAL AND INTERIOR DESIGN DRAWINGS. CONTRACTOR TO MAINTAIN AT THE JOB SITE AN UPDATED SET OF DRAWINGS AND RECORD ANY CHANGES TO BUILDING PERMIT DRAWINGS.
- 2. SITE WORK
- MAINTAIN PROPER ACCESS TO THE SITE. PROVIDE ADEQUATE PROTECTION TO CURBS, SIDEWALKS AND LIGHTS. MAKE GOOD ANY DAMAGE AT NO COST TO THE OWNER.
- REMOVE FROM THE SITE AND LEGALLY DISPOSE OF ALL RUBBISH, AND SURPLUS MATERIALS RESULTING FROM THE WORK.
- 3. CONCRETE
- CONCRETE MATERIALS SHALL CONFORM TO REQUIREMENTS OF CAN/CSA A23.1-M90, 266-M78
- BEFORE COMMENCING WORK, ENSURE THAT SURFACES ARE ACCEPTABLE TO RECEIVE AND MAINTAIN CONCRETE FINISHING AND THAT SPECIFIED INSTALLATION WILL BE ACHIEVED.
- PATCHING CONCRETE SHALL BE THOROUGHLY COMPACTED INTO PLACE AND FINISHED IN SUCH A MANNER AS TO MATCH ADJOINING CONCRETE. RUB DOWN TO GIVE UNIFORM, SMOOTH, FLUSH, MONOLITHIC SURFACE FREE OF ALL DEFECTS IN APPEARANCE TO ARCHITECTS APPROVAL 4. MASONRY
- MAINTAIN DIMENSIONS, LINES AND LEVELS OF EXISTING WORK.
- TAKE SPECIAL CARE OF ERECTING BLOCK WALLS TO WHICH OTHER SECTIONS WILL APPLY FINISHES, TO ENSURE TOLERANCES REQUIRED OF FOLLOWING SECTIONS CAN BE MET WITH REASONABLE CONSTRUCTION PROCEDURES (E.G. THIN SET APPLICATION OF GRANITE TILES.)
- ALL MASONRY SHALL BE PATCHED AND REPAIRED USING METHODS AND MATERIALS TO MATCH EXISTING WORK. 5. METALS

CONFORM TO REQUIREMENTS OF CAN/CSA-G40.21 & M92 (HOT DIP GALV. PARTS)

- WORK TO BE EXECUTED BY FIRM THOROUGHLY FAMILIAR WITH LAWS, BY-LAWS AND REGULATIONS WHICH GOVERN, AND CAPABLE OF WORKMANSHIP OF BEST GRADE AND FIELD PRACTISE KNOWN TO BE RECOGNIZED MANUFACTURE'S SPECIALIZING IN THIS WORK.
- PAINT PRIMER TO BE ZINC CHROMATE CONFORMING TO CGSB 1-6P-40D. FINISH COLOUR TO BE AS PER APPROVED SAMPLE BY INTERIOR DESIGNER.

6. WOOD AND PLASTICS

- MATERIALS SHALL BE CAREFULLY CHECKED, UNLOADED STORED AND HANDLED TO PREVENT DAMAGE. PROTECT MATERIALS WITH SUITABLE NON-STAINING WATERPROOF COVERINGS.
- SUPPLY ALL LABOUR, MATERIALS, EQUIPMENT, SERVICES AND PERFORM ALL OPERATIONS REQUIRED TO COMPLETE ALL ROUGH CARPENTRY WORK, TO THE FULL INTENT OF THE DRAWINGS AND AS HEREIN SPECIFIED.
- ALL INTERIOR ROUGH CARPENTRY APPLIED TO WALLS, FLOORS, AND CEILING IS TO HAVE A FLAME SPREAD RATING OF 150 OR LESS.
- 7. THERMAL AND MOISTURE PROTECTION
- MAINTAIN EXISTING LEVELS OF INSULATION.
- ALL MATERIALS AND METHODS USED IN APPLICATION SHALL BE IN STRICT ACCORDANCE WITH THE PRINTED INSTRUCTIONS OF THE MANUFACTURER.
- INSTALL INSULATION TO MAINTAIN CONTINUITY OF THERMAL PROTECTION TO BUILDING ELEMENTS AND SPACES.
- INSTALL LOOSE INSULATION IN LOCATIONS AND THICKNESS SHOWN, AND FOR PACKING WHERE REQUIRED TO MAINTAIN THE INTEGRITY OF THE THERMAL BARRIER. SEAL JOINTS TO PREVENT THE TRANSFER OF MOISTURE.
- SEALANTS AND COLOUR TO BE SELECTED BY INTERIOR DESIGNER.
- CLEAN JOINTS AND SPACES TO BE CAULKED AND ENSURE THEY ARE DRY AND FREE OF DUST, LOOSE MORTAR, OIL, GREASE AND OTHER FOREIGN MATERIAL. CLEAN FERROUS MATERIALS OR RUST, MILL, SCALE AND FOREIGN MATERIALS BY WIRE BRUSHING, GRINDLING OR SANDING.
- UPON COMPLETION, REMOVE MASKING AND SEALANT SMEARS AND DROPPINGS FROMADJACENT AND OTHER SURFACES.
- PATCH AND REPAIR EXISTING WORK, REQUIRED DUE TO THE WORK OF THE CONTACT. USE THE EXACT SAME METHODS AND MATERIALS TO MATCH THE EXISTING WORK. WHERE IT IS NOT POSSIBLE, SUBMIT PROPOSALS TO THE INTERIOR DESIGNER FOR APPROAVAL.
- CAULKING: PROVIDE CAULKING AS PER OBC 9.27.4 AT ALL EXPOSED JOINTS BETWEEN MASONRY TO WINDOWS, ROOFING, AND FLASHINGS,

SPECIFICATIONS


- 8. DOORS AND WINDOWS STEEL DOORS AND FRAMES:
- 1. SUBMIT SHOP DRAWINGS IN ACCORDANCE WITH GENERAL CONDITIONS, SHOW EACH TYPE OF FRAME, DOOR, HARDWARE BLANKING, REINFORCING TAPPING AND DRILLING ARRANGEMENTS, METAL GAUGES, THICKNESS AND FINISHES. SUBMIT DOOR AND FRAME SCHEDULE IDENTIFYING EACH UNIT. APPROVAL TO BE MADE BY INTERIOR DESIGNER.

WOOD DOORS AND FRAMES:

- 2. MANUFACTURE SOLID CORE VENEERED AND PLASTIC LAMINATED FACED WOOD DOORS TO ARCHITECTURAL WOODWORK MANUFACTURERS ASSOCIATION OF CANADA LATEST REVISIONS, FOR PREMIUM GRADE SPECIALTY DOORS.
- 3. SUBMIT SHOP DRAWINGS IN ACCORDANCE WITH GENERAL CONDITIONS ILLUSTRATING DOOR CONSTRUCTION FOR THE INTERIOR DESIGNER TO REVIEW.

9. FINISHES

- GYPSUM WALLBOARD:
- EXECUTE THE GYPSUM WALLBOARD WORK COMPLETE IN ALL RESPECTS AND FREE 1. OF DEFECTS IN MATERIALS AND WORKMANSHIP AFFECTING APPEARANCE AND PERFORMANCE.
- 2. EXAMINE AND CO-ORDINATE WORK WITH THE OTHER TRADES AND ENSURE THAT ANCHORS, GROUNDS, ELECTRICAL CONDUIT, WIRING AND MECHANICAL WORK, WHICH IS TO BE INSTALLED IN OR BEHIND WORK UNDER THIS CONTRACT HAS E INSTALLED, TESTED AND APPROVED.
- 3. CONFORM TO CURRENT C.S.A. STANDARDS A82.30 AND A82.31, EXEPT A SPECIFIED OTHERWISE HEREIN.
- 4. FINISHED GYPSUM WALLBOARD SURFACES SHALL BE TRUE PLANES WIT WHEN CHECKED WITH 12 FEET STRAIGHT EDGE PLACED ANYWHERE ON THE SURFACE, SURFACES SHALL BE FREE FROM WAVES, IRREGULATIONS AND OTHER DEFECTS. VERTICAL SURFACES, PLUMB AND TRUE TO LINE, HORIZONTAL SURFACES

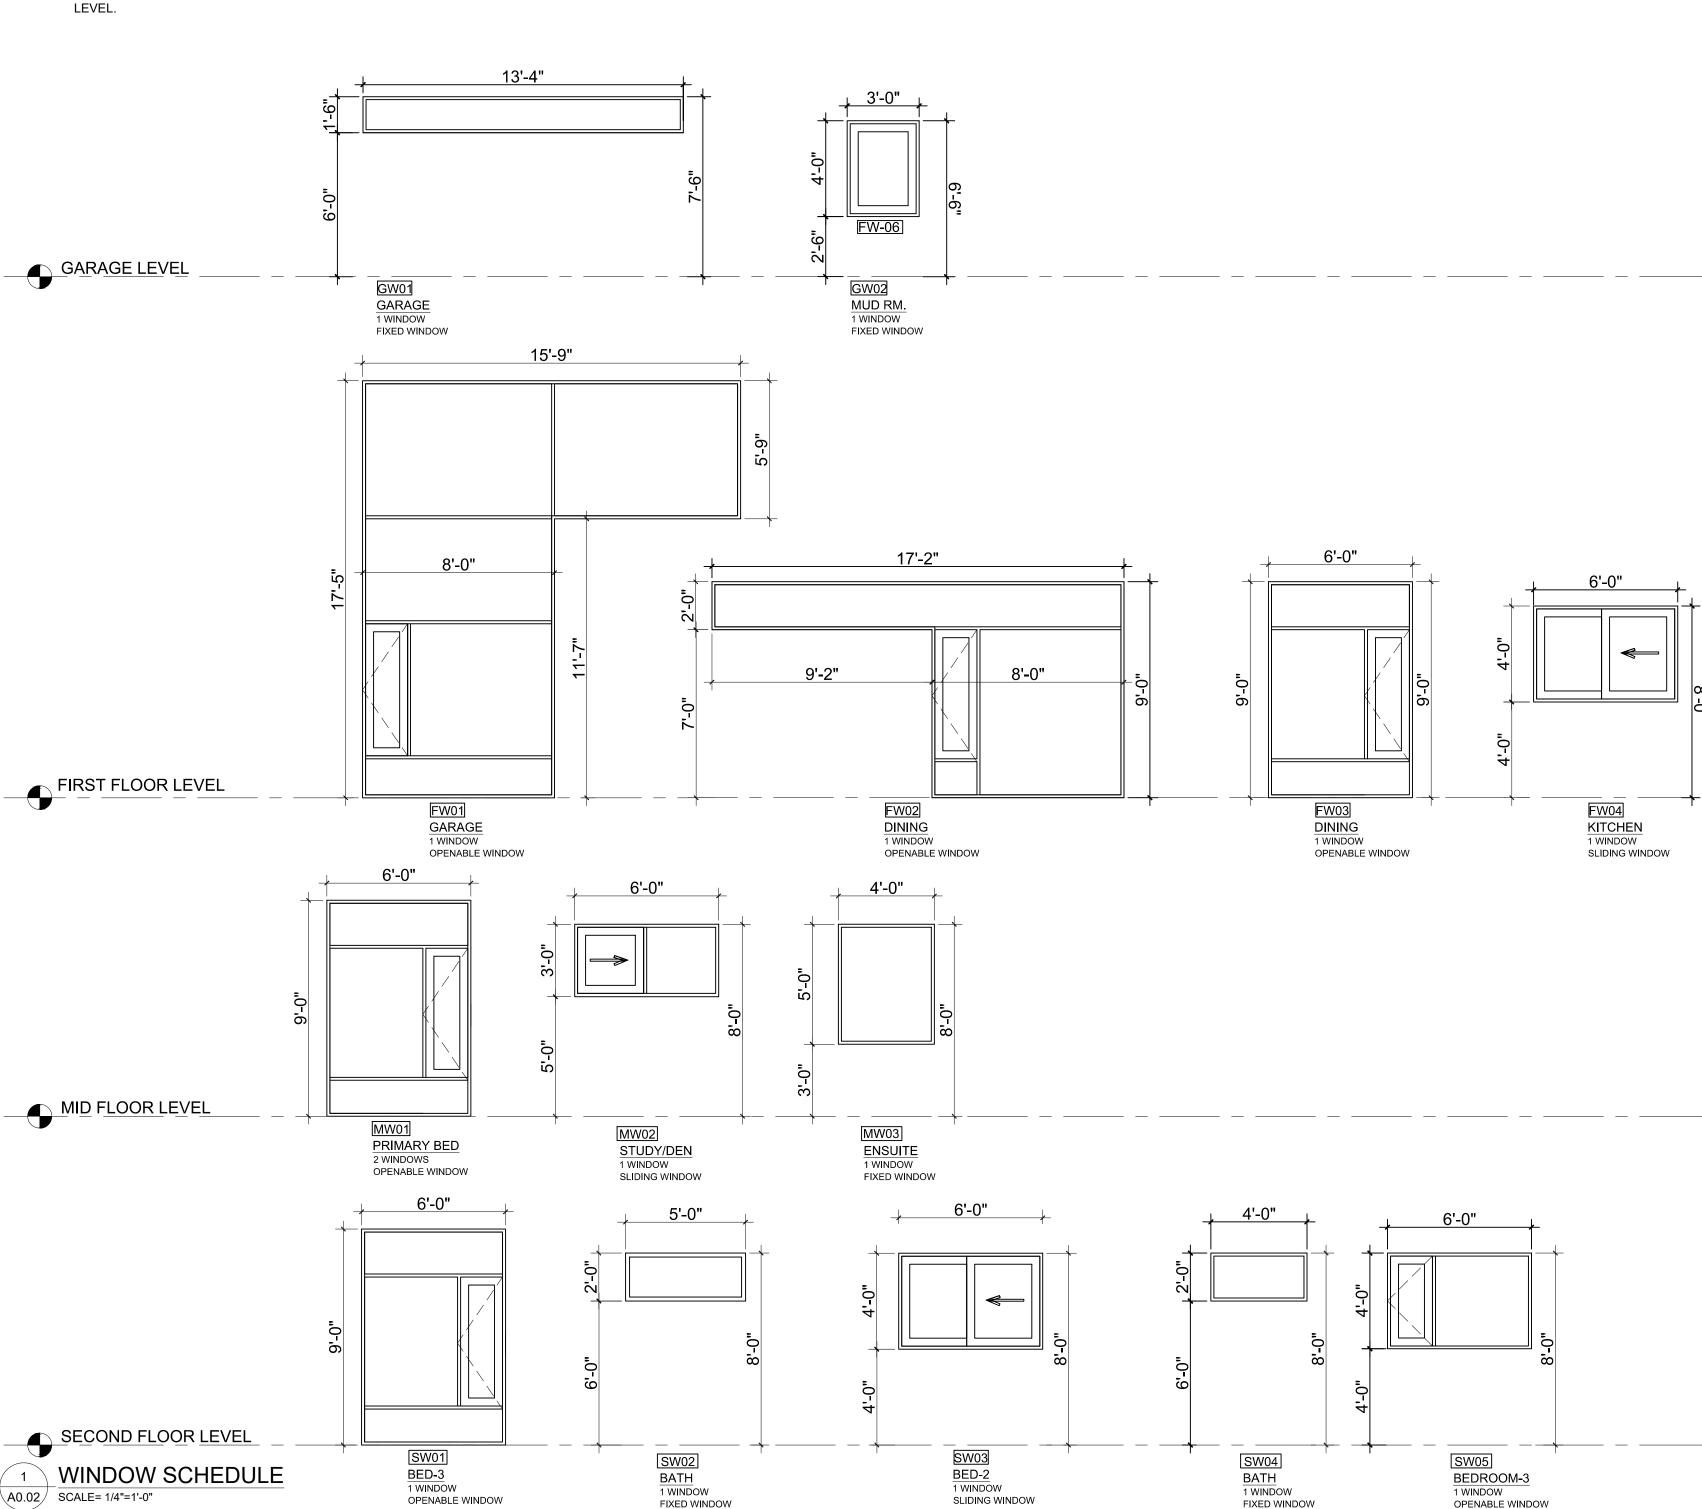


ABBRE	VIATIONS LEGEND
CL.	CLOSET
CLG.	CEILING
-	CONCRETE COVERED DOWN DITTO ELECTRICAL
EX.	EXISTING
FLR. GALV.	FLOOR GALVANIZED
H.C	HOLLOW CORE
HT.	HEIGHT
I/S JST. MAX.	INSIDE JOIST MAXIMUM
MIN.	MINIMUM /MINUTE
MNTD.	MOUNTED
N.L.B	NON-LOAD BEARING
P.F. STL. SQ.M. SQ.FT. WD. W.I.	PRE-FINISHED STEEL SQUARE METER SQUARE FOOT WOOD WALK IN
PWD.	POWDER

BEEN	••••
AS	
ITHIN 1/8	INC

			/S SCHEI	DULE		
	TYPE	SIZ WIDTH	ZE HEIGHT	SILL LVL. (SL)	DESCRIPTION	QT
FLOOR	FW01	15'-9"	17'-5"	+0'-0"	PVC. FRAME THERMOPAN DBL GLAZED WINDOW PROVIDE INSECT SCREEN AT OPERABLE PANS	1
	FW02	17'-2"	9'-0"	+0'-0"	DO	1
FIRST	FW03	6'-0"	9'-0"	+0'-0"	DO	1
ш	FW04	6'-0"	4'-0"	+4'-0"	DO	1
	FW05	8'-0"	7'-0"	+1'-0"	DO	1
ñ	MW01	6'-0"	9'-0"	+0'-0"	DO	2
FLOOR	MW02	6'-0"	3'-0"	5'-0"	DO	1
MID FI	MW03	4'-0"	5'-0"	3'-0"	DO	1
	SW01	6'-0"	9'-0"	0'-0"	DO	1
FLOOR	SW02	5'-0"	2'-0"	6'-0"	DO	1
D FL	SW03	6'-0"	4'-0"	4'-0"	DO	1
2ND	SW04	4'-0"	2'-0"	6'-0"	DO	1
	SW05	6'-0"	4'-0"	4'-0"	DO	1
Щ	GW01	13'-4"	1'-6"	6'-0"	DO	1
GARAGE	GW02	3'-0"	4'-0"	2'-6"	DO	1
gA			тот	AL		16


TYP FD1 FD2 FD3 MD MD MD SD' SD2 SD3 BD' BD2 BD3

DOORS SCHEDULE					
TYPE	SIZ WIDTH	e Height	DESCRIPTION		
DM	3'-0"	7'-0"	WD. FRAME EXTERIOR TYPE SOLID WD. DBL. DOOR WEATHER W/ RESISTANCE AND LATCHED LOCK		
DM1	2'-8"	7'-0"	ALUMN. FRAME H.M INSULATED DOOR W/LATCHED LOCK AT GARAGE WITH GAS-PROOF SEALANT		
OHD1	7'-9"	7'-0"	P.F METAL INSULATED O/H SECTIONAL DOOR W/ REMOTE CONTROL MECHANICAL GARAGE OPENER RWCOX OR EQ.		
OHD2	12'-0"	7'-0"	P.F METAL INSULATED O/H SECTIONAL DOOR W/ REMOTE CONTROL MECHANICAL GARAGE OPENER RWCOX OR EQ.		
FD1	3'-4"	8'-0"	WD. FRAME EXTERIOR TYPE SOLID WD. DBL. DOOR WEATHER W/ RESISTANCE AND LATCHED LOCK		
FD2	2'-6"	8'-0"	WD. FRAME INTERIOR TYPE SOLID WD. DOOR WITH LATCHED LOCK		
FD3	2'-4"	8'-0"	WD. FRAME INTERIOR TYPE SOLID WD. DOOR WITH LATCHED LOCK		
MD1	5'-0"	8'-0"	WD. FRAME INTERIOR TYPE SOLID WD. DBL. DOOR WITH LATCHED LOCK		
MD2	2'-6"	8'-0"	WD. FRAME INTERIOR TYPE SOLID WD. DOOR WITH LATCHED LOCK		
MD3	2'-4"	8'-0"	WD. FRAME INTERIOR TYPE SOLID WD. DOOR WITH LATCHED LOCK		
SD1	2'-6"	8'-0"	WD. FRAME INTERIOR TYPE SOLID WD. DOOR WITH LATCHED LOCK		
SD2	2'-4"	8'-0"	WD. FRAME INTERIOR TYPE SOLID WD. DOOR WITH LATCHED LOCK		
SD3	2'-4"	8'-0"	WD. FRAME INTERIOR TYPE SOLID WD. SLIDING DOOR WITH LATCHED LOCK		
BD1	5'-0"	6'-8"	WD. FRAME INTERIOR TYPE SOLID WD. DBL. DOOR WITH LATCHED LOCK		
BD2	3'-0"	6'-8"	WD. FRAME INTERIOR TYPE SOLID WD. DOOR WITH LATCHED LOCK		
BD3	2'-6"	6'-8"	WD. FRAME INTERIOR TYPE SOLID WD. DOOR WITH LATCHED LOCK		
BD4	2'-4"	6'-8"	WD. FRAME INTERIOR TYPE SOLID WD. DOOR WITH LATCHED LOCK		

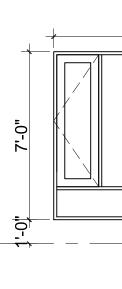


FW05 FAMILY


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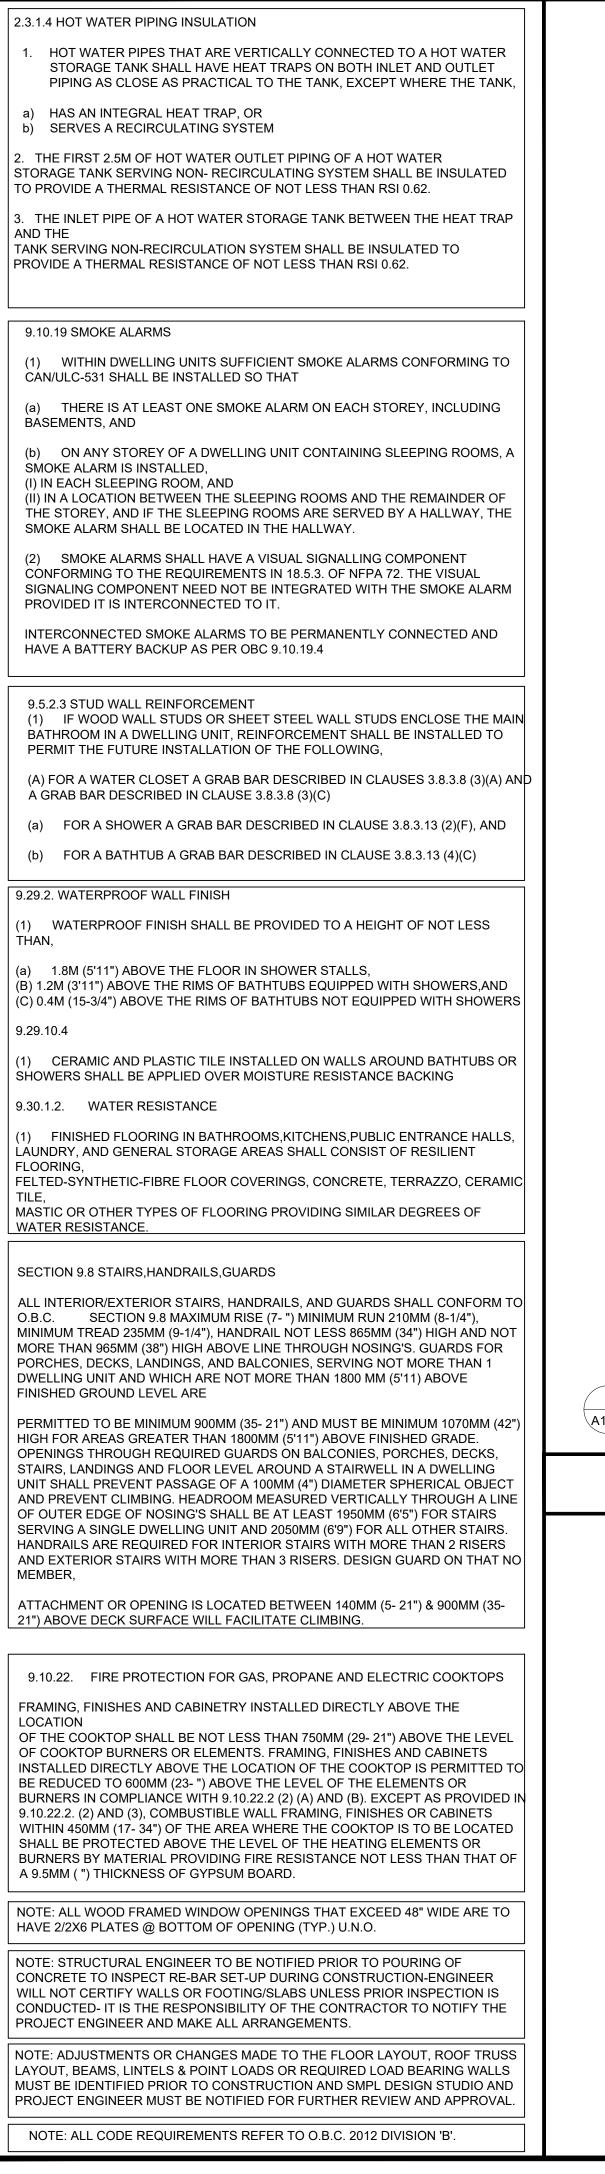


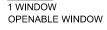
PROJECT ARCHITECTS:		
ARCHISYSTEM	1	NC.
CONSULTING ARCHITECTS	•••	
CERTIFICATE OF PRACTICE # 5465		
80 Eastern Ave. Unit A9, Brampton, O Canada L6W 0B6 Tel:(O) 905 858-2565 (C) 647-295-25		
www.thearchisystem.com e-mail: archisystem@gmail.com		
NOTES: THE DRAWINGS SHALL NOT BE SCALED THE CONTRACTOR SHALL VERIFY ALL DIMEN LEVELS PRIOR TO COMMENCING THE W THAT THE CONTRACTOR WILL BE LIABLE WITHOUT EXTRA COST ALL ERRORS AND OMISSIONS TO BE REPOR THE ARCHITECT. VARIATIONS AND MOD SHOWN ON THIS DRAWING SHALL NOT E WITHOUT THE WRITTEN CONSENT OF TI THIS DRAWING IS EXCLUSIVE PROPERTY OF SHALL NOT BE REPRODUCED WITHOUT PERMISSION ALL WORKS TO BE DONE ACCORDING TO BE PRACTICE AND CONFORM TO PREVAILIN BUILDING CODE	ORK. F/ E TO RE IFICATION BE CARI HE ARC THE AI THE AI ST COM	AILURE TO ECTIFY MEDIATELY TO ONS TO WORK RIED OUT HITECT RCHITECT AND RCHITECT'S MMON
USHA DANIEL		
PERMIT BY:		
HOME SOLUT		N S
REVISIONS:		ISSUED:
ARCHITECTS 2 ARCHITECTS 2 SARWAT S AHMED LICENCE 7987		
PROJECT:		_
PROPOSED ADI ALTERATION 376 PHILIP PL/ ANCASTEF ON. L9G 3G	N A ACE R,	Т
DRAWING TITLE:		
SHEET TITLE:		
GENERAL NOT SCHEDUL		
DATE:	C)4-08-2022
SCALE:	Δ	S NOTED
SHEET NO:	Α	0.02

DEMOLITION NOTES	
I. INTERIOR WALL DIMENSIONS TAKEN TO FACE WALL SURFACE UNLESS OTHERWISE NOTED.	
^{2.} PROTECT ALL EXISTING TREES AND SHRUBS DURING DEMOLISHING	7-01
3. PRIOR TO DEMOLISHING VERIFY THAT ADJOINING NEIGHBOUR'S FOOTINGS WILL NOT BE UNDERMINED BY A 45 DEGREE ANGLE. OTHERWISE, TAKE ALL NECESSARY ACTION TO SHORE NEIGHBOUR'S OR EXISTING PROPERTY TO ENSURE STABILITY.	10
4. PROTECT ALL EXISTING SERVICE PIPES E.G GAS, ELECTRICITY AND DRAINAGE DURING DEMOLISHING. CONTACT CONCERNED UTILITY AUTHORITIES FOR LOCATION OF SERVICE LINE AND MAKE ARRANGEMENTS TO PROTECT PRIOR TO START OF DEMILISHING	32'-11"
^{5.} DEMOLISHING CONTRACTOR TO PROVIDE SEPARATE BINS FOR EACH MATERIAL E.G WOOD, STEEL, CONC. RUBBLE, BRICK BALAST, ETC.	22'-5 ⁻
^{6.} REUSEABLE ITEMS SUCH AS WINDOWS, DOORS, FIXTURES SHOULD BE REMOVED AND STORED IN A COVERED BIN SHED PRIOR TO MAJOR DEMILISHING	
7. CONTRACTOR MUST VERIFY EXISTING CONDITIONS ON THE SITE, INCLUDING AS -BUILT SITUATIONS THAT MAY DIFFER FROM THOSE SHOWN ON THE DRAWINGS. CURSORY SITE INSPECTIONS AND VISITS DID NOT INVOLVE OPENING WALLS AND FLOORS SO CERTAIN ASPECTS OF THE BUILDING WERE ASSUMED,SUCH AS MEMBERS, EXISTING CONSTRUCTION AND THEIR ASSOCIATED DIMENSIONS. DURING DEMOLITION THE CONTRACTOR IS TO VERIFY ANY DISCREPANCIES WITH THE DESIGNER.	2 A1.01 EX.BASEMENT PLAN SCALE= 1/4"=1'-0"
8. CONTRACTOR TO VERIFY NEIGHBORS FOR ANY NOISE REQUIREMENTS OR DISTURBING FACTORS PRIO TO SCHEDULING DEMOLISHING.	
9. ALL DEMOLISHING TO BE DONE DURING STANDARD HOURS AND REGULAR DAYS. FOR DEMOLISHING DURING WEEKENDS, HOLIDAYS NEIGHBORS PERMISSION MUST BE SOUGHT.	
10. CONTRACTOR TO ENSURE SAFETY REQUIREMENTS UNDER PROVINCIAL CODE FOR CREW AND PASSERBY PERSONS	
^{11.} PROVIDE 1 HOSE, NON-FREEZE TYPE, CAULK AND SEAL ALL OPENINGS AROUND SERVICE PIPES.	
EXISTING WALL TO REMAIN	24'-1"
EXISTING WALL TO BE DEMOLISHED	
	1 A1.01 EX.FIRST FLOOR PLAN SCALE= 1/4"=1'-0"




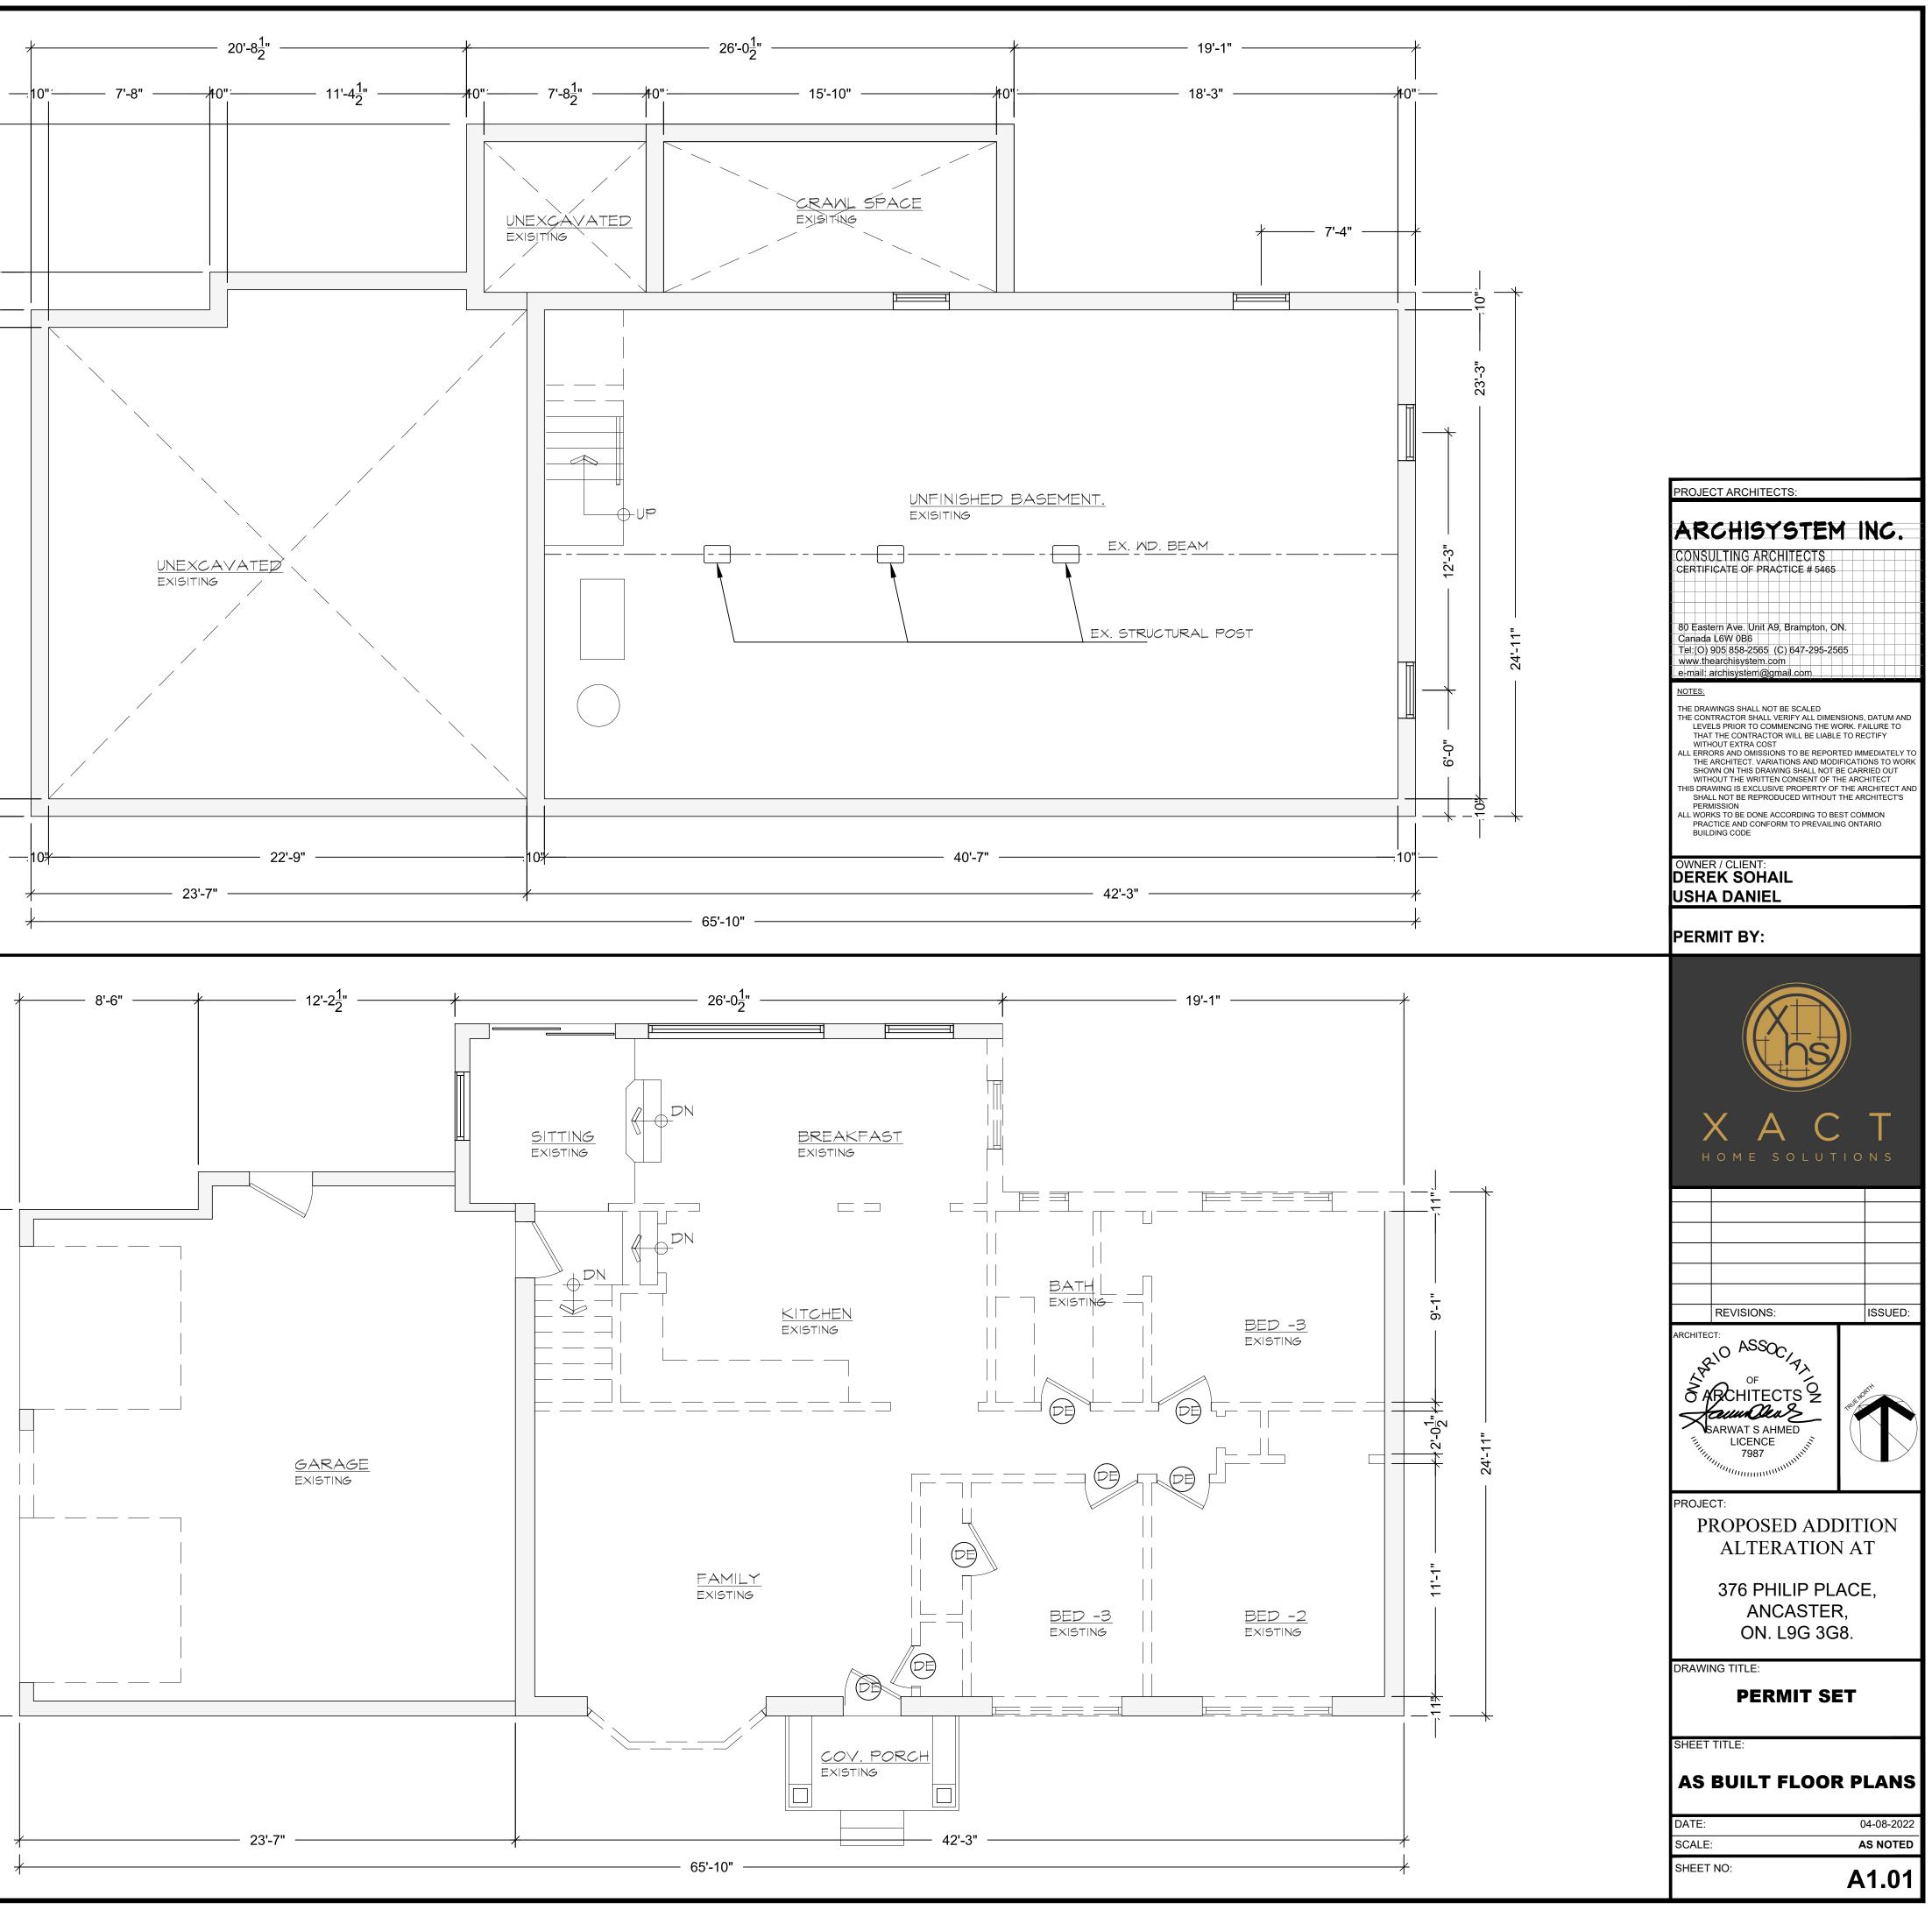

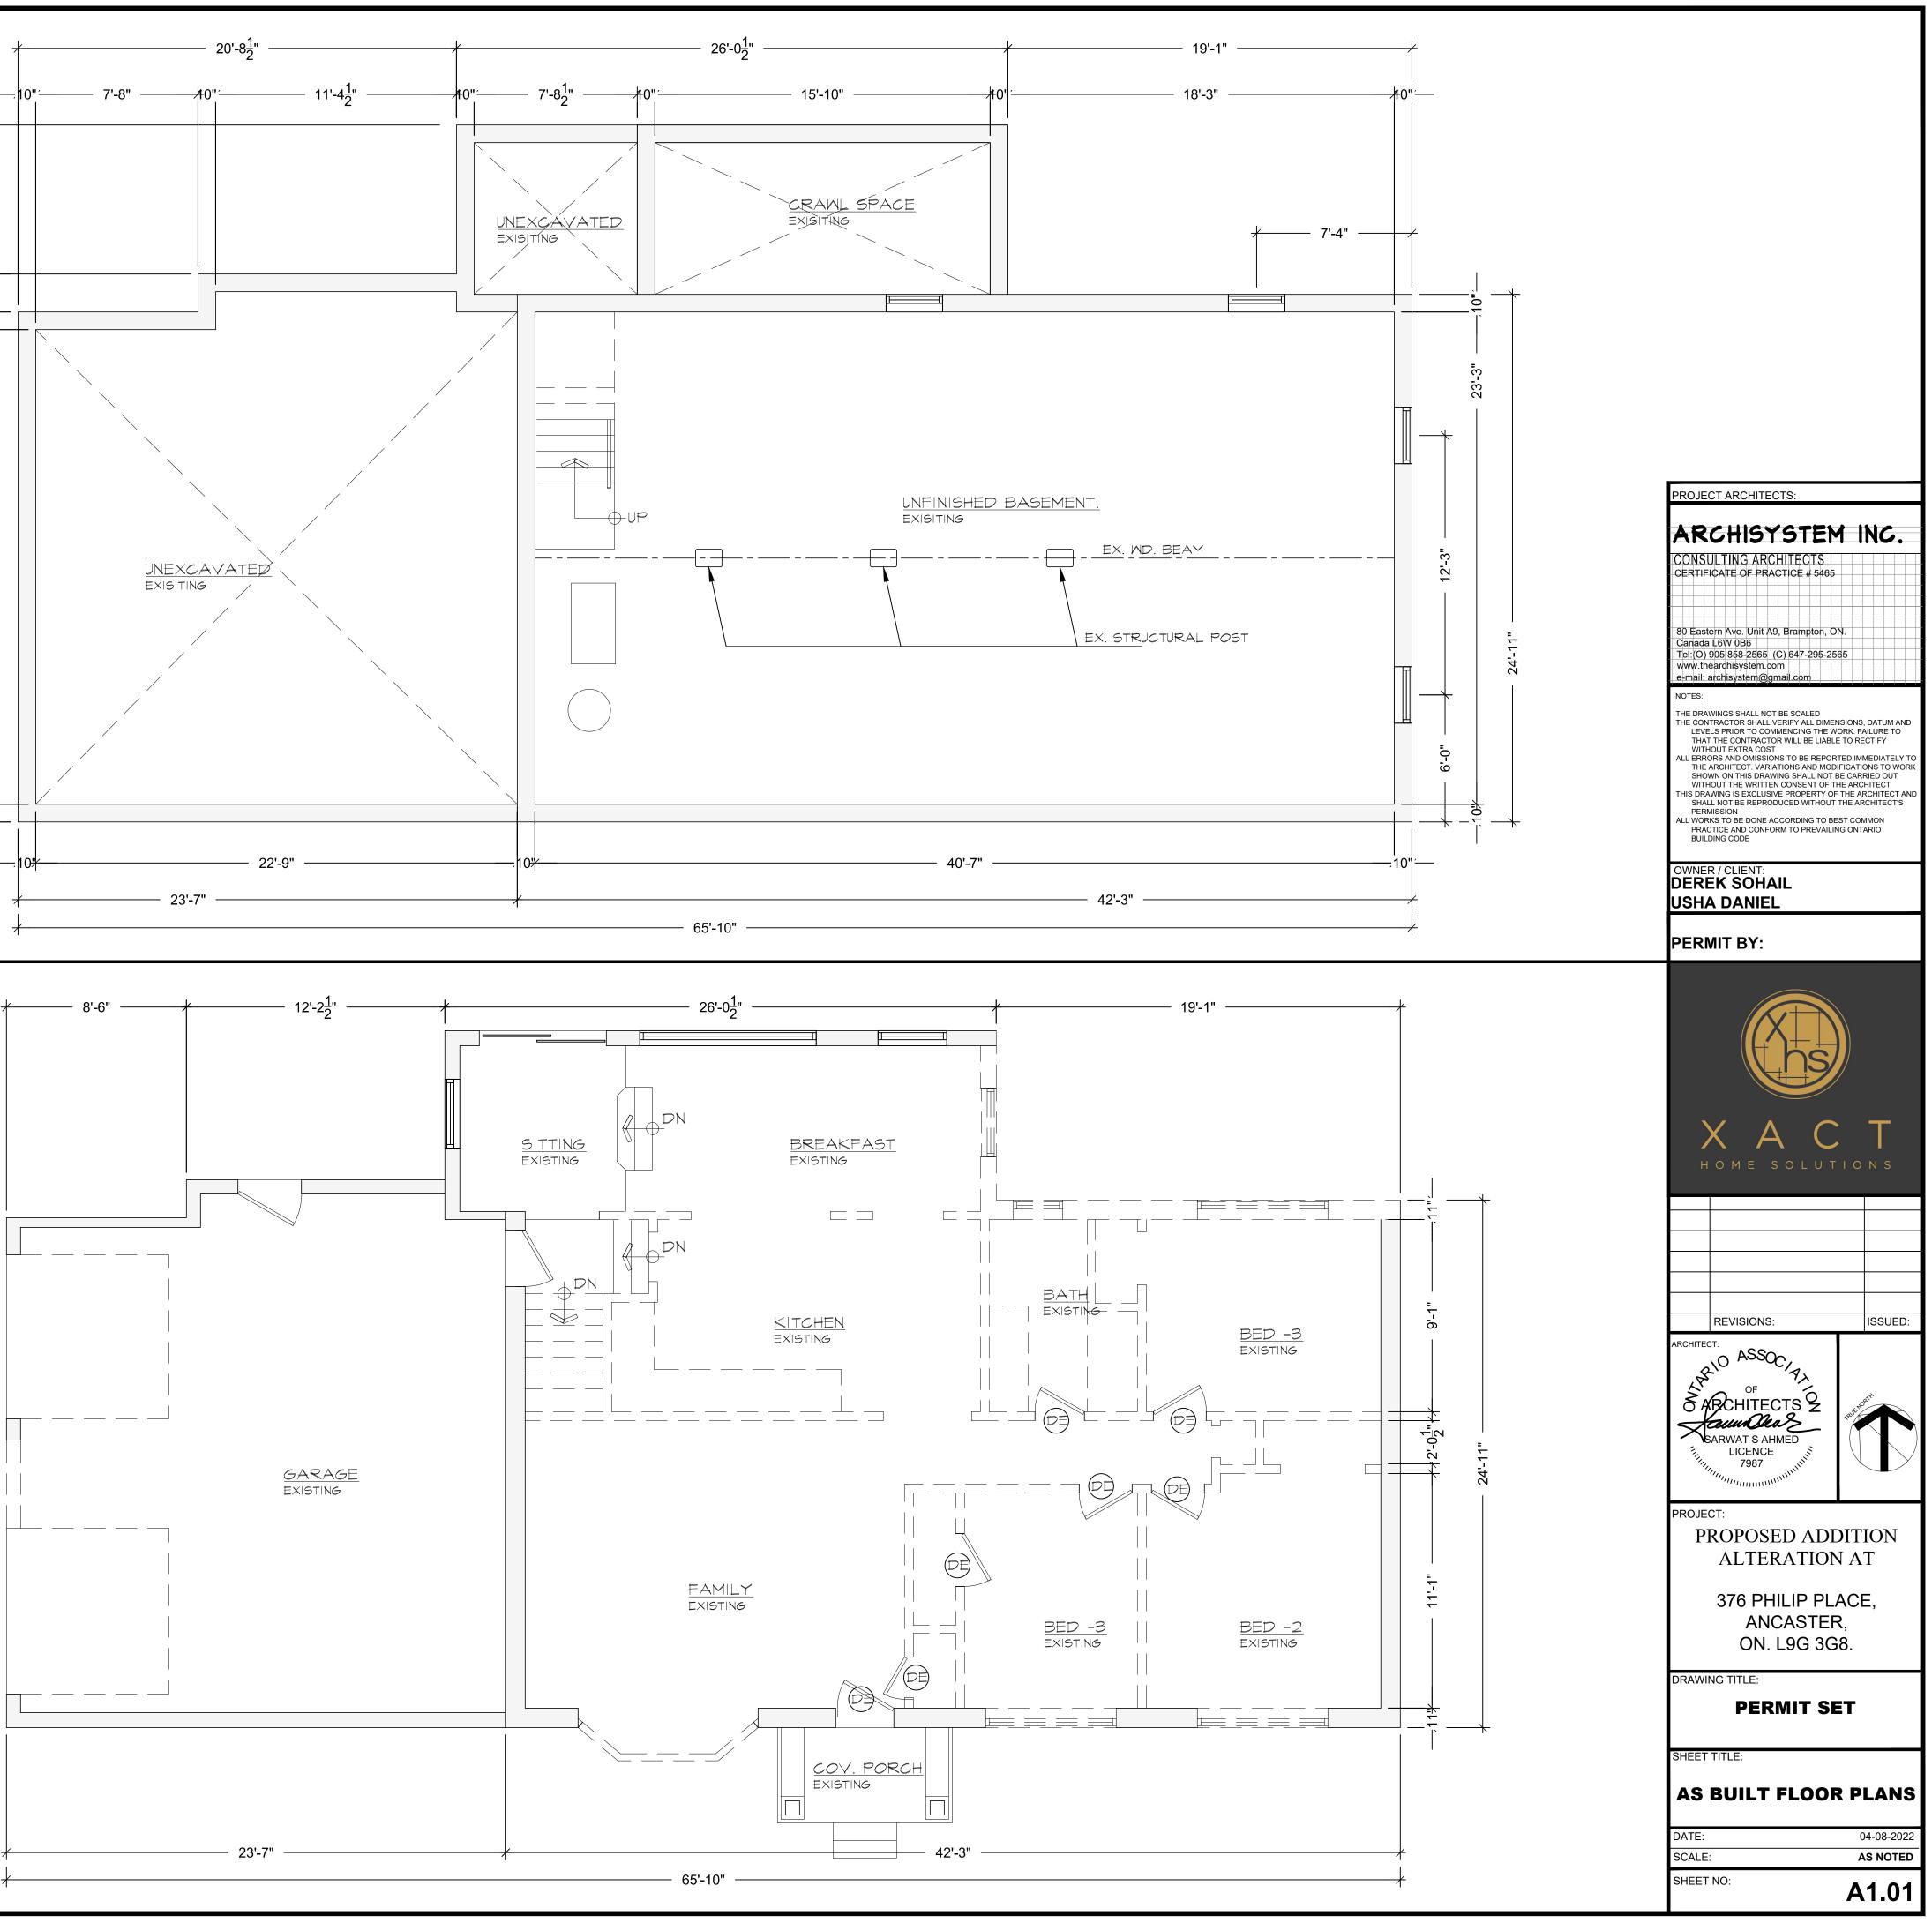

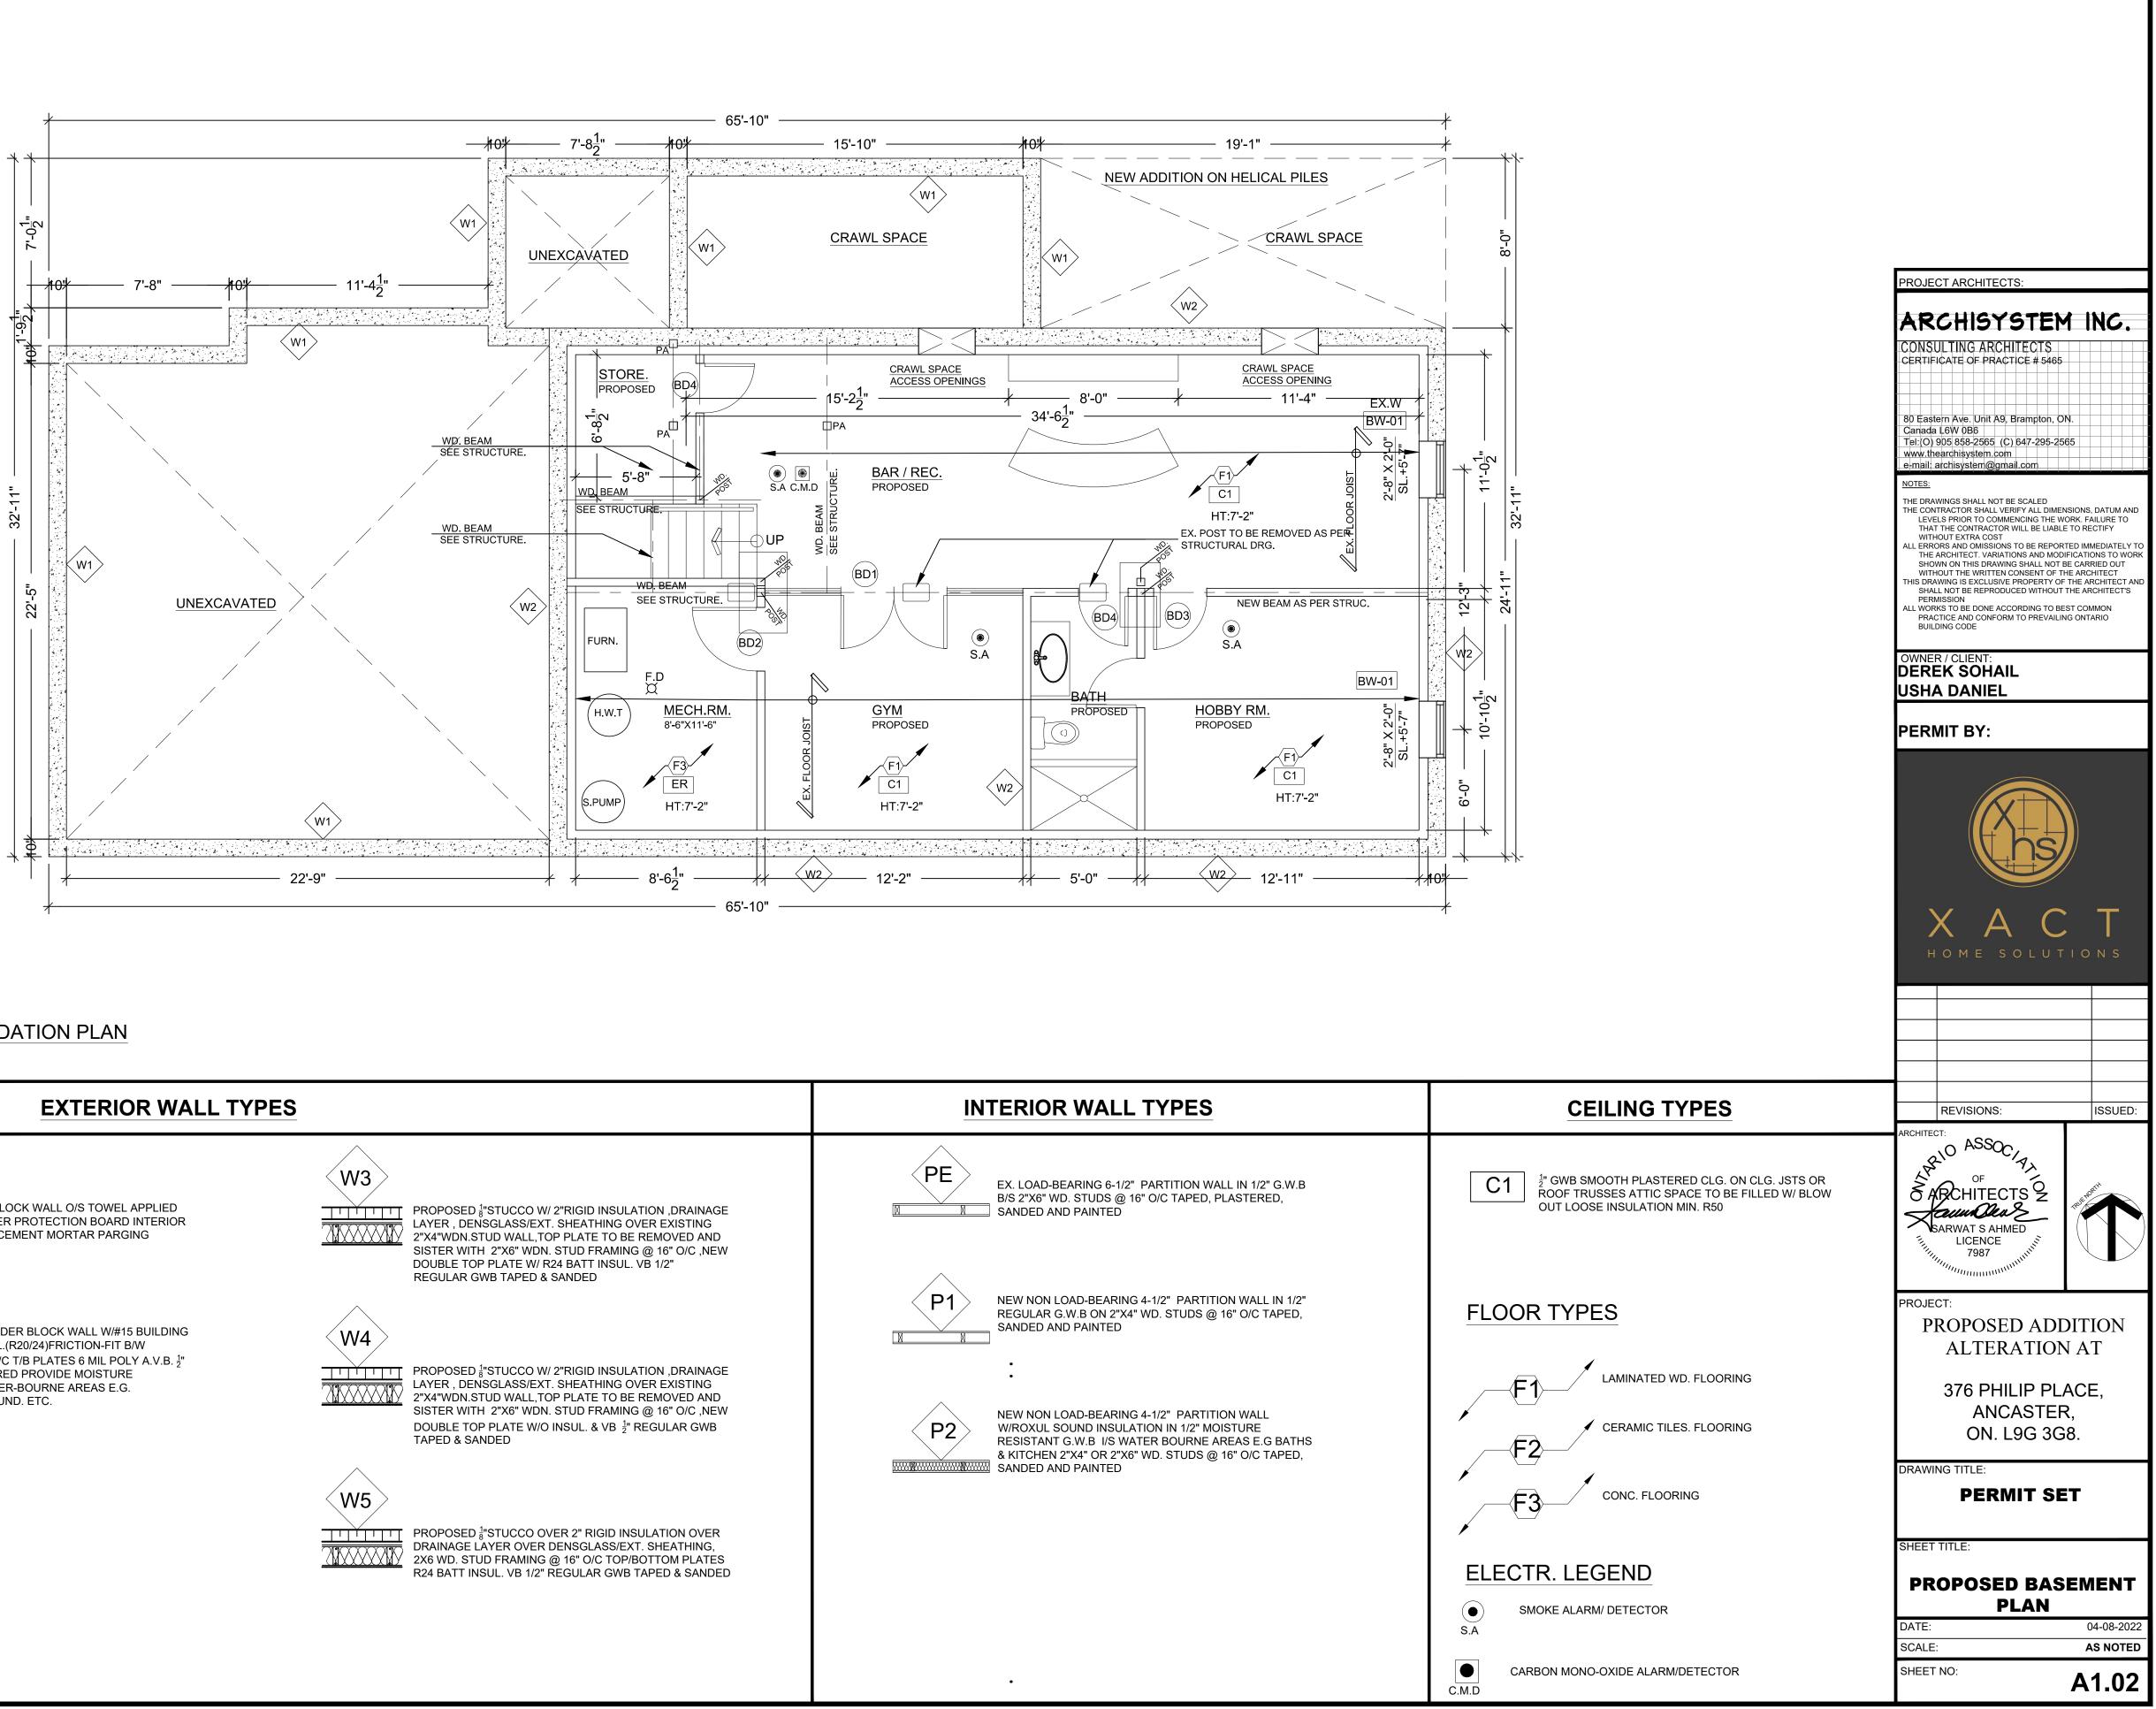




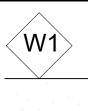



EXISTING 10" CINDER BLOCK WALL O/S TOWEL APPLIED WATERPROOFING LAYER PROTECTION BOARD INTERIOR SMOOTH SURFACE W/ CEMENT MORTAR PARGING WHERE REQUIRED





EXISTING 10" POUR CINDER BLOCK WALL W/#15 BUILDING PAPER 3.5"SR PRO.INSL.(R20/24)FRICTION-FIT B/W - 2"X4"WD.STUDS @16"O/C T/B PLATES 6 MIL POLY A.V.B. 1/2" GWB TAPED & PLASTERED PROVIDE MOISTURE RESISTANT GB AT WATER-BOURNE AREAS E.G. WASHROOM KIT OR LAUND. ETC.

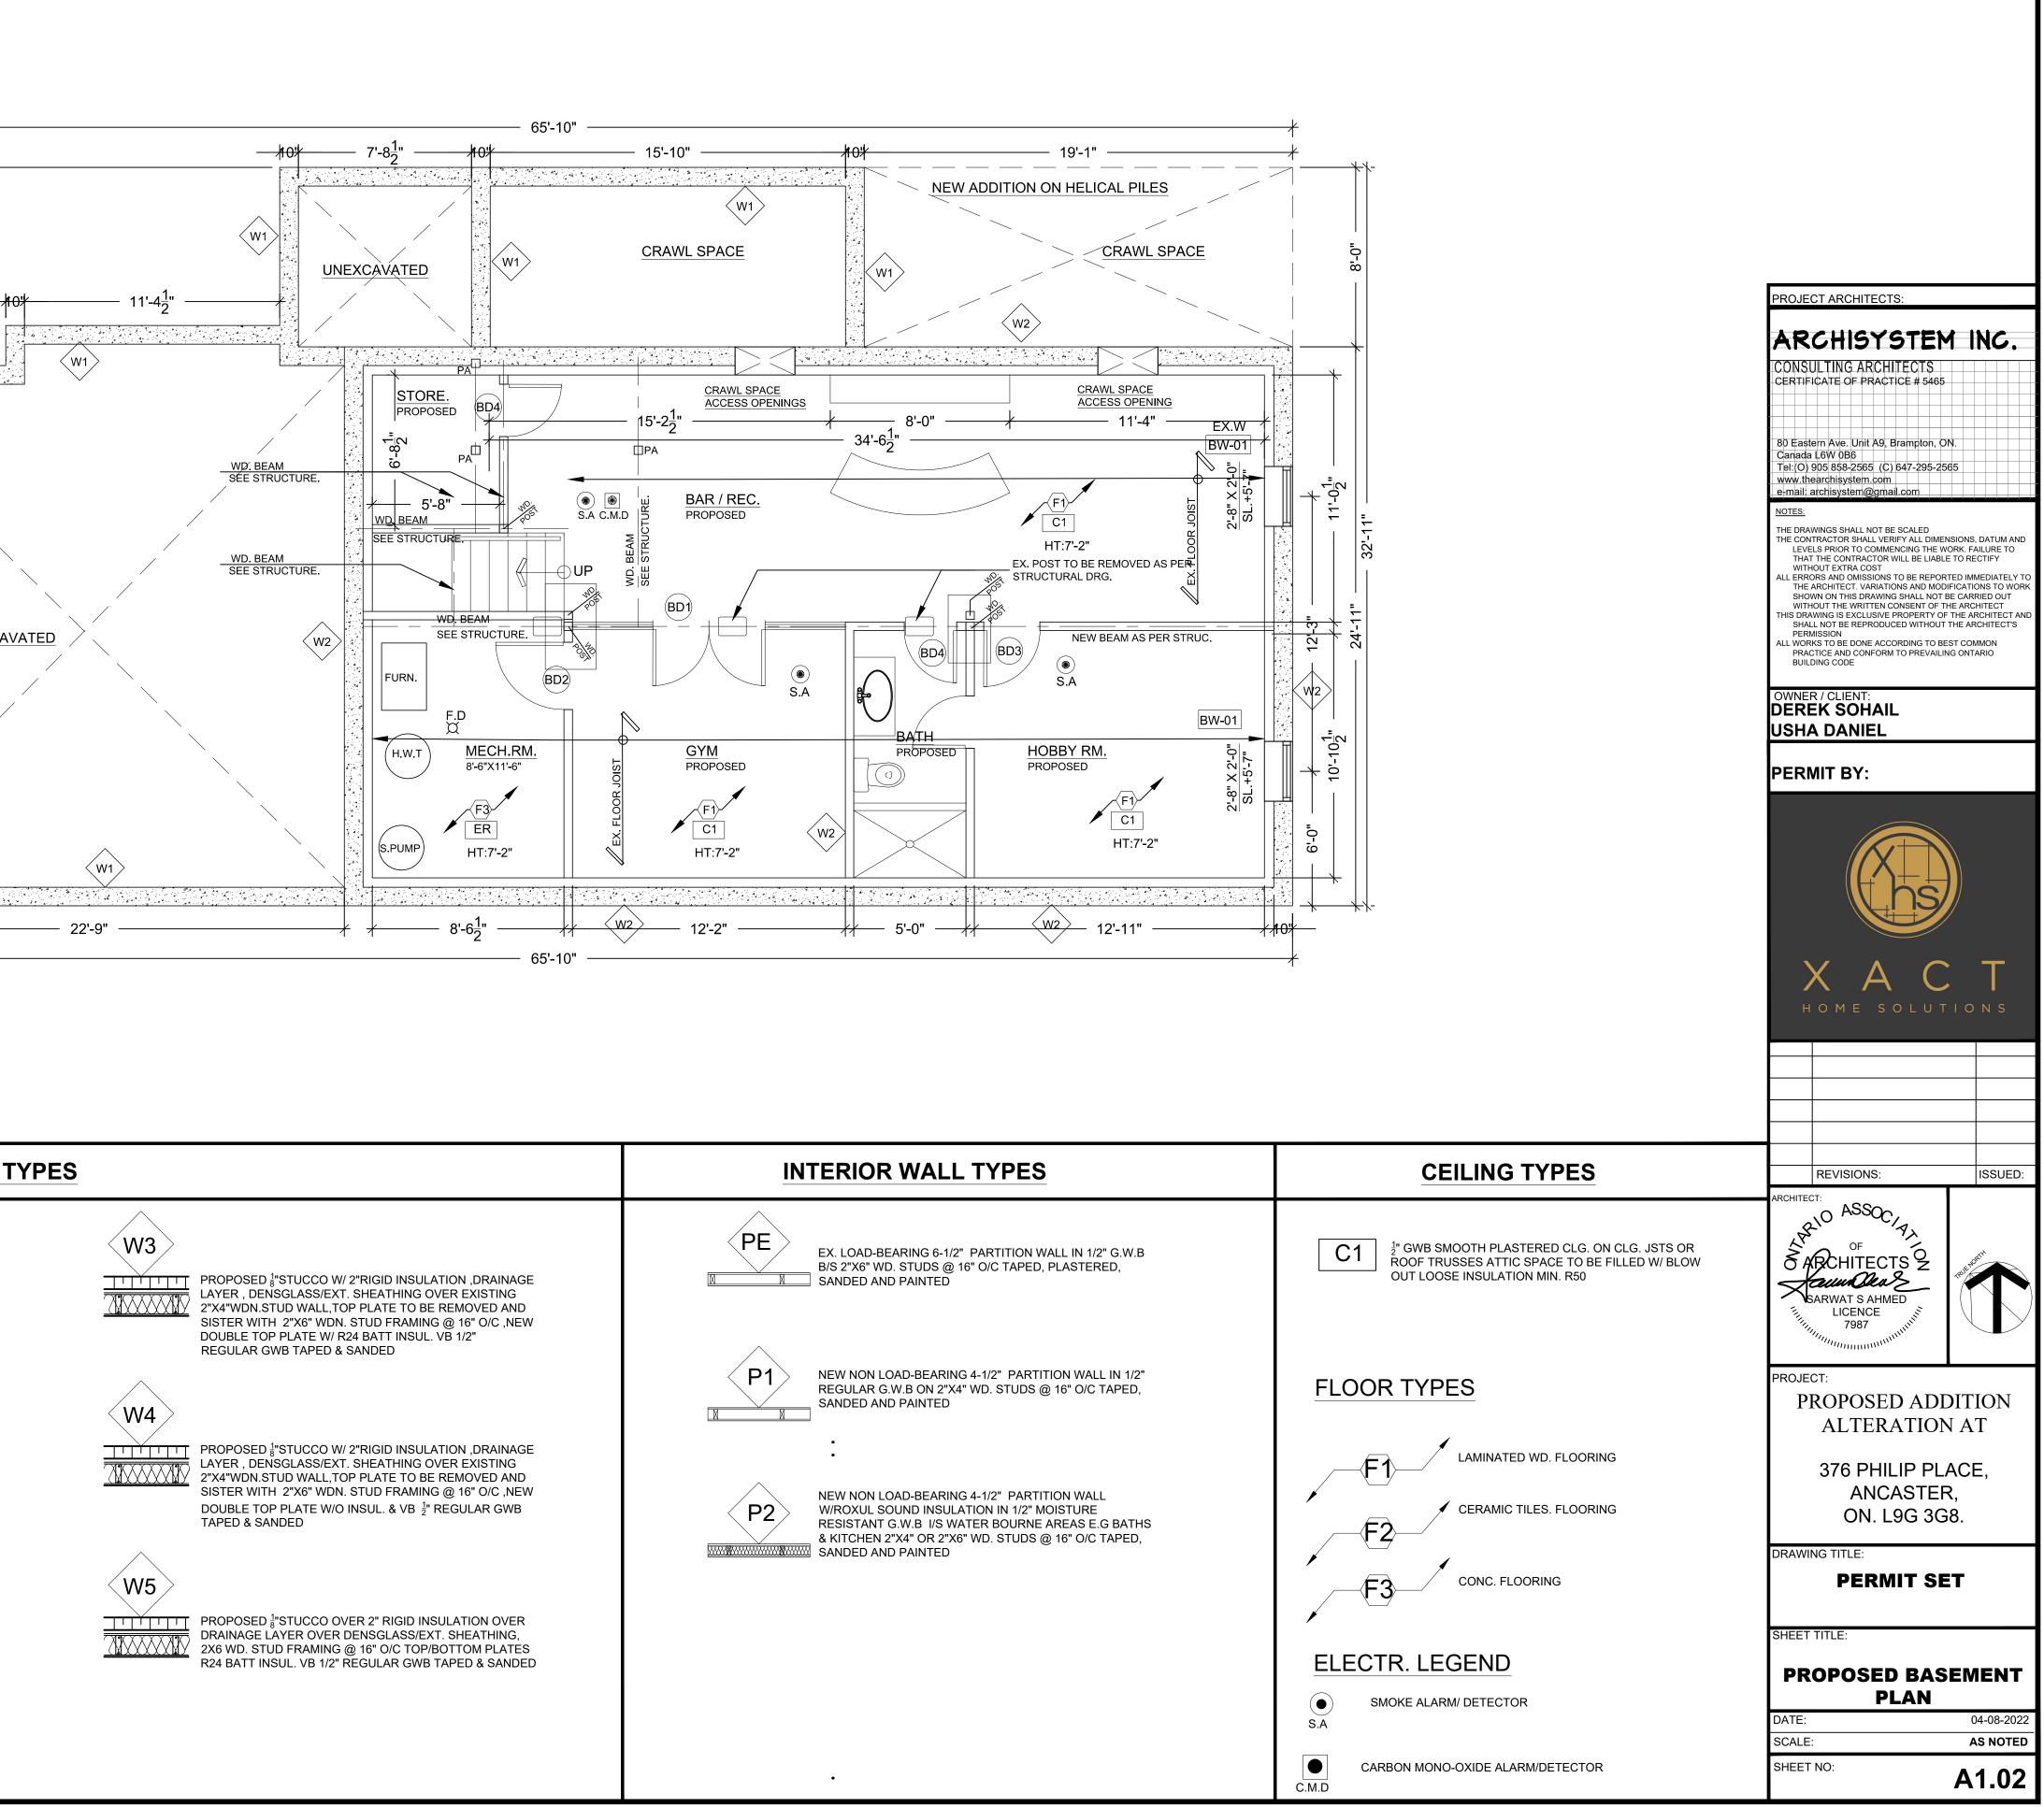


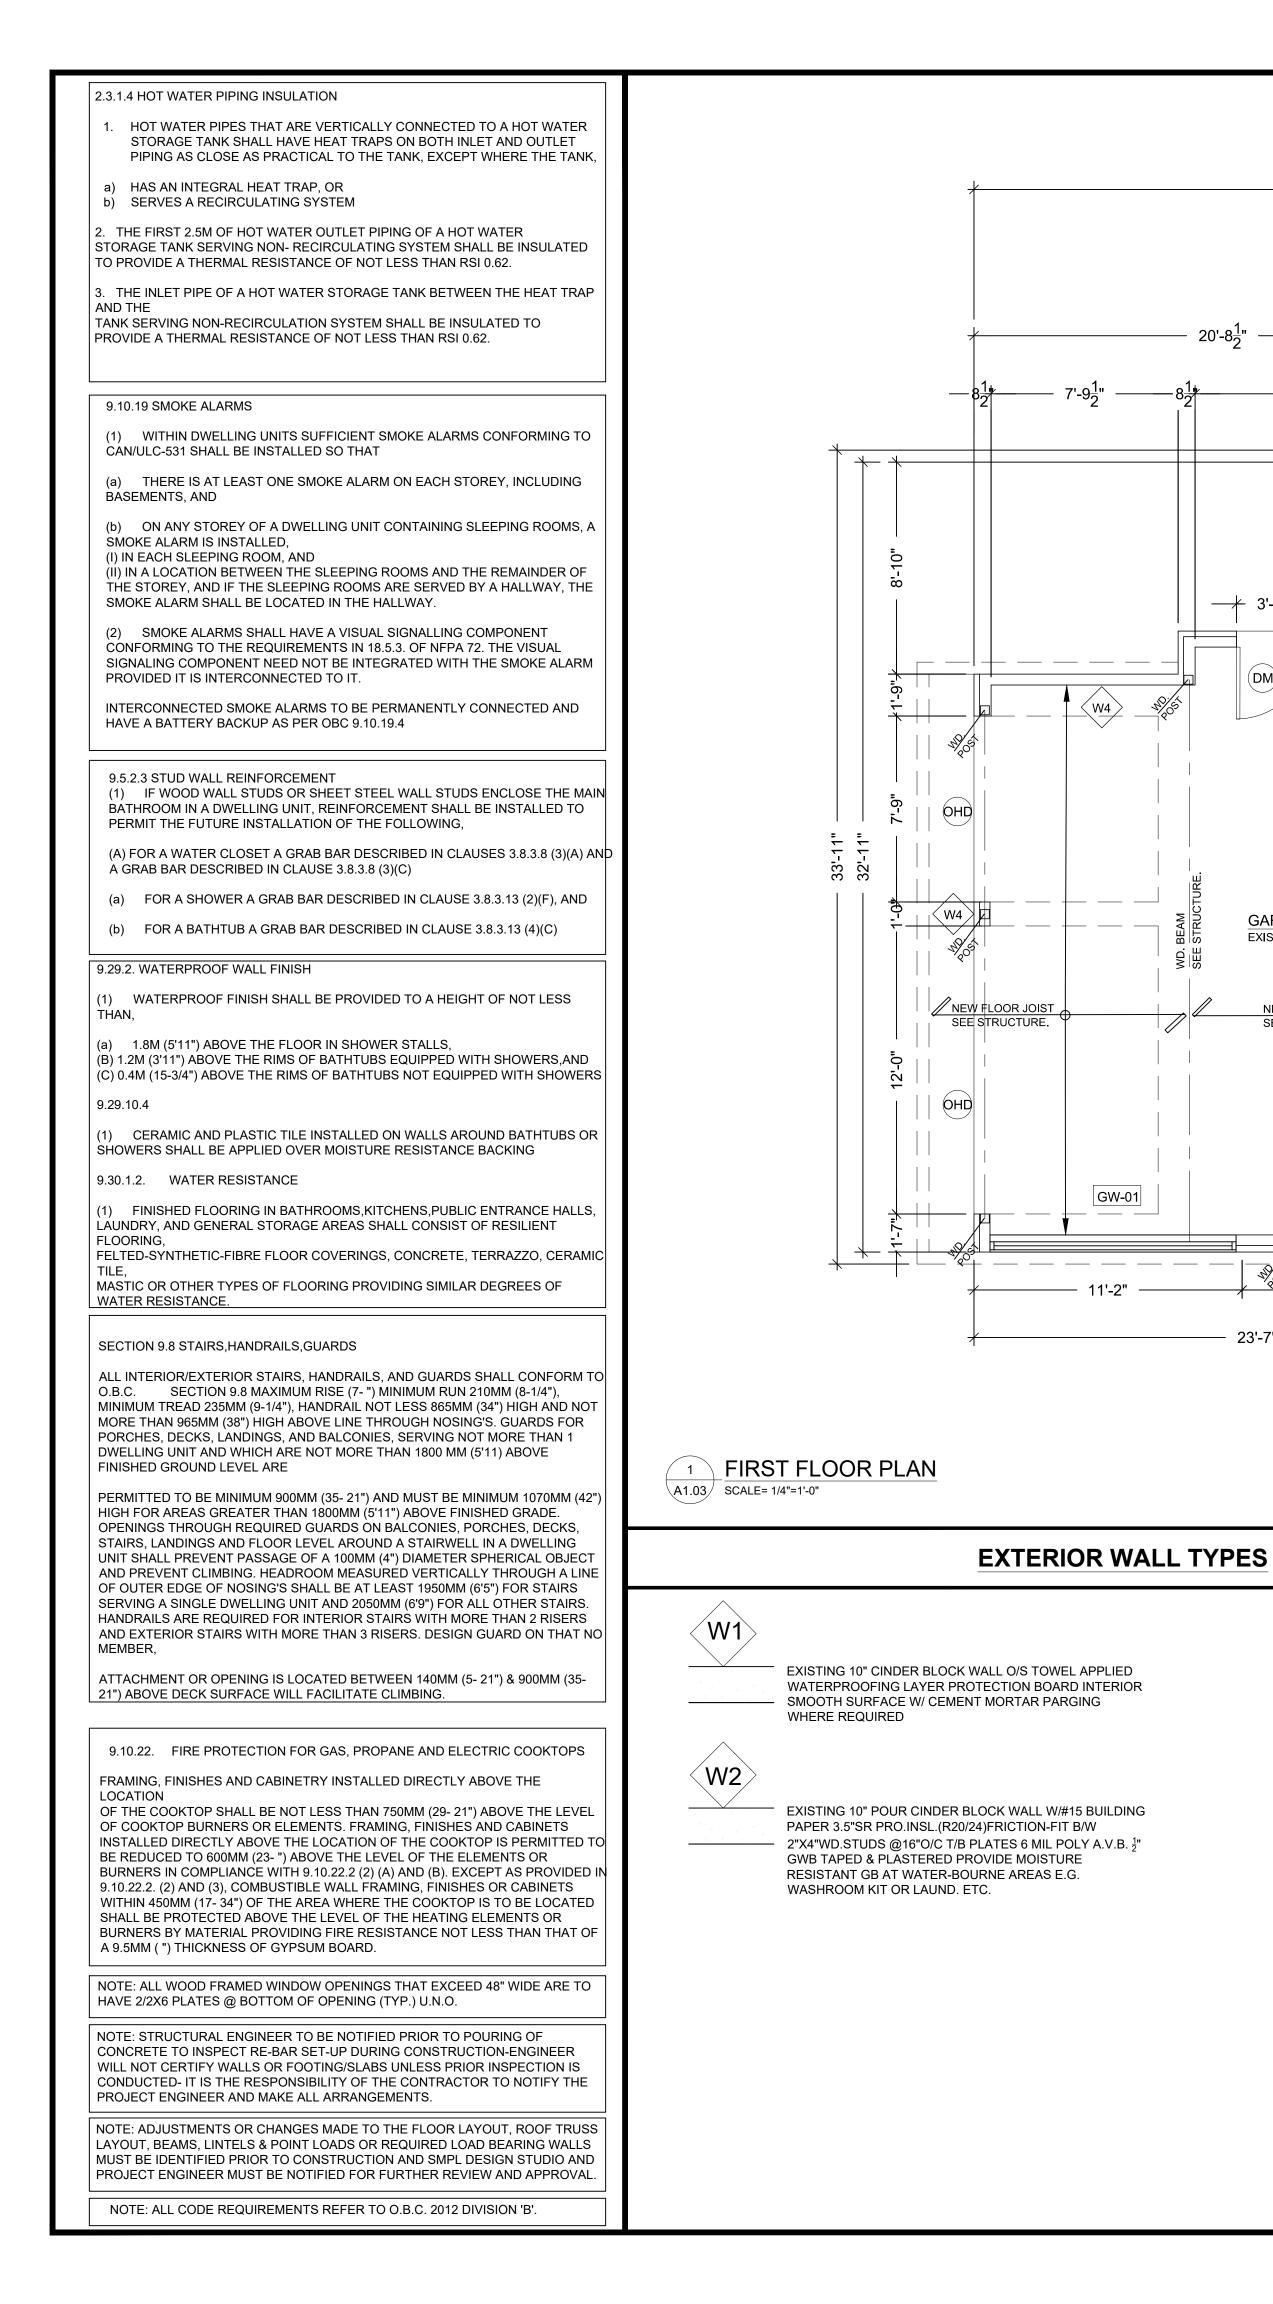

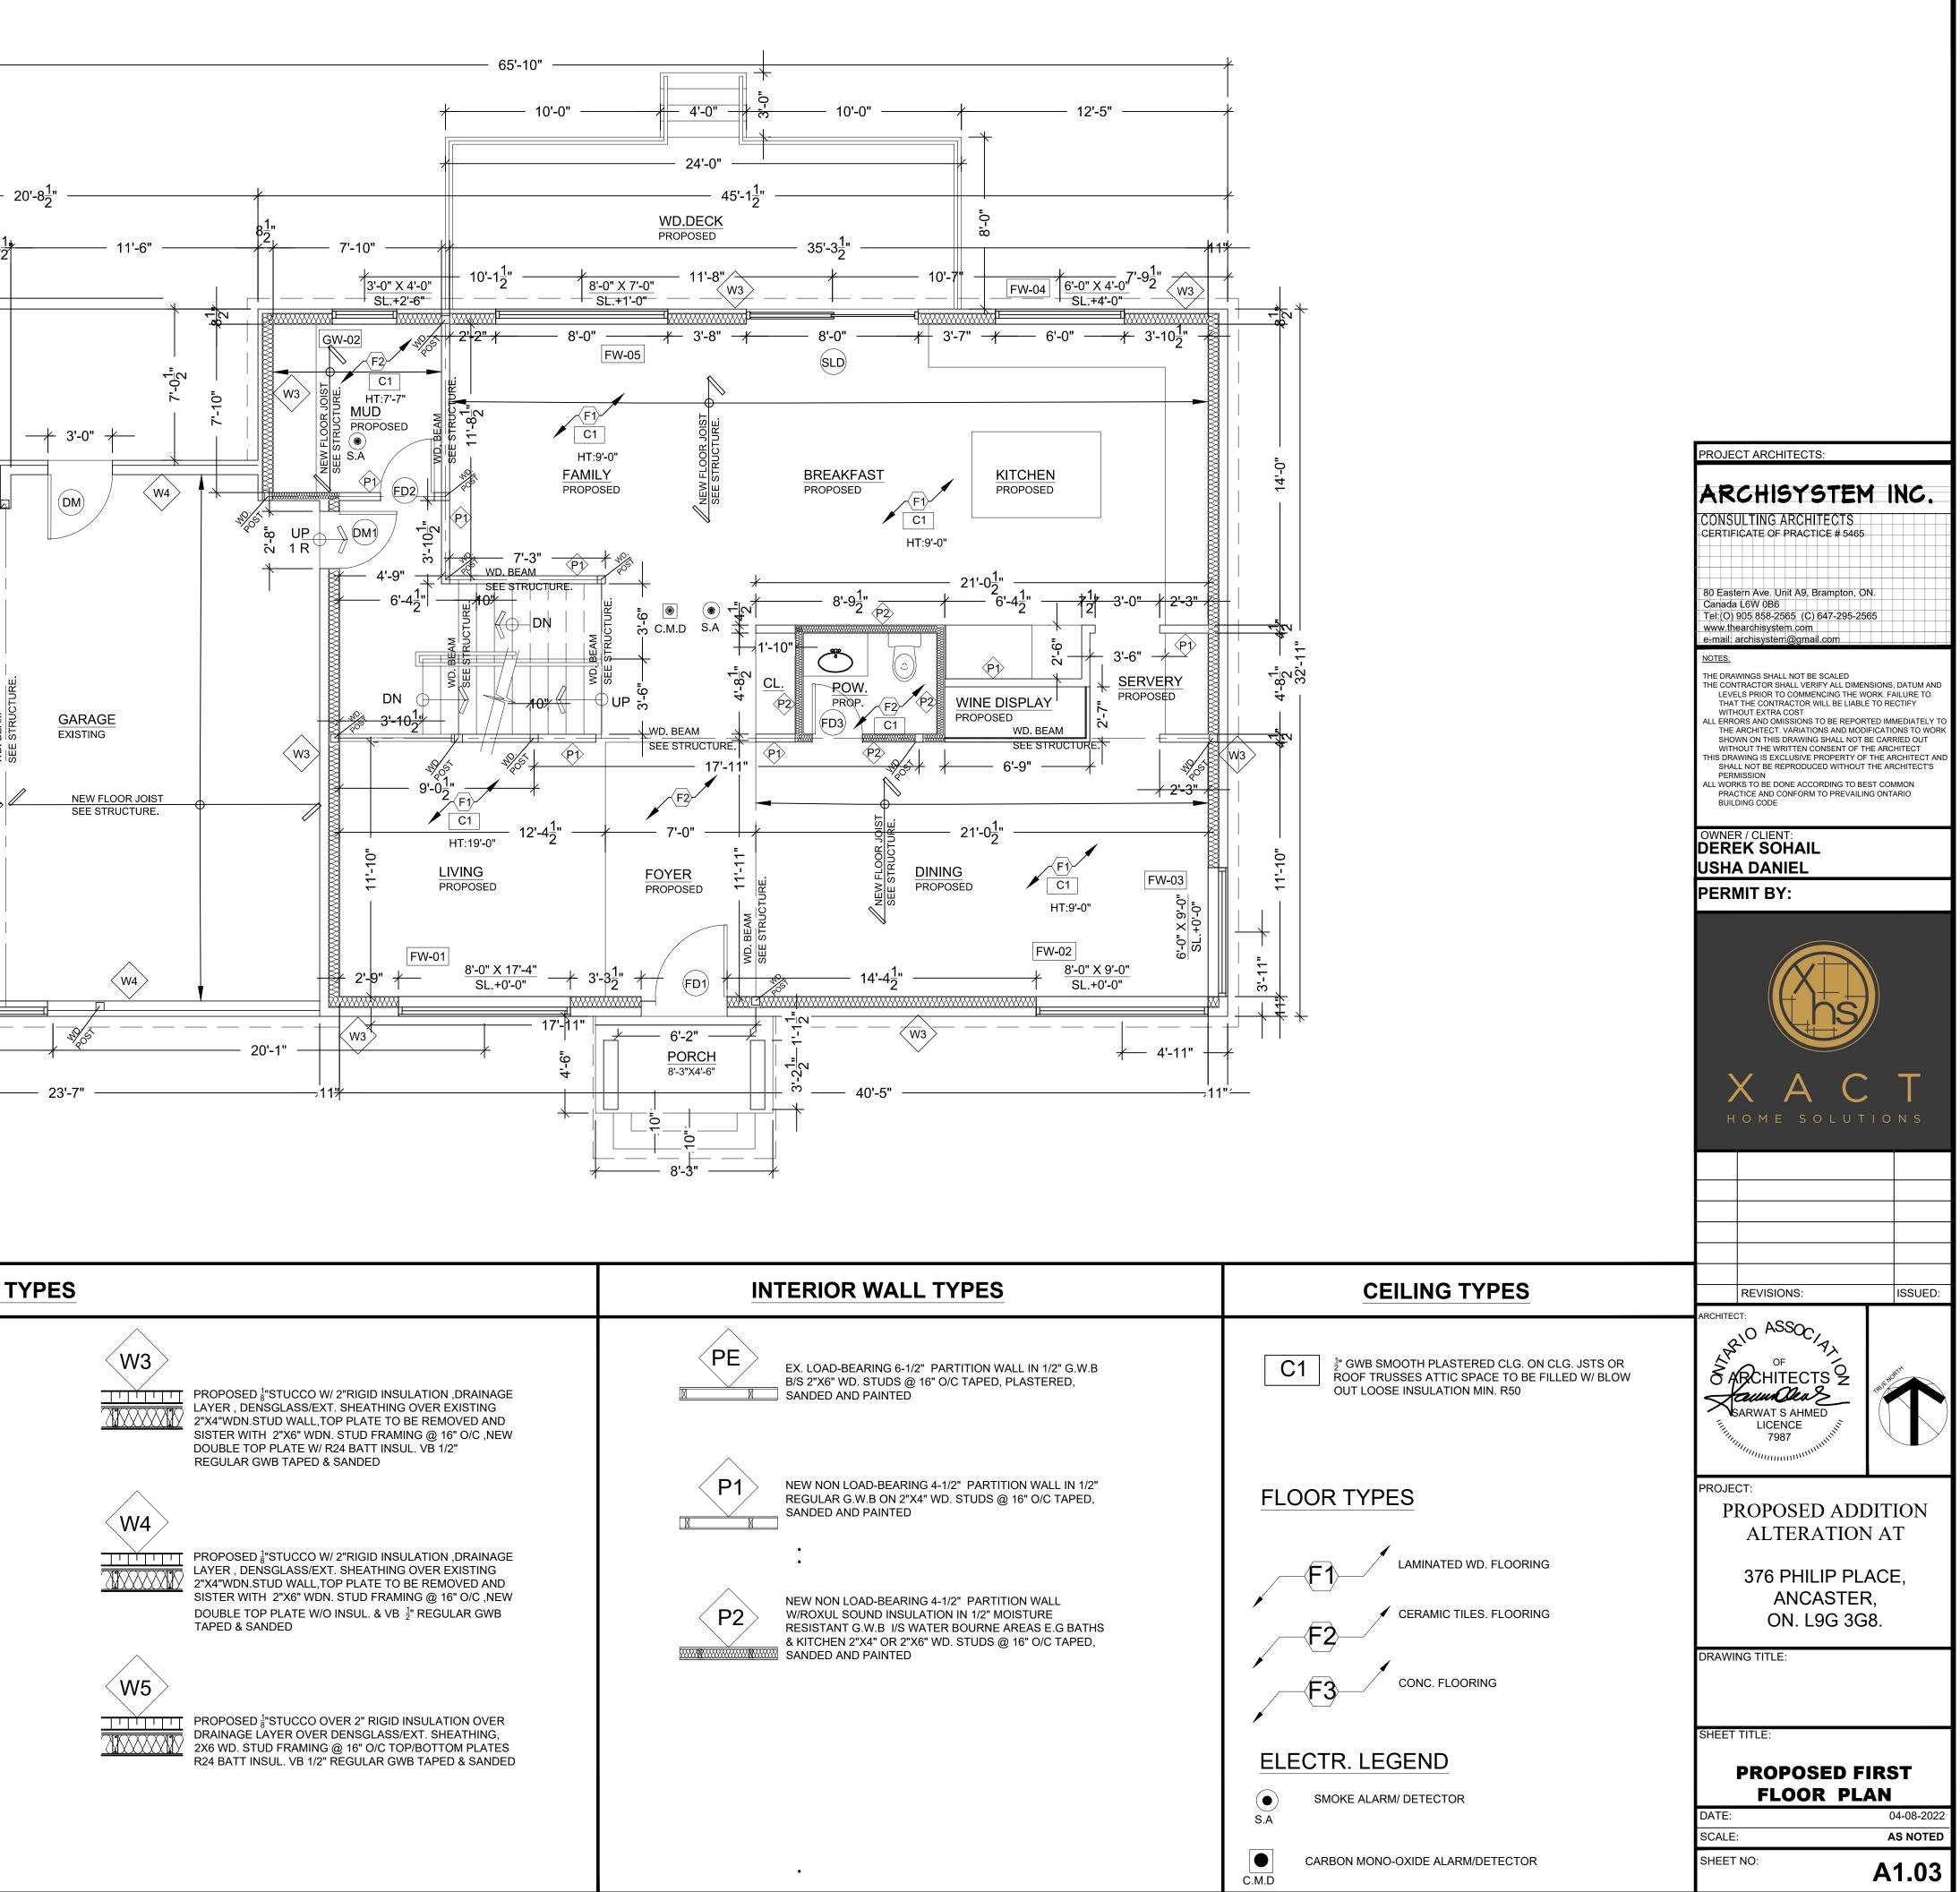

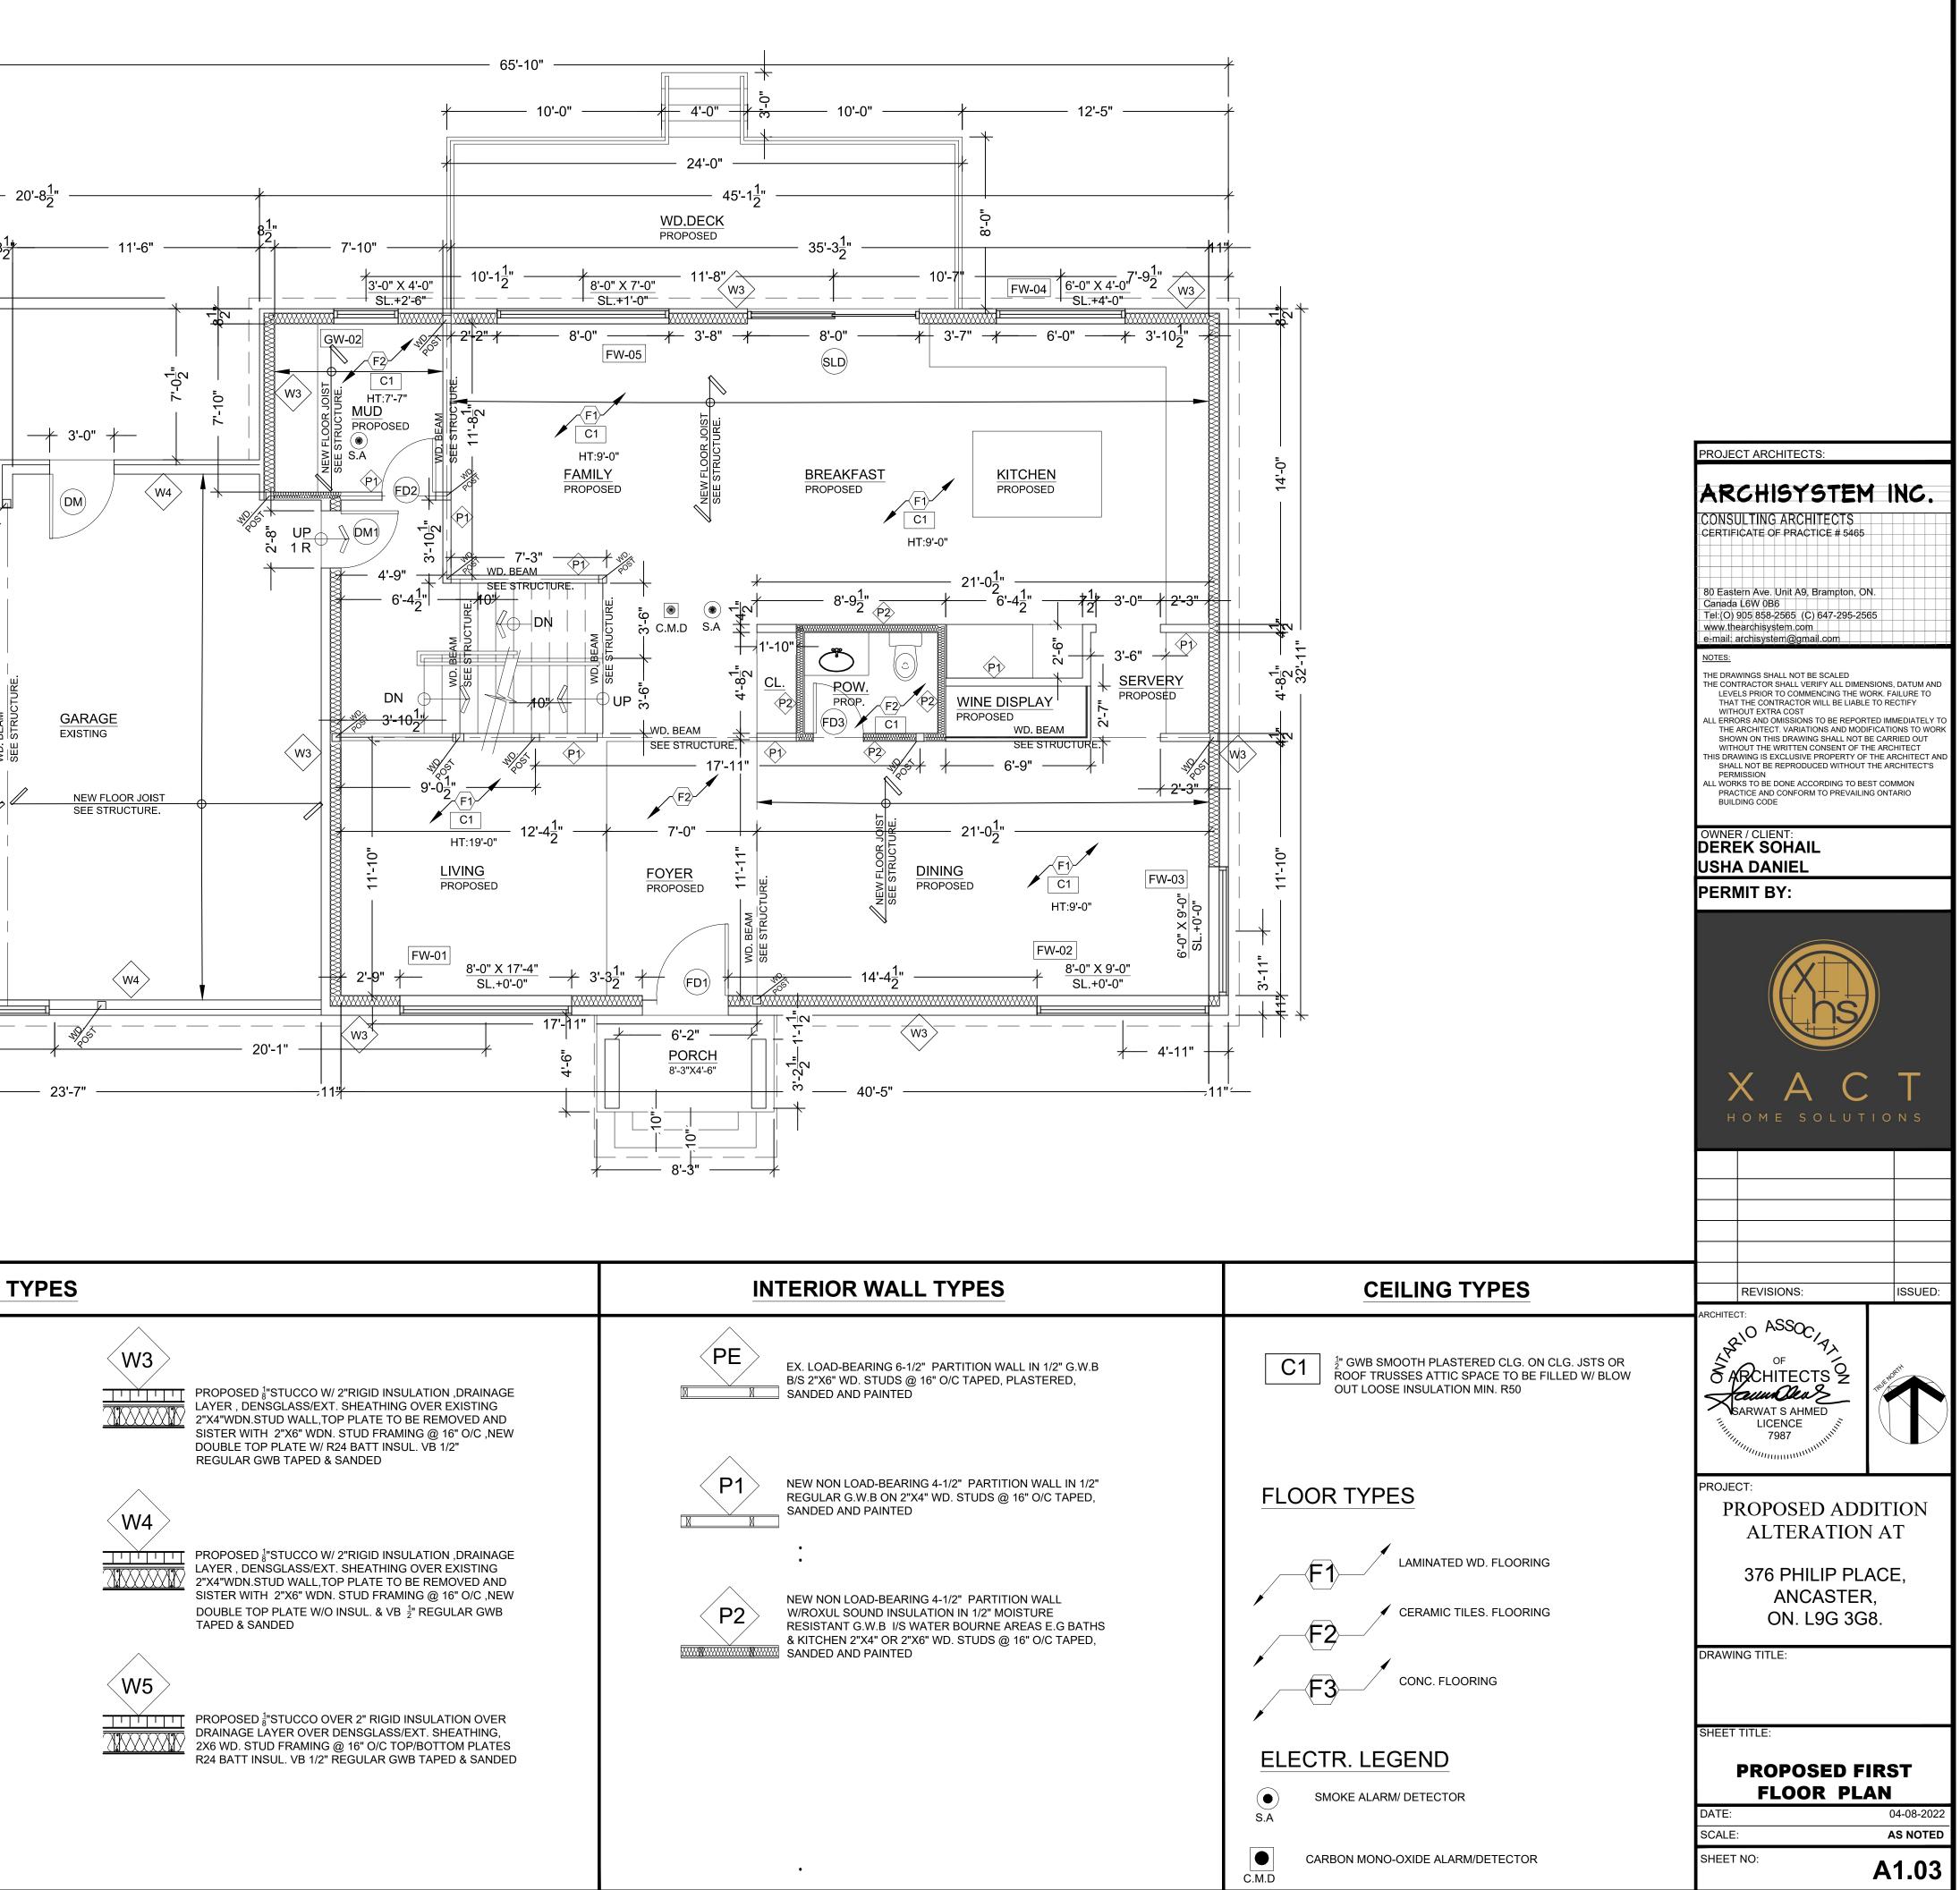

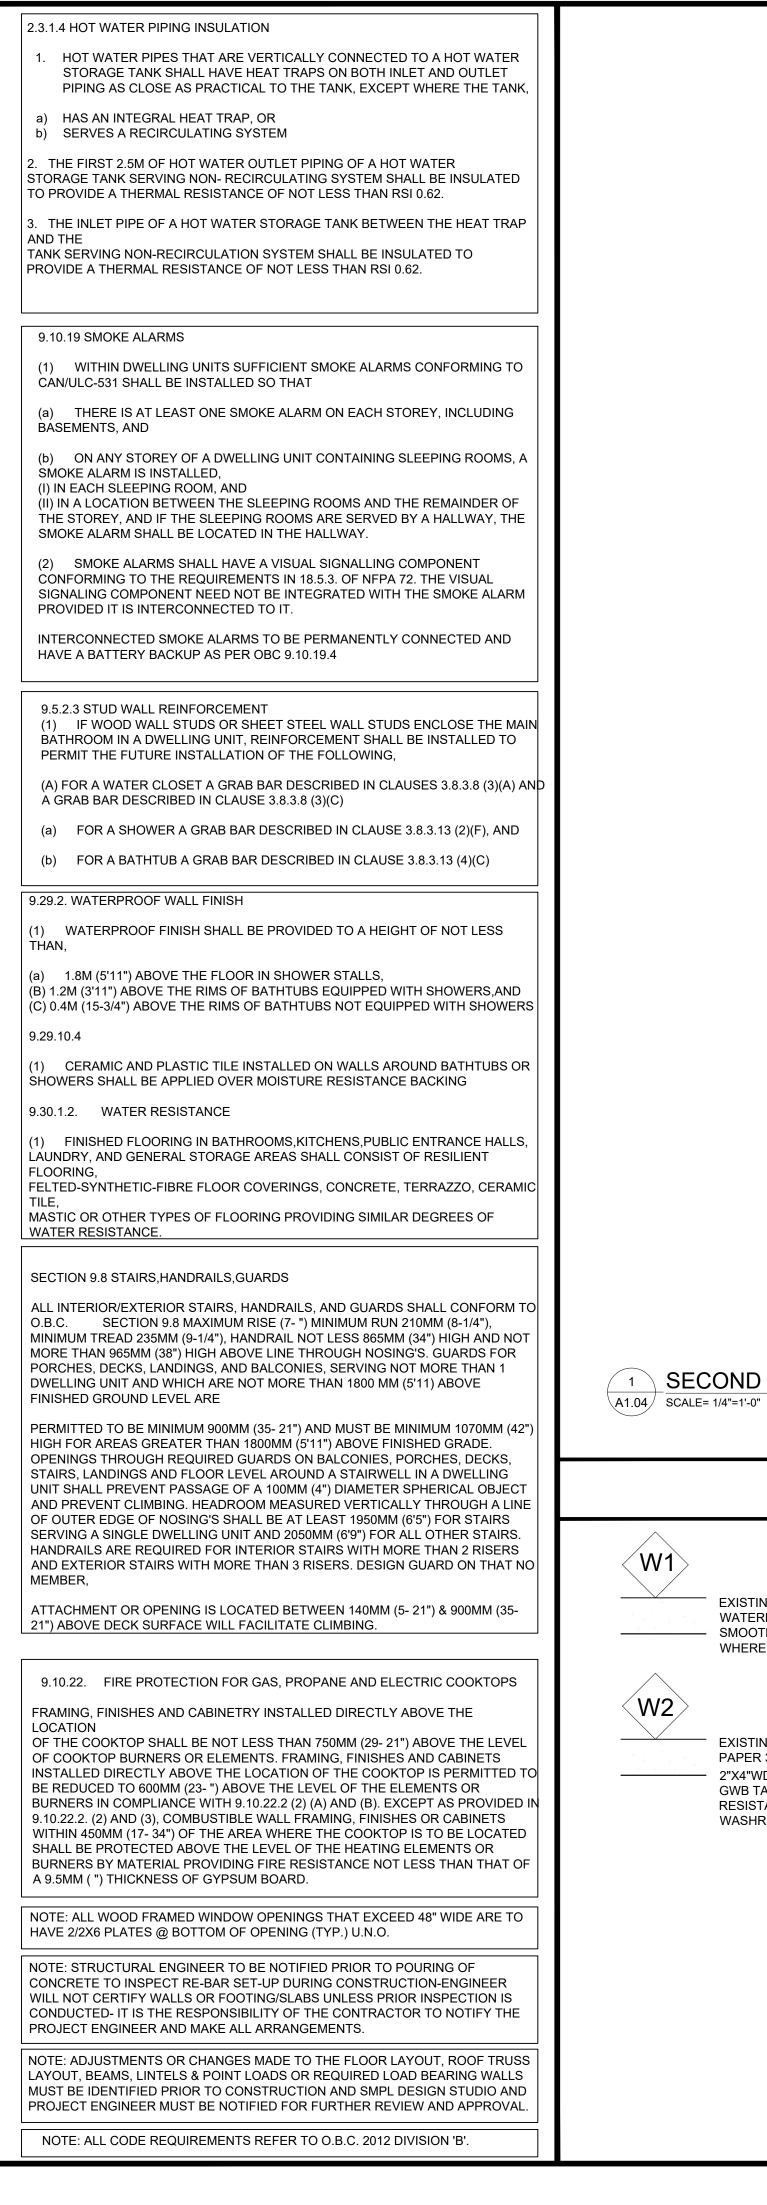

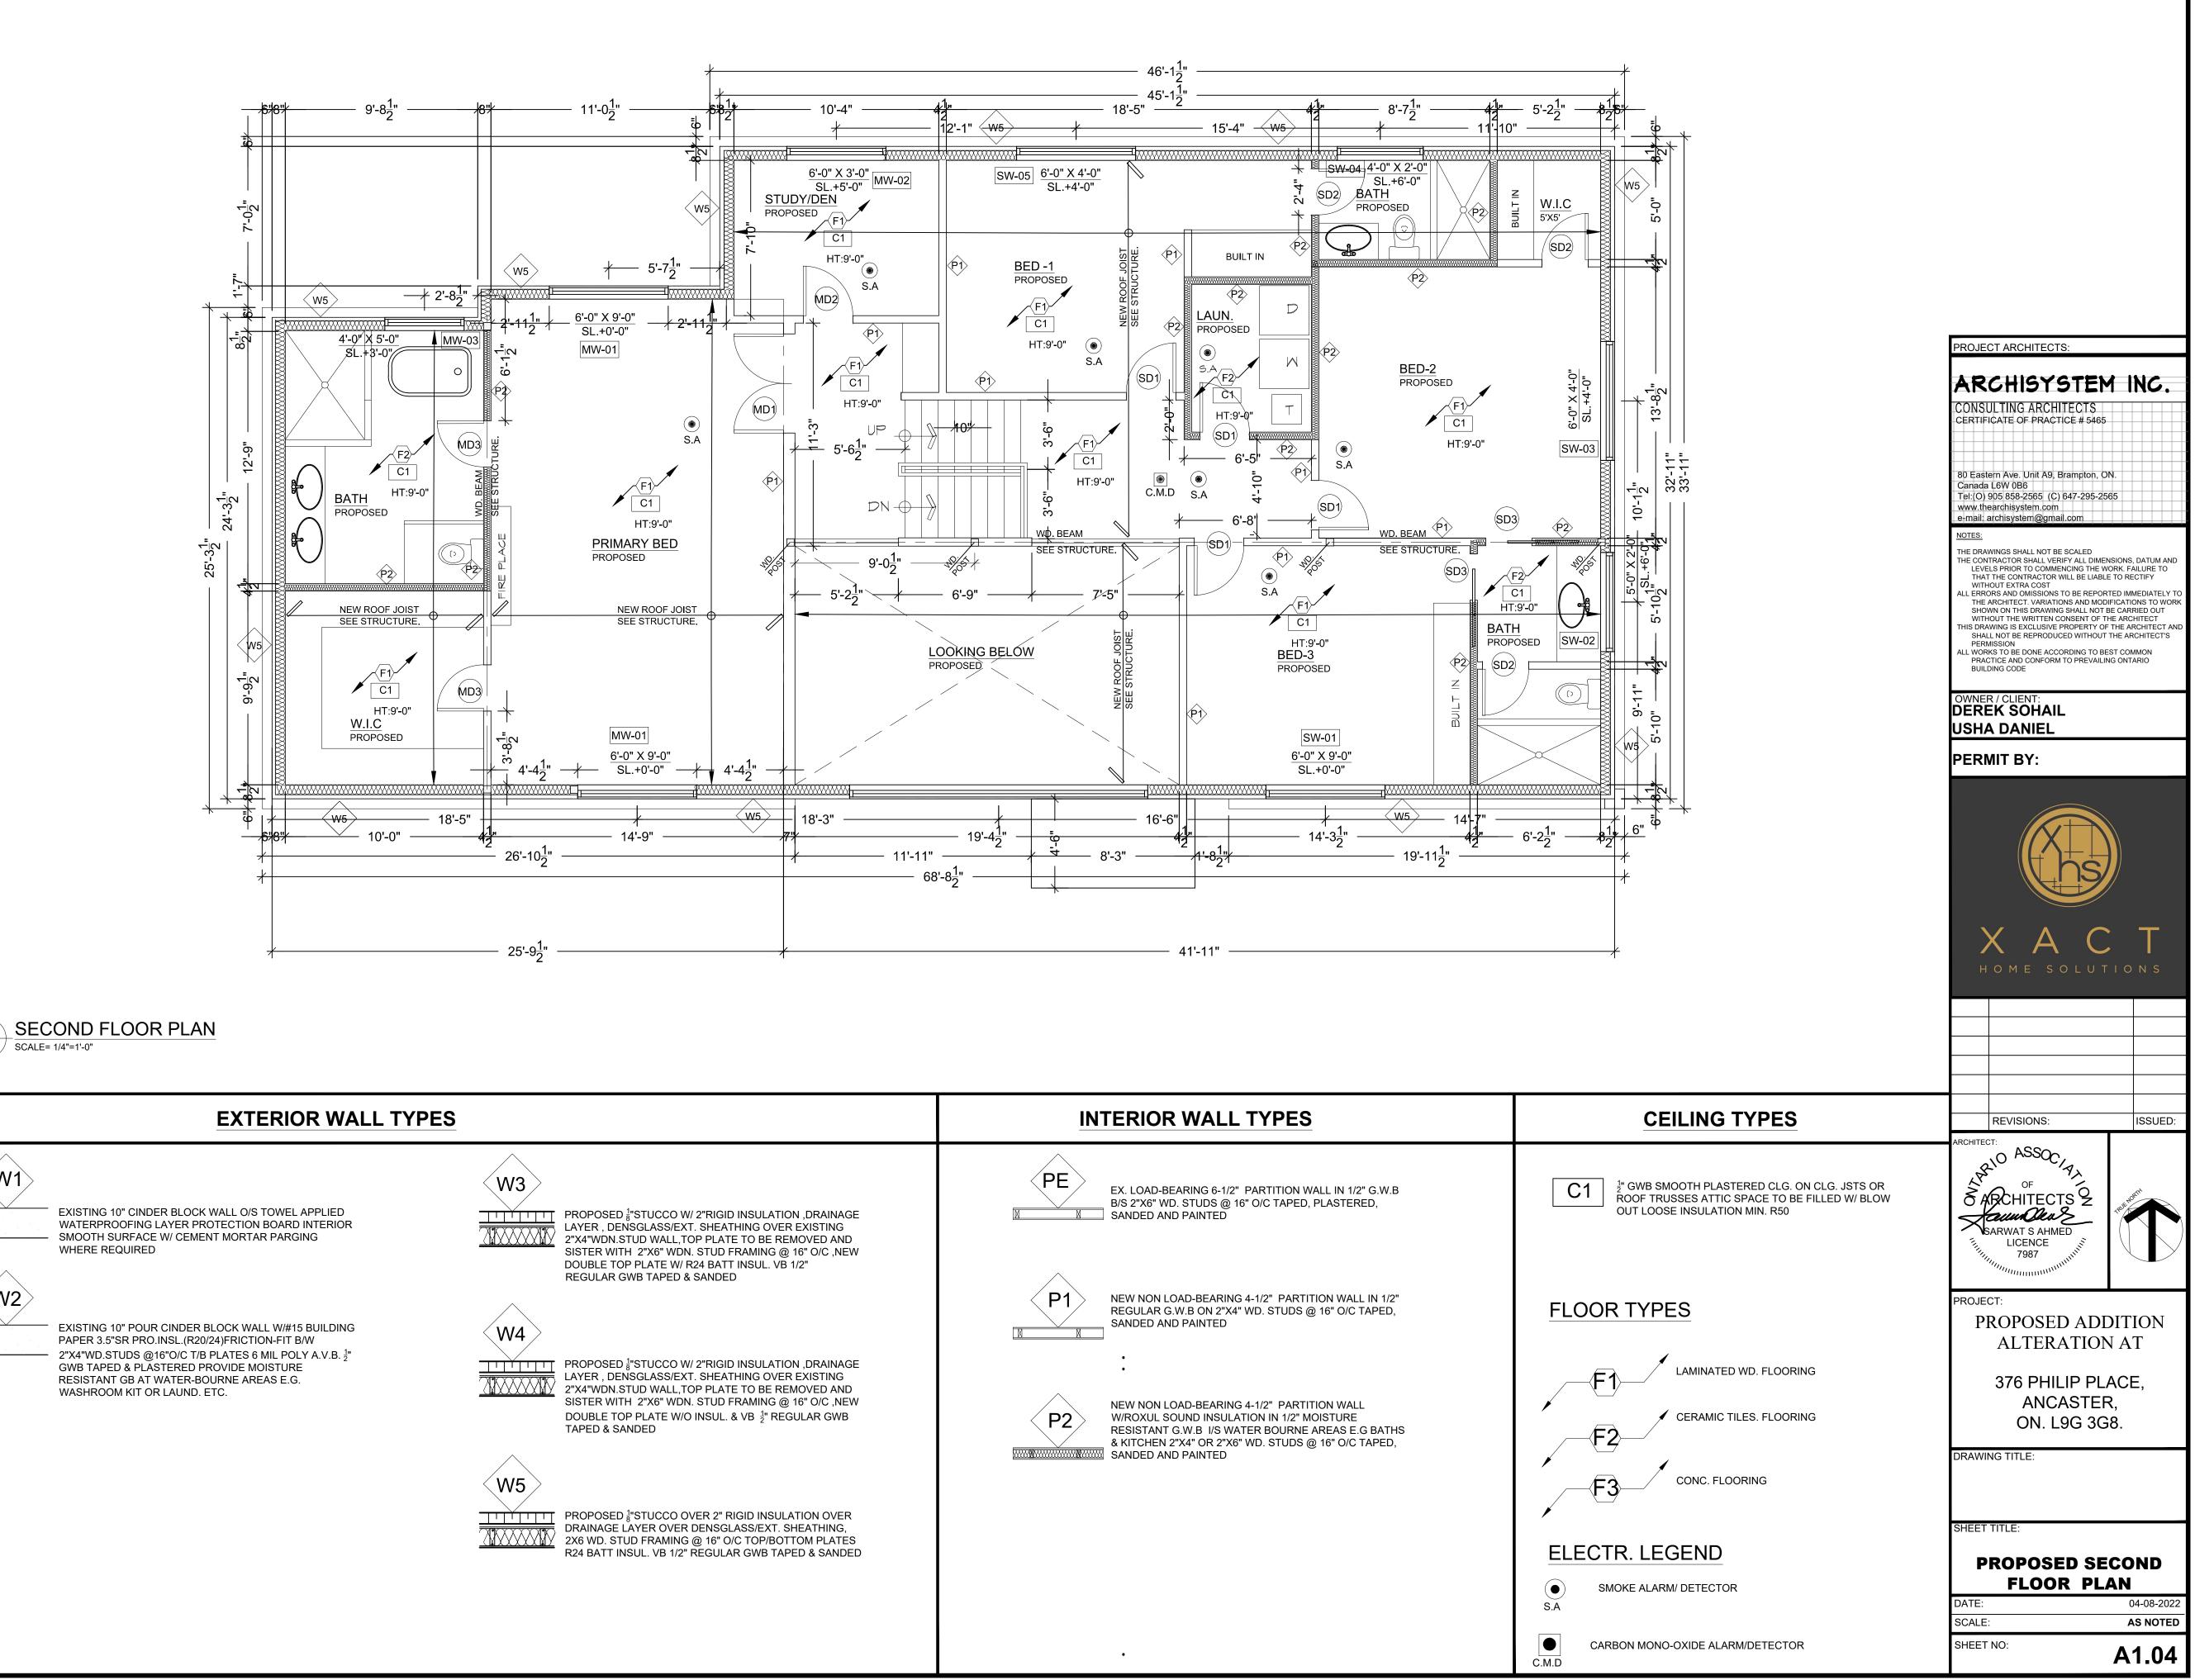



EXISTING 10" CINDER BLOCK WALL O/S TOWEL APPLIED WATERPROOFING LAYER PROTECTION BOARD INTERIOR —— SMOOTH SURFACE W/ CEMENT MORTAR PARGING




WHERE REQUIRED

EXISTING 10" POUR CINDER BLOCK WALL W/#15 BUILDING PAPER 3.5"SR PRO.INSL.(R20/24)FRICTION-FIT B/W 2"X4"WD.STUDS @16"O/C T/B PLATES 6 MIL POLY A.V.B. ¹/₂ GWB TAPED & PLASTERED PROVIDE MOISTURE RESISTANT GB AT WATER-BOURNE AREAS E.G. WASHROOM KIT OR LAUND. ETC.

TYPES	INTERIOR WALL TYPES
PROPOSED ¹ / ₈ "STUCCO W/ 2"RIGID INSULATION ,DRAINAGE LAYER , DENSGLASS/EXT. SHEATHING OVER EXISTING 2"X4"WDN.STUD WALL,TOP PLATE TO BE REMOVED AND SISTER WITH 2"X6" WDN. STUD FRAMING @ 16" O/C ,NEW	EX. LOAD-BEARING 6-1/2" PARTITION WALL IN 1/2" G.W B/S 2"X6" WD. STUDS @ 16" O/C TAPED, PLASTERED, SANDED AND PAINTED
DOUBLE TOP PLATE W/ R24 BATT INSUL. VB 1/2" REGULAR GWB TAPED & SANDED	P1 NEW NON LOAD-BEARING 4-1/2" PARTITION WALL IN 1 REGULAR G.W.B ON 2"X4" WD. STUDS @ 16" O/C TAPE SANDED AND PAINTED
PROPOSED ¹ / ₈ "STUCCO W/ 2"RIGID INSULATION ,DRAINAGE LAYER , DENSGLASS/EXT. SHEATHING OVER EXISTING 2"X4"WDN.STUD WALL,TOP PLATE TO BE REMOVED AND SISTER WITH 2"X6" WDN. STUD FRAMING @ 16" O/C ,NEW DOUBLE TOP PLATE W/O INSUL. & VB ¹ / ₂ " REGULAR GWB TAPED & SANDED	P2 NEW NON LOAD-BEARING 4-1/2" PARTITION WALL W/ROXUL SOUND INSULATION IN 1/2" MOISTURE RESISTANT G.W.B I/S WATER BOURNE AREAS E.G BA & KITCHEN 2"X4" OR 2"X6" WD. STUDS @ 16" O/C TAPE
W5 TTTTTT PROPOSED ¹ / ₈ "STUCCO OVER 2" RIGID INSULATION OVER	SANDED AND PAINTED
DRAINAGE LAYER OVER DENSGLASS/EXT. SHEATHING, 2X6 WD. STUD FRAMING @ 16" O/C TOP/BOTTOM PLATES R24 BATT INSUL. VB 1/2" REGULAR GWB TAPED & SANDED	
	•

2.3.1.4 HOT WATER PIPING INSULATION	
1. HOT WATER PIPES THAT ARE VERTICALLY CONNECTED TO A HOT WATER STORAGE TANK SHALL HAVE HEAT TRAPS ON BOTH INLET AND OUTLET PIPING AS CLOSE AS PRACTICAL TO THE TANK, EXCEPT WHERE THE TANK,	
a) HAS AN INTEGRAL HEAT TRAP, OR b) SERVES A RECIRCULATING SYSTEM	
2. THE FIRST 2.5M OF HOT WATER OUTLET PIPING OF A HOT WATER STORAGE TANK SERVING NON- RECIRCULATING SYSTEM SHALL BE INSULATED TO PROVIDE A THERMAL RESISTANCE OF NOT LESS THAN RSI 0.62.	
3. THE INLET PIPE OF A HOT WATER STORAGE TANK BETWEEN THE HEAT TRAP AND THE TANK SERVING NON RECIPCUL ATION SYSTEM SHALL BE INSUL ATED TO	
TANK SERVING NON-RECIRCULATION SYSTEM SHALL BE INSULATED TO PROVIDE A THERMAL RESISTANCE OF NOT LESS THAN RSI 0.62.	
9.10.19 SMOKE ALARMS	
(1) WITHIN DWELLING UNITS SUFFICIENT SMOKE ALARMS CONFORMING TO CAN/ULC-531 SHALL BE INSTALLED SO THAT	
(a) THERE IS AT LEAST ONE SMOKE ALARM ON EACH STOREY, INCLUDING BASEMENTS, AND	
 (b) ON ANY STOREY OF A DWELLING UNIT CONTAINING SLEEPING ROOMS, A SMOKE ALARM IS INSTALLED, (I) IN EACH SLEEPING ROOM, AND 	
(I) IN A LOCATION BETWEEN THE SLEEPING ROOMS AND THE REMAINDER OF THE STOREY, AND IF THE SLEEPING ROOMS ARE SERVED BY A HALLWAY, THE SMOKE ALARM SHALL BE LOCATED IN THE HALLWAY.	
(2) SMOKE ALARMS SHALL HAVE A VISUAL SIGNALLING COMPONENT CONFORMING TO THE REQUIREMENTS IN 18.5.3. OF NFPA 72. THE VISUAL SIGNALING COMPONENT NEED NOT BE INTEGRATED WITH THE SMOKE ALARM PROVIDED IT IS INTERCONNECTED TO IT.	
INTERCONNECTED SMOKE ALARMS TO BE PERMANENTLY CONNECTED AND HAVE A BATTERY BACKUP AS PER OBC 9.10.19.4	
9.5.2.3 STUD WALL REINFORCEMENT (1) IF WOOD WALL STUDS OR SHEET STEEL WALL STUDS ENCLOSE THE MAIN BATHROOM IN A DWELLING UNIT, REINFORCEMENT SHALL BE INSTALLED TO PERMIT THE FUTURE INSTALLATION OF THE FOLLOWING,	
(A) FOR A WATER CLOSET A GRAB BAR DESCRIBED IN CLAUSES 3.8.3.8 (3)(A) AND A GRAB BAR DESCRIBED IN CLAUSE 3.8.3.8 (3)(C))
(a) FOR A SHOWER A GRAB BAR DESCRIBED IN CLAUSE 3.8.3.13 (2)(F), AND	
(b) FOR A BATHTUB A GRAB BAR DESCRIBED IN CLAUSE 3.8.3.13 (4)(C) 9.29.2. WATERPROOF WALL FINISH	
(1) WATERPROOF FINISH SHALL BE PROVIDED TO A HEIGHT OF NOT LESS THAN,	
 (a) 1.8M (5'11") ABOVE THE FLOOR IN SHOWER STALLS, (B) 1.2M (3'11") ABOVE THE RIMS OF BATHTUBS EQUIPPED WITH SHOWERS, AND (C) 0.4M (15-3/4") ABOVE THE RIMS OF BATHTUBS NOT EQUIPPED WITH SHOWERS 9.29.10.4 	
 (1) CERAMIC AND PLASTIC TILE INSTALLED ON WALLS AROUND BATHTUBS OR SHOWERS SHALL BE APPLIED OVER MOISTURE RESISTANCE BACKING 9.30.1.2. WATER RESISTANCE 	
(1) FINISHED FLOORING IN BATHROOMS, KITCHENS, PUBLIC ENTRANCE HALLS, LAUNDRY, AND GENERAL STORAGE AREAS SHALL CONSIST OF RESILIENT	
FLOORING, FELTED-SYNTHETIC-FIBRE FLOOR COVERINGS, CONCRETE, TERRAZZO, CERAMIC TILE, MASTIC OR OTHER TYPES OF FLOORING PROVIDING SIMILAR DEGREES OF WATER RESISTANCE.	
SECTION 9.8 STAIRS, HANDRAILS, GUARDS	
ALL INTERIOR/EXTERIOR STAIRS, HANDRAILS, AND GUARDS SHALL CONFORM TO O.B.C. SECTION 9.8 MAXIMUM RISE (7- ") MINIMUM RUN 210MM (8-1/4"), MINIMUM TREAD 235MM (9-1/4"), HANDRAIL NOT LESS 865MM (34") HIGH AND NOT	
MORE THAN 965MM (38") HIGH ABOVE LINE THROUGH NOSING'S. GUARDS FOR PORCHES, DECKS, LANDINGS, AND BALCONIES, SERVING NOT MORE THAN 1 DWELLING UNIT AND WHICH ARE NOT MORE THAN 1800 MM (5'11) ABOVE FINISHED GROUND LEVEL ARE	
PERMITTED TO BE MINIMUM 900MM (35- 21") AND MUST BE MINIMUM 1070MM (42") HIGH FOR AREAS GREATER THAN 1800MM (5'11") ABOVE FINISHED GRADE. OPENINGS THROUGH REQUIRED GUARDS ON BALCONIES, PORCHES, DECKS,	
STAIRS, LANDINGS AND FLOOR LEVEL AROUND A STAIRWELL IN A DWELLING UNIT SHALL PREVENT PASSAGE OF A 100MM (4") DIAMETER SPHERICAL OBJECT AND PREVENT CLIMBING. HEADROOM MEASURED VERTICALLY THROUGH A LINE	
OF OUTER EDGE OF NOSING'S SHALL BE AT LEAST 1950MM (6'5") FOR STAIRS SERVING A SINGLE DWELLING UNIT AND 2050MM (6'9") FOR ALL OTHER STAIRS. HANDRAILS ARE REQUIRED FOR INTERIOR STAIRS WITH MORE THAN 2 RISERS AND EXTERIOR STAIRS WITH MORE THAN 3 RISERS. DESIGN GUARD ON THAT NO	
MEMBER, ATTACHMENT OR OPENING IS LOCATED BETWEEN 140MM (5- 21") & 900MM (35-	
21") ABOVE DECK SURFACE WILL FACILITATE CLIMBING.	
9.10.22. FIRE PROTECTION FOR GAS, PROPANE AND ELECTRIC COOKTOPS FRAMING, FINISHES AND CABINETRY INSTALLED DIRECTLY ABOVE THE	
LOCATION OF THE COOKTOP SHALL BE NOT LESS THAN 750MM (29- 21") ABOVE THE LEVEL OF COOKTOP BURNERS OR ELEMENTS. FRAMING, FINISHES AND CABINETS	
INSTALLED DIRECTLY ABOVE THE LOCATION OF THE COOKTOP IS PERMITTED TO BE REDUCED TO 600MM (23- ") ABOVE THE LEVEL OF THE ELEMENTS OR BURNERS IN COMPLIANCE WITH 9.10.22.2 (2) (A) AND (B). EXCEPT AS PROVIDED IN	
9.10.22.2. (2) AND (3), COMBUSTIBLE WALL FRAMING, FINISHES OR CABINETS WITHIN 450MM (17- 34") OF THE AREA WHERE THE COOKTOP IS TO BE LOCATED SHALL BE PROTECTED ABOVE THE LEVEL OF THE HEATING ELEMENTS OR BURNERS BY MATERIAL PROVIDING FIRE RESISTANCE NOT LESS THAN THAT OF A 9.5MM (") THICKNESS OF GYPSUM BOARD.	
NOTE: ALL WOOD FRAMED WINDOW OPENINGS THAT EXCEED 48" WIDE ARE TO HAVE 2/2X6 PLATES @ BOTTOM OF OPENING (TYP.) U.N.O.	
NOTE: STRUCTURAL ENGINEER TO BE NOTIFIED PRIOR TO POURING OF CONCRETE TO INSPECT RE-BAR SET-UP DURING CONSTRUCTION-ENGINEER WILL NOT CERTIFY WALLS OR FOOTING/SLABS UNLESS PRIOR INSPECTION IS CONDUCTED- IT IS THE RESPONSIBILITY OF THE CONTRACTOR TO NOTIFY THE PROJECT ENGINEER AND MAKE ALL ARRANGEMENTS.	
NOTE: ADJUSTMENTS OR CHANGES MADE TO THE FLOOR LAYOUT, ROOF TRUSS LAYOUT, BEAMS, LINTELS & POINT LOADS OR REQUIRED LOAD BEARING WALLS MUST BE IDENTIFIED PRIOR TO CONSTRUCTION AND SMPL DESIGN STUDIO AND PROJECT ENGINEER MUST BE NOTIFIED FOR FURTHER REVIEW AND APPROVAL.	
NOTE: ALL CODE REQUIREMENTS REFER TO O.B.C. 2012 DIVISION 'B'.	

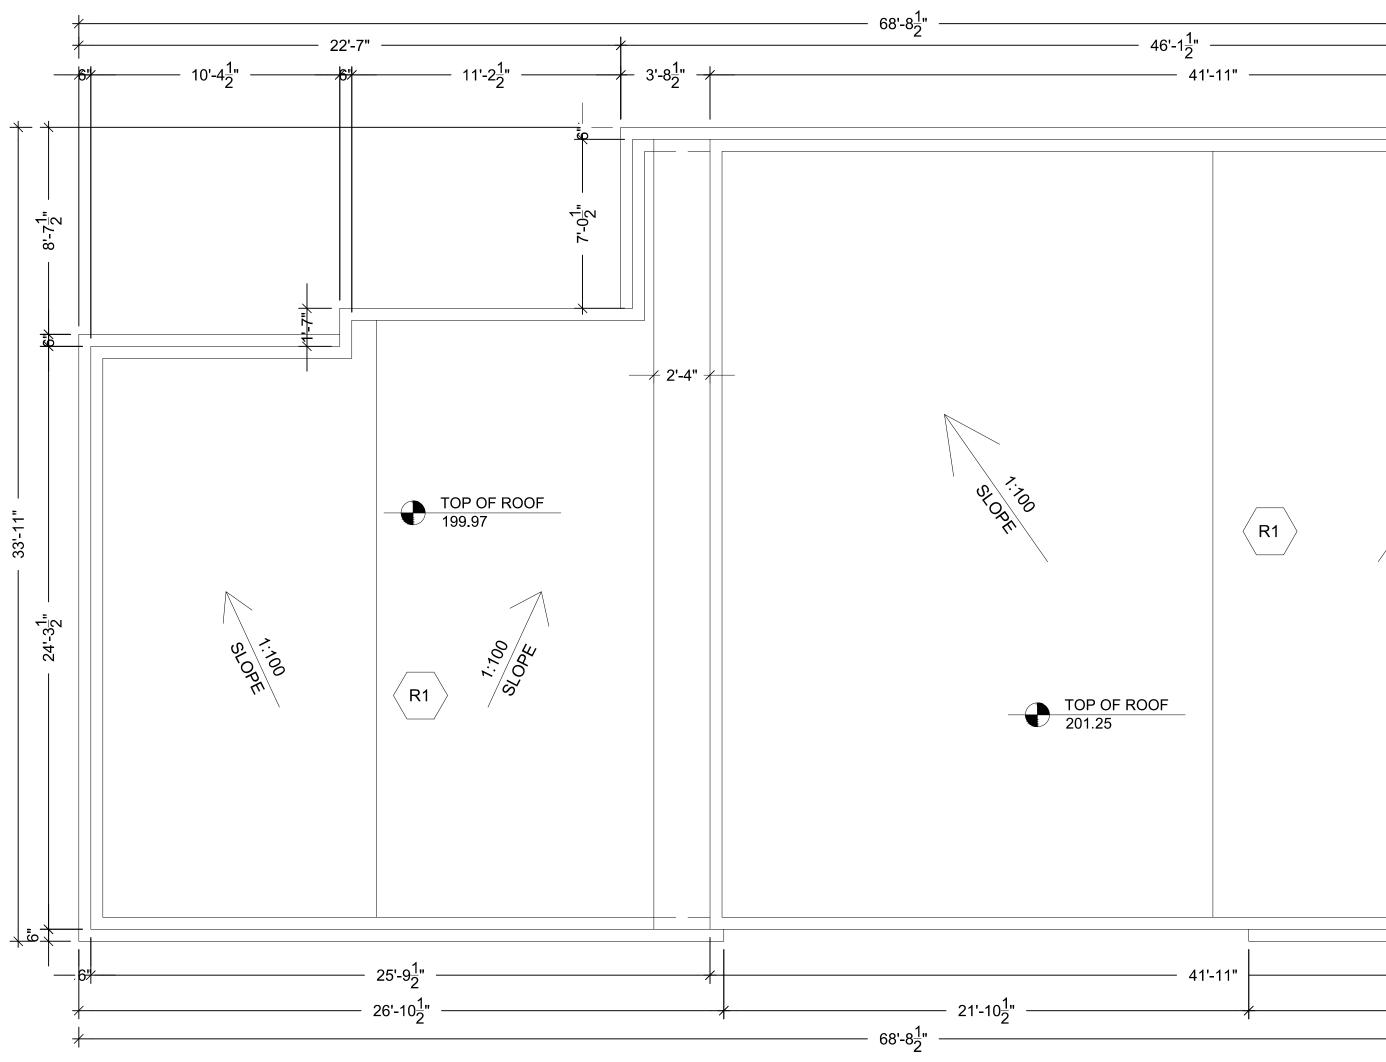



EXTERIOR WALL 1

W1


EXISTING 10" CINDER BLOCK WALL O/S TOWEL APPLIED WATERPROOFING LAYER PROTECTION BOARD INTERIOR SMOOTH SURFACE W/ CEMENT MORTAR PARGING WHERE REQUIRED


W2

EXISTING 10" POUR CINDER BLOCK WALL W/#15 BUILDING PAPER 3.5"SR PRO.INSL.(R20/24)FRICTION-FIT B/W 2"X4"WD.STUDS @16"O/C T/B PLATES 6 MIL POLY A.V.B. ¹/₂" GWB TAPED & PLASTERED PROVIDE MOISTURE RESISTANT GB AT WATER-BOURNE AREAS E.G. WASHROOM KIT OR LAUND. ETC.

TYPES	INTERIOR WALL TYPES
PROPOSED ¹ / ₈ "STUCCO W/ 2"RIGID INSULATION ,DRAINAGE LAYER , DENSGLASS/EXT. SHEATHING OVER EXISTING 2"X4"WDN.STUD WALL,TOP PLATE TO BE REMOVED AND SISTER WITH 2"X6" WDN. STUD FRAMING @ 16" O/C ,NEW DOUBLE TOP PLATE W/ R24 BATT INSUL. VB 1/2"	EX. LOAD-BEARING 6-1/2" PARTITION WALL IN 1/2" G.W B/S 2"X6" WD. STUDS @ 16" O/C TAPED, PLASTERED, SANDED AND PAINTED
REGULAR GWB TAPED & SANDED	P1 NEW NON LOAD-BEARING 4-1/2" PARTITION WALL IN 1/ REGULAR G.W.B ON 2"X4" WD. STUDS @ 16" O/C TAPED SANDED AND PAINTED
PROPOSED ¹ / ₈ "STUCCO W/ 2"RIGID INSULATION ,DRAINAGE LAYER , DENSGLASS/EXT. SHEATHING OVER EXISTING 2"X4"WDN.STUD WALL,TOP PLATE TO BE REMOVED AND SISTER WITH 2"X6" WDN. STUD FRAMING @ 16" O/C ,NEW DOUBLE TOP PLATE W/O INSUL. & VB ¹ / ₂ " REGULAR GWB TAPED & SANDED	P2 NEW NON LOAD-BEARING 4-1/2" PARTITION WALL W/ROXUL SOUND INSULATION IN 1/2" MOISTURE RESISTANT G.W.B I/S WATER BOURNE AREAS E.G BAT & KITCHEN 2"X4" OR 2"X6" WD. STUDS @ 16" O/C TAPEI
W5	SANDED AND PAINTED
PROPOSED ¹ / ₈ "STUCCO OVER 2" RIGID INSULATION OVER DRAINAGE LAYER OVER DENSGLASS/EXT. SHEATHING, 2X6 WD. STUD FRAMING @ 16" O/C TOP/BOTTOM PLATES R24 BATT INSUL. VB 1/2" REGULAR GWB TAPED & SANDED	
	•

7		PROJECT ARCHITECTS:	
N GY	33'-11" 33'-11"	ARCHISYSTEM CONSULTING ARCHITECTS CERTIFICATE OF PRACTICE # 5465 80 Eastern Ave. Unit A9, Brampton, ON. Canada L6W 0B6 Tel:(O) 905 858-2565 (C) 647-295-2565 www.thearchisystem.com e-mail: archisystem@gmail.com	
		NOTES: THE DRAWINGS SHALL NOT BE SCALED THE CONTRACTOR SHALL VERIFY ALL DIMENSI LEVELS PRIOR TO COMMENCING THE WOF THAT THE CONTRACTOR WILL BE LIABLE T WITHOUT EXTRA COST ALL ERRORS AND OMISSIONS TO BE REPORTE THE ARCHITECT. VARIATIONS AND MODIFI SHOWN ON THIS DRAWING SHALL NOT BE WITHOUT THE WRITTEN CONSENT OF THE THIS DRAWING IS EXCLUSIVE PROPERTY OF TI SHALL NOT BE REPRODUCED WITHOUT TH PERMISSION ALL WORKS TO BE DONE ACCORDING TO BEST PRACTICE AND CONFORM TO PREVAILING BUILDING CODE	RK. FAILURE TO O RECTIFY D IMMEDIATELY TO CATIONS TO WORK CARRIED OUT ARCHITECT HE ARCHITECT AND HE ARCHITECT'S
		OWNER / CLIENT: DEREK SOHAIL USHA DANIEL PERMIT BY:	
19'-11 ¹ / ₂ "		The second secon)
		HOME SOLUTI	T ons
	CEILING / ROOF TYPES	REVISIONS:	ISSUED:
G.W.B),	C1 ¹ / ₂ " GWB SMOOTH PLASTERED CLG. ON CLG. JSTS OR ROOF TRUSSES ATTIC SPACE TO BE FILLED W/ BLOW OUT LOOSE INSULATION MIN. R50	ARCHITECT: ARSOC ARCHITECTS 2 GARWAT S AHMED LICENCE 7987	Referent
N 1/2" PED,	R1 PROPOSED ROOF CONST FLAT ROOF PVC SINGLE PLY ROOFING SYSTEM TO BE INSTALLED AS PER MANUFACTURER SPECIFICATIONS- EVERGUARD OR EQUIVALENT OVER 4" [R31] RIGID INSULATION SLOPED AS	PROJECT: PROPOSED ADD ALTERATION	
BATHS	PER ROOF PLAN OVER 4PLY ASPHALT ROOFING OVER FLOOR AS PER ULC M506	376 PHILIP PLA ANCASTER, ON. L9G 3G8	CE,
PED,		DRAWING TITLE:	
	ELECTR. LEGEND	SHEET TITLE:	
	SMOKE ALARM/ DETECTOR	PROPOSED ROOF	PLAN
	S.A	DATE: SCALE:	04-08-2022 AS NOTED
	CARBON MONO-OXIDE ALARM/DETECTOR		A1.05

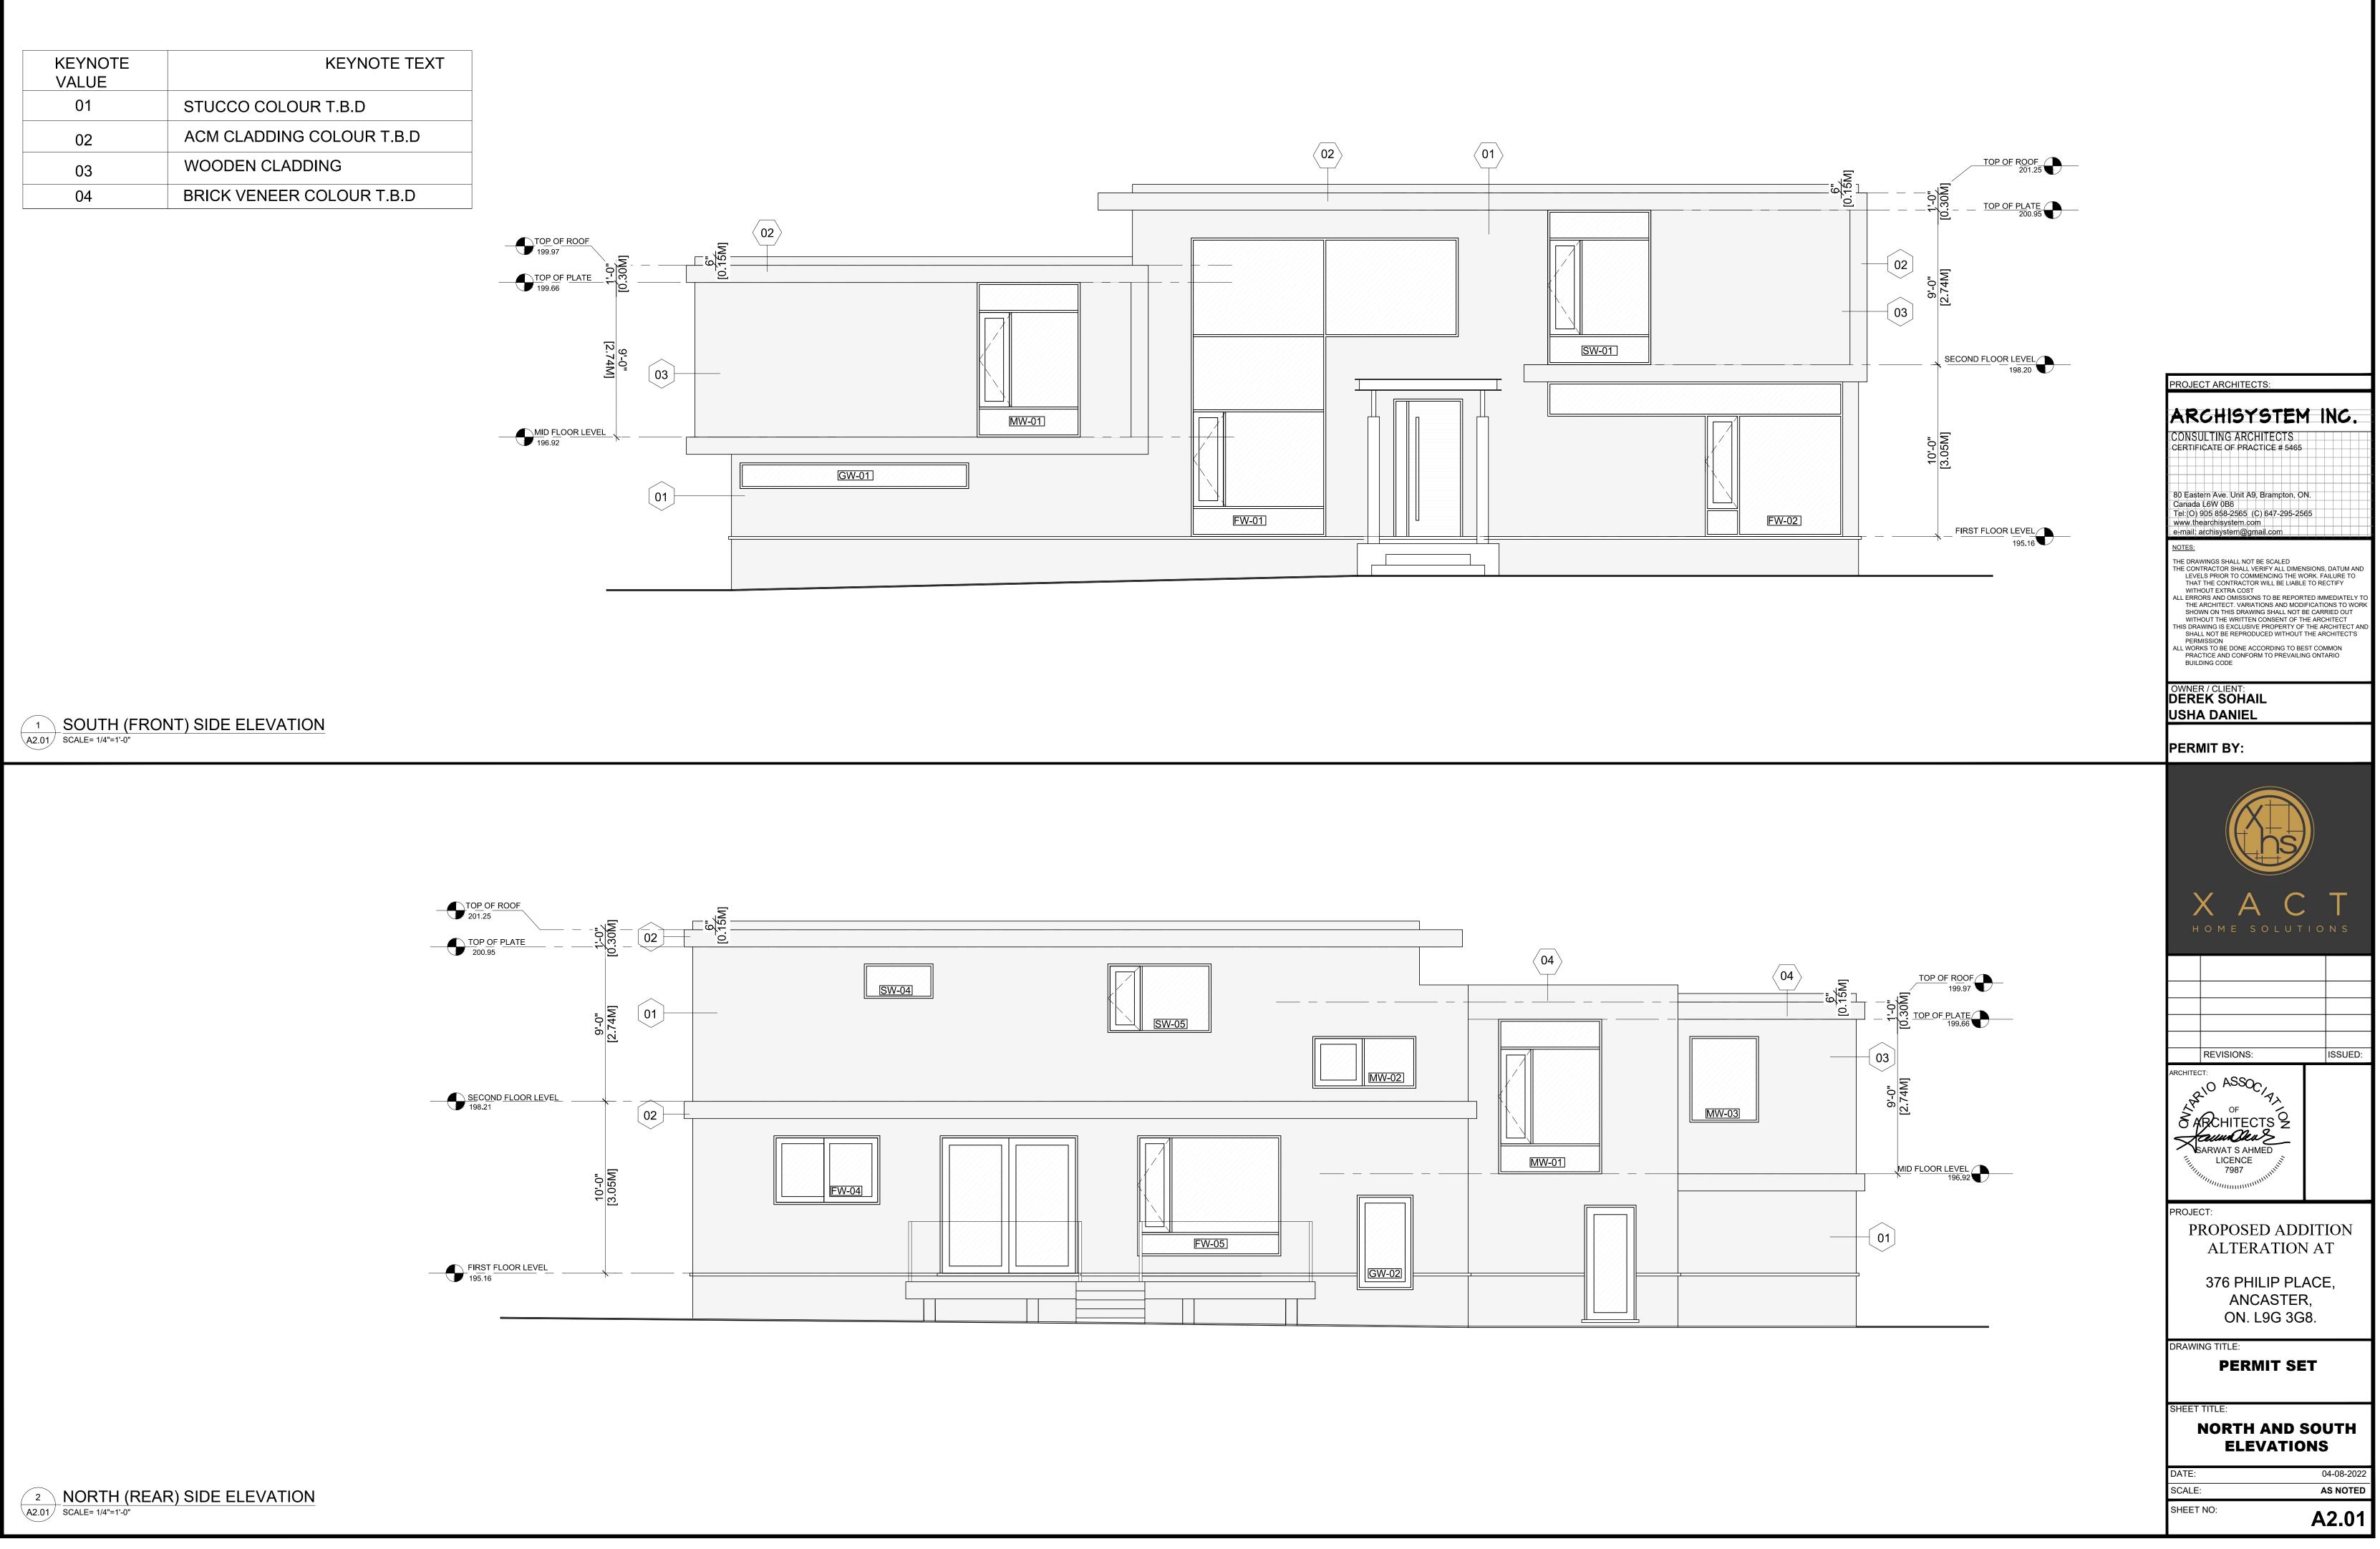

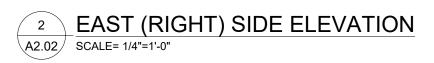

TOTAL EXPOSED WALL AREA U/PROTECTED WINDOW AREA PROVIDED LIMITING DISTANCE %AGE ALLOWED @ 6M UPTO 100 SQM

KEYNOTE

VALUE

01

02

03

04

= 68.68 SQ.M = 8.90 SQ.M

= 6.20M

STUCCO COLOUR T.B.D

WOODEN CLADDING

CALCULATION OF UNPROTECTED OPENINGS OBC 2012 (9.10.15.4)


ACM CLADDING COLOUR T.B.D


BRICK VENEER COLOUR T.B.D


KEYNOTE TEXT


= 34% =23.35 SQM

WEST (LEFT) SIDE ELEVATION A2.02 SCALE= 1/4"=1'-0"

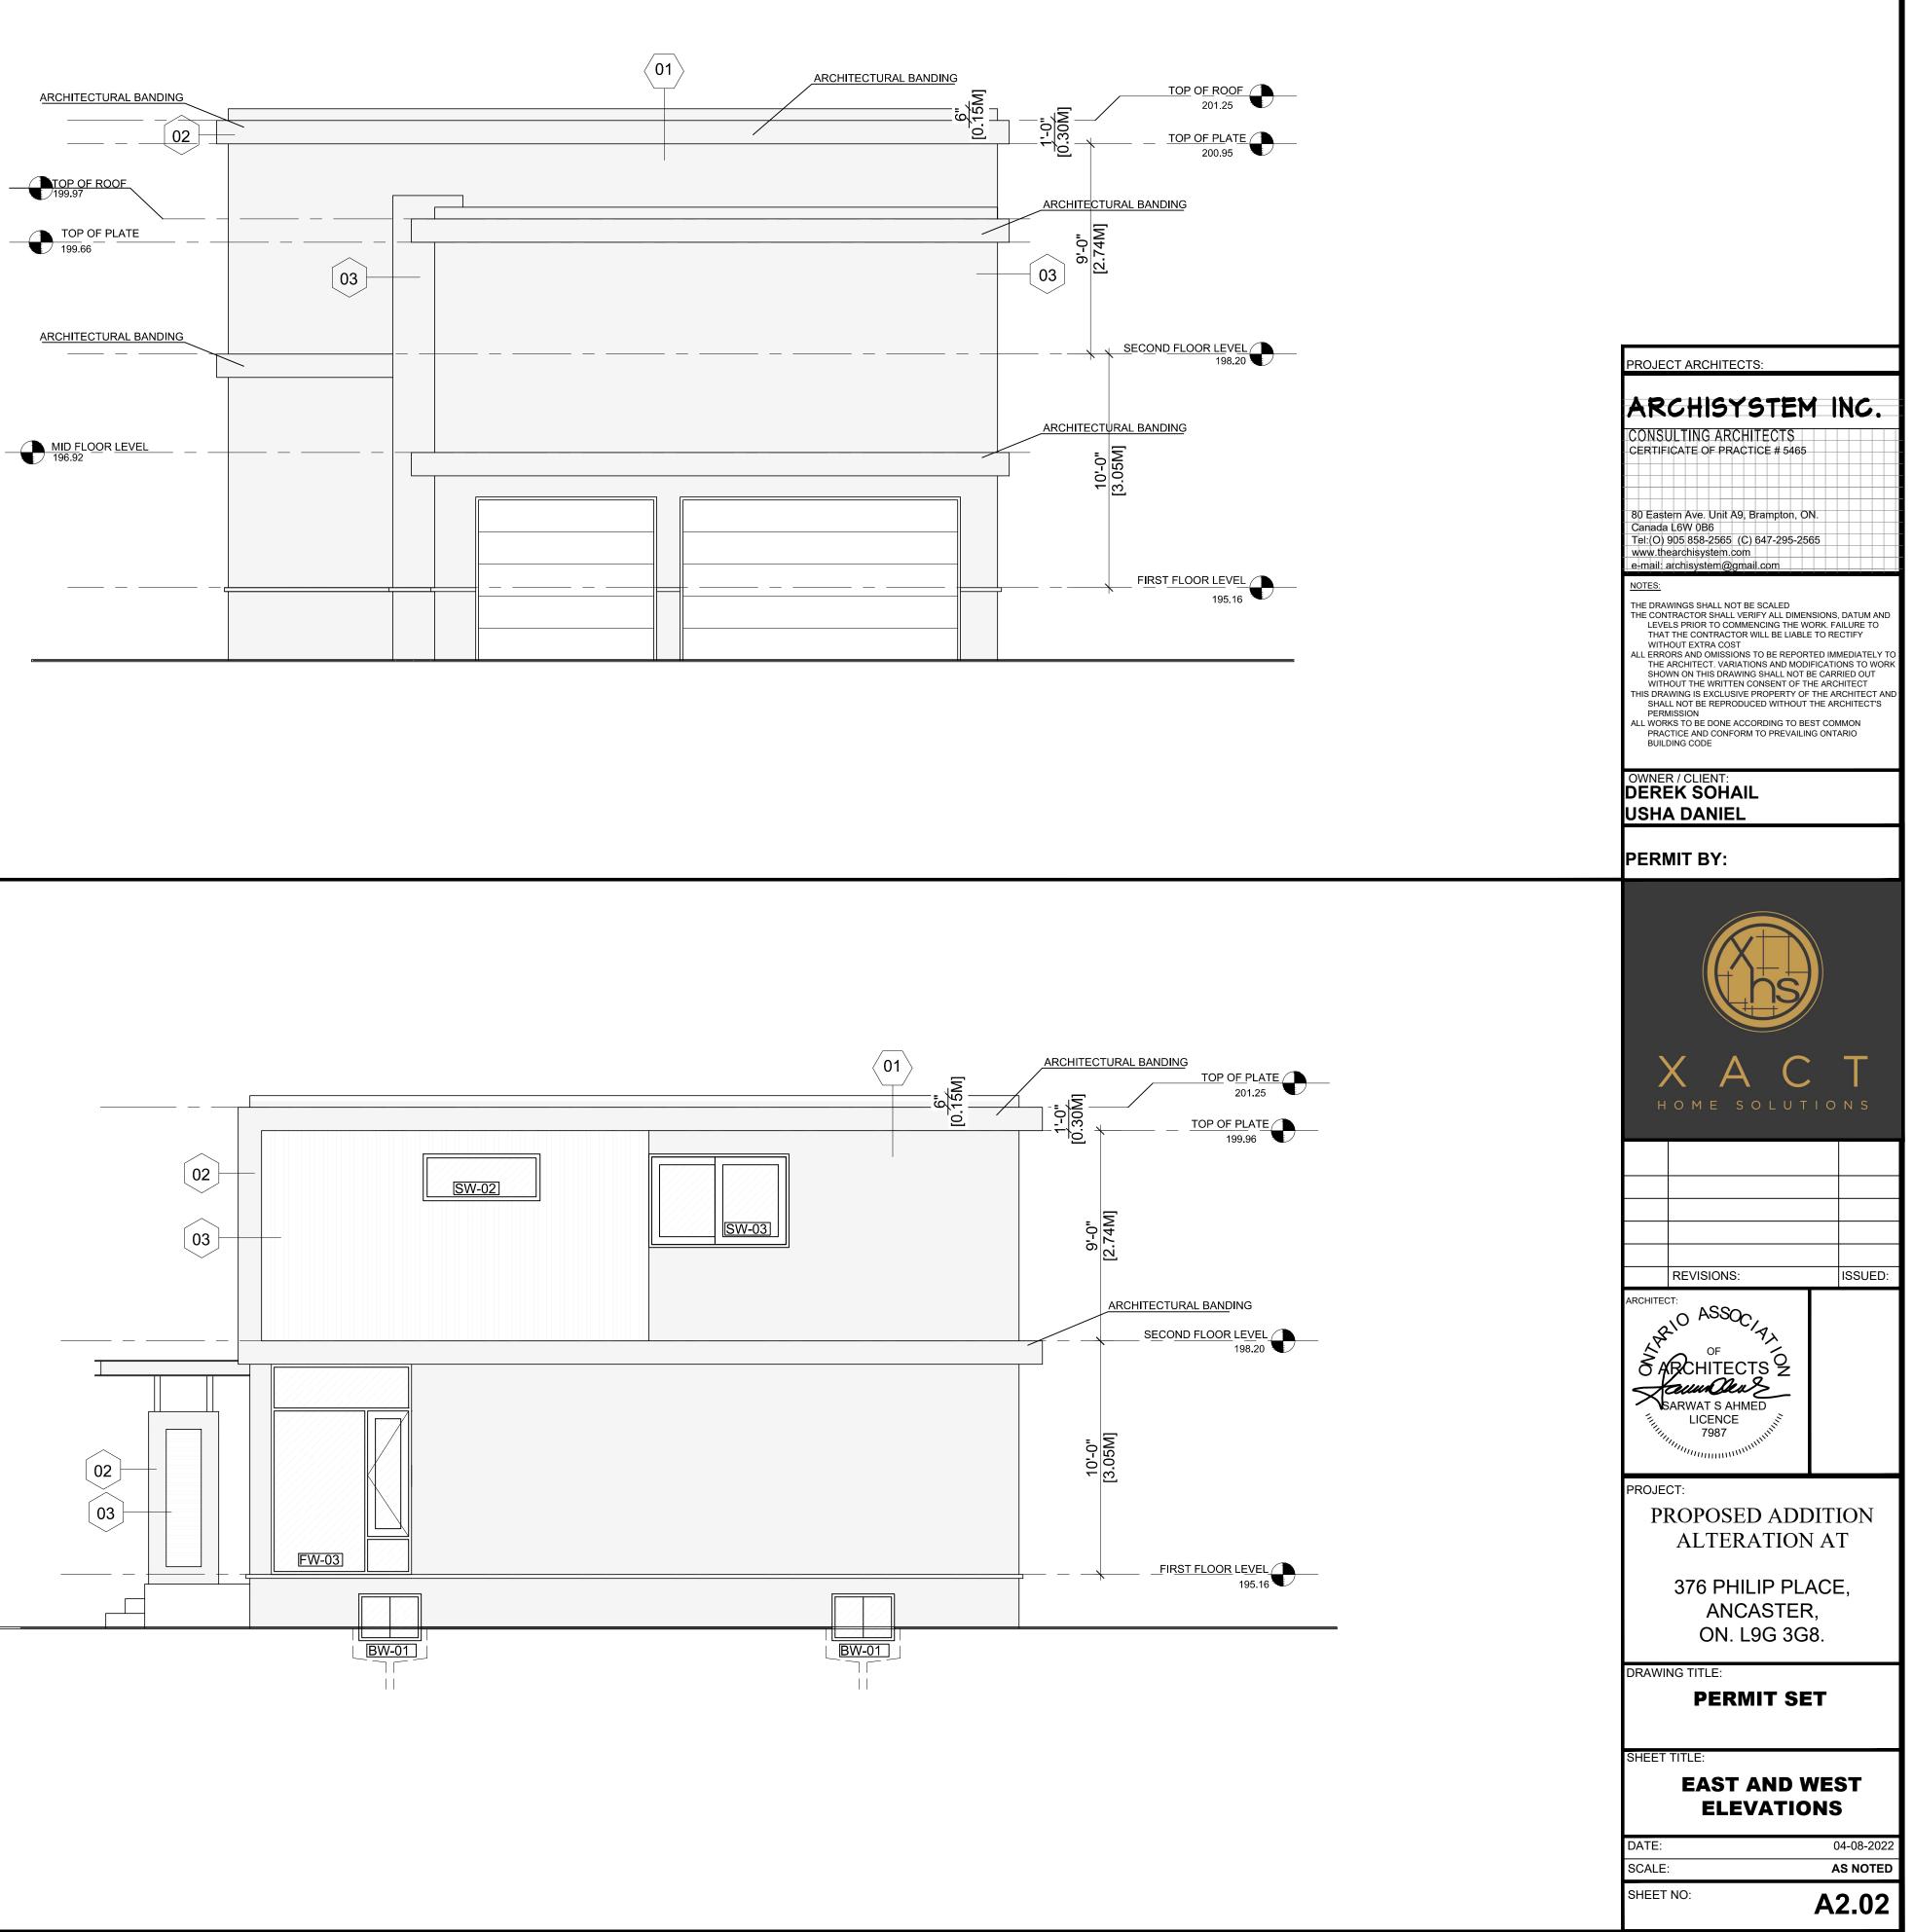

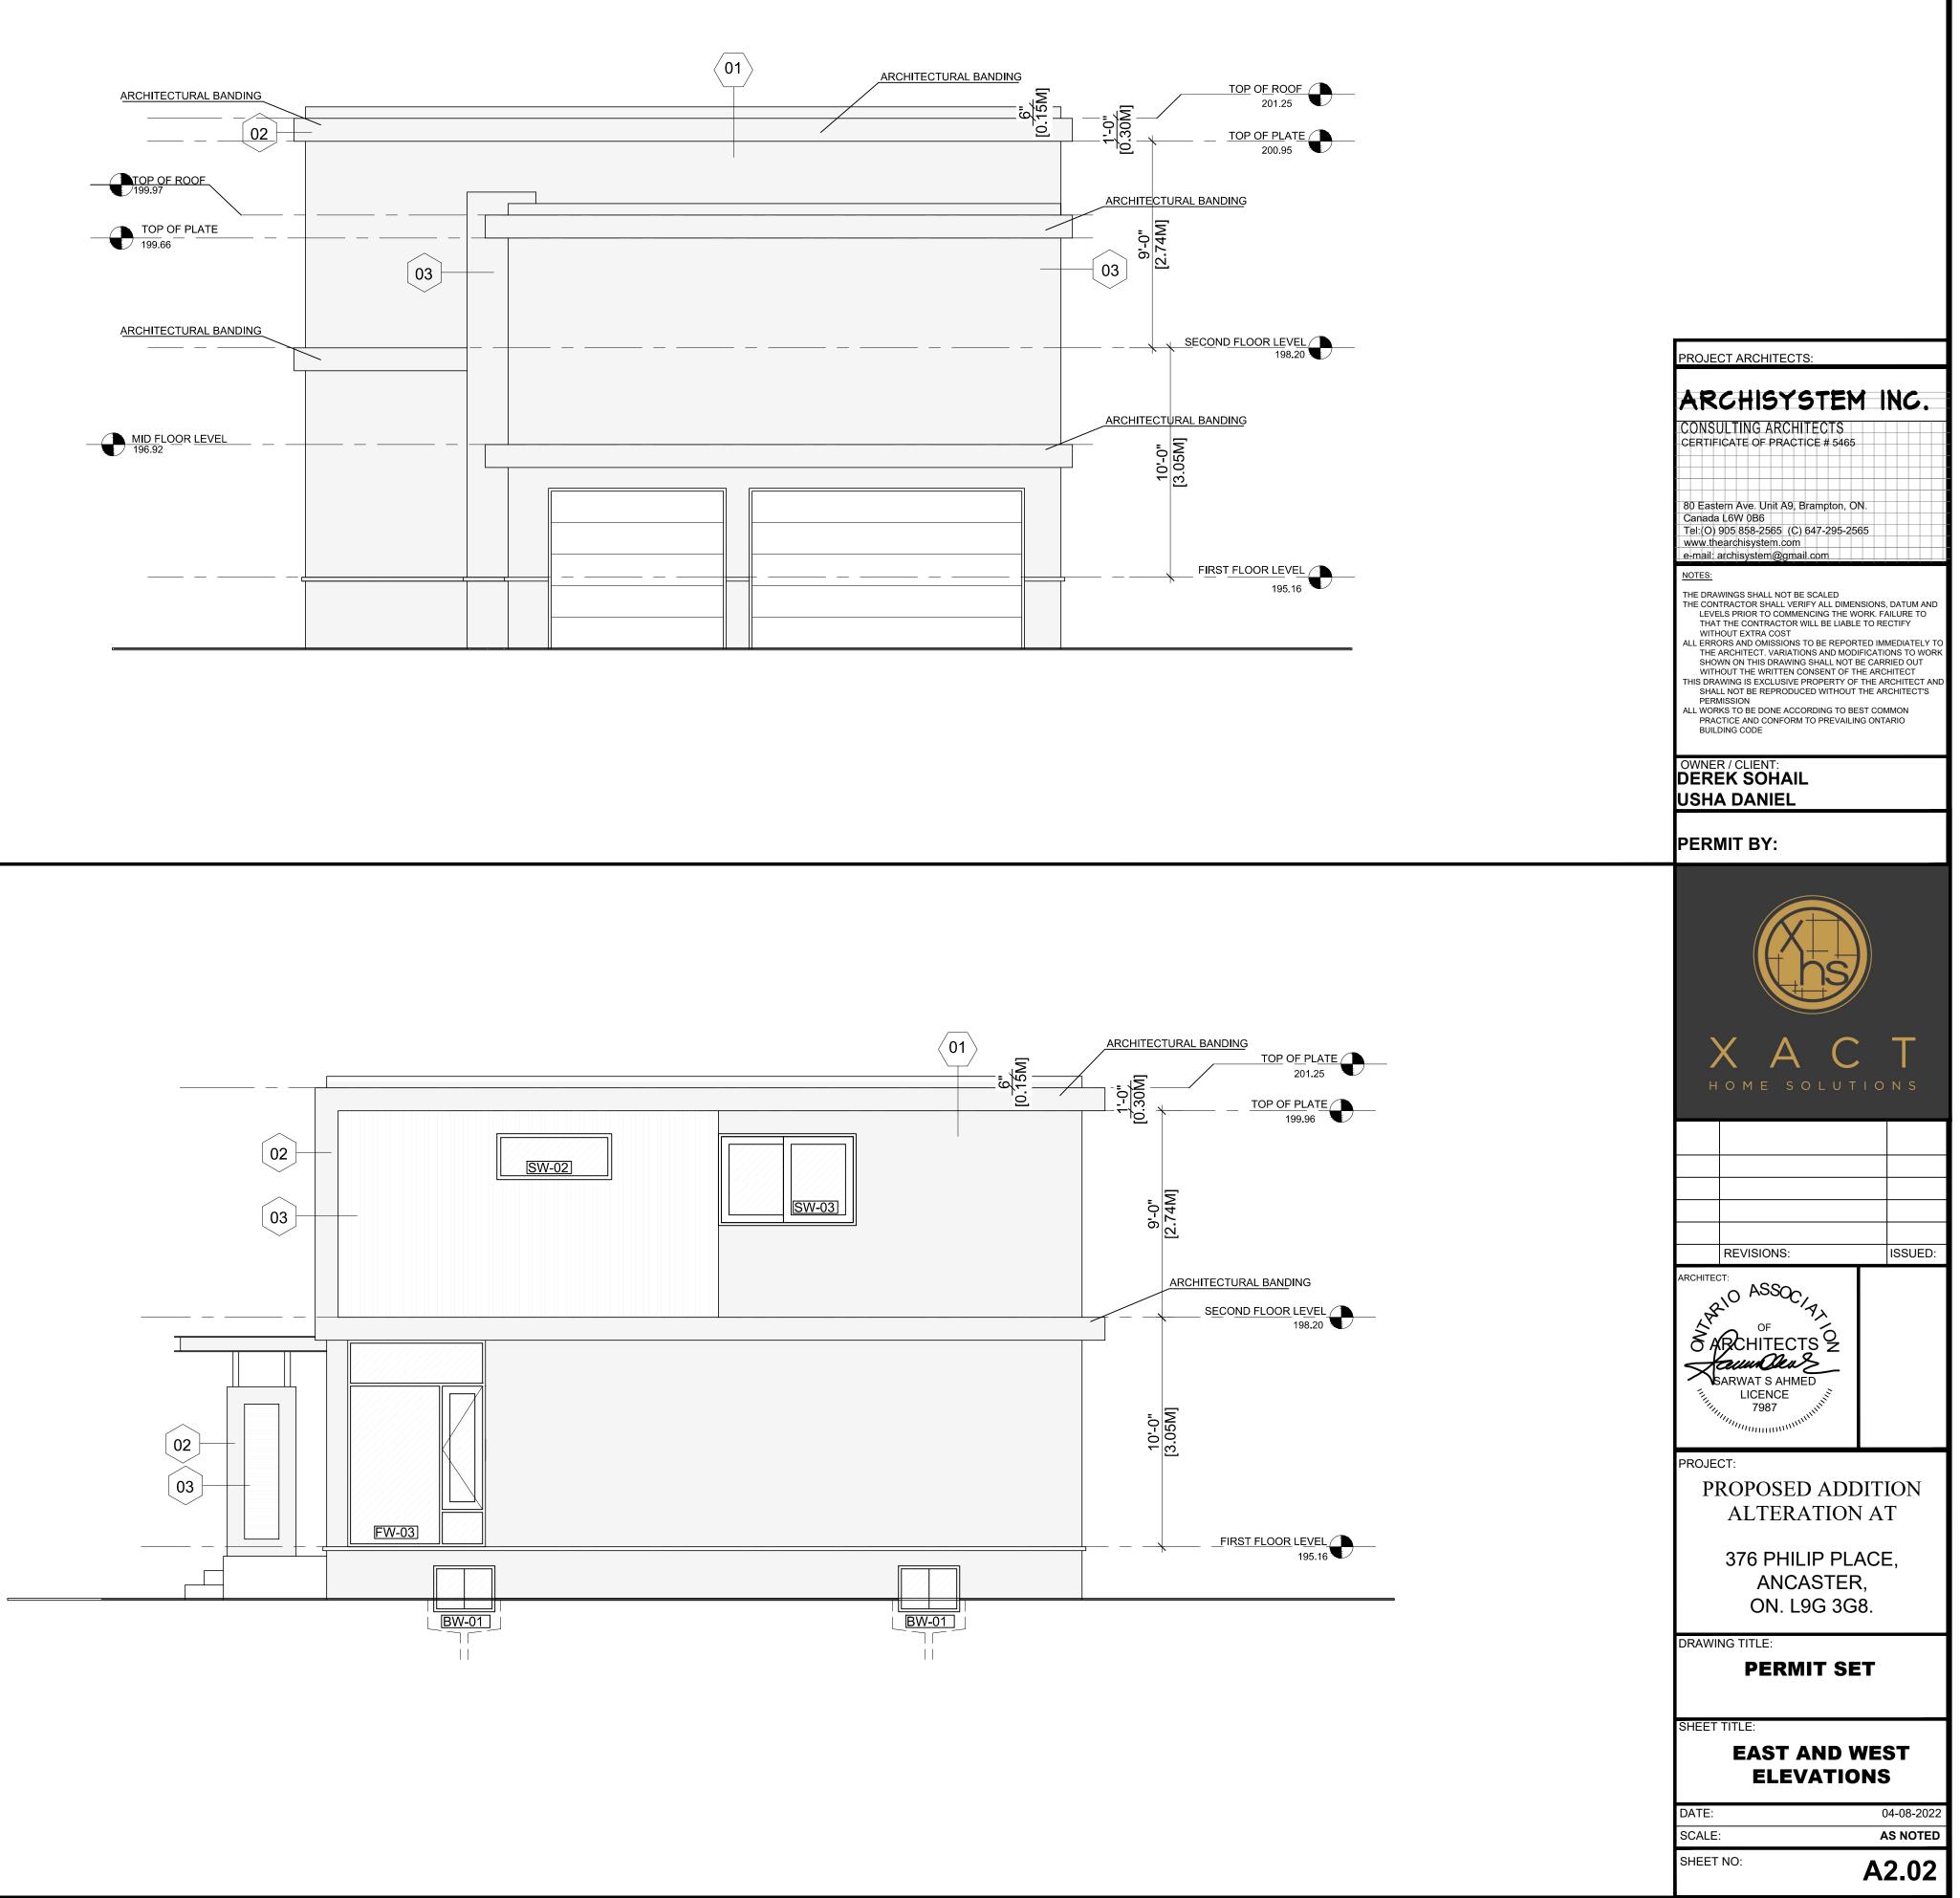


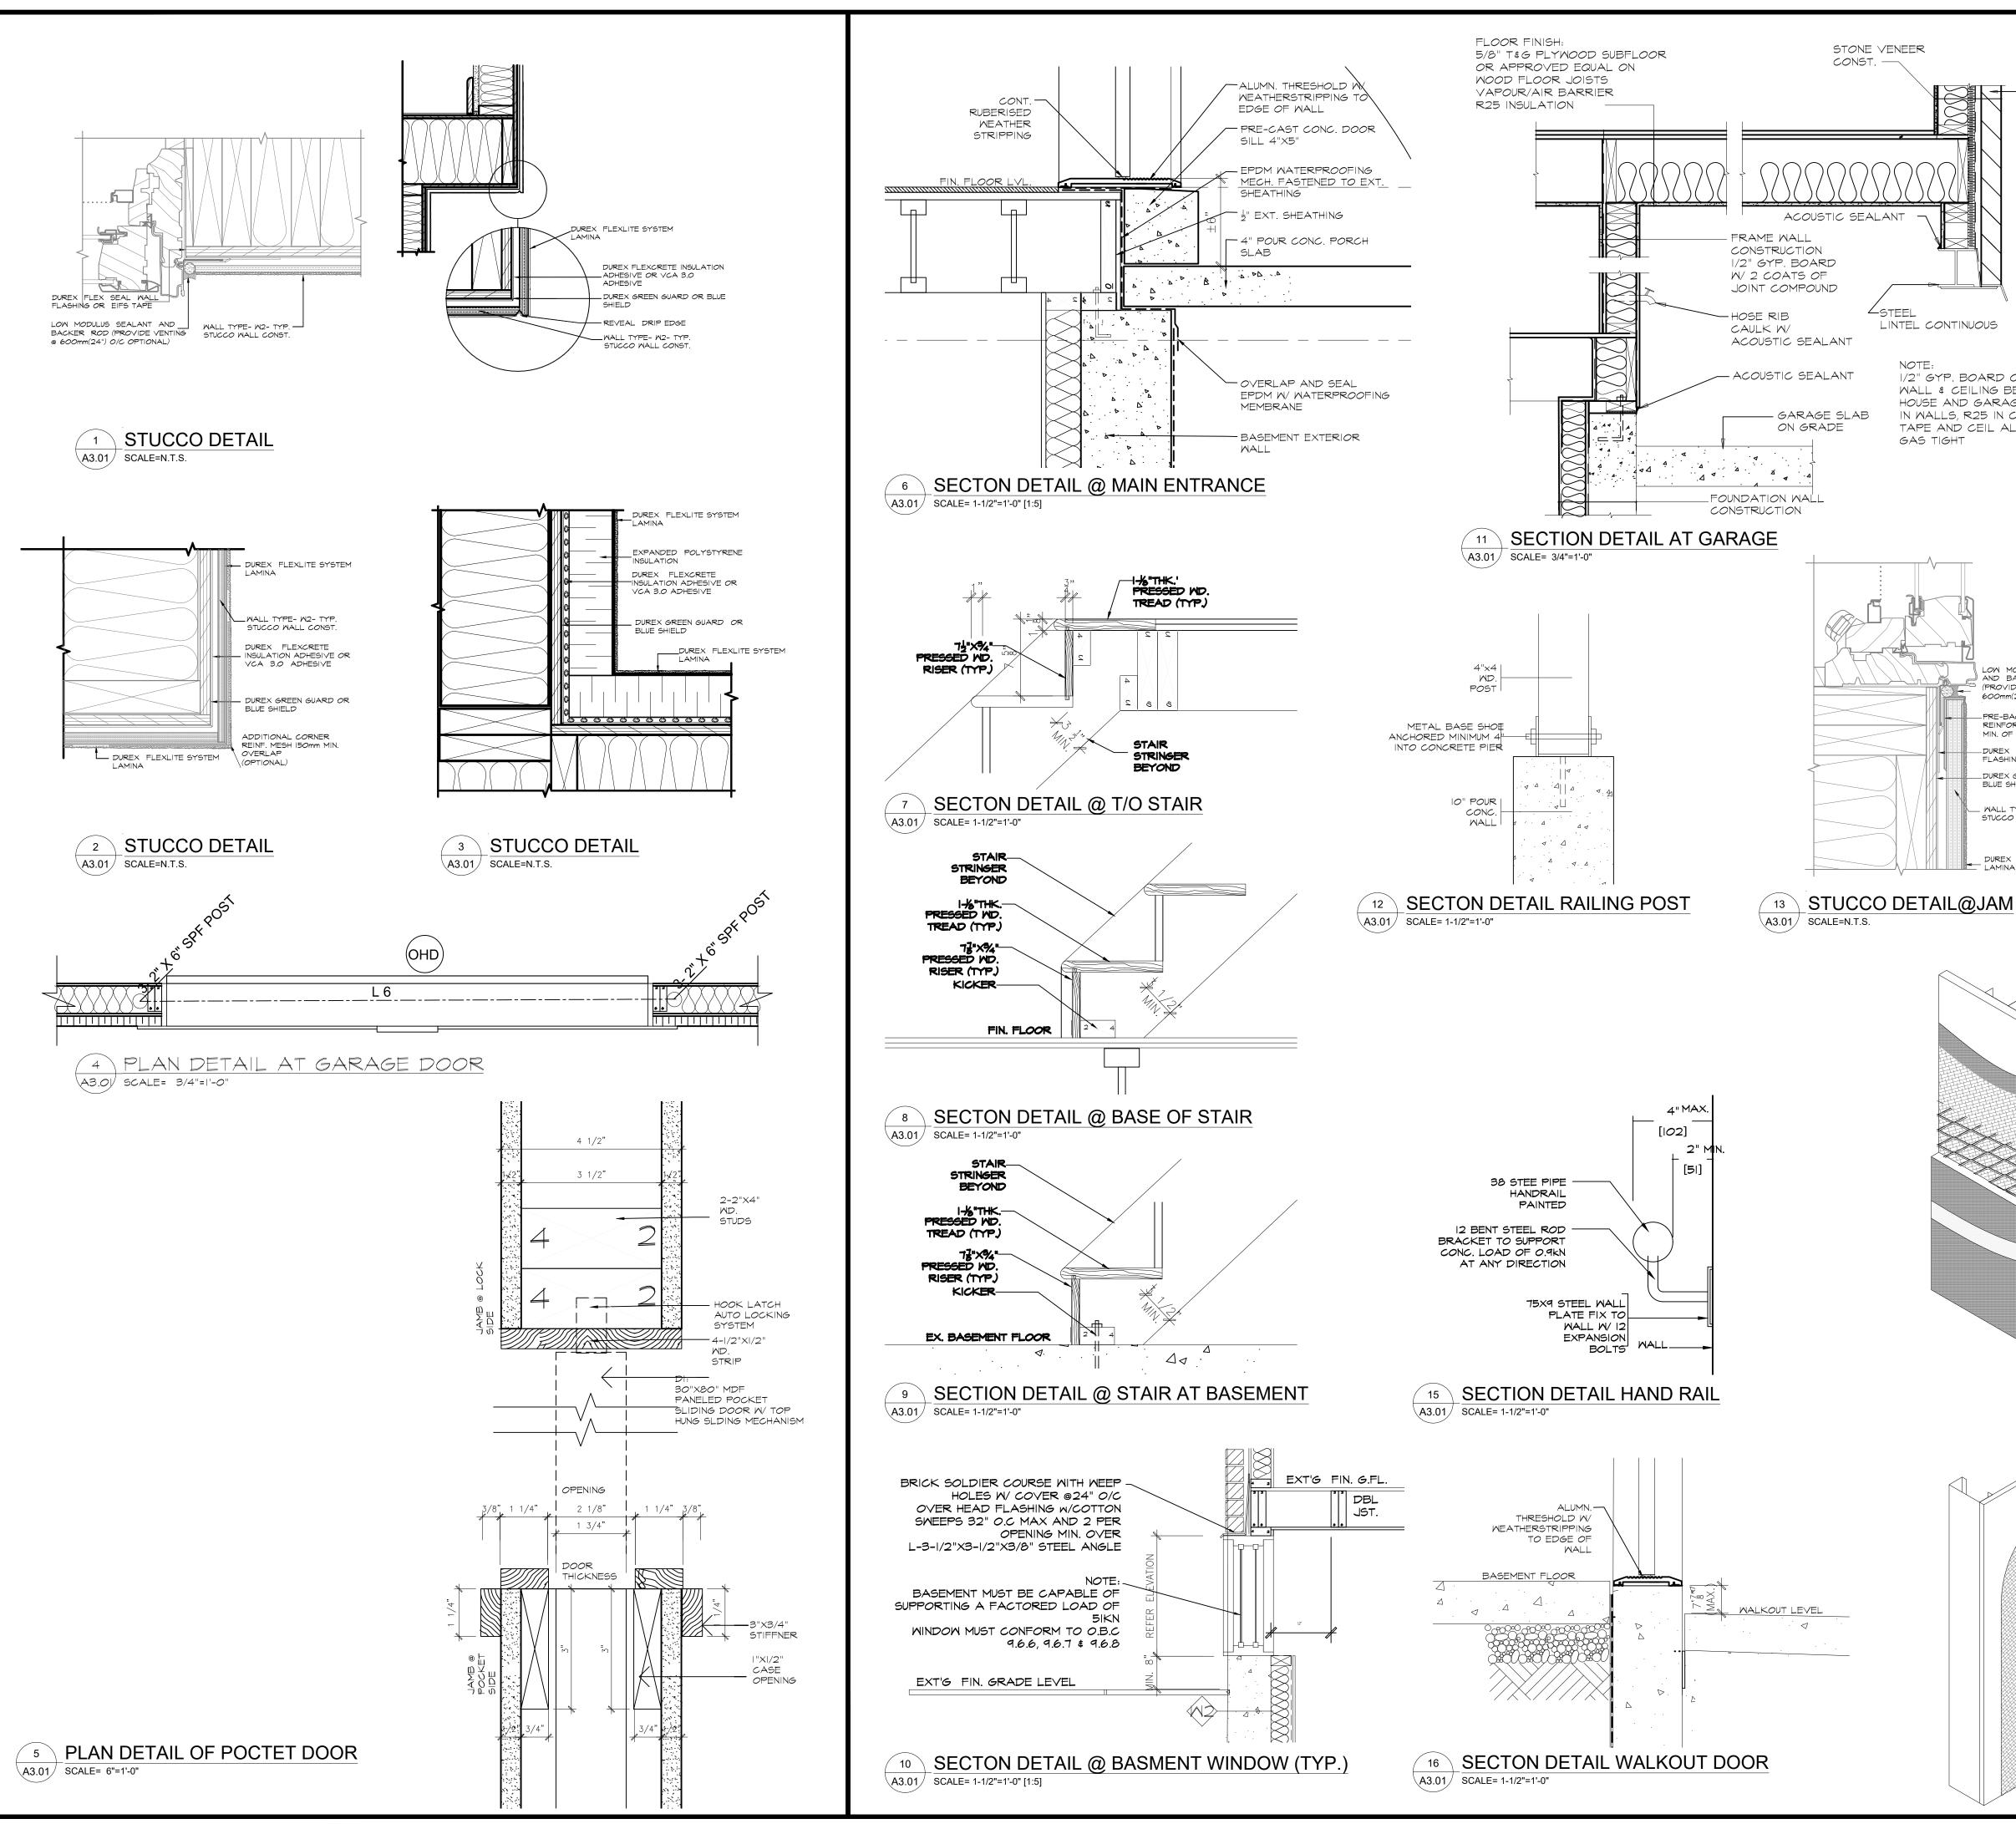


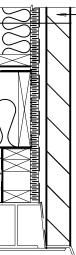


EXTERIOR WALL SEE SECTION GASPROOFING NOTES: ATTACHED GARAGES MUST BE COMPLETELY SEALED TO PREVENT INFILTRATION OF GASES INTO DWELLING.

- I. PROVIDE 1/2" DRYWALL WITH MIN. 2 COATS OF JOINT COMPOUND AT ALL WALLS ADJACENT TO DWELLING . CAULK ALL PENETRATIONS SUCH AS HOSE BIBS WITH ACOUSTIC
- SEALANT 4. EXTERIOR TYPE INSULATED DOOR GASPROOFED, EQUIPED WITH A SELF
- CLOSING DEVICE AND WEATHERSTRIPPING 5. GARAGE SLAB SHALL BE SLOPED TO DRAIN TO OUTDOORS LINTEL CONTINUOUS 6. WHERE AN ATTACHED GARAGE IS
 - ADJACENT TO AN ATTIC SPACE CARRY DRYWALL UP TO ROOF SHEATHING AND CAULK WITH ACOUSTIC SEALANT

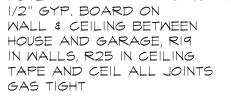

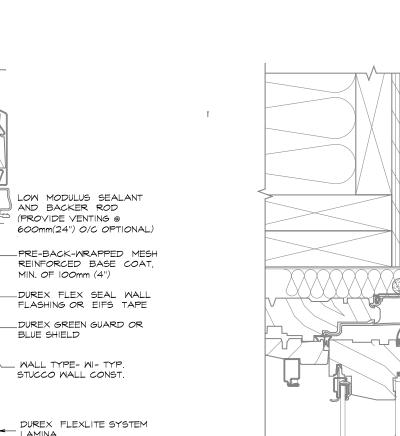


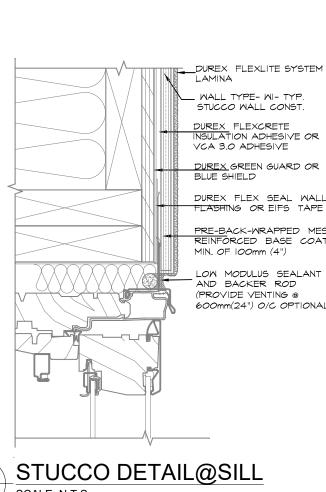

__ WALL TYPE- WI- TYP. STUCCO WALL CONST. DUREX FLEXCRETE INSULATION ADHESIVE OR VCA 3.0 ADHESIVE DUREX GREEN GUARD OR BLUE SHIELD DUREX FLEX SEAL WALL PRE-BACK-WRAPPED MESH REINFORCED BASE COAT, MIN. OF 100mm (4")

LOW MODULUS SEALANT AND BACKER ROD (PROVIDE VENTING @ 600mm(24") O/C OPTIONAL)

14 STUCCO DETAIL@SILL A3.01 SCALE=N.T.S.

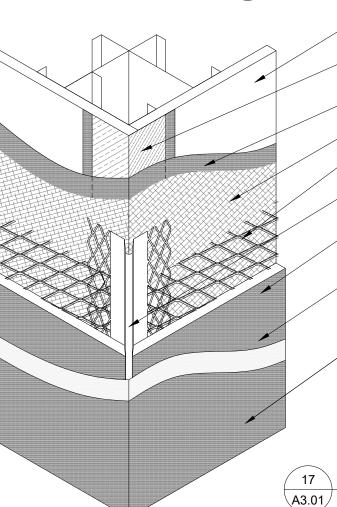

SHEATHING (BY OTHERS) PAREX USA SHEATHING JOINT TAPE - EMBEDDED IN PAREX USA WATER-RESISTIVE & AIR BARRIER COATING -PAREX USA WATER-RESISTIVE & AIR BARRIER COATING WATER-RESISTIVE BARRIER SHEET LATH PER ASTM CIO63

-CORNER BEAD

-STUCCO BASECOAT

PRIME COAT

-FINISH COAT

17 STUCCO DETAILS A3.01 SCALE= N.T.S.

EXTERIOR SHEATHING WATER-RESISTIVE BARRIER SHEET, 2 LAYERS ON WOOD-BASED SHEATHING

LATH PER ASTM CI063 STUCCO BASECOAT

PRIME COAT

FINISH COAT

18 STUCCO DETAILS

A3.01 SCALE= N.T.S.

ARCHISYSTEM INC. CONSULTING ARCHITECTS CERTIFICATE OF PRACTICE # 5465 80 Eastern Ave. Unit A9, Brampton, ON. Canada L6W 0B6 Tel:(O) 905 858-2565 (C) 647-295-2565 www.thearchisystem.com e-mail: archisystem@gmail.com NOTES: THE DRAWINGS SHALL NOT BE SCALED THE CONTRACTOR SHALL VERIFY ALL DIMENSIONS, DATUM AND LEVELS PRIOR TO COMMENCING THE WORK. FAILURE TO THAT THE CONTRACTOR WILL BE LIABLE TO RECTIFY WITHOUT EVERA COST WITHOUT EXTRA COST ALL ERRORS AND OMISSIONS TO BE REPORTED IMMEDIATELY THE ARCHITECT. VARIATIONS AND MODIFICATIONS TO WOR MARCHITECT: VARIATIONS AND MODIFICATIONS TO WOR SHOWN ON THIS DRAWING SHALL NOT BE CARRIED OUT WITHOUT THE WRITTEN CONSENT OF THE ARCHITECT THIS DRAWING IS EXCLUSIVE PROPERTY OF THE ARCHITECT AN SHALL NOT BE REPRODUCED WITHOUT THE ARCHITECT'S PERMISSION ALL WORKS TO BE DONE ACCORDING TO BEST COMMON PRACTICE AND CONFORM TO PREVAILING ONTARIO BUILDING CODE OWNER / CLIENT: DEREK SOHAIL USHA DANIEL PERMIT BY: ISSUED: REVISIONS: ASSOC/AN , fr.1, OF ARCHITECTS Z LICENCE 7987 PROJECT:

PROJECT ARCHITECTS:


PROPOSED ADDITION ALTERATION AT

376 PHILIP PLACE, ANCASTER, ON. L9G 3G8.


DRAWING TITLE:


SHEET TITLE: DETAILS

DATE: 04-08-2022 SCALE: AS NOTED SHEET NO: A3.01

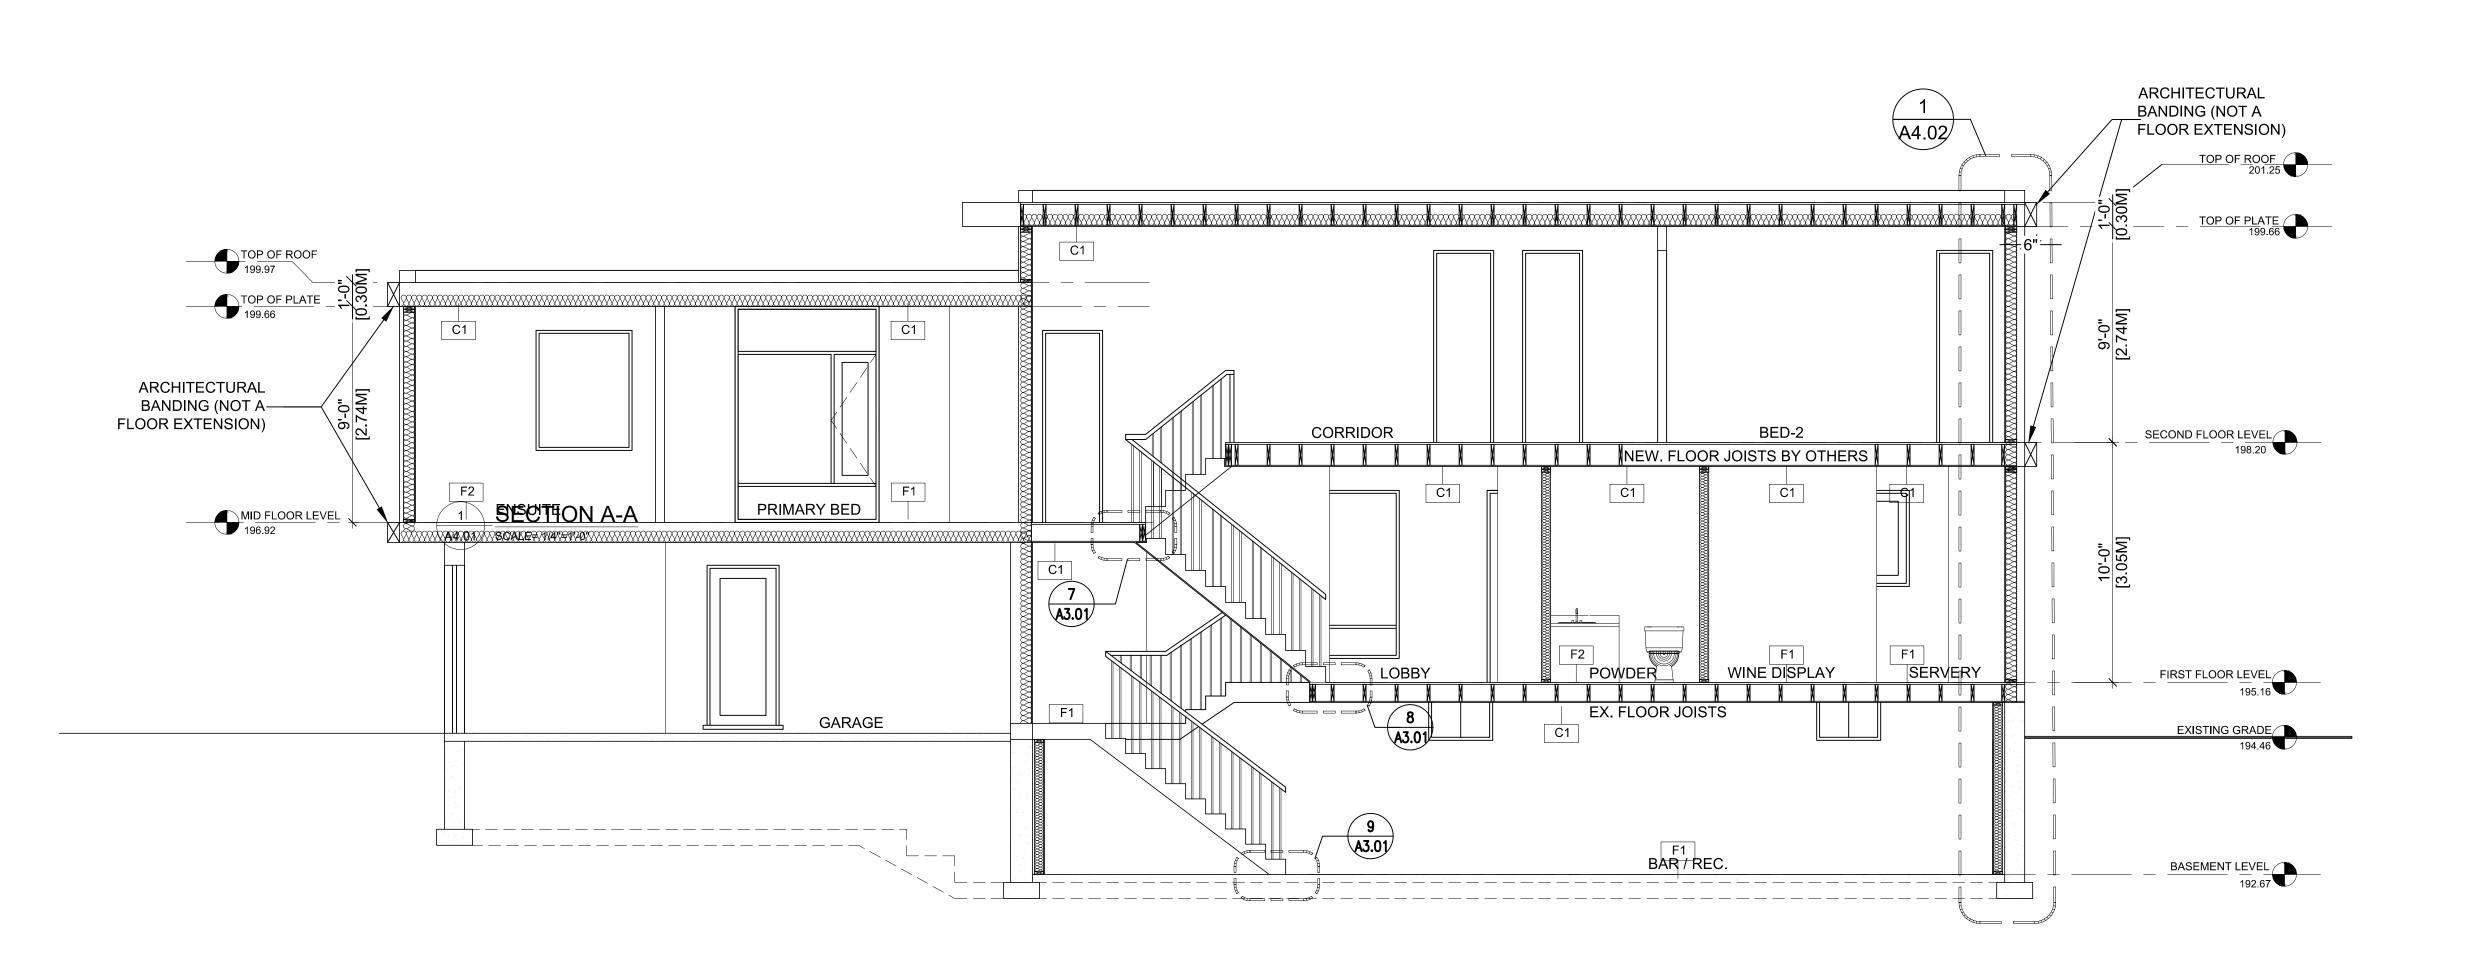


PROJECT ARCHITECTS	:		
ARCHISYS	TEN	1 IN	C.
CONSULTING ARCHIT			
80 Eastern Ave. Unit A9, Bra	ampton, O	N.	
Canada L6W 0B6 Tel:(O) 905 858-2565 (C) 6 www.thearchisystem.com			
e-mail: archisystem@gmail.	com		
NOTES: THE DRAWINGS SHALL NOT BE S THE CONTRACTOR SHALL VERIF		NSIONS, DA	TUM AND
LEVELS PRIOR TO COMMEN THAT THE CONTRACTOR WI WITHOUT EXTRA COST	LL BE LIABLE	TO RECT	FY
ALL ERRORS AND OMISSIONS TO THE ARCHITECT. VARIATION SHOWN ON THIS DRAWING S	S AND MOD SHALL NOT E	IFICATIONS BE CARRIEI	S TO WORI D OUT
WITHOUT THE WRITTEN CON THIS DRAWING IS EXCLUSIVE PR SHALL NOT BE REPRODUCE PERMISSION	OPERTY OF	THE ARCH	ITECT AN
ALL WORKS TO BE DONE ACCOR PRACTICE AND CONFORM TO BUILDING CODE			
OWNER / CLIENT			
OWNER / CLIENT: DEREK SOHAIL USHA DANIEL			
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DATE:		04-	08-2022
SCALE:		AS	NOTED
SHEET NO:		A 4	04

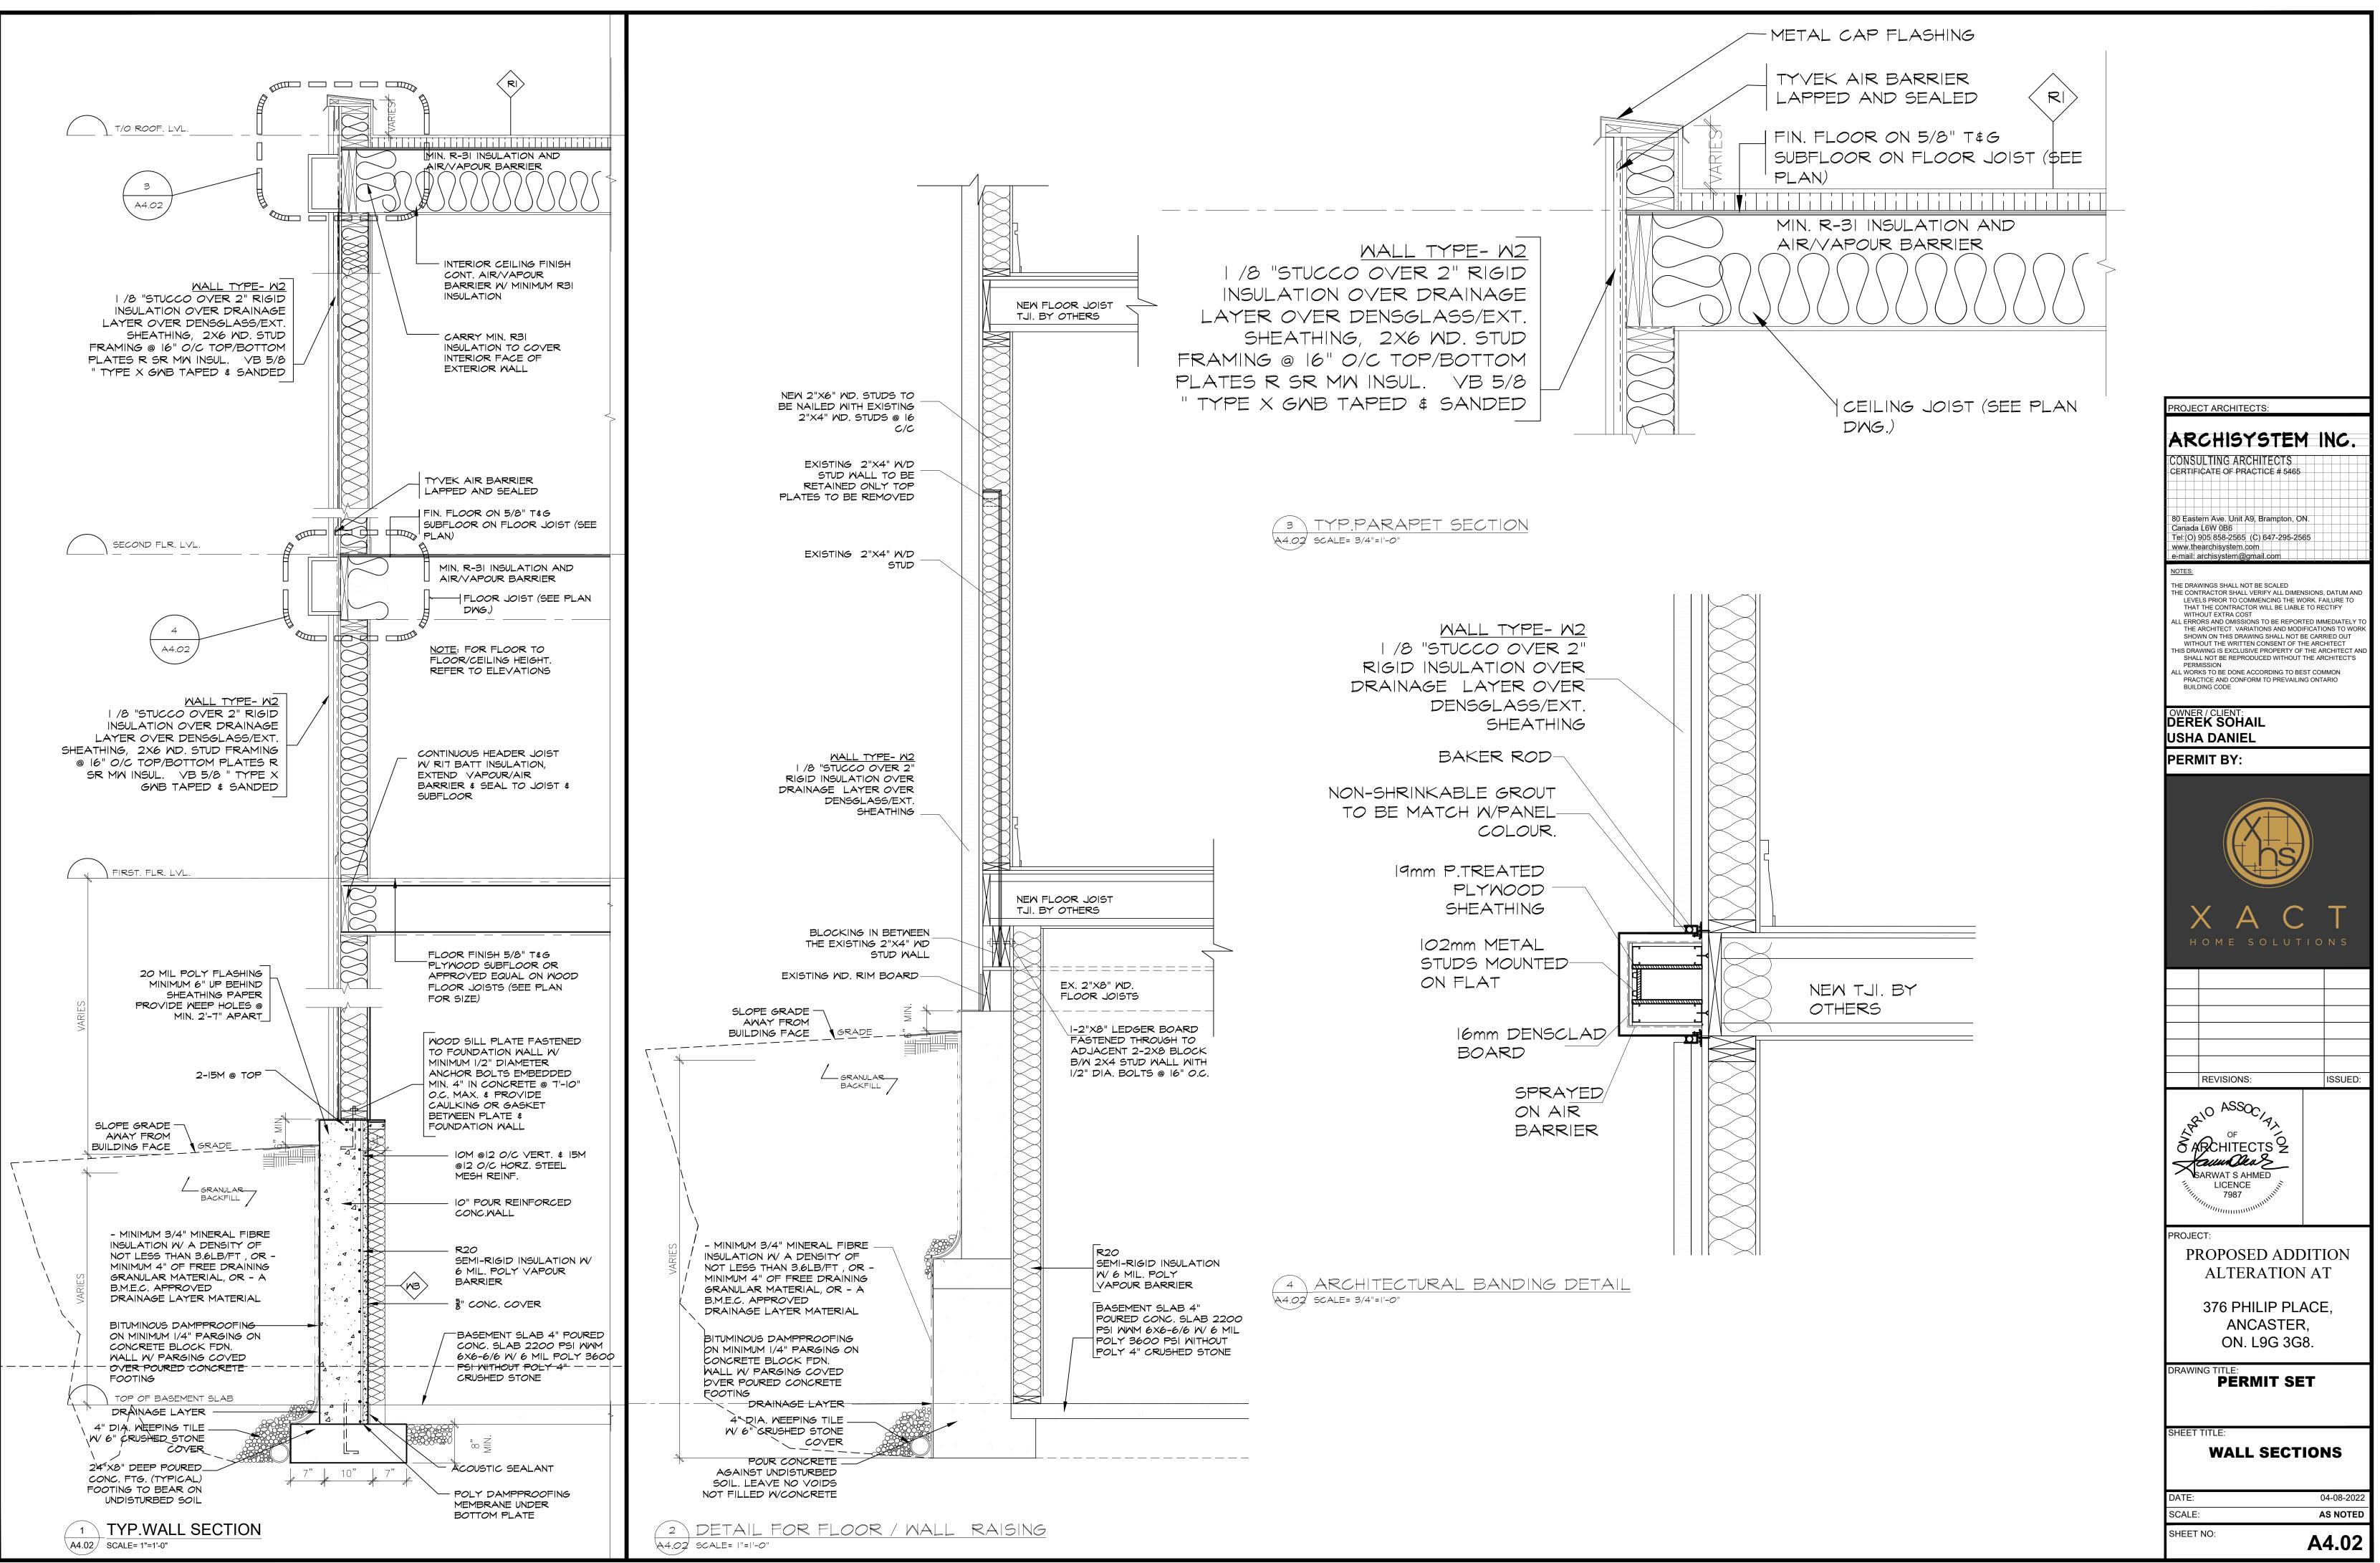

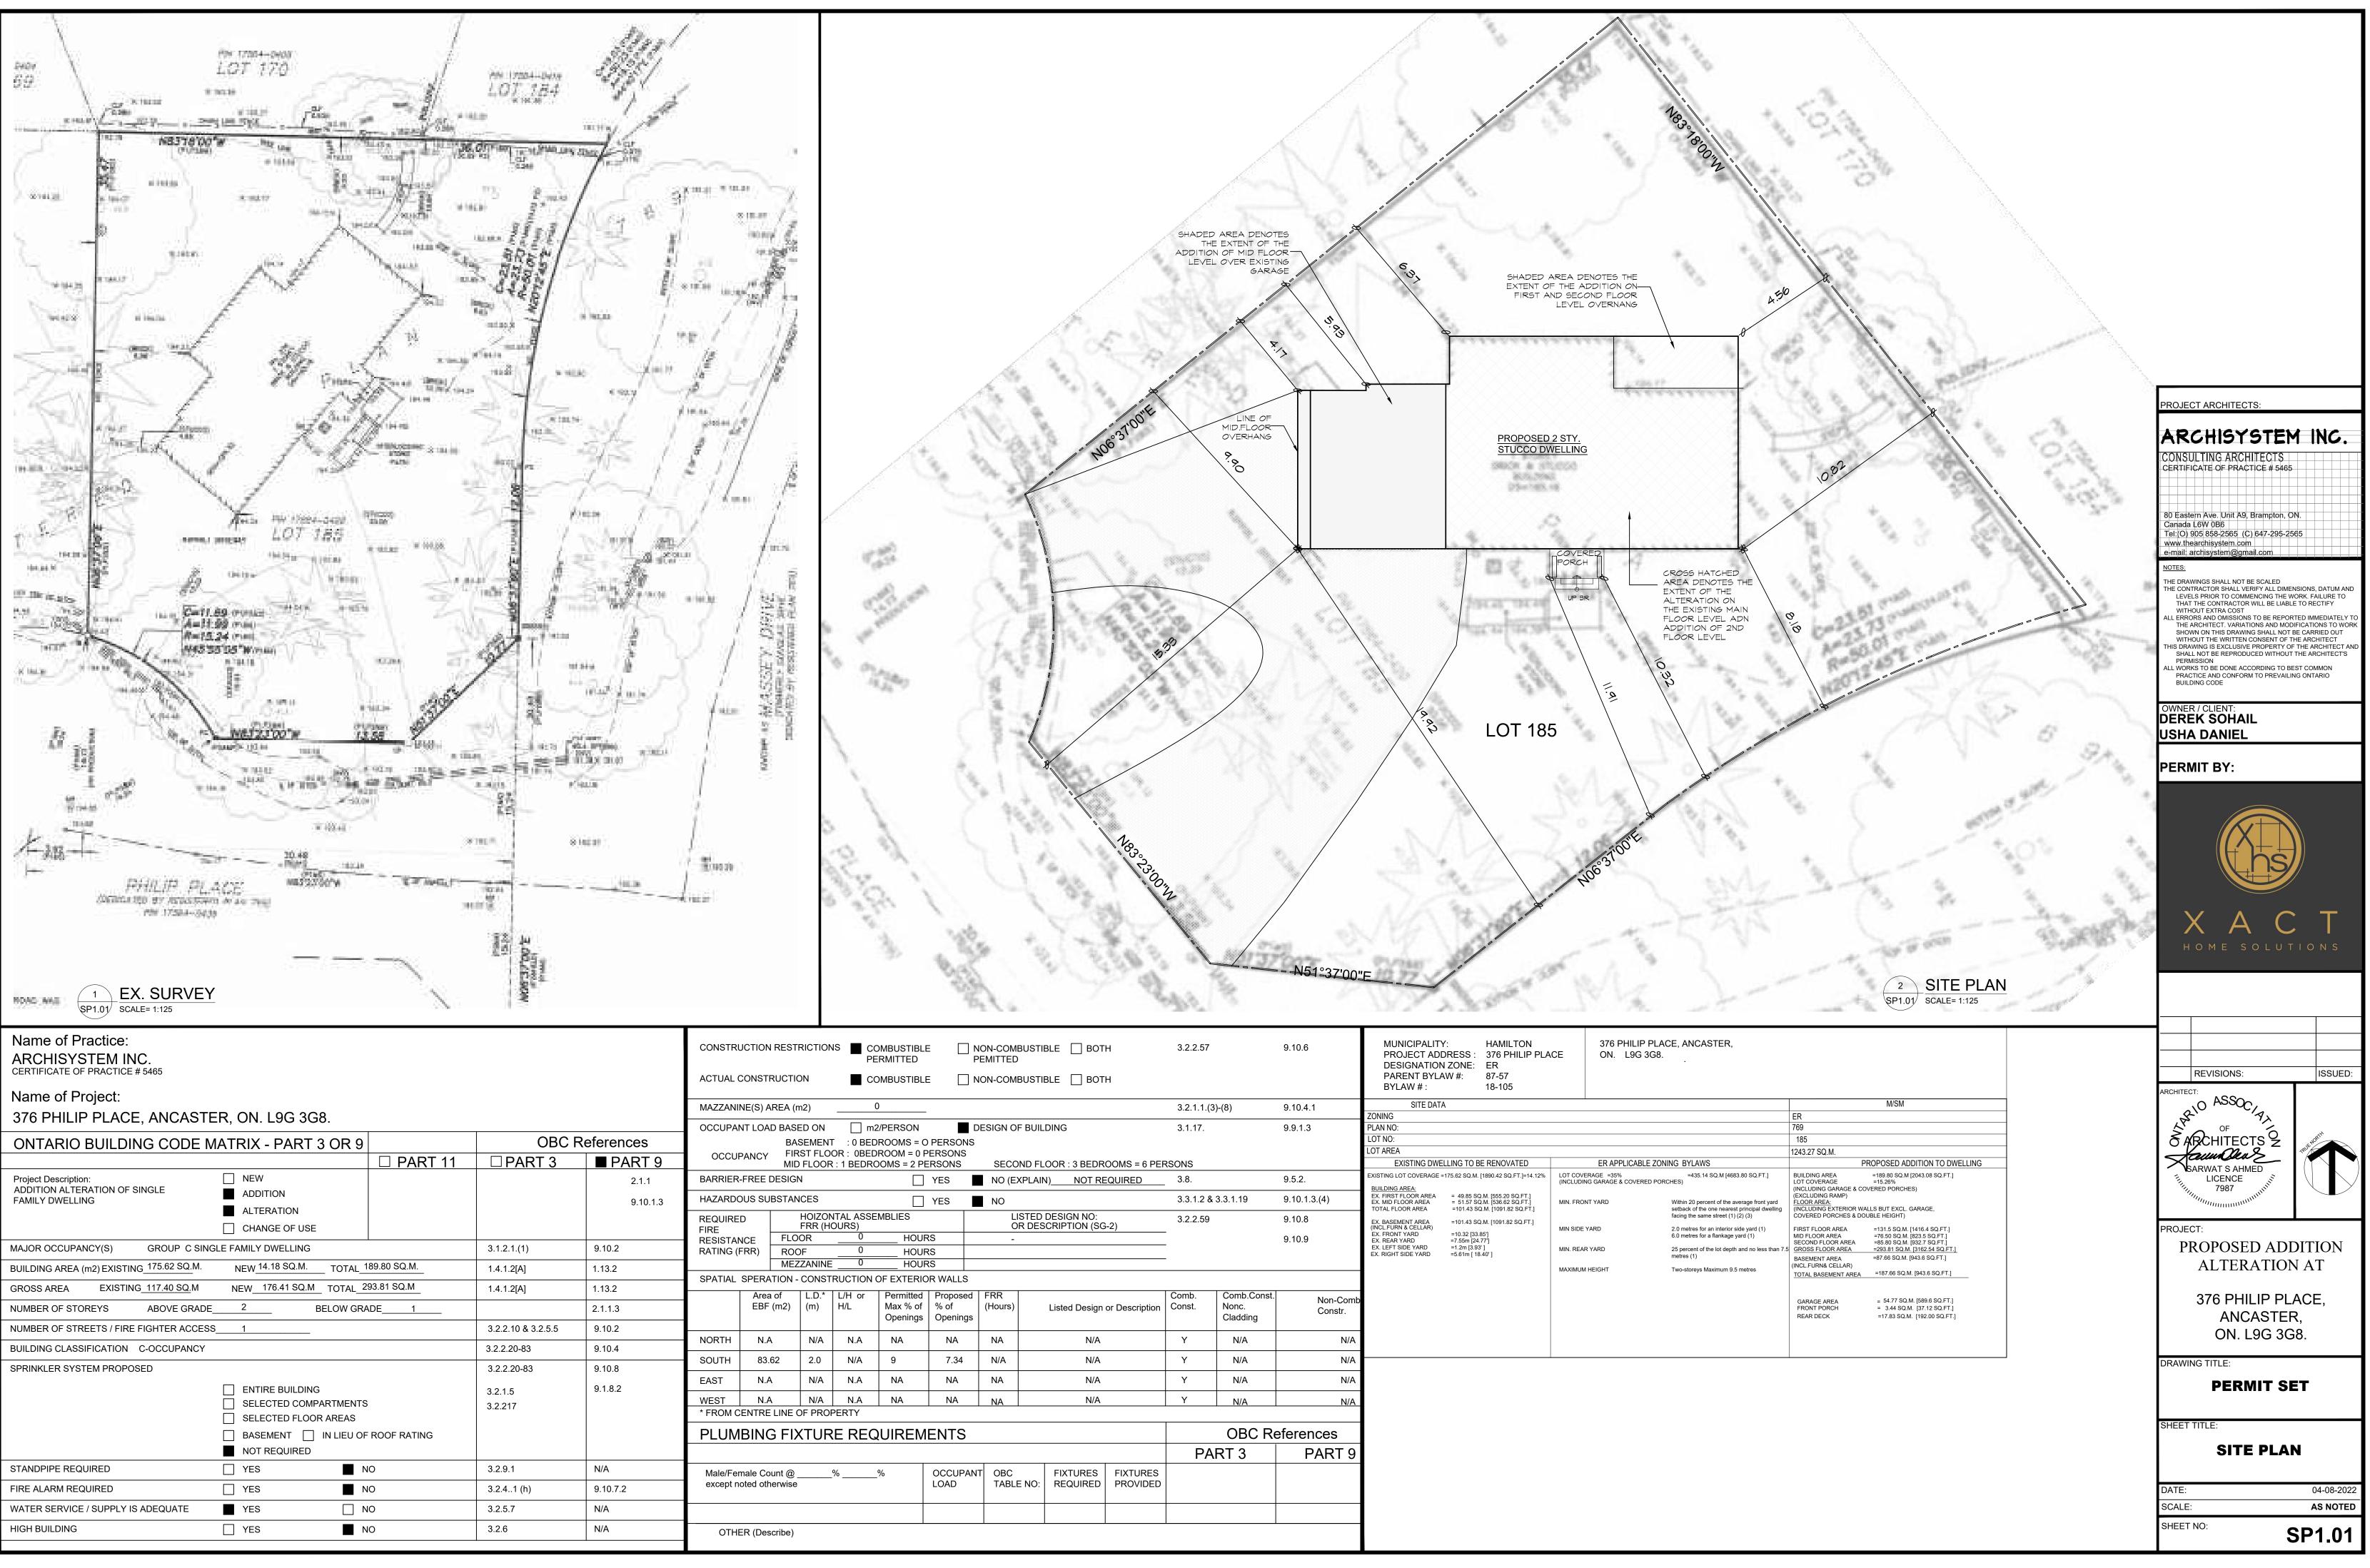

RICTIONS		MBUSTIBLI RMITTED		ON-COMBUST EMITTED	IBLE 🗌 BOTI	Н	3.2.2.57		9.10.6	MUNICIPALITY PROJECT ADD DESIGNATION	DRESS : 376 PHILIP PLA I ZONE: ER	376 PHILIP PLA CE ON. L9G 3G8
ON	CC	MBUSTIBL	E 🗌 NC	ON-COMBUST	IBLE 🗌 BOTI	Н				PARENT BYLA BYLAW # :	W#: 87-57 18-105	
m2) _	0						3.2.1.1.(3	6)-(8)	9.10.4.1	SITE DATA	A	
ED ON	m2	/PERSON		SIGN OF BUI	DING		3.1.17.		9.9.1.3	ZONING PLAN NO:		
SEMENT							0.1.11		0.0.110	LOT NO:		
		ROOM = 0 F								LOT AREA		
D FLOOR :	1 BEDRO	OMS = 2 PE	ERSONS	SECOND F	LOOR : 3 BEDR	OOMS = 6 PEF	RSONS			EXISTING DWE	LLING TO BE RENOVATED	ER APPLICABLE ZO
Ν			YES	NO (EXPLA	N) <u>NOT RE</u>	QUIRED	3.8.		9.5.2.	EXISTING LOT COVERAGE = BUILDING AREA:	175.62 SQ.M. [1890.42 SQ.FT.]=14.12%	LOT COVERAGE =35% (INCLUDING GARAGE & COVERED PO
NCES			YES	-			3.3.1.2 &	3.3.1.19	9.10.1.3.(4)	EX. FIRST FLOOR AREA EX. MID FLOOR AREA TOTAL FLOOR AREA	= 49.85 SQ.M. [555.20 SQ.FT.] = 51.57 SQ.M. [536.62 SQ.FT.] =101.43 SQ.M. [1091.82 SQ.FT.]	MIN. FRONT YARD
HOIZONT FRR (HOI		MBLIES			DESIGN NO: SCRIPTION (SG	-2)	3.2.2.59		9.10.8	EX. BASEMENT AREA (INCL.FURN & CELLAR)	=101.43 SQ.M. [1091.82 SQ.FT.]	MIN SIDE YARD
OR _	0	Hour	RS	-		•	-		9.10.9	EX. FRONT YARD EX. REAR YARD	=10.32 [33.85'] =7.55m [24.77']	
OF _	0	Hour					-			EX. LEFT SIDE YARD EX. RIGHT SIDE YARD	=1.2m [3.93'] =5.61m [18.40']	MIN. REAR YARD
ZZANINE	0	Hour										MAXIMUM HEIGHT
- CONSTR	UCTION C	OF EXTERIO	OR WALLS									
	L/H or H/L	Permitted Max % of Openings		FRR (Hours)	Listed Design	or Description	Comb. Const.	Comb.Const. Nonc. Cladding	Non-Comb Constr.			
N/A	N.A	NA	NA	NA	N/A		Y	N/A	N/A			
2.0	N/A	9	7.34	N/A	N/A		Y	N/A	N/A			
N/A	N.A	NA	NA	NA	N/A		Y	N/A	N/A			
N/A	N.A	NA	NA	NA	N/A		Y	N/A	N/A			
OF PROPE	ERTY											
XTURE	E REQ	UIREM	ENTS					OBC Re	eferences			
							PA	RT 3	PART 9			
%)	%	OCCUPANT LOAD	OBC TABLE NO:	FIXTURES REQUIRED	FIXTURES PROVIDED						
				l			1					

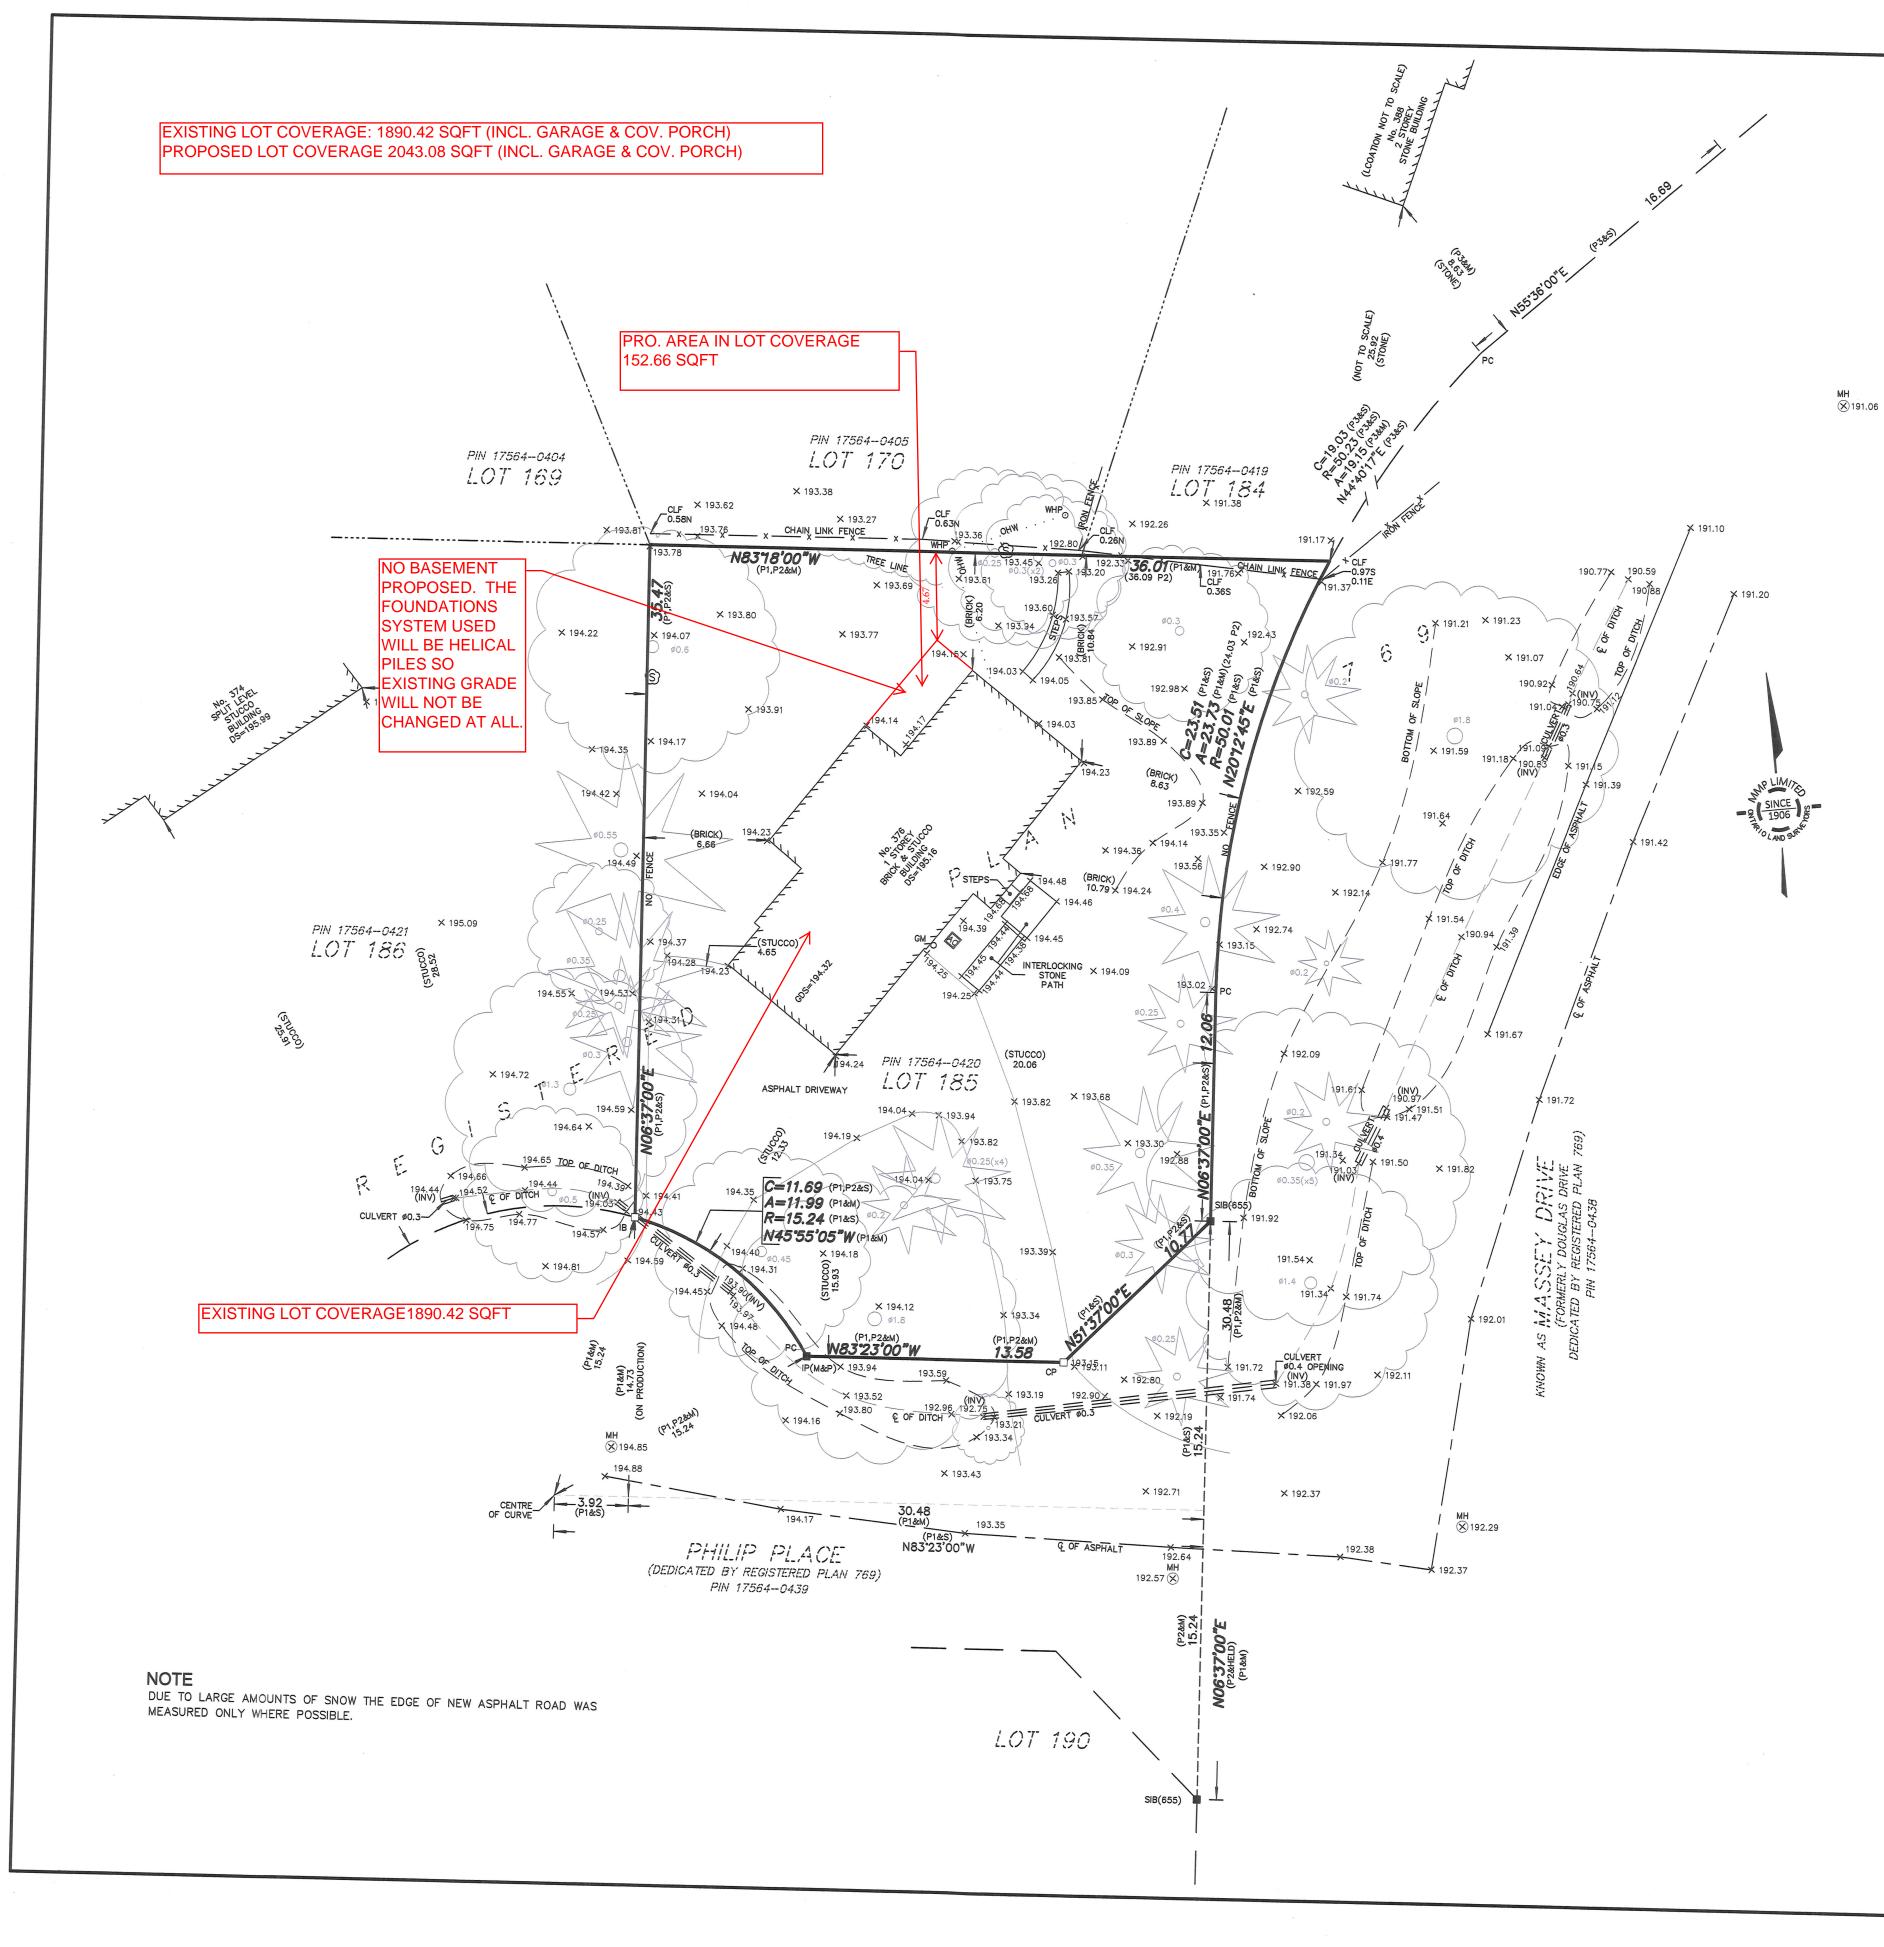

SURVEYOR'S REAL PROPERTY
PART 1 - PLAN OF SURVEY SH
LOT 185
REGISTERED PLAN 76
IN THE
CITY OF HAMILTON
SCALE 1 : 200
THE INTENDED PLOT SIZE OF THIS PLAN IS 680mm IN WHEN PLOTTED AT A SCALE OF 1:200 (INCLUDING 1
MacKAY, MacKAY & PETERS LIMITED - ONT
KNOWN AS MUNICIPAL No. 376 PHILIP PLAC
PART 2 - REPORT SUMMARY (TO BE READ LAND REGISTRY OFFICE TITLE INFORMATION ON SUBJECT PI BOUNDARIES, EASEMENTS AND RIGHT OF WAYS - NOVEMBI
REGISTERED EASEMENTS AND/OR RIGHTS-OF- - NONE
ADDITIONAL REMARKS: - REFER TO PART 1 OF SURVEY FOR THE LOCATION OF B
MacKAY, MacKAY & PETERS LIMITED grants ANTHONY MANCIN their solicitor and other related parties permission Surveyor's Real Property Report in transacti
METRIC DISTANCES SHOWN HEREON ARE IN METRES AND CAN BE CONVERTED TO FEET BY DIVIDING BY 0.3

LEGEND ■ DENOTES A SURVEY MONUMENT FOUND □ DENOTES A SURVEY MONUMENT PLANTED SIB DENOTES STANDARD IRON BAR IB DENOTES IRON BAR CP DENOTES CONCRETE PIN IP DENOTES IRON PIPE
P1 DENOTES PLAN BY MMP LIMITED DATED JANUARY 16, P2 DENOTES REGISTERED PLAN 769 P3 DENOTES PLAN BY MMP LIMITED DATED MAY 26, 1985 PIN DENOTES PROPERTY IDENTIFICATION NUMBER PC DENOTES POINT OF CURVATURE
© DENOTES CENTRELINE WHP DENOTES WOOD HYDRO POLE OHW DENOTES OVERHEAD WIRE (INV) DENOTES INVERT MH DENOTES MANHOLE GM DENOTES GAS METER CLF DENOTES CHAIN LINK FENCE GDS DENOTES GARAGE DOORSILL M DENOTES AIR CONDITIONER ③ DENOTES STUMP
DENOTES DECIDOUS TREE SCALED TO CANOPY TRUNK S
DENOTES CONIFEROUS TREE SCALED TO CANOPY TRUNK
ALL BUILDING TIES ARE TO FOUNDATION AND PERPENDIDUUNLESS OTHERWISE NOTED
BENCHMARK NO. 0011975U144 BENCHMARK No. 0011975U144 ELEVATION = 215.265 METRES (CGVD28:78 ADJUSTMENT)
CONCRETE & STONE WALL WILSON STREET NORTHEAST OF CENTRE OF NORTHEAST END OF WALL AT SOUTHEAST SIDE & 9.8 METRES SOUTHWEST OF CENTRE LINE OF PRIVATE DF BELOW TOP OF WALL AT SIDEWALK LEVEL

BEARING REFERENCE BEARINGS ARE ASTRONOMIC AND ARE REFERRED TO THE

DRIVE AS SHOWN ON REGISTERED PLAN 769 HAVING A BI

I CERTIFY THAT:

1. THIS SURVEY AND PLAN ARE CORRECT AND IN ACCORD THE SURVEYORS ACT AND THE REGULATIONS MADE UNI

2. THE SURVEY WAS COMPLETED ON THE 18th DAY OF JA

JANUARY 25, 2022 DATE



TY REPORT Showing topography of
69
20 metres m IN WIDTH BY 520mm IN HEIGHT G 15mm BEYOND EACH BORDER) NTARIO LAND SURVEYORS
LACE
EAD IN CONJUNCTION WITH PART 1) T PROPERTY INCLUDING EMBER 2, 2021 OF-WAY:
OF BUILDINGS, STRUCTURES, FENCES & UTILITIES
NCINI & CAIRINE MACKAY WILSON ("The Client"), sion to use "Original Copies" of the sactions involving "The Client"
AND ASSOCIATION OF ONTARIO
LAND SURVEYORS PLAN SUBMISSION FORM V-21934 THIS PLAN IS NOT VALID UNLESS IT IS AN EMBOSSED
ORIGINAL COPY ISSUED BY THE SURVEYOR IN ACCORDANCE WITH
REGULATION 1026, SECTION 29(3)
16, 1985 (Y—19541)
1985 (Y-19706)
JNK SIZE SHOWN IN METRES
TRUNK SIZE SHOWN IN METRES
PENDICULAR TO PROPERTY LIMITS
NT)
OF MOHAWK ROAD TABLET IN
SIDE OF WILSON STREET TE DRIVEWAY 1.12 METRES
HE WESTERLY LIMIT OF MASSEY BEARING OF N06*37'00"E
ORDANCE WITH THE SURVEYS ACT.
UNDER THEM.
AISAR BHERI ONTARIO LAND SURVEYOR MACKAY, MACKAY & PETERS LIMITED 1-379.dwg
Service Road DRAWN BY: G.S.
ON PARTY CHIEF: M.A. 375 CHECKED BY: AB
PROJECT No.: 21-379



Committee of Adjustment City Hall, 5th Floor, 71 Main St. W., Hamilton, ON L8P4Y5

Phone: (905) 546-2424 ext. 4221 Email: <u>cofa@hamilton.ca</u>

APPLICATION FOR A MINOR VARIANCE

FOR OFFICE USE ONLY.	
APPLICATION NO.	DATE APPLICATION RECEIVED
PAID	DATE APPLICATION DEEMED COMPLETE
SECRETARY'S SIGNATURE	

The Planning Act

Application for Minor Variance or for Permission

The undersigned hereby applies to the Committee of Adjustment for the City of Hamilton under Section 45 of the *Planning Act*, R.S.O. 1990, Chapter P.13 for relief, as described in this application, from the Zoning By-law.

1, 2	NAME	MAILING ADDRESS	
Registered Owners(s)	Derek Sohail Usha Daniel Shophan Daniel Suzeen Daniel		
Applicant(s)*	Derek Sohail Shophan Daniel		
Agent or Solicitor			Phone:
			E-mail:

Note: Unless otherwise requested all communications will be sent to the agent, if any.

 Names and addresses of any mortgagees, holders of charges or other encumbrances: Royal Bank of Canada 10 YORK MILLS RD NORTH YORK, ON M2P 0A2

Additional sheets can be submitted if there is not sufficient room to answer the following questions. Additional sheets must be clearly labelled

4.	Nature and extent of relief applied for:
	To reduce the rearyard setback from the required 7.5m to 4.5m. Note: It should be noted that the existing Non-conforming setback of 6.5m to the existing dwelling.
_	Second Dwelling Unit Reconstruction of Existing Dwelling
5.	Why it is not possible to comply with the provisions of the By-law?
	Proposed addition result in reduce setback. Notwithstanding due to existing lot configuration and dwelling orientation, it is difficult to meet the required setback. However, the proposal maintain the ample rearyard amenity area.
6.	Legal description and Address of subject lands (registered plan number and lot number or other legal description and where applicable, street and street number):
	Part 1 - Lot 185 Registered Plan 769 376 Philip Place, Ancaster
7.	PREVIOUS USE OF PROPERTY
	Residential 🔲 Industrial 🗌 Commercial 🗌
	Agricultural 🗌 Vacant 🗌
	Other
8.1	If Industrial or Commercial, specify use
8.2	Has the grading of the subject land been changed by adding earth or other material, i.e. has filling occurred?
	Yes No No Unknown
8.3	Has a gas station been located on the subject land or adjacent lands at any time? Yes 🗌 No 🔳 Unknown 🗍
8.4	Has there been petroleum or other fuel stored on the subject land or adjacent lands?
	Yes No I Unknown
8.5	Are there or have there ever been underground storage tanks or buried waste on the subject land or adjacent lands?
	Yes No No Unknown
8.6	Have the lands or adjacent lands ever been used as an agricultural operation where cyanide products may have been used as pesticides and/or sewage sludge was applied to the lands?
	Yes 🗌 No 🗵 Unknown 🗌
8.7	Have the lands or adjacent lands ever been used as a weapon firing range? Yes No No Vinknown
8.8	Is the nearest boundary line of the application within 500 metres (1,640 feet) of the fill area of an operational/non-operational landfill or dump?
	Yes 🗌 No 🔳 Unknown 🗌
8.9	If there are existing or previously existing buildings, are there any building materials remaining on site which are potentially hazardous to public health (eg. asbestos, PCB's)?
	Yes 🗌 No 🔳 Unknown 🗌

8.10	Is there any reaso uses on the site or			t land may ha	ave bee	n conta	aminated	by former
		No 🔳	Unkno	own 🗌				
8.11	What information of							
	Recently property any concerns. In							identify
8.12	If previous use of previous use inver previous use inver land adjacent to th	ntory showing	all forme	er uses of the				
	Is the previous use	e inventory atta	ached?	Yes		No		
9.	ACKNOWLEDGE I acknowledge tha remediation of cor reason of its appro	t the City of Hantamination on	amilton i the prop	perty which is				
	May 17, 2022							
	Date			Signature F	roperty	Owner	r(s)	
				Derek Soh	ail			
				Print Name		er(s)		
10.	Dimensions of lan	ds affected:						
	Frontage	29.68M						
	Depth	35.47M						
	Area	1243.27M						
	Width of street	7M						
11.	Particulars of all be ground floor area, Existing: GROUND FLOOF GROSS FLOOR NO.OF STORIES BUILIDNG HEIGE Proposed GROUND FLOOF GROSS FLOOR NO.OF STORIES	gross floor an R AREA=49.8 AREA=101.43 HT=4.87M R ARE=131.5 AREA=293.81 S= 2	ea, num 5 SQ.M 3 SQ.M SQ.M			-		
12.	BUILIDNG HEIGH	dings and stru			d for the	subjec	ct lands;	(Specify
	distance from side	, rear and fron	it lot line	S)				

Existing:
FRONT YARD:15.33M REAR YARD= 6.2M FLAKAGE= 8.63M INTERIOR YARD= 4.65M
Proposed:
FRONT YARD:15.33M REAR YARD= 4.67M FLAKAGE= 8.63M INTERIOR YARD= 4.65M

13.	Date of acquisition of subject lands: Mar. 11, 2022
14.	Date of construction of all buildings and structures on subject lands: Expected Renovation Summer 2022
15.	Existing uses of the subject property (single family, duplex, retail, factory etc.): Single
16.	Existing uses of abutting properties (single family, duplex, retail, factory etc.): Single
17.	Length of time the existing uses of the subject property have continued: Approx. 40+ years
18.	Municipal services available: (check the appropriate space or spaces) Water <u>Yes</u> Connected <u>Yes</u>
	Sanitary Sewer Yes Connected Yes Storm Sewers Unknown Connected Yes
19.	Present Official Plan/Secondary Plan provisions applying to the land:
	Neighborhoods Designations
20.	Present Restricted Area By-law (Zoning By-law) provisions applying to the land:
	Existing Residential (ER Zone)
21.	Has the owner previously applied for relief in respect of the subject property? (Zoning By- law Amendment or Minor Variance) Yes × No If yes, please provide the file number:
	21.1 If a site-specific zoning by-law amendment has been received for the subject property, has the two-year anniversary of the by-law being passed expired?
	21.2 If the answer is no, the decision of Council, or Director of Planning and Chief Planner that the application for Minor Variance is allowed must be included. Failure to do so may result in an application not being "received" for processing.
22.	Is the subject property the subject of a current application for consent under Section 53 of the <i>Planning Act</i> ?
23.	Additional Information (please include separate sheet if needed)
24.	The applicant shall attach to each copy of this application a plan showing the dimensions of the subject lands and of all abutting lands and showing the location, size and type of all buildings and structures on the subject and abutting lands, and where required by the Committee of Adjustment such plan shall be signed by an Ontario Land Surveyor.