

#### **COMMITTEE OF ADJUSTMENT**

City Hall, 5<sup>th</sup> floor, 71 Main Street West, Hamilton, ON L8P 4Y5
Telephone (905) 546-2424, ext. 4221, 3935

E-mail: cofa@hamilton.ca

### NOTICE OF PUBLIC HEARING Minor Variance

#### You are receiving this notice because you are either:

- Assessed owner of a property located within 60 metres of the subject property
- Applicant/agent on file, or
- Person likely to be interested in this application

APPLICATION	HM/A-22:200	SUBJECT	2 RUTHERFORD AVENUE,
NO.:		PROPERTY:	HAMILTON
ZONE:	"C" (Urban Protected	ZONING BY-	Zoning By-law 6593, as Amended
	Residential, etc.)	LAW:	

**APPLICANTS:** Agent Perspective Views – M. Ribau

Owner C. Zavarise

The following variances are requested:

- 1. To permit the expansion of a legally established non-conforming five (5) unit multiple dwelling by construction of a dormer addition on the 2<sup>nd</sup> floor notwithstanding that a multiple dwelling is not permitted.
- 2. A minimum front yard depth of 3.5m shall be permitted instead of the minimum required front yard depth of 6.0m.
- 3. The existing rear fire escape shall be permitted to project a maximum of 5.9m into the minimum required 7.5m rear yard and shall be at least 1.6m from the rear lot line instead of the requirement that an open fire escape or open stairway may project into a required rear yard not more than 1.0m.

**PURPOSE & EFFECT:** To permit the expansion of a legally established non-conforming five (5) unit multiple dwelling by construction of a dormer addition on the 2<sup>nd</sup> floor for Unit 202:

#### Notes:

This Notice must be posted by the owner of any land which contains seven or more residential units so that it is visible to all residents.

This application will be heard by the Committee as shown below:

#### HM/A-22:200

DATE:	Thursday, July 14, 2022
TIME:	2:30 p.m.
PLACE:	Via video link or call in (see attached sheet for details)
	2 <sup>nd</sup> floor City Hall, room 222 (see attached sheet for
	details), 71 Main St. W., Hamilton
	To be streamed (viewing only) at
	www.hamilton.ca/committeeofadjustment

For more information on this matter, including access to drawings illustrating this request and other information submitted:

- Visit <u>www.hamilton.ca/committeeofadjustment</u>
- Email Committee of Adjustment staff at cofa@hamilton.ca
- Call 905-546-CITY (2489) or 905-546-2424 extension 4221, 4130, or 3935

#### **PUBLIC INPUT**

**Written:** If you would like to submit written comments to the Committee of Adjustment you may do so via email or hardcopy. Please see attached page for complete instructions, <u>including deadlines</u> for submitting to be seen by the Committee.

**Orally:** If you would like to speak to this item at the hearing you may do so via video link, calling in, or attending in person. Please see attached page for complete instructions, including deadlines for registering to participate virtually.

#### HM/A-22:200



DATED: June 28, 2022

Jamila Sheffield, Secretary-Treasurer Committee of Adjustment Information respecting this application is being collected under the authority of the Planning Act, R.S.O., 1990, c. P. 13. All comments and opinions submitted to the City of Hamilton on this matter, including the name, address, and contact information of persons submitting comments and/or opinions, will become part of the public record and will be made available to the Applicant and the general public, and may include posting electronic versions.



#### COMMITTEE OF ADJUSTMENT

City Hall, 5<sup>th</sup> floor, 71 Main Street West, Hamilton, ON L8P 4Y5 Telephone (905) 546-2424, ext. 4221, 3935

E-mail: cofa@hamilton.ca

#### PARTICIPATION PROCEDURES

#### Written Submissions

Members of the public who would like to participate in a Committee of Adjustment meeting are able to provide comments in writing or via email in advance of the meeting. Comments can be submitted by emailing cofa@hamilton.ca or by mailing the Committee of Adjustment, City of Hamilton, 71 Main Street West, 5th Floor, Hamilton, Ontario, L8P 4Y5. Comments must be received by noon two days before the Hearing.

Comments are available two days prior to the Hearing and are available on our website: www.hamilton.ca/committeeofadjustment

#### **Oral Submissions**

Members of the public are also able to provide oral comments regarding Committee of Adjustment Hearing items by participating Virtually through Webex via computer or phone or by attending the Hearing In-person. Participation Virtually requires pre-registration in advance. Please contact staff for instructions if you wish to make a presentation containing visual materials.

#### 1. Virtual Oral Submissions

Interested members of the public, agents, and owners <u>must register by noon the day before the hearing</u> to participate Virtually.

To register to participate Virtually by Webex either via computer or phone, please contact Committee of Adjustment staff by email <a href="mailton.ca">cofa@hamilton.ca</a>. The following information is required to register: Committee of Adjustment file number, hearing date, name and mailing address of each person wishing to speak, if participation will be by phone or video, and if applicable the phone number they will be using to call in.


A separate registration for each person wishing to speak is required. Upon registering for a meeting, members of the public will be emailed a link for the Webex meeting the Wednesday afternoon before the hearing. The link must not be shared with others as it is unique to the registrant.


#### 2. In person Oral Submissions

Interested members of the public, agents, and owners who wish to participate in person <u>must sign in at City Hall room 222 (2<sup>nd</sup> floor) no less than 10 minutes</u> before the time of the Public Hearing as noted on the Notice of Public Hearing.

We hope this is of assistance and if you need clarification or have any questions, please email cofa@hamilton.ca or by phone at 905-546-2424 ext. 4221.

Please note: Webex (video) participation requires either a compatible computer or smartphone and an application (app/program) must be downloaded by the interested party in order to participate. It is the interested party's responsibility to ensure that their device is compatible and operating correctly prior to the Hearing.

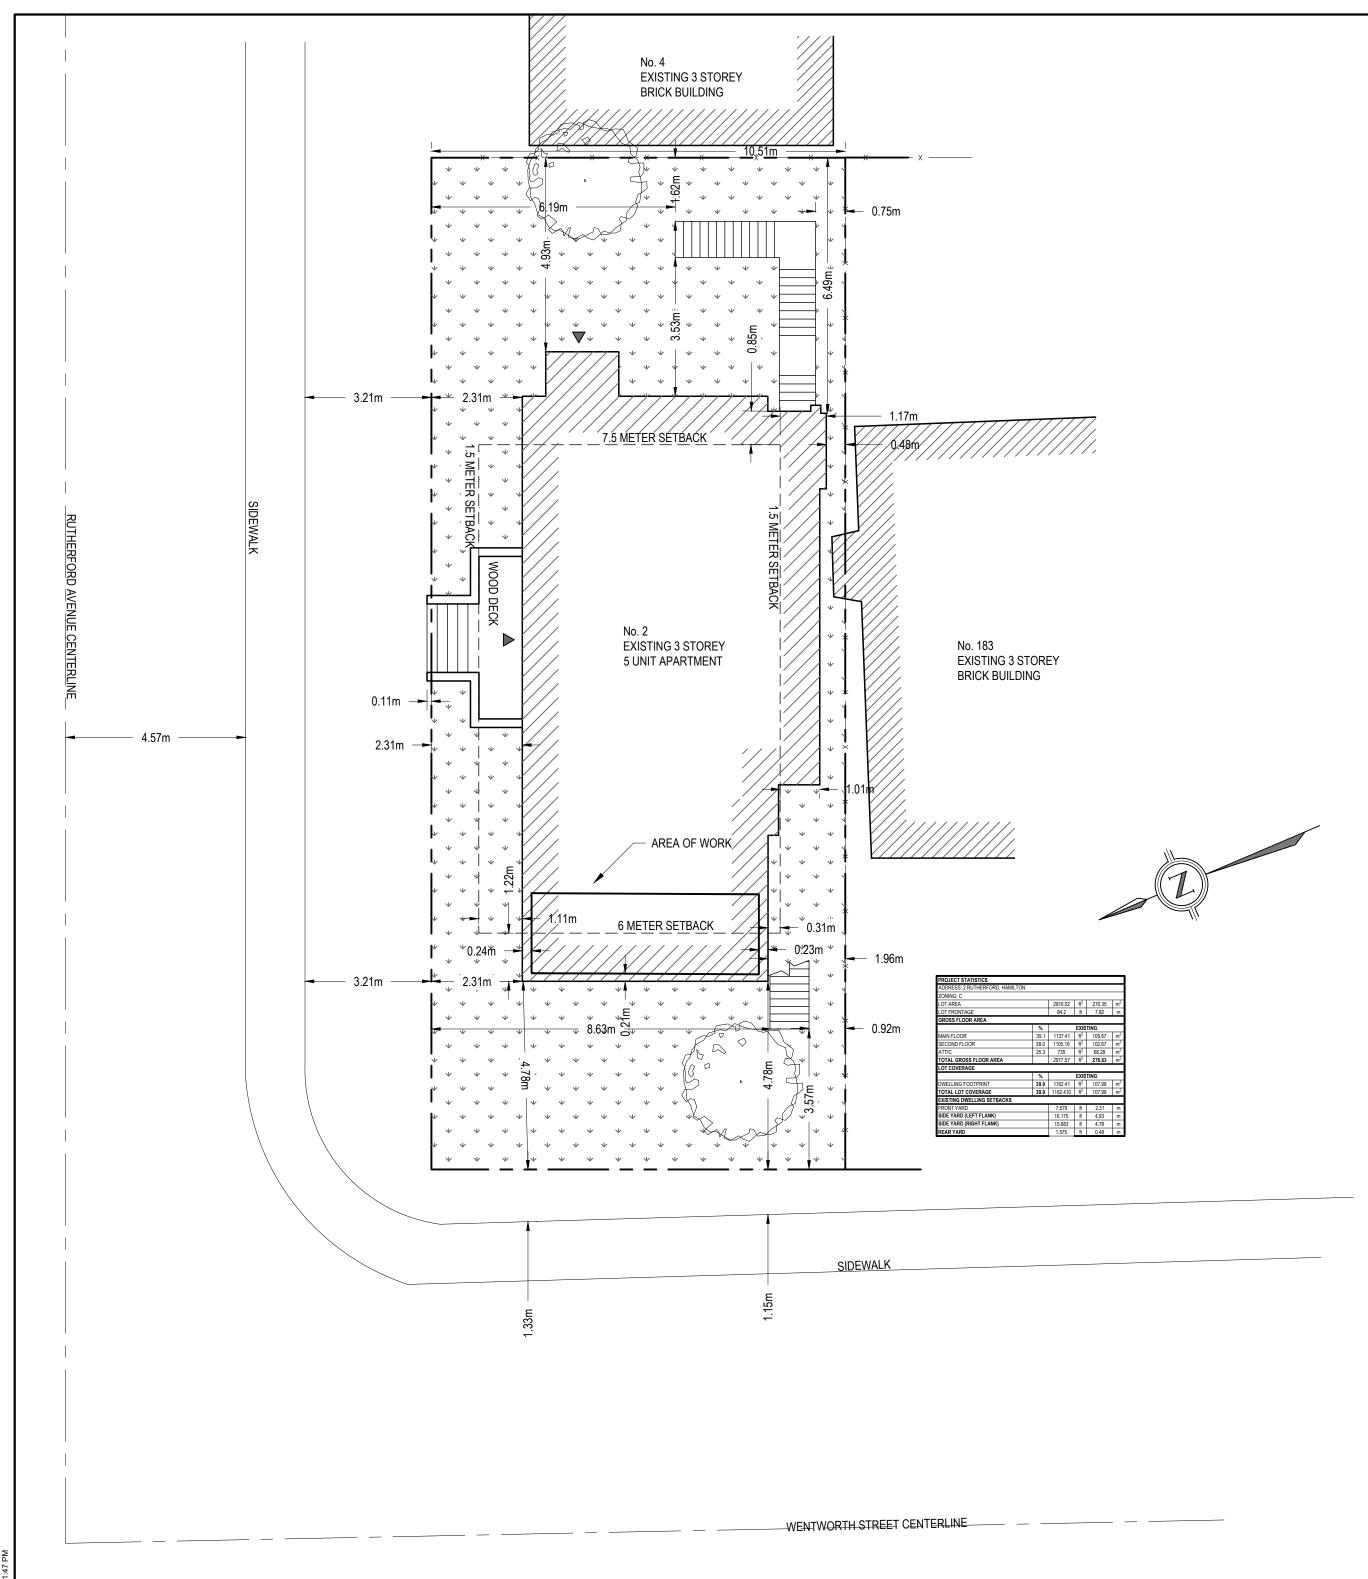

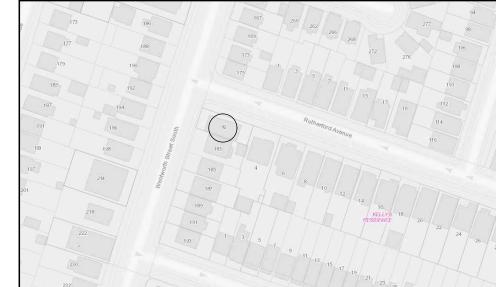

### KEYPLAN



### STREET VIEW

Item					tario's 2012 Data Matrix					References for	OBC Ref are to Divi Division A	sion B Unless no or [C] for Division	oted [
	Project D	escriptio	on			] New	l r	Part 10	-+	☐ Part 3		Part 9	
				hange of I		] Addition ] Renova	1	0.1 to 10.4		1.1.2. [A]		1.1.2. [A] &	9.10.1
	Major Oc				ntial (Group (	•	1			3.1.2.1.(1)			
	Building	Area (n	n²)	Existing	110	New 0		Total 110		1.4.1.2.(A)		1.4.1.2.(A)	
	Gross Ar		_	Existing	274	New 0		Total 274		1.4.1.2.(A)		1.4.1.2.(A)	
	Number						Grade: 3	Below Grade: 1		3.2.2.10. & 3.2			
			<u> </u>		C, Part 9					- a.z.z.10. & 3.z	2.5.		
	Sprinkler					] Entire (	Building			3.2.2.47.			
		-			_		d Compartm	nents				-	
						] Selecte	d Floor Area	38					
						] Baseme		In lieu of roof rating				-	
	Standpipe	Requi	ired			Not Re	quired 🖂	No		3.2.9.			
10	Fire Aları	_		By Other		Yes				3.2.4.2.(4)		9.10.18.2.	
11				is Adeq		Yes		No		3.2.5.7.		-	
12	High Buil	ding				] Yes	×	No		3.2.6.		-	
13	Construc	tion Re	stricti	ons	☐ Con	nbustible mitted	☐ Non- Requ	-combustible 🔀 ired	3 Both	3.2.2.47.		_	
	Actual C	onstruc	tion		☐ Yes		□ No	×	3 Both				
14	Mezzani	ine Ar	rea (	m²) –	n/a				+	_		_	
15	Occupano					M²/Pers	ion 🗵	design of buildin	ıg	3.1.17.		_	
	Residenti	al – 2	Perso	ons Per E	Bedroom - 10					-			
16	Barrier-f					] Yes	⊠	No		3.8.		11.3.3.2. (2)	
17	Hazardou	s Subs	tance	3		] Yes	×	No		3.3.1.2. & 3.3.	1.19.	-	
18	Required Resistance	:e	ı		Assemblies (Hours)			Listed Design No or Description	». T				
	Rating (F		104	Floor	0.75Ho	urs	cr	E DRAWINGS					
		ł		Floor	0.75Hou			E DRAWINGS					
		İ		Floor	_0.75Hou		SE	E DRAWINGS					
		į	Root		_N/AHo	ours							
				FRR of Supporting Listed Design No. Members or Description (SB-2)									
	1st		1st	Floor		lours		E DRAWINGS	-				
		ł		Floor _	0.75Hou			E DRAWINGS					
		İ	3rd	Floor	_0.75Hou	rs	SE	E DRAWINGS					
4-		[	Root			urs							
19	Spatial S Wall	eparati Area		Construc LD (m)	tion of Exterior		(REFER TO FL	OOR PLANS FOR DE	'FRR'	Listed	Comb	Comb. Constr.	Non
		EBF		ر,	27.1 61 1.72	of Ope		of Openings	(Hours)	Design or Description	Const	Non Comb. Cladding	Con
	South	Exist	ing	Existing	Existing	Existing	)	Existing	Existing	Existing	Existing	Existing	Exi
	East	Exist	-	Existing	Existing	Existing		Existing	Existing	Existing	Existing	Existing	Exis
	North West	Exist Exist	-	Existing	Existing	Existing		Existing Existing	Existing	Existing Existing	Existing Existing	Existing	Exi
	west	EXIST	ing	Existing	Existing	Existing			Existing	Existing	Existing	Existing	-
Item							rix - Part 1	Building Code L 1 - Renovation				OBC Refe	erenc
44.4	Estate		+	n - " -		C		g Building				10212	
11.1	Classificat	Existing Building Classification:  Describe Existing Use: Triplex — (Gr				roup C)					10.2.1.2. T 11.2.1.1.(A)		
				⊠ N∧t Ar	oplicable (no ch	nange of	major occupa	incv)				T 11.2.1.1.(I)	
11.2	Alteration	to Exis	-		Renovation	.sgo UI						11.3.3.1.	
	Building is	:	- 1 I	<b>⊠</b> Exten	sive Renovation	on						11.3.3.2.	
11.3	Reducitor Performa	n in nce Le	vel:									11.4.2.	
			- 1	Structure	ıl:		☐ Yes	⊠ No	Structu	ıral by other	rs .	11.4.2.1.	
			- 1		ise in Occupa	nt Load:		⊠ No				11.4.2.2.	
				Occupano			☐ Yes	⊠ No				11.4.2.3.	
				Plumbing			⊠ Yes	□ No		nical by othe	ers	11.4.2.4.	
4		-41	+	Sewage-	oystem:		☐ Yes	⊠ No	1			11.4.2.5.	
11.4	Compens Construc	ating tion:										11.4.3.	
				Structure	d:		⊠ No	☐ Ye:	s (Struct	ural by othe	ers)	-	
					se in Occupa	nt	⊠ No		s (Explai	•		-	
				Load: By Chang Occupano	ge of Major		⊠ No		s (Explai	-		-	
	ı		- 1	Plumbing			□ No	⊠ Ye:	s (Design	for plumbin	ng by	-	
			- 1	•				Ме	chanical	Engineer)	- •		
				C	C				s (Explaiı	o 1		I —	
			_	Sewage-	System:		⊠ No	Te:	5 (Expidii	''			
11.5	Complian Alternativ Proposed	/es	_	Sewage-	System:		⊠ NO	Tes	5 (Expidii	''		11.5.1.	



### PERSPECTIVE VIEWS

Perspective Views Inc. 126 Catharine Street N Hamilton, ON L8R 1J4 t 289.389.4502 www.perspectiveviews.com

#### These Drawings are not to be scaled

All drawings, the design, and the details thereon remain the property of the architect and are not to be altered, re-used or reporduced without the designer's express written concent. The contractor, must field verify all dimensions and must confirm & correlate all details within the fill drawing package being responsible for same throughout construction, reporting any discrepancies to the designer prior to commencing the relevant work. All drawings, details & specifications represengted in the drawings are to be used for construction only when issued by the designer and noted accordingly in the "issue/revisions" box hereon.

### TINA LISTER

2 RUTHERFORD AVENUE, HAMILTON

### Revisions

Issued for MV 22/04/13

The undersigned has reviewed and takes responsibility for this design, and has the qualifications and meets the requirements set out in the Ontario Building Code to be a designer.

Qualification Information

Required unless design is exempt under Div. C - 3.2.5 of the Building Co

Project No. PV21-017
Issue Date 15-12-2021
Drawn By JOSEPH FALZONE
Checked By MATTHEW RIBAU

### North



Drawing Title

### SITEPLAN

Scale

Sheet No.

SP1

### **GENERAL NOTES:**

- 1. CONTRACTOR SHALL FIELD VERIFY ALL DIMENSIONS IN FIELD PRIOR CONSTRUCTION. NOTIFY ARCHITECT OF ANY DISCREPANCIES ON DRAWINGS.
- 2. VISIT THE SITE TO VERIFY EXISTING CONDITIONS. EXISTING CONCEALED CONDITIONS AND CONNECTIONS ARE BASED UPON INFORMATION TAKEN FROM LIMITED FIELD INVESTIGATIONS. CONTRACTOR SHALL MAKE REQUIRED ADJUSTMENTS TO SYSTEM COMPONENTS AS NECESSITATED BY ACTUAL FIELD CONDITIONS. REPORT ANY DISCREPANCIES BETWEEN THE DRAWINGS AND ACTUAL FIELD CONDITIONS TO THE ARCHITECT BEFORE CONSTRUCTION RECINS
- 3. CONTRACTOR SHALL KEEP THE JOB FREE OF DEBRIS AND MAKE FINAL CLEANUP TO THE SATISFACTION OF THE OWNER. CONTRACTOR SHALL BE RESPONSIBLE FOR REMOVAL OF ALL CONSTRUCTION DEBRIS FROM PROJECT SITE AND SHALL PROVIDE DUMPSTERS ETC. AS REQUIRED. REMOVE ALL DEBRIS ON A DAILY BASIS.
- 4. CONTRACTOR SHALL BE RESPONSIBLE FOR THE PROTECTION OF ALL EXISTING BUILDINGS AND OTHER INSTALLATIONS THAT ARE TO REMAIN INTACT WHILE PERFORMING THE SPECIFIED
- 5. UNLESS INDICATED OTHERWISE, ALL MATERIAL FURNISHED AND INCORPORATED INTO THE WORK SHALL BE NEW, UNUSED AND OF QUALITY STANDARD TO THE INDUSTRY FOR FIRST CLASS WORK OF SIMILAR NATURE AND CHARACTER. INSTALL ALL MATERIALS TO THE MANUFACTURER'S RECOMMENDATIONS AND BEST STANDARD OF THE TRADES INVOLVED.
- 6. UNLESS OTHERWISE INDICATED ALL INTERIOR FINISHES SHALL BE AS DIRECTED BY THE OWNER.

#### **DEMOLITION NOTES:**

- 1. REMOVE ALL EXISTING CONSTRUCTIONS AND FINISHES NECESSARY FOR THE COMPLETION OF THE WORK AS DEPICTED ON THE DRAWINGS. INCLUDING BUT NOT LIMITED TO, ITEMS SHOWN ON THE PLANS WITH DASHED LINES. NECESSARY DISCONNECTS AND ALTERATIONS TO EXISTING MECHANICAL AND ELECTRICAL SYSTEMS SHALL BE INCLUDED. PATCH AS REQUIRED ALL CONSTRUCTIONS TO REMAIN IN ACCORDANCE WITH THE CONTRACT DRAWINGS. WHERE CONTRACTOR IS DESIGNATED TO MAKE REMOVALS, DISPOSITION OF MATERIALS IS THE RESPONSIBILITY OF THE CONTRACTOR. VERIFY WITH OWNER, THE DISPOSITION AND REMOVAL OF ANY COMPONENTS OF SALVAGEABLE VALUE.
- 2. ALL REMOVALS AND SALVAGE, UNLESS SPECIFICALLY NOTED OR REQUESTED BY THE OWNER SHALL BECOME THE PROPERTY OF THE CONTRACTOR.
- 3. REMOVE ONLY NONLOAD BEARING CONSTRICTION AND PARTITIONS. CONTRACTOR TO VERIFY, PRIOR TO REMOVAL, THAT NO STRUCTURAL COMPONENTS, I.E. BEARING WALLS, BEAMS, HEADERS, ETC.. SUPPORTING FLOOR, ROOF OR CEILING JOISTS ARE DESIGNATED FOR REMOVAL. CONTACT THE ARCHITECT PRIOR TO REMOVAL OF ANY CONSTRUCTION IN QUESTION OR DEVIATING FROM THE DESIGN INTENT. CONTRACTOR'S NONCONTACT OF ARCHITECT PRIOR TO REMOVAL OF ANY WORK INDICATES HIS COMPLETE UNDERSTANDING THAT NO LOAD BEARING OR STRUCTURAL WORK IS BEING ALTERED UNDER THIS CONTRACT. UNLESS OTHERWISE SPECIFIED.
- 4. ALL STRUCTURAL SYSTEMS SHALL BE MAINTAINED AND SHALL BE OF SUFFICIENT STRENGTH TO SUPPORT THE DESIGN LOADS.
- 5. PATCH ALL FINISHES TO MATCH EXISTING, INCLUDING BUT NOT LIMITED TO, GYPSUM BOARD, PLASTER, ACOUSTIC SYSTEMS, WOOD TRIM, COVERS, BASE, PANELS, RAILS AND WAINSCOT. VERIFY MATCH OF NEW FINISH MATERIALS TO EXISTING IN COLOR, TEXTURE, THICKNESS, CUT, ETC... TO SATISFACTION OF OWNER PRIOR TO INSTALLATIONS. PROVIDE OTHER MATERIALS TO MATCH EXISTING WHEN REQUIRED. TO BE APPROVED BY OWNER.
- 6. PATCH EXISTING WALLS GYPSUM DRYWALL OR PLASTER TO MATCH EXISTING OF SUFFICIENT THICKNESS TO MAINTAIN UNIFORM WALL THICKNESS. ALL EXPOSED PORTIONS OF WALL SHALL BE FINISHED WITH NECESSARY COATS OF PLASTER, SANDED AND LEFT IN A PAINT READY CONDITION.
- 7. WHERE APPLICABLE LEVEL ALL EXISTING FLOORS AS REQUIRED TO RECEIVE NEW FLOOR FINISHES. INSTALL REQUIRED TRANSITION PIECES BETWEEN VARIOUS FLOOR FINISHES SUITABLE FOR CONDITIONS AND ACCEPTABLE TO THE OWNER. MATCH EXISTING WHEREVER POSSIBLE

### MECHANICAL & ELECTRICAL NOTES:

- 1. SEE MECHANICAL DRAWINGS (IF APPLICABLE) FOR ADDITIONAL INFORMATION.
- 2. ANY EXISTING ELECTRICAL WHERE A WALL IS TO BE REMOVED NEEDS TO BE REMOVED OR RELOCATED AS PER PROPOSED DESIGN. REFER TO ELECTRICAL PERMIT FOR FURTHER DETAIL. PERMIT TO BE OBTAINED BY LICENSED ELECTRICIAN.
- 3. ELECTRICIAN TO DETERMINE IF EXISTING ELECTRICAL PANEL AND SERVICE IS ADEQUATE FOR PROPOSED DESIGN FOR ALL EQUIPMENT, FIXTURES AND APPLIANCES.

### $\underline{\mathsf{MECHANICAL}\;\mathsf{NOTE}}.$

EXISTING MECHANICAL SYSTEM TO REMAIN. THE INTEGRITY OF THE EXISTING HVAC SYSTEM SHALL NOT BE COMPROMISED BY THE REMOVAL OF EXISTING PARTITIONS. FREE AREA OF RETURN AIR INLETS SHALL BE MAINTAINED. ALL BASEMENT SUPPLY REGISTERS TO BE INSTALLED 16" F.F.F. UNLESS OTHERWISE LABELED. ALL BASEMENT SUPPLY VENTS ARE 5" DIAMETER UNLESS OTHERWISE SPECIFIED.

PROVIDE CLOSED 10"x3.25" DUCT IN ALL 2"x4" STUD WALLS.

- (A/R) MECHANICAL AIR RETURN REGISTER
- (A/S) MECHANICAL AIR SUPPLY REGISTER

### PLUMBING NOTE:

IF THE CONNECTION AT EXTERIOR WALL IS NOT LOW ENOUGH TO ACCOMMODATE THE NEW SANITARY LINES UNDER SLAB, USE SEWAGE PUMP TO CONNECT TO A HIGHER WASTE STACK. REDIRECT EXISTING PLUMBING STACK BELOW FLOOR FRAMING AND ALONG EXTERIOR WALLS CONNECTING TO THE EXISTING SANITARY CONNECTION.

#### SUMP PUMP NOTE.

THE DISCHARGE PIPE FROM EVERY PUMPED STORM SEWAGE SUMP SHALL BE EQUIPPED WITH A UNION, A CHECK VALVE, AND A SHUT-OFF VALVE (IF APPLICABLE) INSTALLED IN THAT SEQUENCE AND PUMPED TO ABOVE GRADE LEVEL OR IN THE DIRECTION OF DISCHARGE.

#### SANITARY PUMP NOTE:

ONLY PIPING THAT IS TOO LOW TO DRAIN INTO A BUILDING SEWER BY GRAVITY SHALL BE DRAINED TO A SUMP OR RECEIVING TANK. SUMP OR TANK THAT RECEIVES SANITARY SEWAGE SHALL BE WATER AIR—TIGHT AND VENTED.

#### LUMBER


- 1. ALL LUMBER SHALL BE SPRUCE NO.2 GRADE, UNLESS NOTED OTHERWISE.
- 2. STUDS SHALL BE STUD GRADE SPRUCE, UNLESS NOTED OTHERWISE.
- 3. LUMBER EXPOSED TO THE EXTERIOR TO BE SPRUCE No. 2 GRADE PRESSURE TREATED OR CEDAR, UNLESS NOTED OTHERWISE.
- 4. ALL LAMINATED VENEER LUMBER (L.V.L.) BEAMS, GIRDER TRUSSES, AND METAL HANGER CONNECTIONS SUPPORTING ROOF FRAMING TO BE DESIGNED & CERTIFIED BY TRUSS MANUFACTURER.
- 5. LVL BEAMS SHALL BE 2.0E WS MICRO-LAM LVL (Fb=2800psi.MIN.) OR EQUIVALENT. NAIL EACH PLY OF LVL WITH 89mm (3 1/2") LONG COMMON WIRE NAILS @ 300mm (12") 0.C. STAGGERED IN 2 ROWS FOR 184,240 & 300mm (7 1/4",9 1/2", 11 7/8") DEPTHS AND STAGGERED IN 3 ROWS FOR GREATER DEPTHS AND FOR 4PLY MEMBERS ADD 13mm (1/2") DIA. GALV. BOLTS BOLTED AT MID-DEPTH OF BEAM @ 915mm (3'-0") 0.C. 6. PROVIDE TOP MOUNT BEAM HANGERS TYPE "SCL" MANUFACTURED BY MGA CONNECTOR LTD. Tel. (905) 642-3175 OR EQUAL FOR ALL LVL BEAM TO BEAM CONNECTIONS UNLESS NOTED OTHERWISE.
- 7. JOIST HANGERS: PROVIDE METAL HANGERS FOR ALL JOISTS AND BUILT-UP WOOD MEMBERS INTERSECTING FLUSH BUILT-UP WOOD MEMBERS.
- 8. WOOD FRAMING NOT TREATED WITH A WOOD PRESERVATIVE, IN CONTACT WITH CONCRETE, SHALL BE SEPARATED FROM THE CONC. BY AT LEAST 2 mil. POLYETHYLENE FILM, No.50 (45lbs.) ROLL ROOFING OR OTHER DAMP PROOFING MATERIAL, EXCEPT WHERE THE WOOD MEMBER IS AT LEAST 150mm (6") CHEMICAL THAT IS TOXIC TO TERMITES.

### STEEL:

- 1. STRUCTURAL STEEL SHALL CONFORM TO CAN/CSA-G40-21 GRADE 300W. HOLLOW STRUCTURAL SECTIONS SHALL CONFORM TO CAN/CSA-G40-21 GRADE 350W CLASS "H". 2. REINFORCING STEEL SHALL CONFORM TO CSA-G30-18M GRADE 400R.
- 3. WELDING SHALL BE UNDERTAKEN ONLY BY A COMPANY APPROVED BY THE CANADIAN WELDING BUREAU TO THE REQUIREMENTS OF C.S.A. STANDARD W.47.1.
  4. TEMPORARY BRACING TO BE USED WHEREVER NECESSARY TO WITHSTAND ALL LOADS
- DURING ERECTION AND SUBSEQUENT CONSTRUCTION.
- 5. ALL STRUCTURAL STEEL BUILDINGS TO CONFORM TO CAN/CSA-S16-09.

### FIRE PROTECTION (9.10.22.):

- 1. A VERTICAL CLEARANCE OF NOT LESS THAN 750mm FROM COOKTOP SHALL BE PROVIDED UNLESS IT IS PROTECTED BY A NON-COMBUSTIBLE HOOD OR FINISH.
- 2. COMBUSTIBLE FINISHES LOCATED WITHIN 450mm HORIZONTALLY, SHALL BE PROTECTED BY A MINIMUM 9.5mm GYPSUM BOARD OR SPLASH BOARD/BACK PLATE.

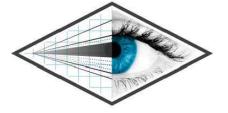

#### PERSPECTIVE VIEWS

Perspective Views Inc.
126 Catharine Street N Hamilton, ON L8R 1J4
t 289.389.4502
www.perspectiveviews.com

#### These Drawings are not to be scaled

All drawings, the design, and the details thereon remain the property of the architect and are not to be altered, re-used or reporduced without the designer's express written concent. The contractor, must field verify all dimensions and must confirm & correlate all details within the fill drawing package being responsible for same throughout construction, reporting any discrepancies to the designer prior to commencing the relevant work. All drawings, details & specifications represengted in the drawings are to be used for construction only when issued by the designer and noted accordingly in the "issue/revisions" box hereon.

TINA LISTER

2 RUTHERFORD AVENUE, HAMILTON

Revisions

Issued for MV

22/04/13

The undersigned has reviewed and takes responsibility for this design, and has the qualifications and meets the requirements set out in the Ontario Building Code to be a designer.

Qualification Information
Required unless design is exempt under Div. C - 3.2.5 of the Building C

Adriano Passariello 115278

Name Signature BCIN

Project No. PV21-017

Issue Date 15-12-2021

Drawn By JOSEPH FALZONE

Checked By MATTHEW RIBAU



Drawing Title

**NOTES** 

Scale

1/4" = 1'-0"

Sheet No.

A00.1

FOUNDATION WALL / FOOTINGS DRAINAGE

100mm (4") DIA. WEEPING TILE 150mm (6") CRUSHED STONE OVER AND AROUND WEEPING TILES.

BASEMENT SLAB

MIN. 75mm (3") CONCRETE BASE SLAB ON R5 RIGID INSUL. 100mm (4") COARSE GRANULAR FILL. REINFORCED W/ 6x6-W2.9xW2.9 MESH PLACED NEAR MID-DEPTH OF SLAB. CONC. STRENGTH 32 MPa.(4640 PSI) WITH 5-8% AIR ENTRAINMENT ON COMPACTED SUB-GRADE.

COLD CELLAR PORCH SLAB

FOR MAX. 2500mm (8'-3") PORCH DEPTH, 130mm (5") 32MPa (4640 PSI) CONC. SLAB WITH 5-8% AIR ENTRAINMENT. REINF. WITH 10M BARS @ 200mm (8") O.C. EACH WAY IN BOTTOM THIRD OF SLAB, 610x610 (24"x24") DOWELS @ 600mm (24") O.C., ANCHORED IN PERIMETER FDTN. WALLS. SLOPE SLAB MIN. 1.0% FROM DOOR. WALLS. SLOPE SLAB MIN. 1.0% FROM DOOR. PROVIDE (L7) LINTELS OVER CELLAR DOOR.

STEP FOOTINGS

MIN. HORIZ. STEP = 600mm (23 5/8"). MAX. VERT. STEP = 600mm (23 5/8") FOR FIRM SOILS.

DIRECT VENT FURNACE TERMINAL

MIN. 900mm (36") FROM A GAS REGULATOR. MIN. 300mm (12") ABOVE FIN. GRADE, FROM ALL OPENINGS, EXHAUST & INTAKE VENTS. HRV INTAKE TO BE A MIN. OF 1830mm (6'-0") FROM ALL EXHAUST TERMINALS. REFER TO GAS UTILIZATION CODE.

SILL PLATE ANCORING

13mm (1/2") DIA. ANCHOR BOLTS 200mm (8") LONG, EMBEDDED MIN. 100mm (4") INTO CONC. @ 2400mm (7'-10") O.C., CAULKING OR 25 (1") MIN MINERAL WOOL BETWEEN PLATE AND TOP OF WALL.

SUBFLOOR, JOIST STRAPPING AND BRIDGING

16mm (5/8") T & G GLUED & SCREWED SUB FLOOR ON WOOD 6mm (1/4") PANEL TYPE UNDERLAY UNDER RESILIENT & PARQUET FLOORING. ALL JOISTS TO BE BRIDGED WITH 38x38 (2"x2") CROSS BRACING OR SOLID BLOCKING @ 2100mm (6'-11") O.C. MAX. ALL JOISTS TO BE STRAPPED WITH 19x64 (1"x3") @ 2100mm (6'-11") O.C. UNLESS A PANEL TYPE CEILING FINISH IS APPLIED.

TWO STOREY VOLUME SPACES

FOR A MAXIMUM 5490mm (18'-0") HEIGHT, PROVIDE 2-38X140 (2-2"X6") SPR.#2 CONTIN. STUDS @ 300MM (12") O.C. FOR BRICK AND 400MM (16") O.C. FOR SIDING C/W 9.6 (3/8") THICK EXT. PLYWOOD SHEATHING. PROVIDE SOLID WOOD BLOCKING BETWEEN WOOD STUDS @ 1220mm (4'-0") O.C. VERTICALLY.

FOR HORIZ. DISTANCES NOT EXCEEDING 2900mm (9'-6"), PROVIDE 38X140 (2"X6") STUDS @ 400 (16") O.C. WITH CONTINUOUS 2-38X140 (2-2"X6") TOP PLATE + 1-38X140 (1-2"X6") BOTTOM PLATE & MINIMUM OF 3-38X184 (3-2"X8") CONT. HEADER AT GRND. CEILING LEVEL TOE-NAILED & GLUED AT TOP, BOTTOM PLATES AND HEADERS.

STUD WALL REINFORCEMENT (O.B.C. 9.5.2.3.)

PROVIDE WOOD BLOCKING REINFORCEMENT TO STUD WALLS FOR GRAB BAR INSTALLATION IN THE BATHROOM, 840–920mm (33"–36") A.F.F. BEHIND TOILET. 850mm (33") A.F.F. ON THE WALL OPPOSITE THE ENTRANCE TO THE BATHTUB OR SHOWER.

GARAGE GAS PROOFING (O.B.C. 9.10.9.16.)

13mm (1/2") GYPSUM BD. ON WALL AND CEILING BETWEEN HOUSE AND GARAGE, R22 IN WALLS, R35 IN CEILING. TAPE AND SEAL & STRUCTURALLY SUPPORT ALL JOINTS, IN ORDER TO BE GAS TIGHT.

GARAGE DOOR GAS PROOFING

DOOR AND FRAME GASPROOFED. DOOR EQUIPPED WITH SELF CLOSING DEVICE AND WEATHERSTRIPPING.

GARAGE STEPS

PRECAST CONCRETE STEP OR WD. STEP WHERENOT EXPOSED TO WEATHER. MAX. RISE 200mm (7-7/8"); MINIMUM TREAD 250mm (9-1/2").

EXPOSED FLOOR TO EXTERIOR

PROVIDE R31 INSULATION, APPROVED VAPOR BARRIER AND CONTINUOUS AIR BARRIER, FINISHED SOFFIT.

RAILINGS AND GUARDS

FINISHED RAILING ON PICKETS SPACED NOT MORE THAN 100mm (4") BETWEEN PICKETS. GUARDS -OBC. 9.8.8. INTERIOR GUARDS: 900mm (2'-11") MIN. EXTERIOR GUARDS: 1070mm (3'-6") MIN.

STAIR HANDRAIL

REQ'D ON ONE SIDE OF STAIR UP TO 3'-6" WIDE, 2 IF WIDER. HANDRAILS TO COMPLY TO 9.8.7. OBC

ALL STAIRS / EXTERIOR STAIRS

REQ'D ON ONE SIDE OF STAIR UP TO 3'-6" WIDE, 2 IF WIDER.

= 860 (2'-10'')

MAX RISE = 200 (7-7/8")FOR CURVED STAIRS = 210 (8-1/4")MIN. AVG. RUN = 150 (6")MIN. RUN MIN. TREAD = 235 (9-1/4")= 200 (8")MAX NOSING = 25 (1") MIN. HEADROOM = 1950 (6'-5")= 900 (2'-11")RAIL @ LANDING RAIL @ STAIR = 800 (2'-8'')

DIRECT VENT GAS FIREPLACE

MIN. STAIR WIDTH

VENT TO BE A MINIMUM 300mm (12") FROM ANY OPENING AND ABOVE FIN. GRADE. REFER TO GAS UTILIZATION CODE.

MECHANICAL EXHAUST FAN

VENTED TO EXTERIOR, TO PROVIDE AT LEAST ONE AIR CHANGE PER HOUR.

ATTIC OR CRAWL SPACE ACCESS HATCH (O.B.C. 9.19.2.1.)

500x700 (22"x28") WITH WEATHERSTRIPPING. R50 RIGID MIN AREA 3.4 sqft INSULATION BACKING. (R12 FOR CRAWL SPACE)

ATTIC VENTILATION (O.B.C. 9.19.1.)

ATTIC VENTILATION 1:300 OF INSULATED CEILING AREA WITH 50% AT EAVES.

CONVENTIONAL ROOF FRAMING

38x140 (2"x6") RAFTERS @ 400mm (16"0.C.), 38x184 (2"x8") RIDGE BOARD. 38x89 (2"x4") COLLAR TIES AT MIDSPANS. CEILING JOISTS TO BE 38x89 (2"x4") @ 400mm (16") 0.C. FOR MAX. 2830mm (9'-3") SPAN & 38x140 (2"x6") @ 400 (16") 0.C. FOR MAX. 4450mm (14'-7") SPAN. RAFTERS FOR BUILT-UP ROOF TO BE 38x89 (2"x4") @ 600mm (24") 0.C. UNLESS OTHERWISE NOTED.

ROOF CONSTRUCTION (TYP. TRUSS ROOF)

NO.210 (10.25kg/m2) ASPHALT SHINGLES, 10mm (3/8") PLYWOOD SHEATHING WITH "H" CLIPS. ENG. TRUSS AS PER MANUF. PLANS. APPROVED EAVES PROTECTION TO EXTEND 900mm (3'-0") FROM EDGE OF ROOF AND MIN. 300mm (12") BEYOND INNER FACE OF EXTERIOR WALL. PREFIN. ALUM. EAVESTROUGH, FASCIA, RWL & VENTED SOFFIT. ATTIC VENTILATION 1:300 OF INSULATED R50 CEILING AREA WITH 50% AT EAVES.

ROOF WITHOUT ATTIC CONSTRUCTION

NO.210 (10.25kg/m2) ASPHALT SHINGLES, 10mm (3/8") PLYWOOD SHEATHING WITH "H" CLIPS. 2x10 ROOF JOISTS @ 400mm (16") O.C. WITH R50 BATT INSL. PROVIDE RURLINS TO MAINTAIN 2 1/2" VENT SPACE FROM U/S OF ROOF DECK TO TOP OF INSL. 6 MIL POLY. V/B AND 1/2" G.W.B. CEILING FINISH. APPROVED EAVES PROTECTION TO EXTEND 900mm (3'-0") FROM EDGE OF ROOF AND MIN. 300mm (12") BEYOND INNER FACE OF EXTERIOR WALL, PREFIN. ALUM. EAVESTROUGH, FASCIA, RWL & VENTED SOFFIT. ATTIC VENTILATION 1:300 OF INSULATED CEILING AREA WITH 50% AT EAVES.

EAVES CONSTRUCTION

ALUM. 'OGEE' STYLE EAVESTROUGH C/W ALUM. CORRUGATED RECTANGULAR DOWN SPOUTS SPACED 20'-0"MIN.-50'-0"MAX. EAVESTROUGH ON 2x6 ALUM. FASCIA BOARD W/ VENTED ALUM. SOFFIT AND INSULATION BAFFLE TO PROVIDE CLEAR VENTILATION FLOW OVER INSULATION SOFFIT.

FLAT ROOF INSULATION (NON-VENTED)

R50 R00F 2Ib CLOSED CELL SPRAY FOAM INSULATION IN R00F JOIST CAVITY, 13mm (1/2") INT. DRYWALL FINISH OR APPROVED EQUAL.

BASEMENT CEILING (1HR FIRE RATED FLOOR ASSEMBLY) (O.B.C. 9.10.9.14(3))

5/8" TYPE 'X' DRYWALL SCREWED TO EXISTING FLOOR JOISTS, ROXUL INSULATION BETWEEN JOIST CAVITY. STC RAITING OF 50.

EGRESS WINDOW OR DOORS FOR BEDROOMS (9.9.10.1.)

SHOULD BE OPENABLE FROM THE INSIDE WITHOUT THE USE OF TOOLS AND PROVIDES AN INDIVIDUAL UNOBSTRUCTED OPEN PORTION HAVING A MINIMUM AREA OF 0.35sqm WITH NO DIMENSION LESS THAN 380mm

WINDOW AS MEANS OF EGRESS (O.B.C. 9.9.2.3.)

CASEMENT WINDOWS NOT LESS THAN 1060mm HIGH, 560mm WIDE, WITH A SILL HEIGHT NOT MORE THAN 900mm ABOVE THE INSIDE FLOOR, ARE PERMITTED TO BE CONSIDERED PART OF A REQUIRED MEANS OF EGRESS TO PROVIDE ACCESS TO FIRE ESCAPES, WHEN FIRE ESCAPES ARE PERMITTED.

MINIMUM CEILING HEIGHT (O.B.C. TABLE 11.5.1.1.C) (C102B)

MINIMUM ROOM HEIGHT SHALL NOT BE LESS THAN 1950mm OVER THE REQUIRED FLOOR AREA AND IN ANY LOCATION THAT WOULD NORMALLY BE USED AS MEANS OF EGRESS, OR MINIMUM ROOM HEIGHT SHALL NOT BE LESS THAN 2030mm OVER AT LEAST 50% OF THE REQUIRED FLOOR AREA, PROVIDED THAT ANY PART OF THE FLOOR HAVING CLEAR HEIGHT OF LESS THAN 1400mm SHALL NOT BE CONSIDERED IN COMPUTING THE REQUIRED FLOOR AREA.

STEEL COLUMN (SEE O.B.C. 9.17.3.4.)

90mm (3-1/2") DIA. SINGLE TUBE NON-ADJUSTABLE STEEL COLUMN. CONFORMING TO CAN/CGSB-7.2M, AND W/ 150x150x9.5 (6"x6"x3/8") STEEL PLATE TOP & BOTTOM.

LAUNDRY (OBC 9.31.4.2.)


PROVIDE HOOK UP FOR A MOBILE LAUNDRY LOCATED CONVENIENTLY ACCESSIBLE TO THE DWELLING UNIT OCCUPANTS.

DRAIN WATER HEAT RECOVERY (OBC SB-12, 3.1.1.12.)

PROVIDE A DRAIN WATER HEAT RECOVERY UNIT TO RECEIVE DRAIN WATER FROM ALL NEW SHOWERS FROM THE DWELLING UNIT, TO BE INSTALLED AS PER MANUFACTURER'S SPEC'S, CONTRACTOR TO PROVIDE THE MANUFACTURER'S SPECS TO THE BUILDING INSPECTOR.

SMOKE ALARM & CARBON MONOXIDE DETECTOR (O.B.C. 9.10.19.1.(2))

PROVIDE 1 PER FLOOR, NEAR THE STAIRS CONNECTING LEVELS, AND IN ALL BEDROOMS. ALARMS TO BE CONNECTED TO AN ELECTRICAL CIRCUIT AND INTERCONNECTED TO ACTIVATE ALL ALARMS IF ONE SOUNDS.

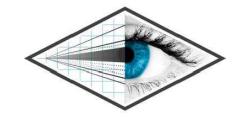

#### PERSPECTIVE VIEWS

Perspective Views Inc.
126 Catharine Street N Hamilton, ON L8R 1J4
t 289.389.4502
www.perspectiveviews.com

These Drawings are not to be scaled

All drawings, the design, and the details thereon remain the property of the architect and are not to be altered, re-used or reporduced without the designer's express written concent. The contractor, must field verify all dimensions and must confirm & correlate all details within the fill drawing package being responsible for same throughout construction, reporting any discrepancies to the designer prior to commencing the relevant work. All drawings are to be used for construction only when issued by the designer and noted accordingly in the "issue/revisions" box hereon.

### TINA LISTER

2 RUTHERFORD AVENUE, HAMILTON

Revisions

Issued for MV 22/04/13

The undersigned has reviewed and takes responsibility for this design, and has the qualifications and meets the requirements set out in the Ontario Building Code to be a designer.

Required unless design is exempt under Div. C - 3.2.5 of the Building Code

Adriano Passariello 115278

Name Signature BCIN

Project No. PV21-017

Issue Date 15-12-2021

Drawn By JOSEPH FALZONE

Checked By MATTHEW RIBAU

North



Drawing Title

**NOTES** 

Scale


Sheet No.

1/4" = 1'-0"

 $\Delta \cap \cap \mathcal{O}$ 


#### WALL SCHEDULE



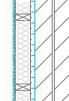


13mm (1/2") INTERIOR DRYWALL, 38x86 (2"x4") STUDS @ 400mm (16") O.C. SINGLE BOTTOM PLATE, DOUBLE TOP PLATE, R24 BATT INSULATION BETWEEN VOIDS, 26mm (1") RIDGED INSULATION, AND APPROVED VAPOR BARRIER. EXISTING WALL DOUBLE MASONRY BEYOND.



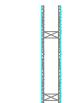

### INTERIOR STUD PARTITIONS

BEARING PARTITIONS 38x89 (2"x4") @ 400mm (16") 0.C. FOR 2 STOREYS AND 300mm (12") O.C. FOR 3 STOREYS. NON-BEARING PARTITIONS 38x89 (2"x4") @ 600mm (24") O.C., PROVIDE 38x89 (2"x4") BOTTOM PLATE AND 2/38x89 (2-2"x4") TOP PLATE. 13mm (1/2") INTERIOR DRYWALL BOTH SIDES OF STUD, PROVIDE 38x140 (2"x6") @ 406mm (16") O.C. STUDS/PLATES WHERE NOTED.

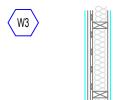


### SB-3 (WALL No. W4a) 1 HR FIRE RATED / STC: 51

2"x4" WOOD STUDS @16" O/C. 4" ABSORPTIVE MATERIAL. RESILIENT METAL CHANNELS ON ONE SIDE @16" OR 24" O/C. 2 LAYERS OF 1/8" TYPE-X GYPSUM BOARD ON RESILIENT CHANNEL SIDE.

1 LAYER OF 1/8" TYPE-X GYPSUM BOARD ON OTHER SIDE.

### FLOOR SCHEDULE

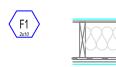

#### SB-3 (FLOOR No. F9g) 1 HR FIRE RATED / STC: 50

5/8" NOMINAL PLYWOOD SUBFLOOR 2"x10" WOOD JOIST @16" O/C. MIN 3" ABSORPTIVE MATERIAL IN CAVITY 1 LAYER OF RESILIENT CHANNEL 406mm O/C. 2 LAYER OF 5/8" TYPE 'X' GYPSUM BOARD ON UNDERSIDE.





### SB-3 (FLOOR No. F9g) 1 HR FIRE RATED / STC: 50


5/8" NOMINAL PLYWOOD SUBFLOOR 2"x8" WOOD JOIST @16" O/C. MIN 3" ABSORPTIVE MATERIAL IN CAVITY 1 LAYER OF RESILIENT CHANNEL 406mm O/C. 2 LAYER OF 5/8" TYPE 'X' GYPSUM BOARD ON UNDERSIDE.

		C	OOOR SCHEDULE			
NO.	SIZE	HINGE	REMARK			
BASEN	MENT FLOOR DOORS		•			
D01	80" x 28"	L	EXT. INTERIOR			
D02	80" x 26"	L	EXT. INTERIOR			
D03	80" x 30"	R	EXT. INTERIOR			
D04	80" x 32"	L	EXT. INTERIOR			
D31	80" x 32"	R	EXT. EXTERIOR			
D32	80" x 30"	L	EXT. EXTERIOR			
MAIN	FLOOR DOORS					
D05	96" x 38"	L	EXT. EXTERIOR			
ΛΑΙΝ	FLOOR UNIT 101 DOORS					
D06	80" x 32"	L	NEW FRONT ENTERANCE, FIRE RATED			
D07	80" X 48"	SLIDING	NEW CLOSET DOOR			
D08	80" x 24"	L	NEW BATHROOM DOOR			
D09	80"x 32"	R	NEW BED ROOM DOOR			
D10	80"x 32"	L	EXT. EXTERIOR			
MIAN	FLOOR UNIT 102 DOORS					
D11	80" x 32"	R	NEW FRONT ENTERANCE, FIRE RATED			
D12	80" X 53"	SLIDING	NEW CLOSET DOOR			
D13	80" x 24"	L	NEW BATHROOM DOOR			
D14	80" x 32"	R	NEW BED ROOM DOOR			
ECON	ID FLOOR UNIT 201 DOORS					
15	80" x 32"	L	NEW FRONT ENTERANCE, FIRE RATED			
016	80" X 48"	SLIDING	NEFW CLOSET DOOR			
17	80" x 24"	L	NEW BATHROOM DOOR			
18	80"x 32"	R	NEW BED ROOM DOOR			
19	80" X 48"	SLIDING	NEW CLOSET DOOR			
ECON	ID FLOOR UNIT 202 DOORS		•			
20	80" x 32"	R	NEW FRONT ENTERANCE, FIRE RATED			
21	80" x 24"	L	NEW BATHROOM DOOR			
22	80"x 32"	R	NEW BED ROOM DOOR			
23	80" X 30"	R	NEW DOOR TO CLOSET			
TTIC	FLOOR UNIT 301 DOORS					
)25	80" x 30"	R	NEW FRONT ENTERANCE, FIRE RATED			
26	80" x 30"	L	NEW DOOR TO CLOSET			
)27	80" x 30"	R	NEW DOOR TO LAUNDRY			
28	80" x 30"	R	NEW BED ROOM DOOR			
29	80" x 30"	R	NEW BATHROOM DOOR			
LL EX	ISTING WINDOWS TO REMA	N. PLAN PRO	VIDED FOR REFERENCE ONLY			

NOTE: CONTRACTOR TO CONFIRM WITH OWNER ANY EXISTING DOORS TO BE REPLACED WITH NEW, CONTRACTOR TO PROVIDE SAMPLE DOOR STYLES AND HARDWARE TO BE APPROVED BY OWNER PRIOR TO PLACING ANY ORDERS.

		WIND	OW SCHEDULE	
NO.	SIZE	SILL HEIGHT	FIXED/OPERABLE	REMARKS
BASEMEN	T WINDOWS			
W01	1'-9.5" x 3'-0"	4'-6"	SLIDER	EXISTING
W02	1'-9.5" x 3'-0"	4'-6"	SLIDER	EXISTING
W03	1'-9.5" x 6'-1"	4'-6"	SLIDER	EXISTING
W04	1'-9.5" x 2'-8"	4'-6"	SLIDER	EXISTING
W05	1'-9.5" x 2'-8"	4'-6"	SLIDER	EXISTING
MAIN FLO	OOR COMMON AREA W	/INDOWS		
W06	2'-5" x 1'-5"	4'-9"	FIXED	EXISTING
W07	2'-5" x 1'-5"	4'-9"	FIXED	EXISTING
MAIN FLO	OOR UNIT 101 WINDOW	VS		
W08	5'-6" x 1'-5"	2'-3"	OPERABLE	EXISTING
W09	1'-8" x 1'-5"	6'-3"	OPERABLE	EXISTING
W10	1'-8" x 1'-5"	6'-3"	OPERABLE	EXISTING
W11	4'-5" x 1'-5"	4'-5"	OPERABLE	EXISTING
W12	5'-4" x 1'-5"	2'-3"	OPERABLE	EXISTING
W13	3'-1" x 1'-5"	3'-11"	OPERABLE	EXISTING
MAIN FLO	OOR UNIT 102 WINDOW	VS		
W14	5'-6" x 1'-5"	2'-3"	OPERABLE	EXISTING
W15	4'-11" x 3'-2"	2'-3"	OPERABLE	EXISTING
W16	4'-11" x 3'-2"	2'-3"	OPERABLE	EXISTING
W17	4'-9" x 1'-5"	2'-3"	OPERABLE	EXISTING EGRESS
SECOND F	LOOR COMMON AREA	WINDOWS		
W18	4'-9" x 7'-9"	2'-3"	OPERABLE	EXISTING
SECOND F	LOOR UNIT 201 WINDO	ows		•
W19	4'-11" x 4'-2"	2'-3"	OPERABLE	EXISTING
W20	4'-10" x 2'-3"	2'-3"	OPERABLE	EXISTING
W21	4'-10" x 4'-10"	2'-3"	OPERABLE	EXISTING
W22	4'-10" x 2'-3"	2'-3"	OPERABLE	EXISTING EGRESS
W23	1'-10" x 2'-0"	4'-1"	OPERABLE	EXISTING
W24	4'-9" x 2'-2"	2'-3"	OPERABLE	EXISTING
SECOND F	LOOR UNIT 202 WINDO	ows		•
W25	4'-11" x 4'-2"	2'-3"	OPERABLE	EXISTING
W26	2'-9" x 8'-3"	3'-5"	OPERABLE	EXISTING
W27	4'-9" x 2'-2"	2'-3"	OPERABLE	EXISTING
W34	4'-10" x 2'-3"	2'-3"	OPERABLE	EXISTING EGRESS
	OR COMMON AREA W	/INDOWS		•
W28	2'-2" x 1'-5"	2'-10"	FIXED	EXISTING
	OR UNIT 301 WINDOW	/S	1.00 (00) (00) (00)	
W29	1'-9" x 1'-5"	2'-9"	OPERABLE	EXISTING
W30	1'-9" x 1'-5"	2'-9"	OPERABLE	EXISTING
W31	3'-6" x 1'-5"	1'-10"	OPERABLE	EXISTING
W32	3'-1" x 1'-5"	4'-5"	OPERABLE	EXISTING
		-	FIXED	NEW SKYLIGHT
W33	2-6 X 3-4			
W33 W35	2'-6" x 3'-4" 4'-10" x 2'-3"	2'-3"	OPERABLE	EXISTING EGRESS

NOTE: CONTRACTOR TO CONFIRM WITH OWNER ANY EXISTING WINDOWS TO BE REPALCED WITH NEW, CONTRACTOR TO PROVIDE SAMPLE WINDOW STYLES AND COLOR TO BE APPROVED BY OWNER PRIOR TO PLACING

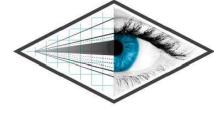

### PERSPECTIVE VIEWS

Perspective Views Inc. 126 Catharine Street N Hamilton, ON L8R 1J4 t 289.389.4502 www.perspectiveviews.com

#### These Drawings are not to be scaled

property of the architect and are not to be altered, re-used or reporduced without the designer's express written concent. The contractor, must field verify all dimensions and must confirm & correlate all details within the fill drawing package being responsible for same throughout construction, reporting any discrepancies to the designer prior to commencing the relevant work. All drawings, details & specifications represengted in the drawings are to be used for construction only when issued by the designer and noted accordingly in the "issue/revisions" box hereon.

### TINA LISTER

### 2 RUTHERFORD AVENUE, HAMILTON

22/04/13 Issued for MV

The undersigned has reviewed and takes responsibility for this design, and has the qualifications and meets the requirements set out in the Ontario Building Code to be a designer.

 Adriano Passariello
 115278

 Name
 Signature
 BCIN


PV21-017 Project No. 15-12-2021 Issue Date Drawn By JOSEPH FALZONE MATTHEW RIBAU Checked By






Drawing Title

### SCHEDULES

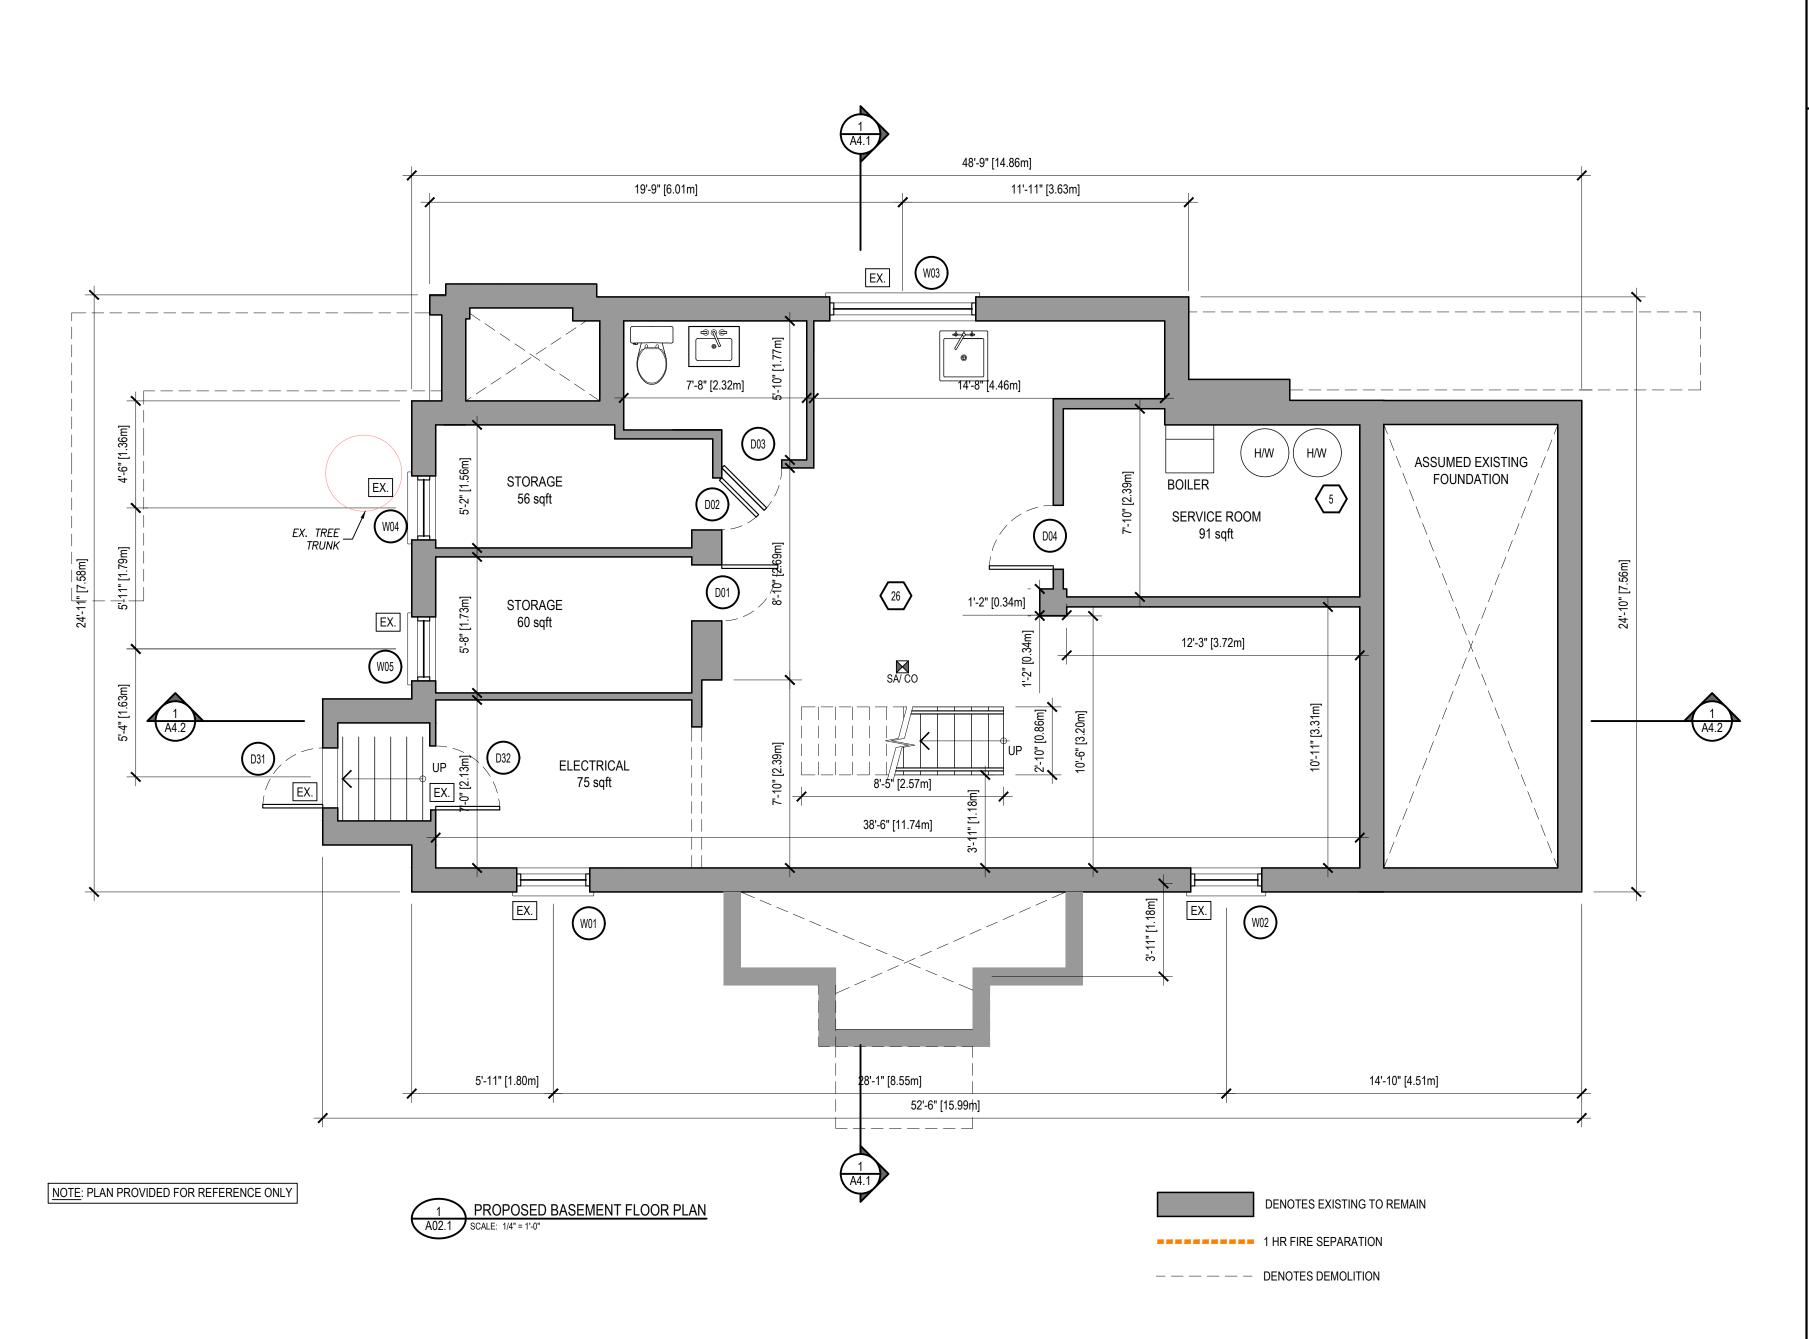

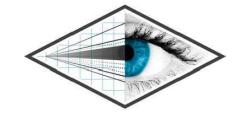

Perspective Views Inc. 126 Catharine Street N Hamilton, ON L8R 1J4 t 289.389.4502 www.perspectiveviews.com

### These Drawings are not to be scaled

All drawings, the design, and the details thereon remain the property of the architect and are not to be altered, re-used or reporduced without the designer's express written concent. The contractor, must field verify all dimensions and must confirm & correlate all details within the fill drawing package being responsible for same throughout construction, reporting any discrepancies to the designer prior to commencing the relevant work. All drawings, details & specifications represengted in the drawings are to be used for construction only when issued by the designer and noted accordingly in the "issue/revisions" box hereon.

### TINA LISTER

2 RUTHERFORD AVENUE, HAMILTON

Revisions

Issued for MV 22/04/13

The undersigned has reviewed and takes responsibility for this design, and has the qualifications and meets the requirements set out in the Ontario Building Code to be a designer.

Adriano Passariello 115278

Name Signature BCIN

Project No. PV21-017

Issue Date 15-12-2021

Drawn By JOSEPH FALZONE

Checked By MATTHEW RIBAU

North




Drawing Title


## EXISTING BASEMENT

Scale 1/4" = 1'-0"

Sheet N

1

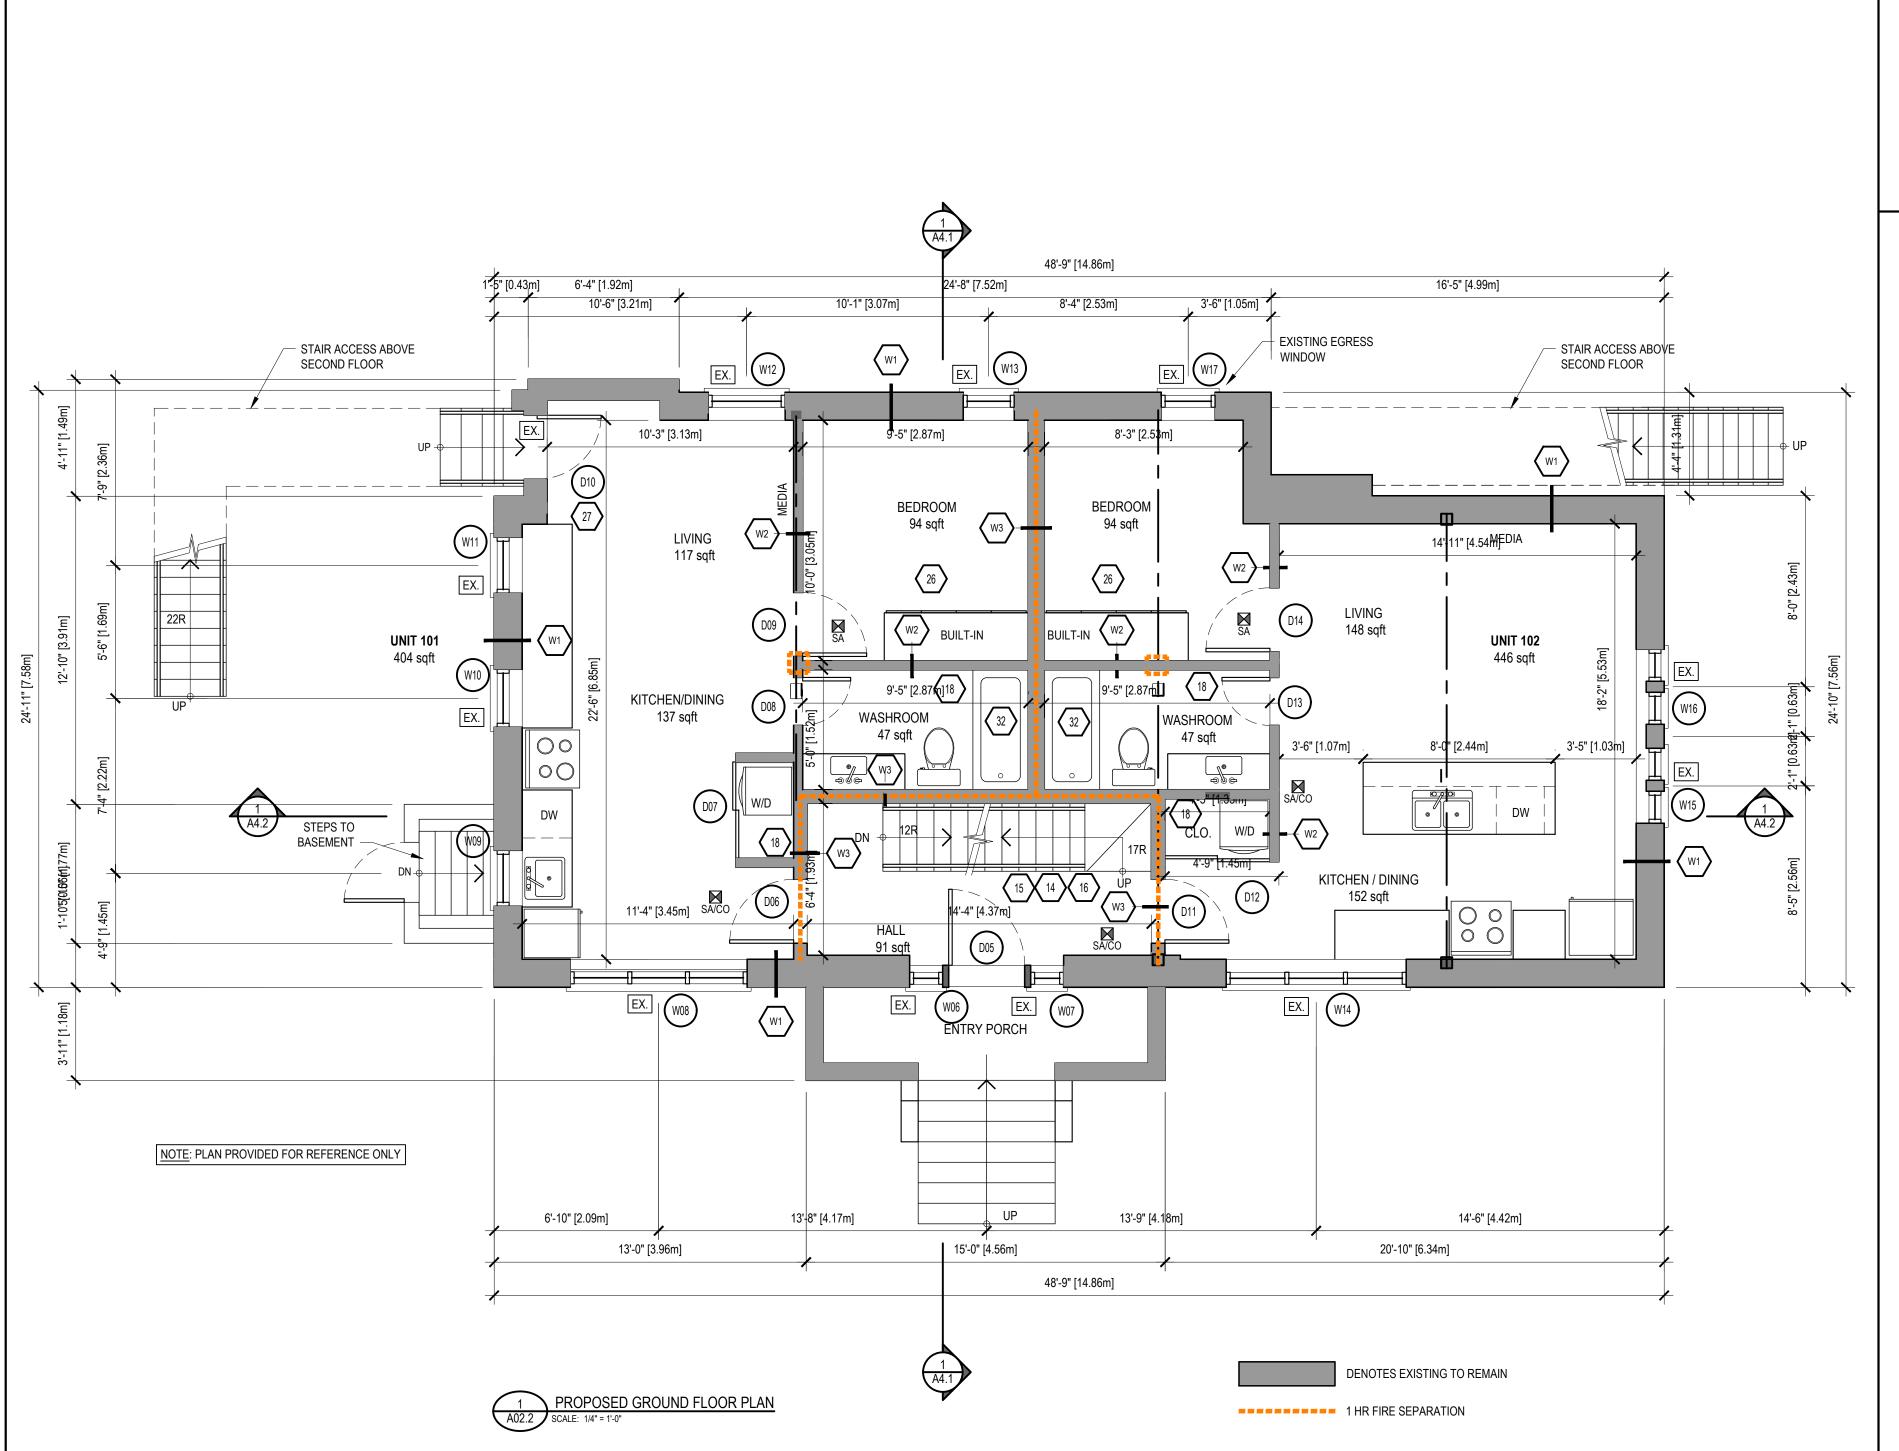

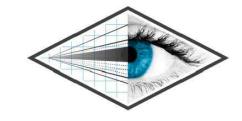

Perspective Views Inc. 126 Catharine Street N Hamilton, ON L8R 1J4 t 289.389.4502 www.perspectiveviews.com

### These Drawings are not to be scaled

All drawings, the design, and the details thereon remain the property of the architect and are not to be altered, re-used or reporduced without the designer's express written concent. The contractor, must field verify all dimensions and must confirm & correlate all details within the fill drawing package being responsible for same throughout construction, reporting any discrepancies to the designer prior to commencing the relevant work. All drawings, details & specifications represengted in the drawings are to be used for construction only when issued by the designer and noted accordingly in the "issue/revisions" box hereon.

### TINA LISTER

2 RUTHERFORD AVENUE, HAMILTON

Revisions

Issued for MV 22/04/13

The undersigned has reviewed and takes responsibility for this design, and has the qualifications and meets the requirements set out in the Ontario Building Code to be a designer.

Qualification Information
Required unless design is exempt under Div. C - 3.2.5 of the Building Coc
Adriano Passariello

Name
Signature
BCIN

Project No. PV21-017

Issue Date 15-12-2021

Drawn By JOSEPH FALZONE

Checked By MATTHEW RIBAU

North




Drawing Title


# EXISTING GROUND FLOOR

Scale 1/4" = 1'-0"

Sheet

A01.2

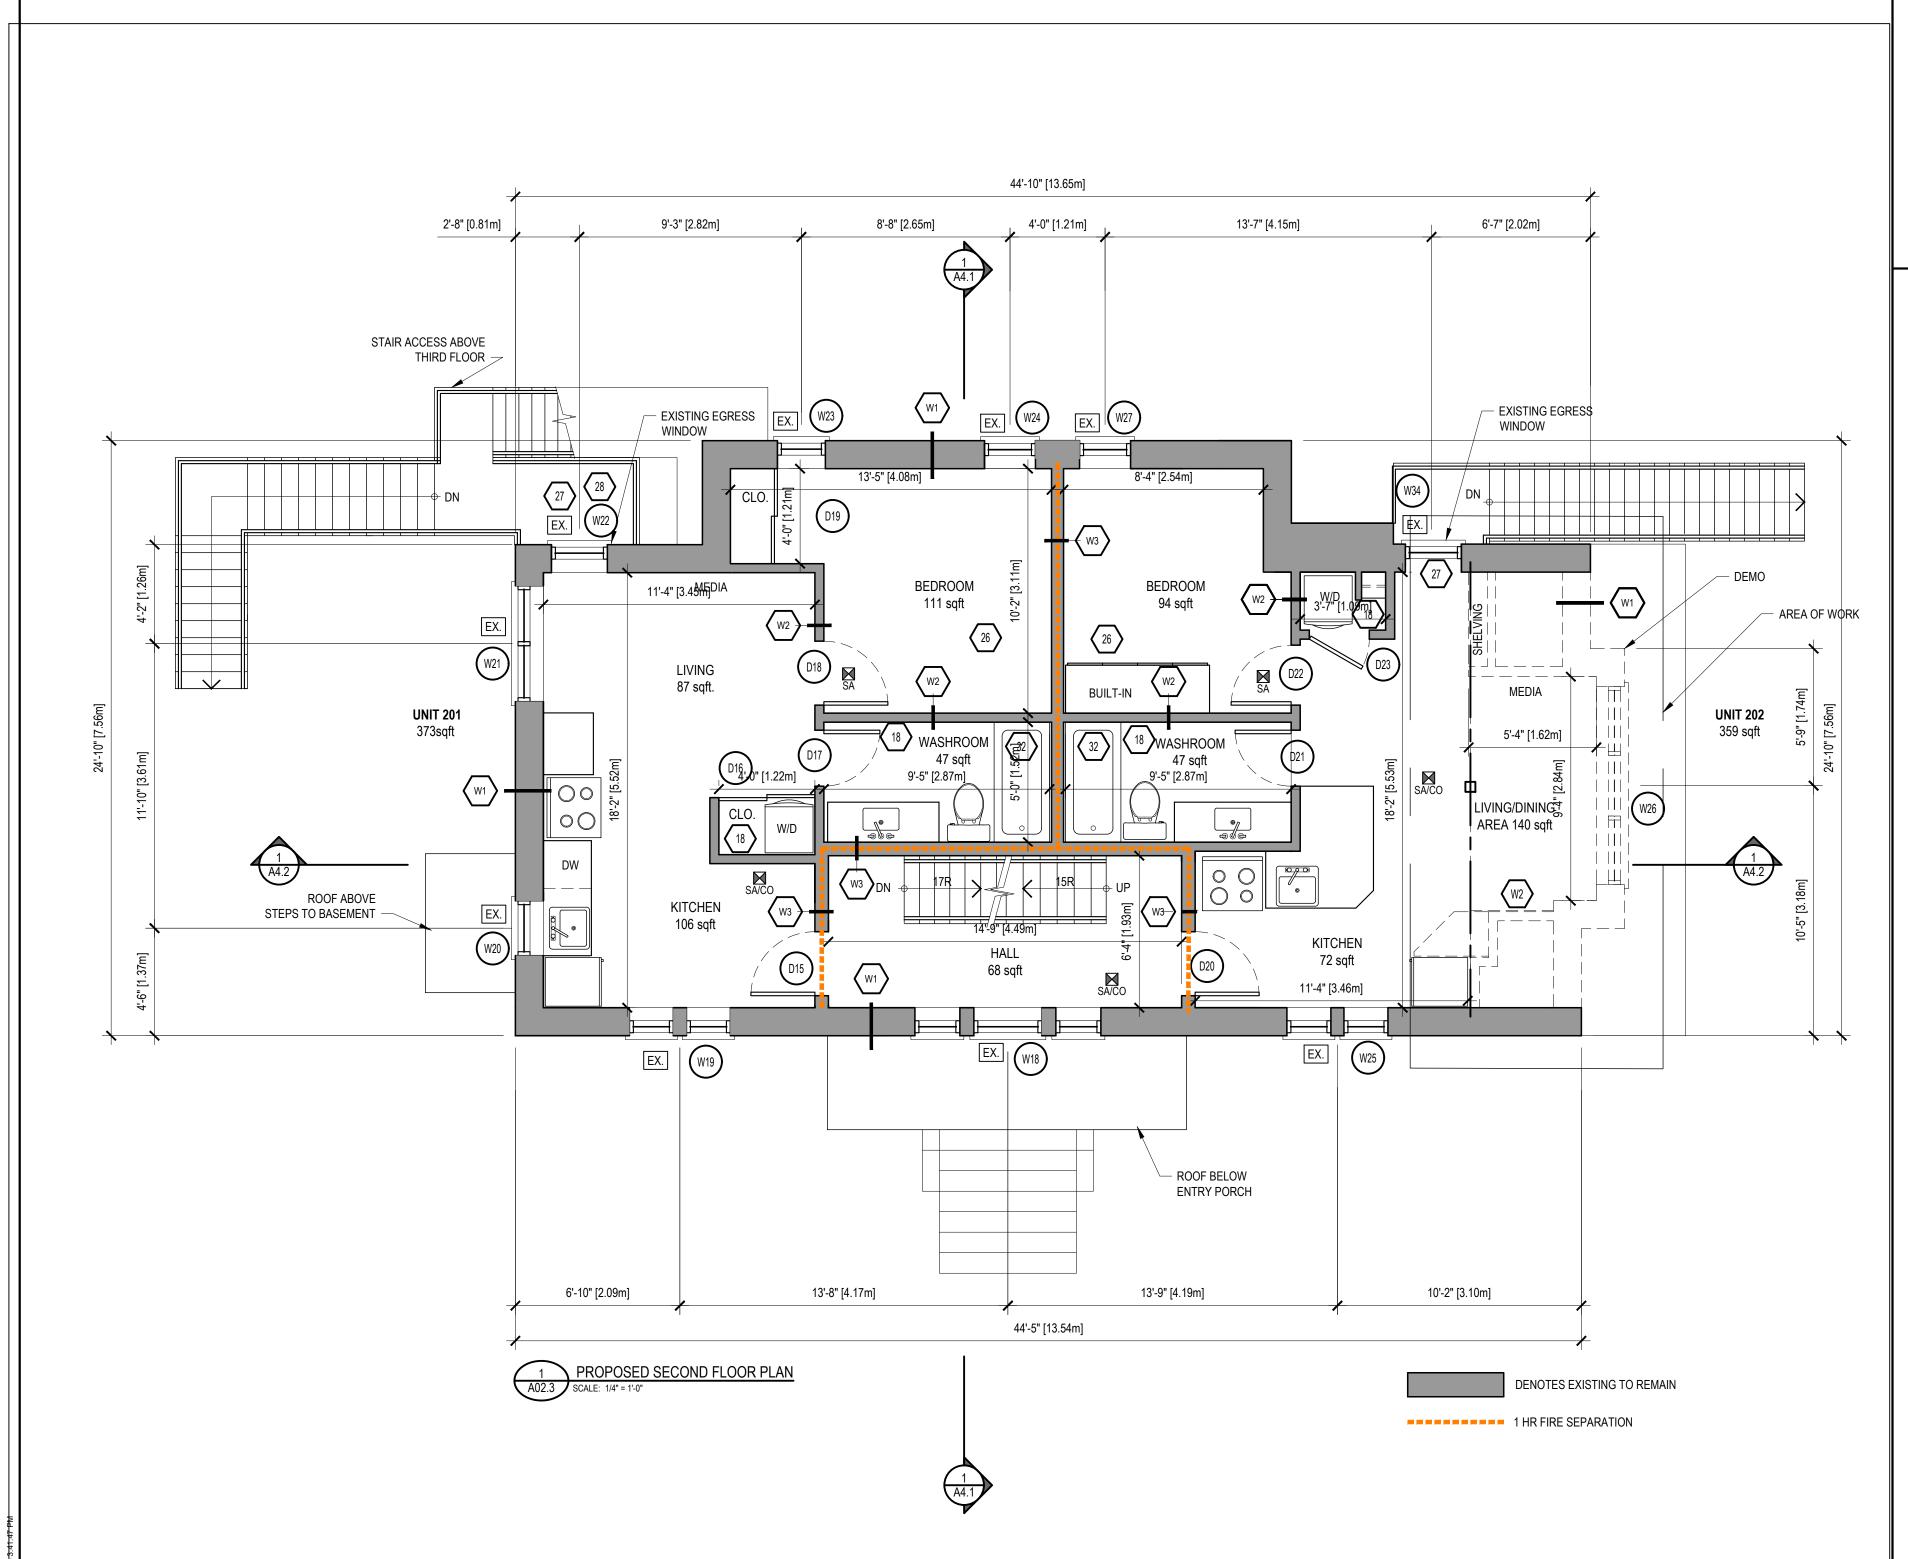

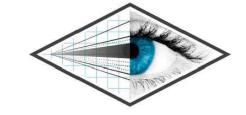

Perspective Views Inc. 126 Catharine Street N Hamilton, ON L8R 1J4 t 289.389.4502 www.perspectiveviews.com

### These Drawings are not to be scaled

All drawings, the design, and the details thereon remain the property of the architect and are not to be altered, re-used or reporduced without the designer's express written concent. The contractor, must field verify all dimensions and must confirm & correlate all details within the fill drawing package being responsible for same throughout construction, reporting any discrepancies to the designer prior to commencing the relevant work. All drawings, details & specifications represengted in the drawings are to be used for construction only when issued by the designer and noted accordingly in the "issue/revisions" box hereon.

### TINA LISTER

2 RUTHERFORD AVENUE, HAMILTON

Revisions

Issued for MV 22/04/13

The undersigned has reviewed and takes responsibility for this design, and has the qualifications and meets the requirements set out in the Ontario Building Code to be a designer.

Required unless design is exempt under Div. C - 3.2.5 of the Building Coc

Adriano Passariello

115278

Project No. PV21-017
Issue Date 15-12-2021
Drawn By JOSEPH FALZONE
Checked By MATTHEW RIBAU

North




Drawing Title


EXISTING & DEMO SECOND FLOOR

01 -- ( N

1/4" = 1'-0"

A01.3

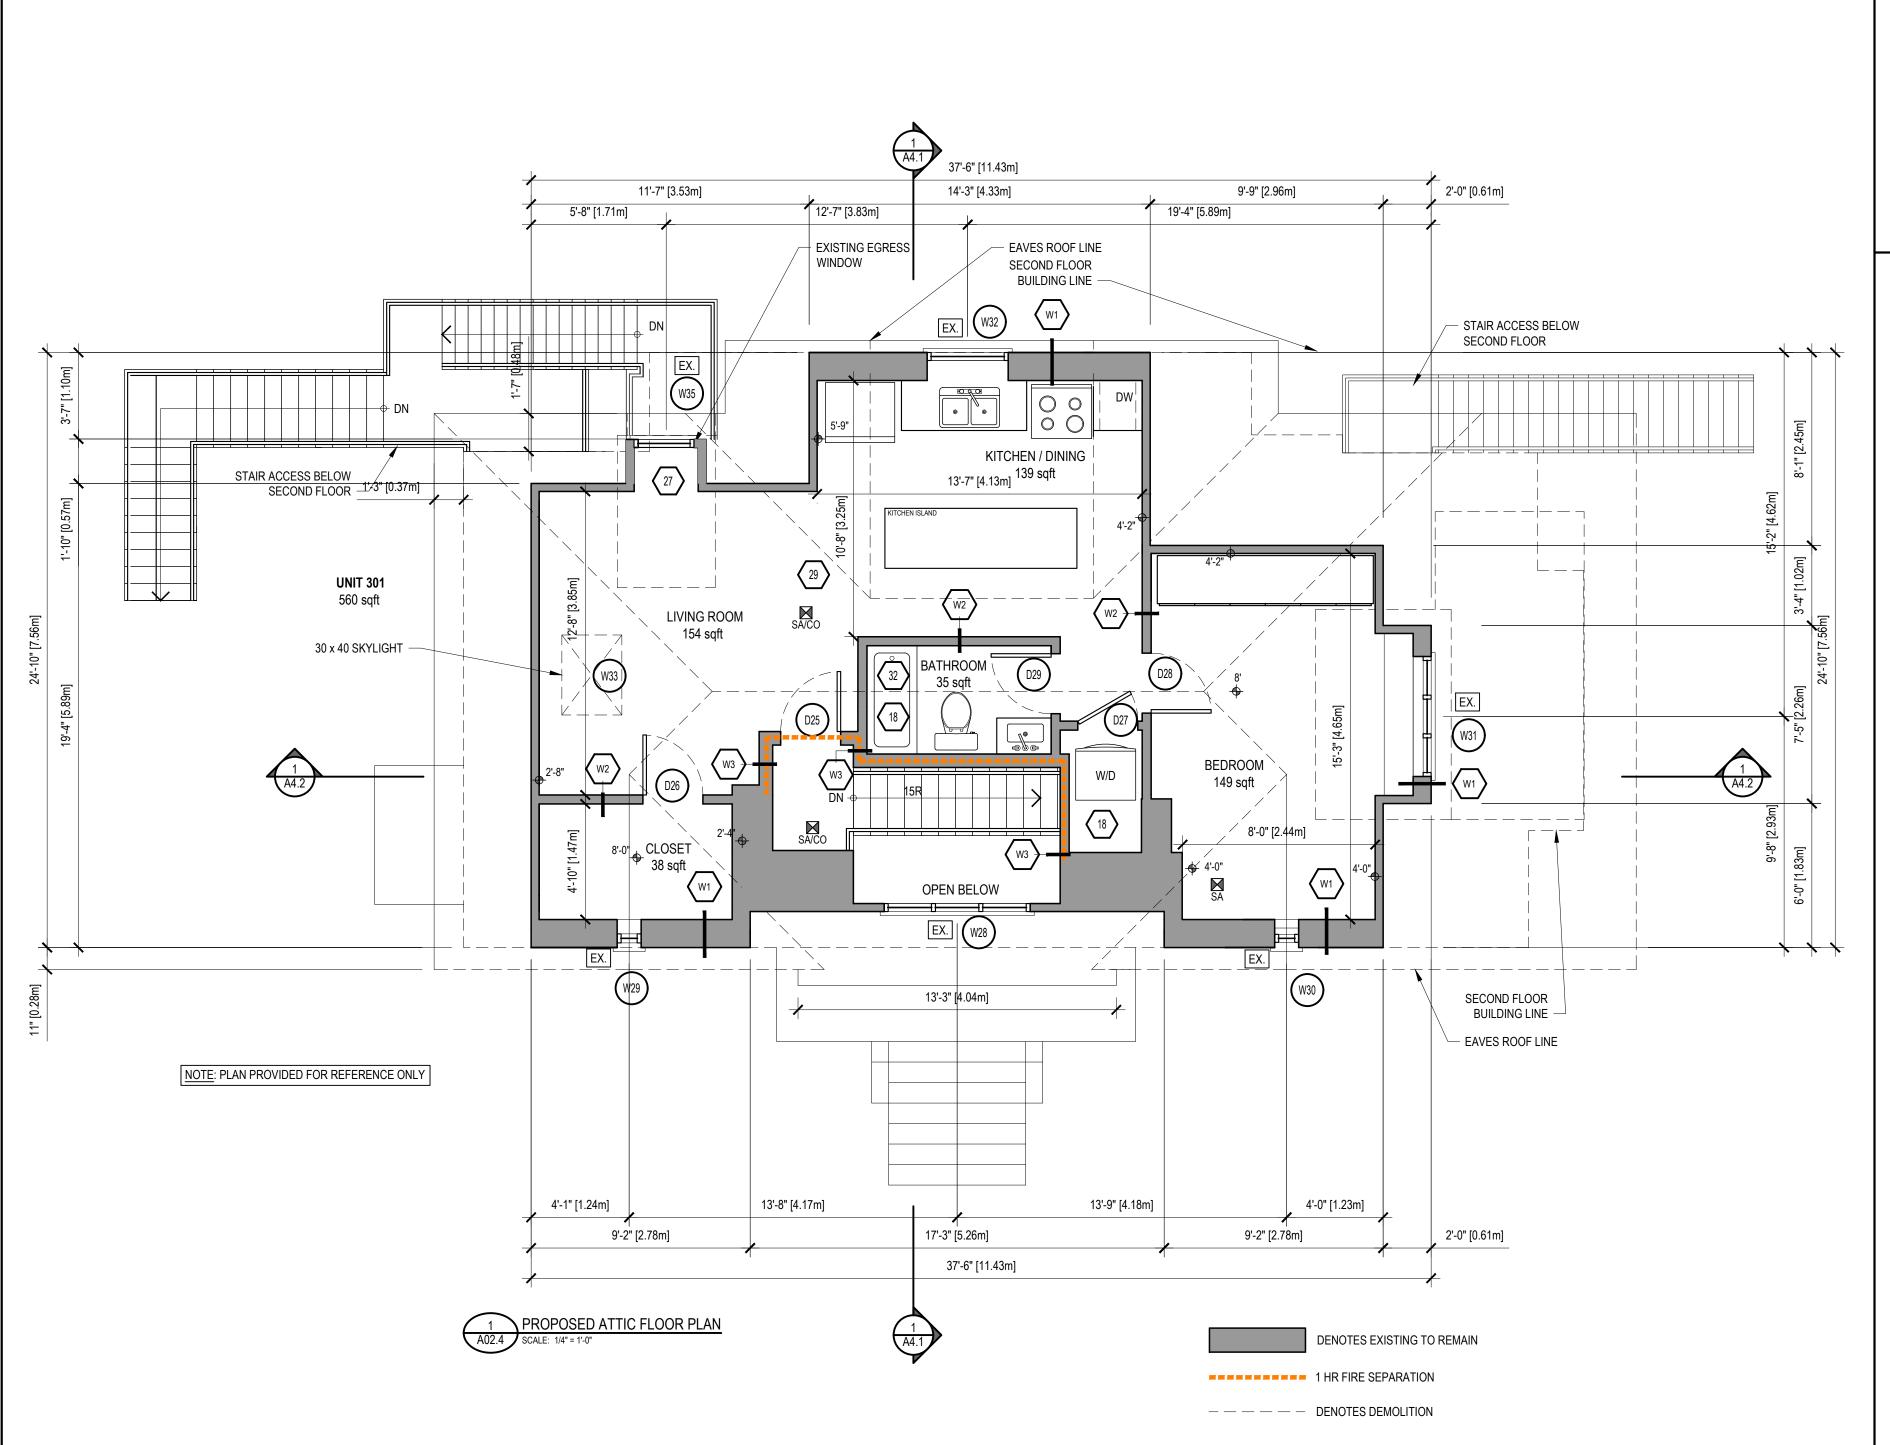

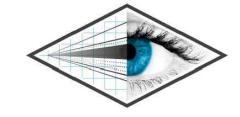

Perspective Views Inc. 126 Catharine Street N Hamilton, ON L8R 1J4 t 289.389.4502 www.perspectiveviews.com

#### These Drawings are not to be scaled

All drawings, the design, and the details thereon remain the property of the architect and are not to be altered, re-used or reporduced without the designer's express written concent. The contractor, must field verify all dimensions and must confirm & correlate all details within the fill drawing package being responsible for same throughout construction, reporting any discrepancies to the designer prior to commencing the relevant work. All drawings, details & specifications represengted in the drawings are to be used for construction only when issued by the designer and noted accordingly in the "issue/revisions" box hereon.

### TINA LISTER

2 RUTHERFORD AVENUE, HAMILTON

Revisio

Issued for MV 22/04/13

The undersigned has reviewed and takes responsibility for this design, and has the qualifications and meets the requirements set out in the Ontario Building Code to be a designer.

Qualification Information

Adriano Passariello 115278
Name Signature BCIN

Project No. PV21-017

Issue Date 15-12-2021

Drawn By JOSEPH FALZONE

Checked By MATTHEW RIBAU

North



Drawing Title


## EXISTING ATTIC


Scale 1/4" = 1'-0"

Sheet N

0.

A01.4

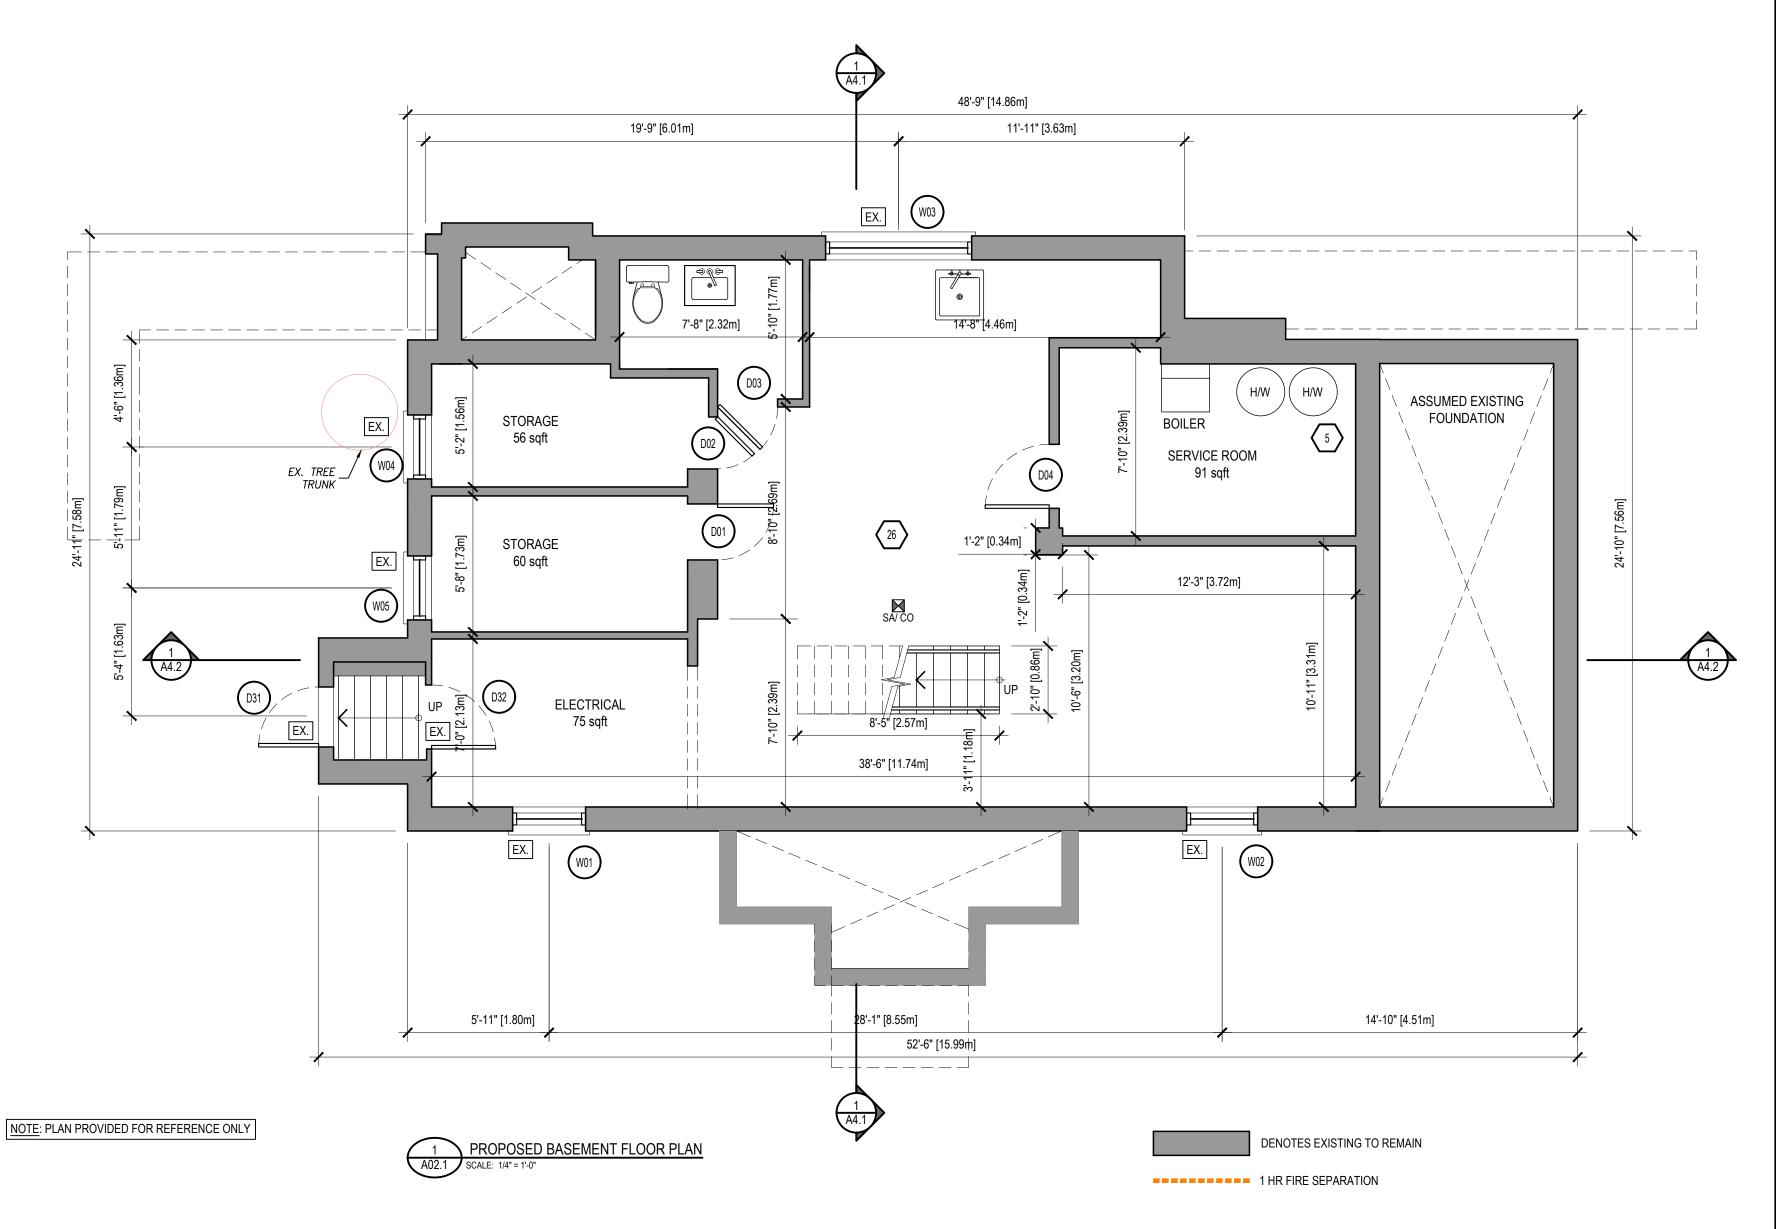

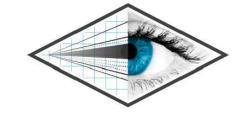

Perspective Views Inc. 126 Catharine Street N Hamilton, ON L8R 1J4 t 289.389.4502 www.perspectiveviews.com

### These Drawings are not to be scaled

All drawings, the design, and the details thereon remain the property of the architect and are not to be altered, re-used or reporduced without the designer's express written concent. The contractor, must field verify all dimensions and must confirm & correlate all details within the fill drawing package being responsible for same throughout construction, reporting any discrepancies to the designer prior to commencing the relevant work. All drawings, details & specifications represengted in the drawings are to be used for construction only when issued by the designer and noted accordingly in the "issue/revisions" box hereon.

### TINA LISTER

2 RUTHERFORD AVENUE, HAMILTON

Revision

Issued for MV 22/04/13

The undersigned has reviewed and takes responsibility for this design, and has the qualifications and meets the requirements set out in the Ontario Building Code to be a designer.

Project No. PV21-017

Issue Date 15-12-2021

Drawn By JOSEPH FALZONE

Checked By MATTHEW RIBAU

North




Drawing Title


## PROPOSED BASEMENT

Scale 1/4" = 1'-0"

Sheet No

A02.1

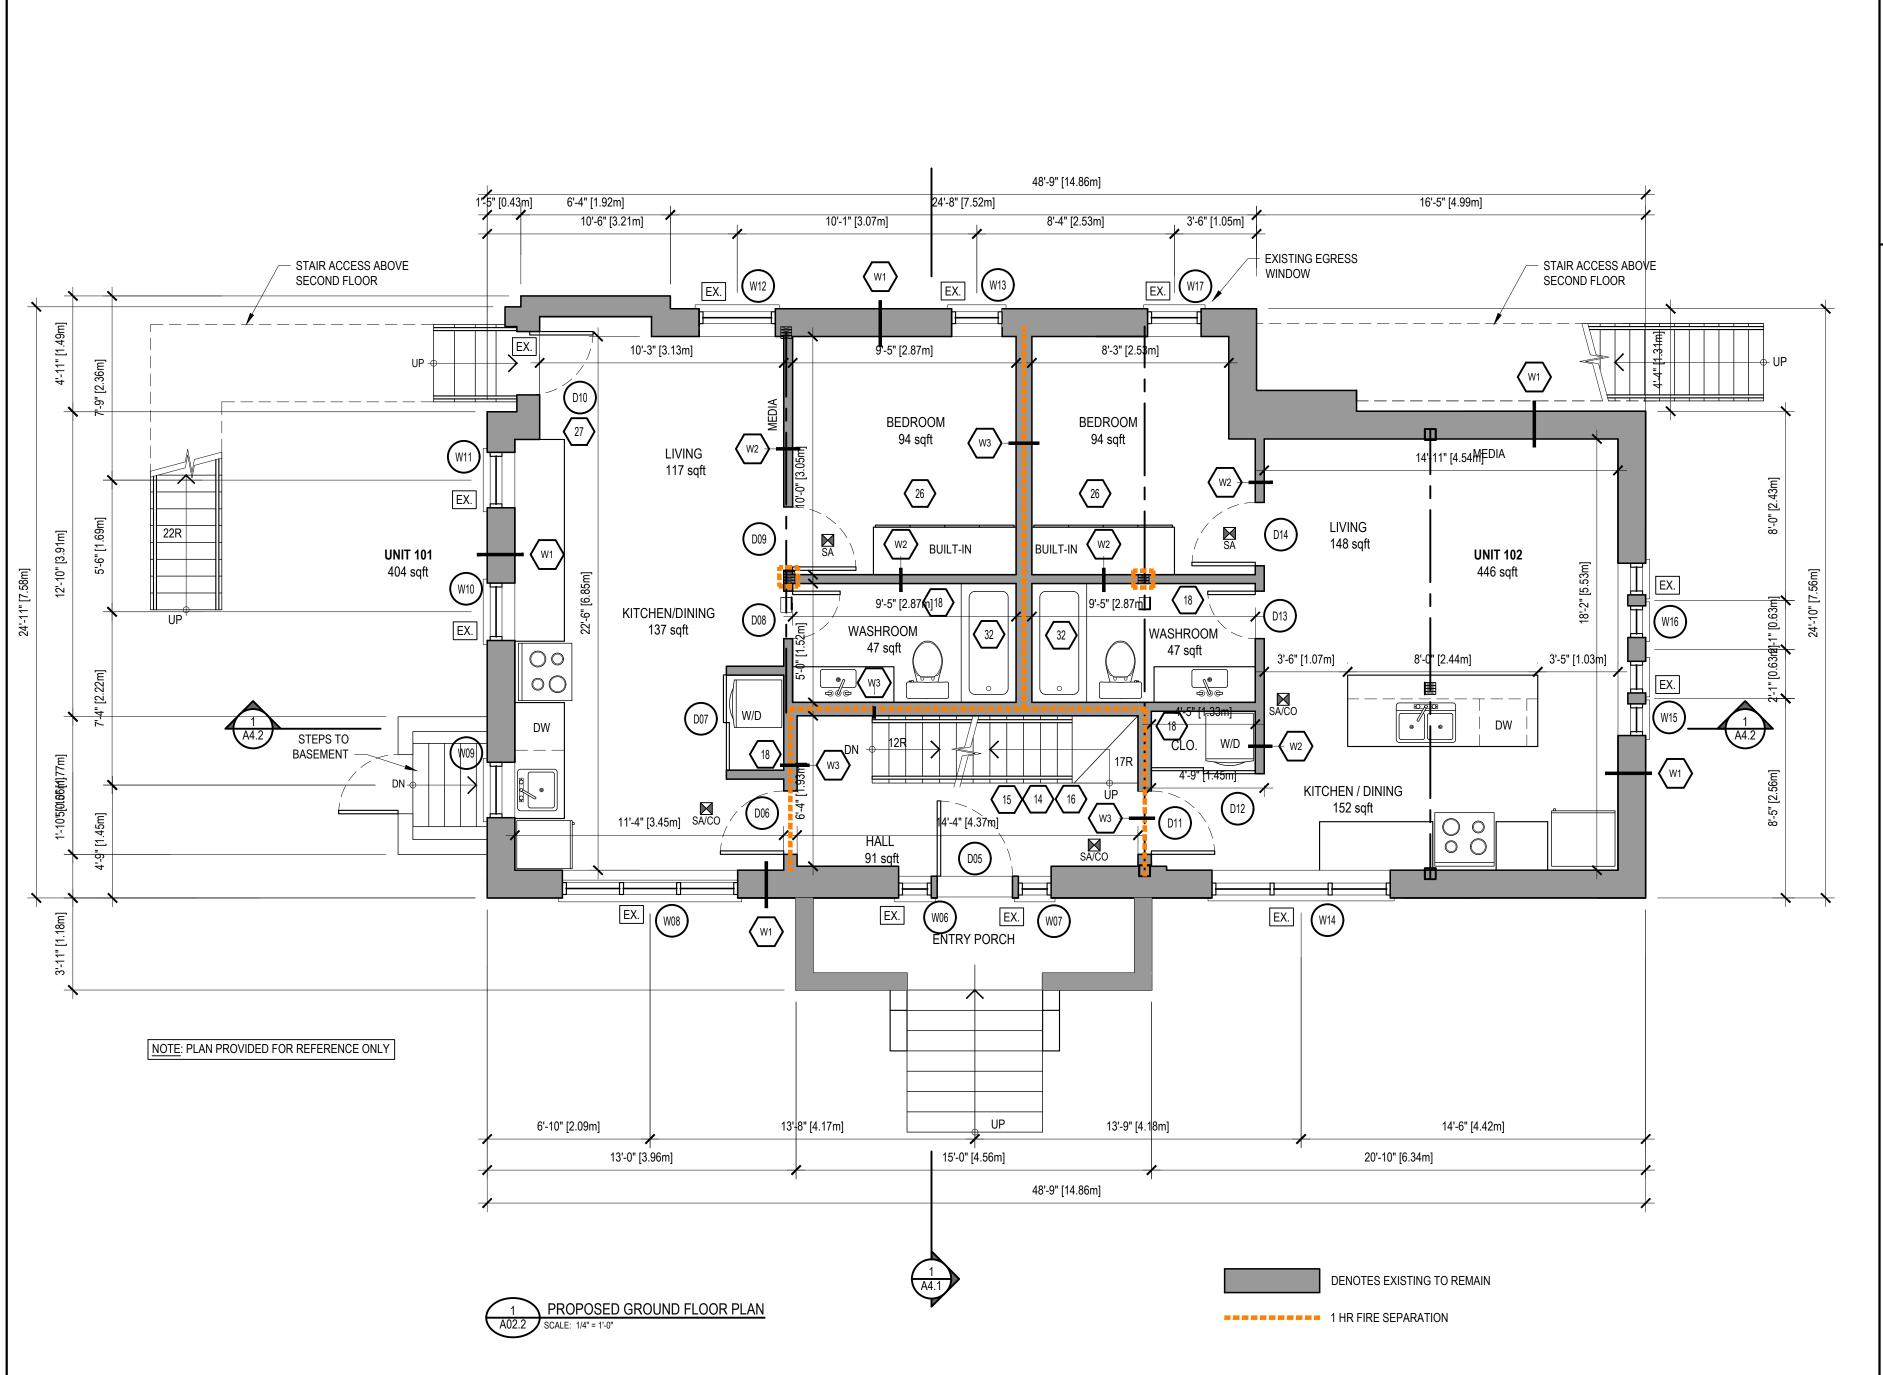

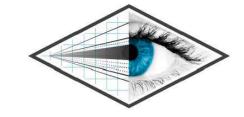

Perspective Views Inc. 126 Catharine Street N Hamilton, ON L8R 1J4 t 289.389.4502 www.perspectiveviews.com

#### These Drawings are not to be scaled

All drawings, the design, and the details thereon remain the property of the architect and are not to be altered, re-used or reporduced without the designer's express written concent. The contractor, must field verify all dimensions and must confirm & correlate all details within the fill drawing package being responsible for same throughout construction, reporting any discrepancies to the designer prior to commencing the relevant work. All drawings, details & specifications represengted in the drawings are to be used for construction only when issued by the designer and noted accordingly in the "issue/revisions" box hereon.

### TINA LISTER

2 RUTHERFORD AVENUE, HAMILTON

Revisio

Issued for MV 22/04/13

The undersigned has reviewed and takes responsibility for this design, and has the qualifications and meets the requirements set out in the Ontario Building Code to be a designer.

Qualification Information

Required unless design is exempt under Div. C - 3.2.5 of the Building Co

Project No. PV21-017

Issue Date 15-12-2021

Drawn By JOSEPH FALZONE

Checked By MATTHEW RIBAU

North




Drawing Title

### PROPOSED GROUND FLOOR

Scale 1/4" = 1'-0"

Sheet I

A02.2

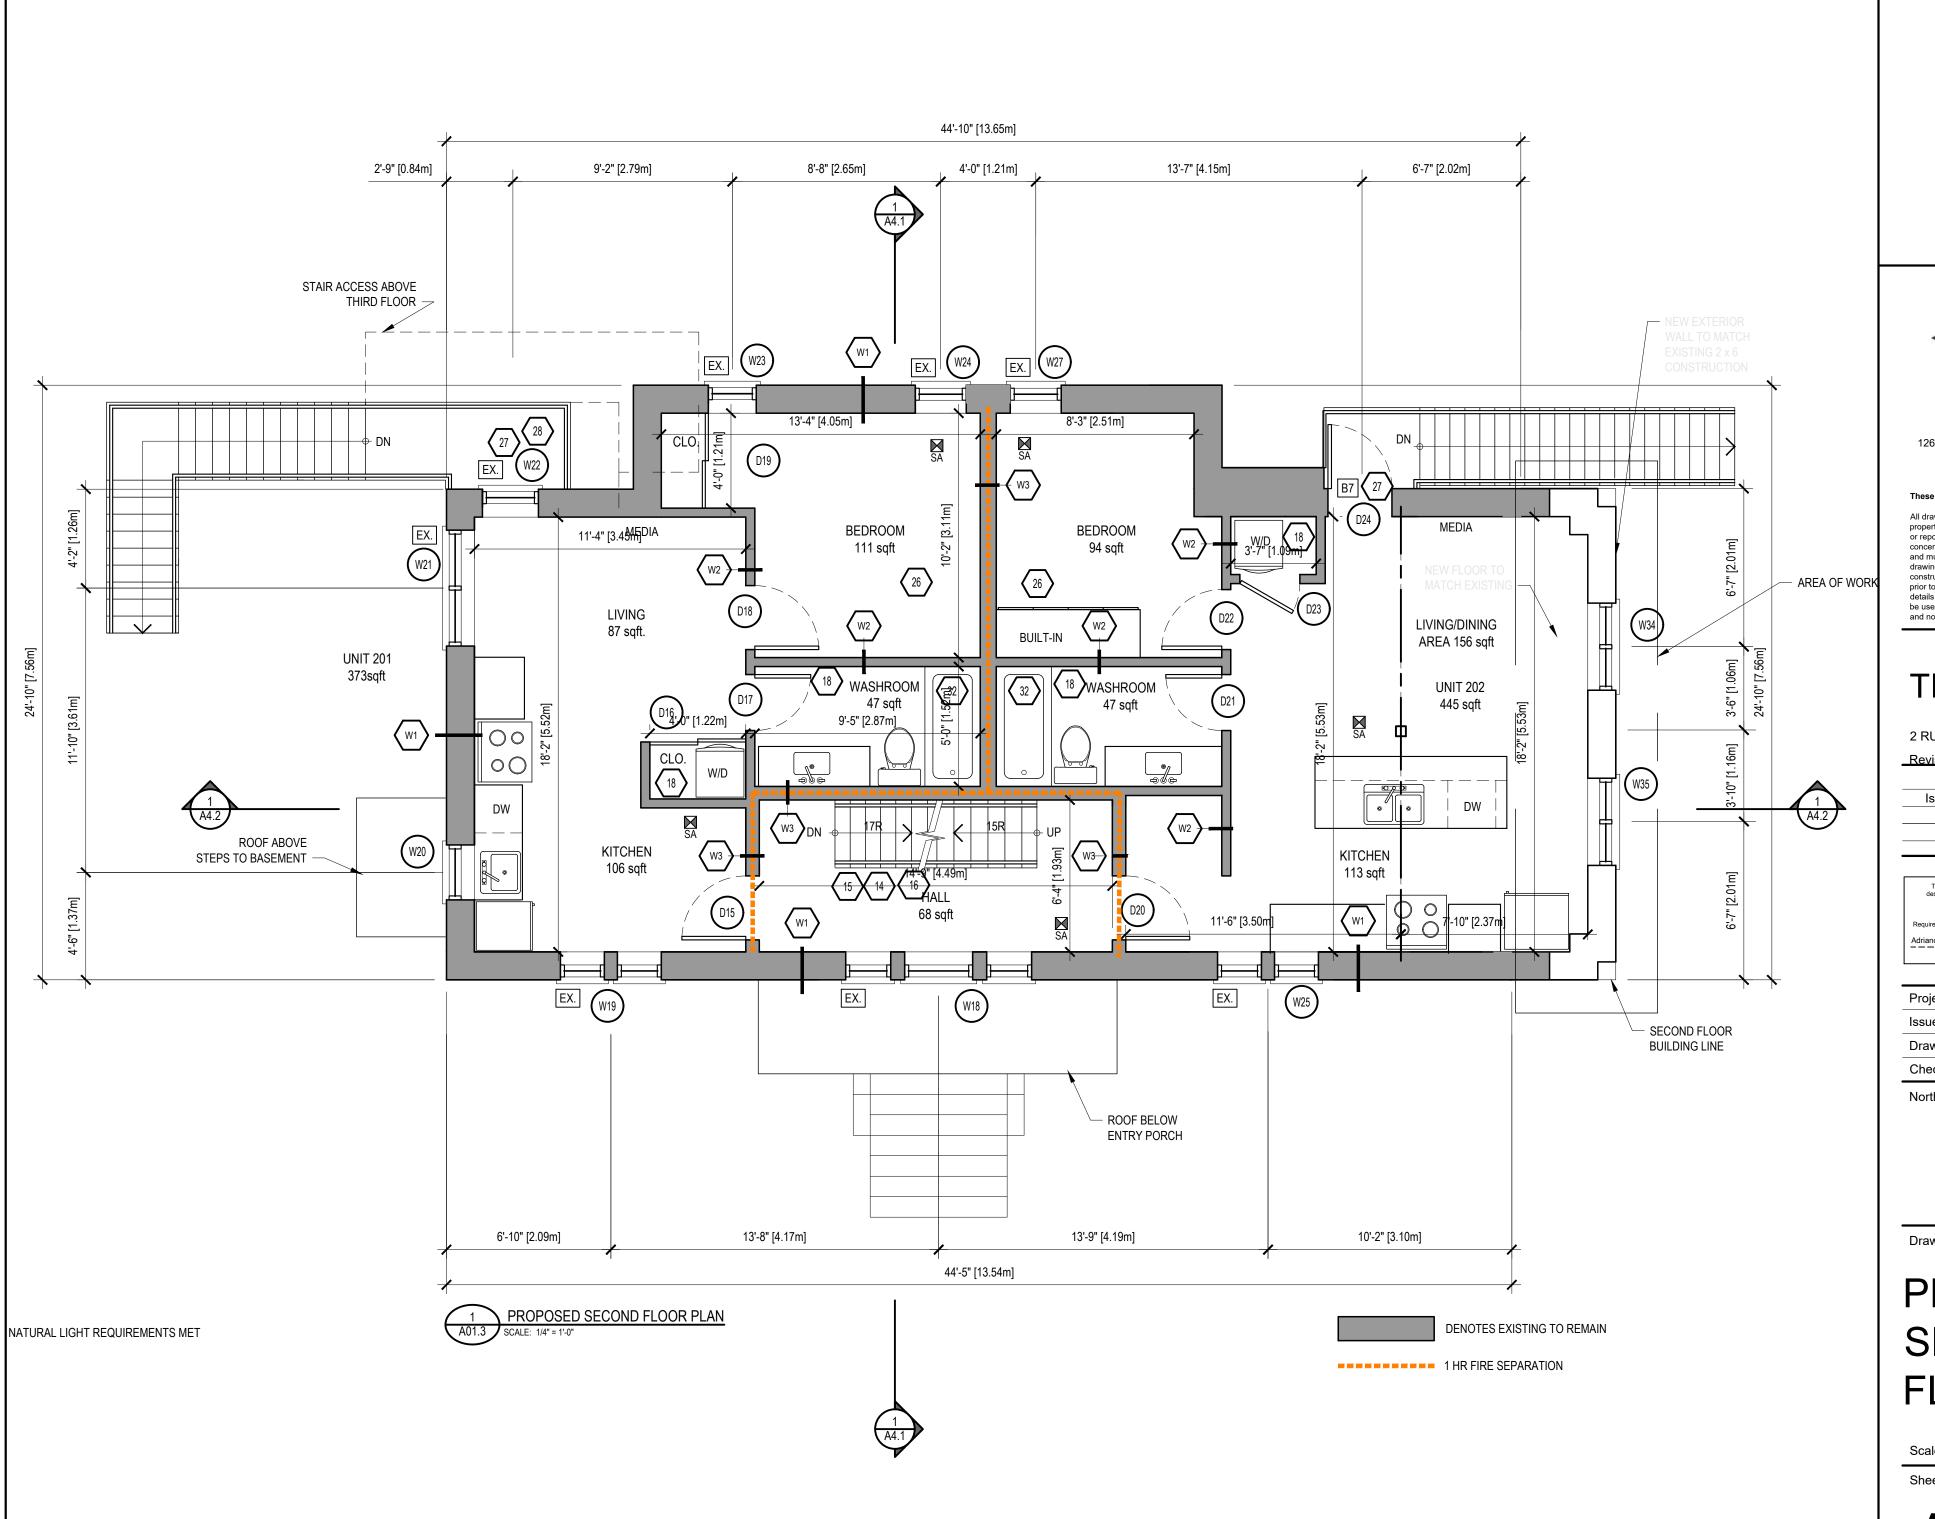



Perspective Views Inc. 126 Catharine Street N Hamilton, ON L8R 1J4 t 289.389.4502 www.perspectiveviews.com

### These Drawings are not to be scaled

All drawings, the design, and the details thereon remain the property of the architect and are not to be altered, re-used or reporduced without the designer's express written concent. The contractor, must field verify all dimensions and must confirm & correlate all details within the fill and must confirm & correlate all details within the fill drawing package being responsible for same throughout construction, reporting any discrepancies to the designer prior to commencing the relevant work. All drawings, details & specifications represengted in the drawings are to be used for construction only when issued by the designer and noted accordingly in the "issue/revisions" box hereon.

### TINA LISTER

2 RUTHERFORD AVENUE, HAMILTON

22/04/13 Issued for MV

The undersigned has reviewed and takes responsibility for this design, and has the qualifications and meets the requirements set out in the Ontario Building Code to be a designer.


Project No. PV21-017 15-12-2021 Issue Date JOSEPH FALZONE Drawn By Checked By MATTHEW RIBAU


North



Drawing Title

### **PROPOSED SECOND FLOOR**

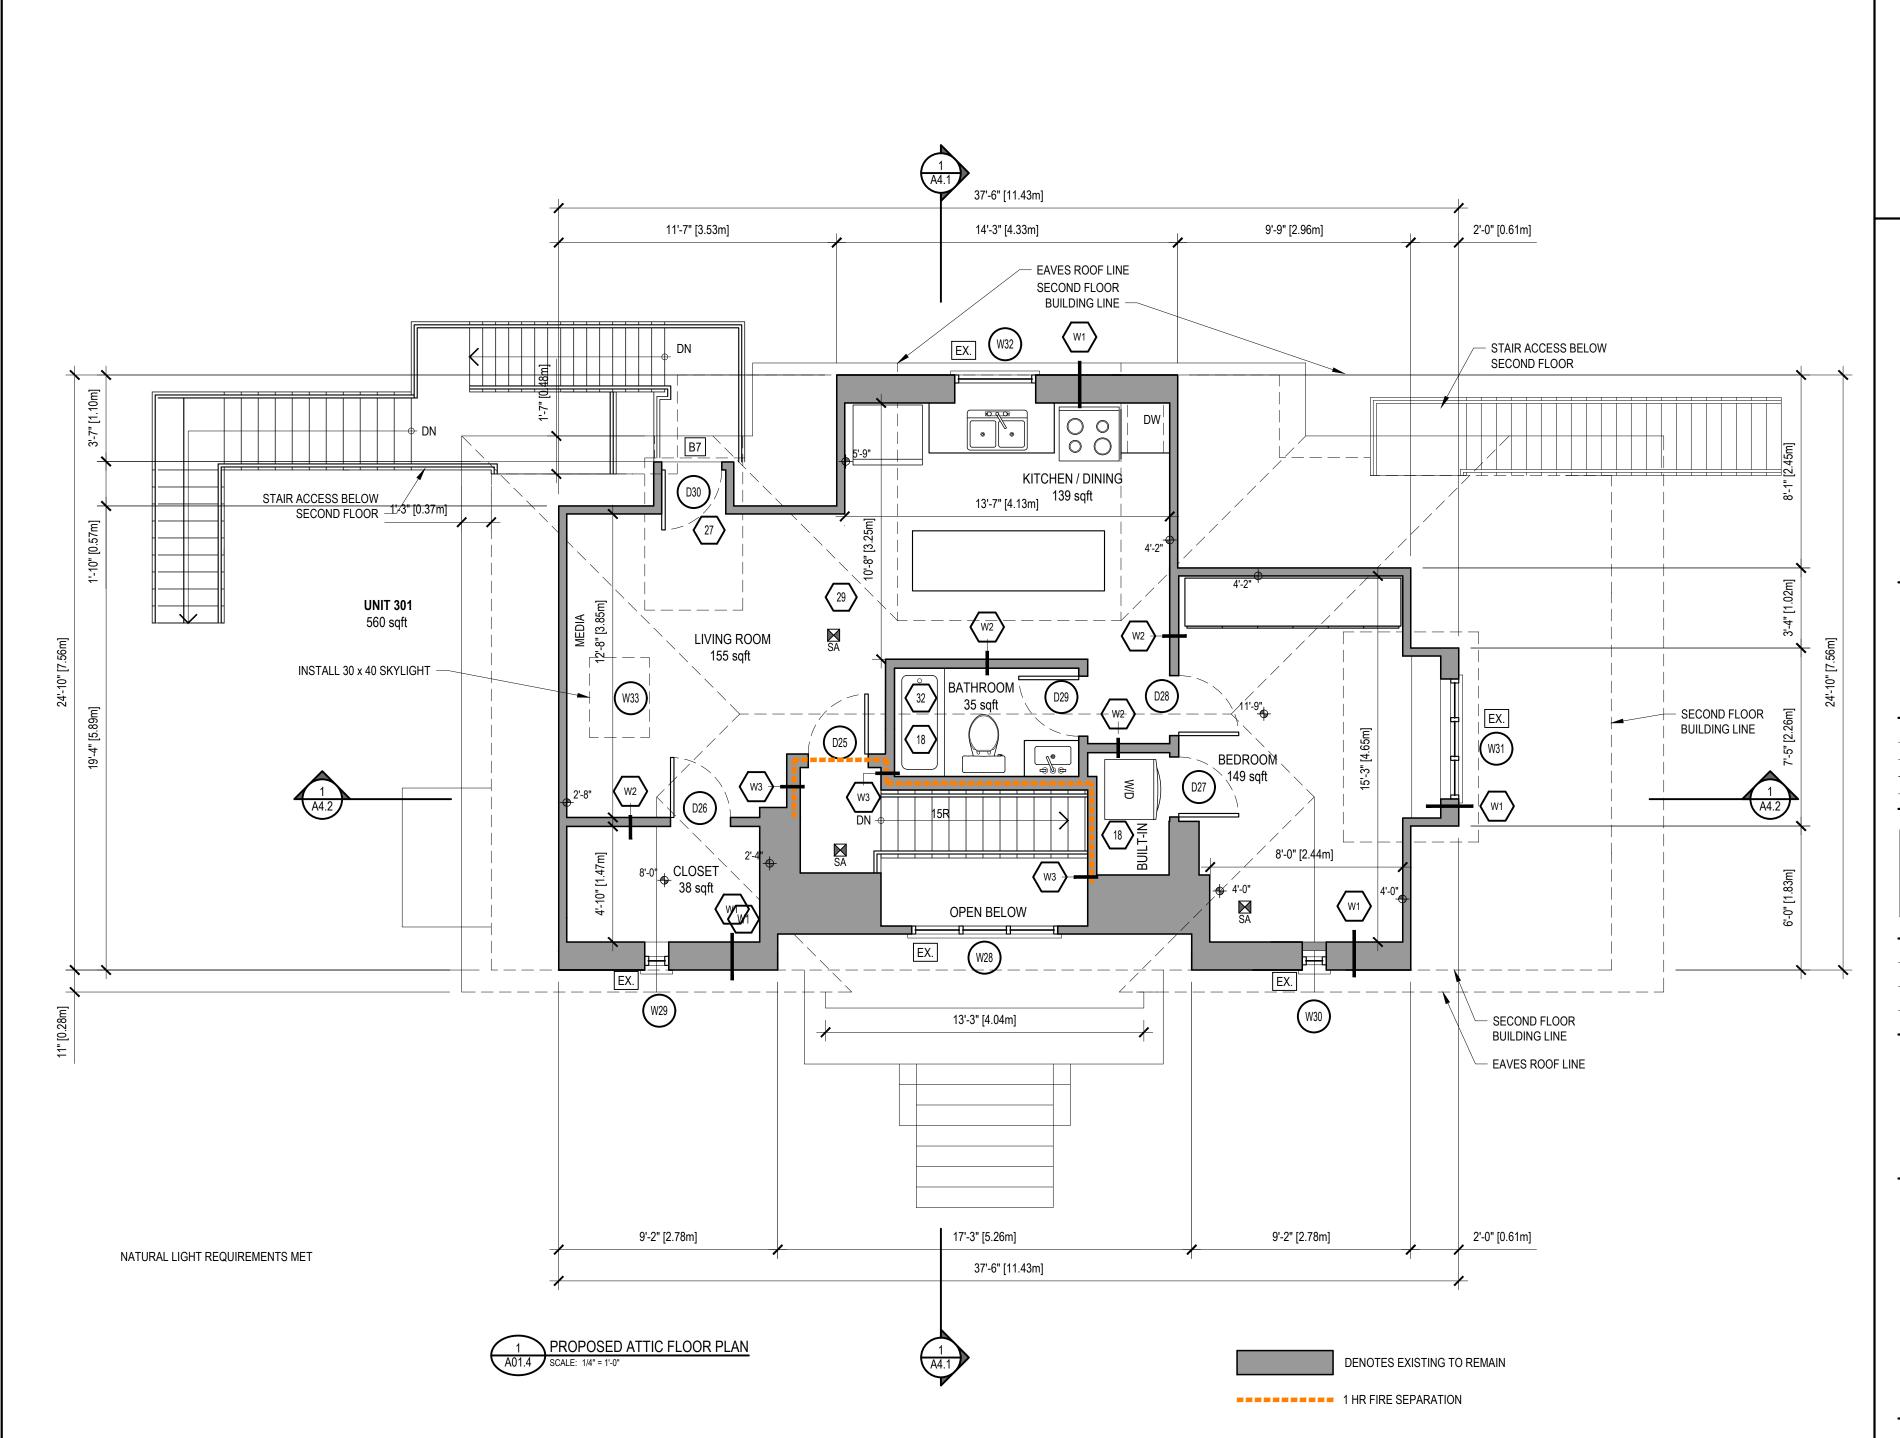

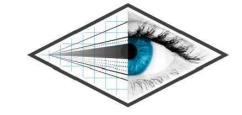

Perspective Views Inc. 126 Catharine Street N Hamilton, ON L8R 1J4 t 289.389.4502 www.perspectiveviews.com

#### These Drawings are not to be scaled

All drawings, the design, and the details thereon remain the property of the architect and are not to be altered, re-used or reporduced without the designer's express written concent. The contractor, must field verify all dimensions and must confirm & correlate all details within the fill drawing package being responsible for same throughout construction, reporting any discrepancies to the designer prior to commencing the relevant work. All drawings, details & specifications represengted in the drawings are to be used for construction only when issued by the designer and noted accordingly in the "issue/revisions" box hereon.

### TINA LISTER

2 RUTHERFORD AVENUE, HAMILTON

Revisions

Issued for MV 22/04/13

The undersigned has reviewed and takes responsibility for this design, and has the qualifications and meets the requirements set out in the Ontario Building Code to be a designer.

Qualification Information

Project No. PV21-017

Issue Date 15-12-2021

Drawn By JOSEPH FALZONE

Checked By MATTHEW RIBAU

North



Drawing Title

## PROPOSED ATTIC

Scale 1/4" = 1'-0"

Sheet No.

A02.4





Perspective Views Inc. 126 Catharine Street N Hamilton, ON L8R 1J4 t 289.389.4502 www.perspectiveviews.com

#### These Drawings are not to be scaled

All drawings, the design, and the details thereon remain the property of the architect and are not to be altered, re-used or reporduced without the designer's express written concent. The contractor, must field verify all dimensions and must confirm & correlate all details within the fill drawing package being responsible for same throughout construction, reporting any discrepancies to the designer prior to commencing the relevant work. All drawings, details & specifications represengted in the drawings are to be used for construction only when issued by the designer and noted accordingly in the "issue/revisions" box hereon.

### TINA LISTER

2 RUTHERFORD AVENUE, HAMILTON

22/04/13 Issued for MV

The undersigned has reviewed and takes responsibility for this design, and has the qualifications and meets the requirements set out in the Ontario Building Code to be a designer.


PV21-017 Project No. 15-12-2021 Issue Date JOSEPH FALZONE Drawn By MATTHEW RIBAU


Checked By



Drawing Title

### **FRONT** SOUTH **ELEVATION**

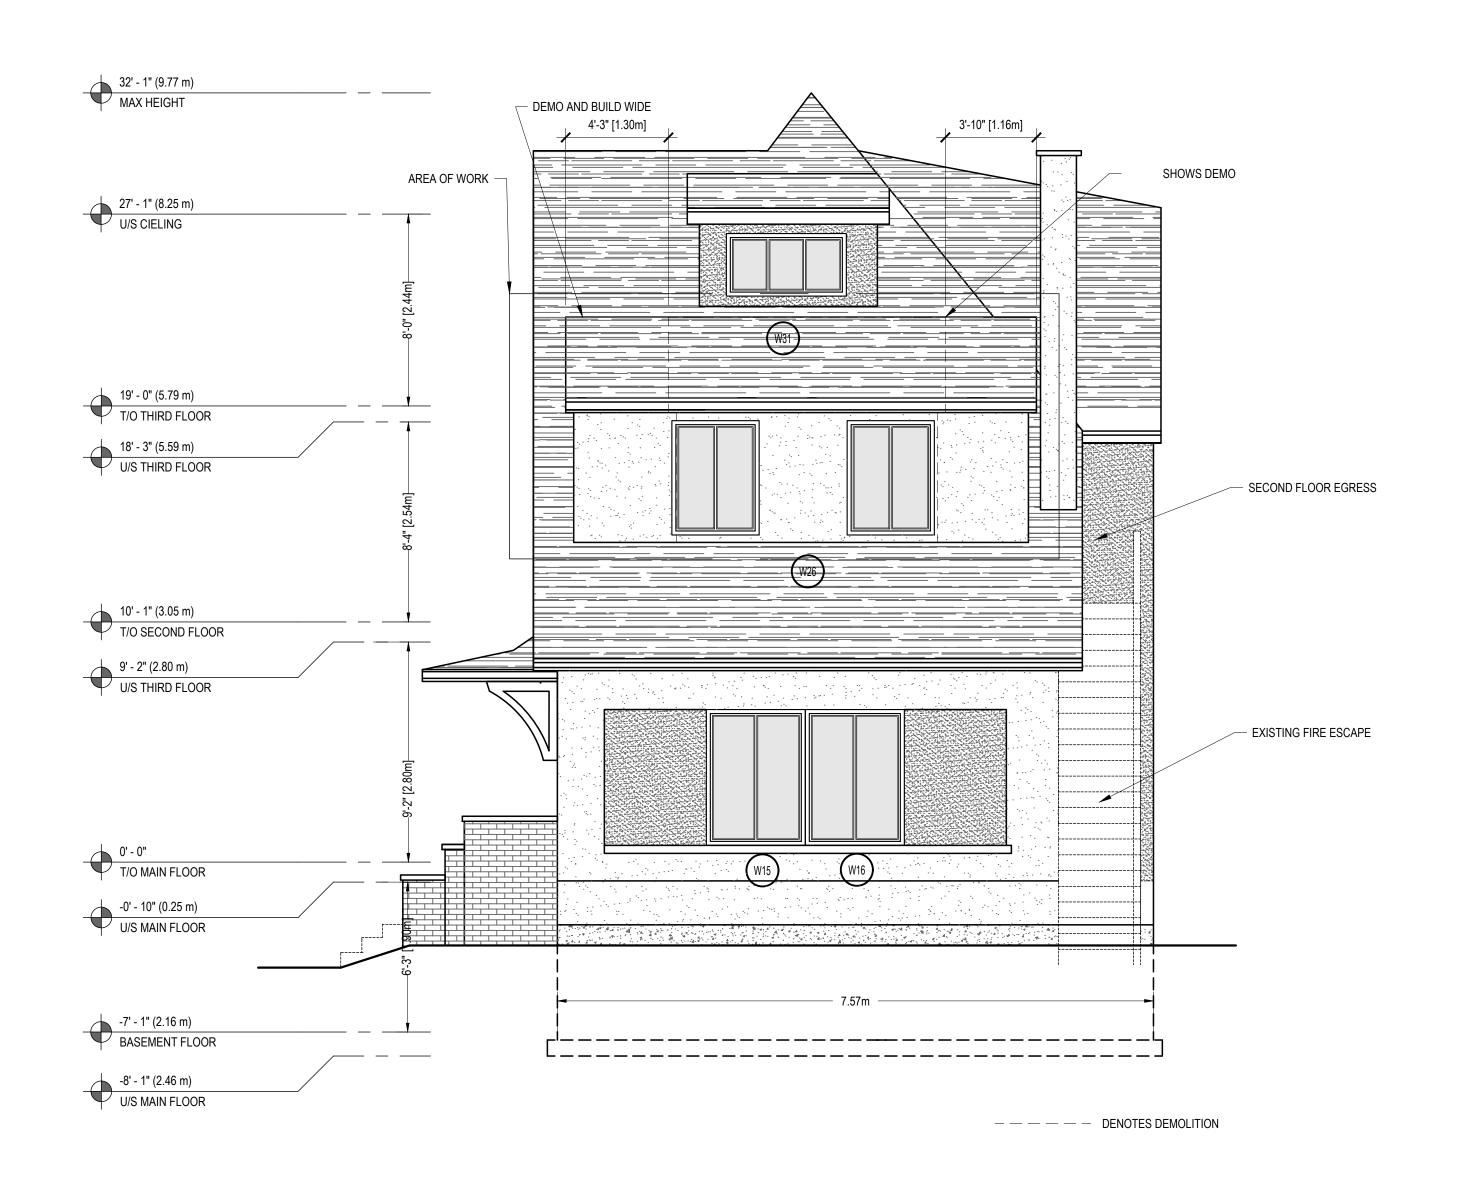

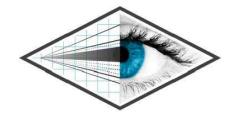

Perspective Views Inc. 126 Catharine Street N Hamilton, ON L8R 1J4 t 289.389.4502 www.perspectiveviews.com

#### These Drawings are not to be scaled

All drawings, the design, and the details thereon remain the property of the architect and are not to be altered, re-used or reporduced without the designer's express written concent. The contractor, must field verify all dimensions and must confirm & correlate all details within the fill drawing package being responsible for same throughout construction, reporting any discrepancies to the designer prior to commencing the relevant work. All drawings, details & specifications represengted in the drawings are to be used for construction only when issued by the designer and noted accordingly in the "issue/revisions" box hereon.

### TINA LISTER

2 RUTHERFORD AVENUE, HAMILTON

Revision

Issued for MV 22/04/13

The undersigned has reviewed and takes responsibility for this design, and has the qualifications and meets the requirements set out in the Ontario Building Code to be a designer.

Required unless design is exempt under Div. C - 3.2.5 of the Building (
Adriano Passariello 115278

Project No. PV21-017
Issue Date 15-12-2021
Drawn By JOSEPH FALZONE
Checked By MATTHEW RIBAU

North




Drawing Title


RIGHT WEST ELEVATION

DL - - ( N)

Sheet N

A03.2

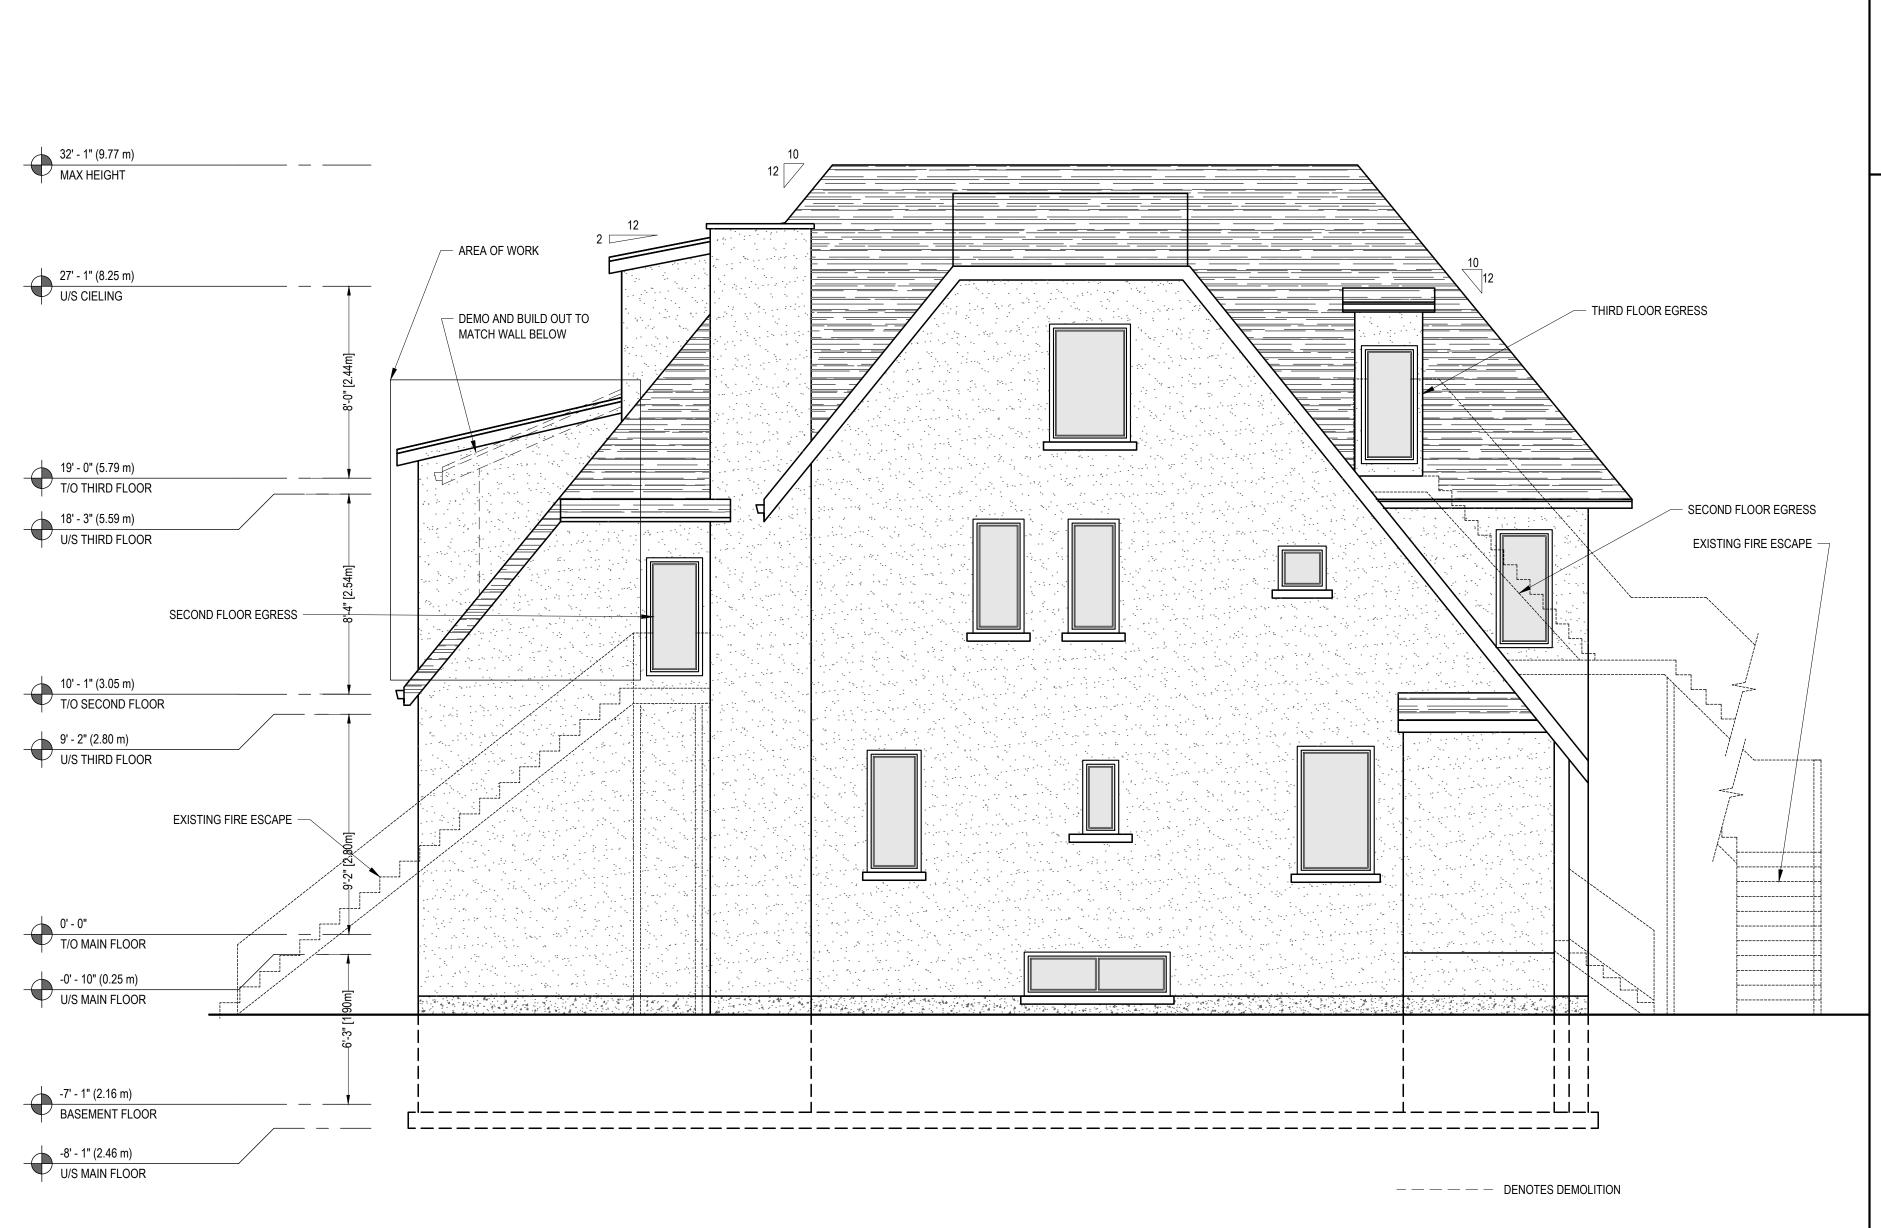

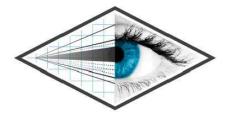

Perspective Views Inc. 126 Catharine Street N Hamilton, ON L8R 1J4 t 289.389.4502 www.perspectiveviews.com

### These Drawings are not to be scaled

All drawings, the design, and the details thereon remain the property of the architect and are not to be altered, re-used or reporduced without the designer's express written concent. The contractor, must field verify all dimensions and must confirm & correlate all details within the fill drawing package being responsible for same throughout construction, reporting any discrepancies to the designer prior to commencing the relevant work. All drawings, details & specifications represengted in the drawings are to be used for construction only when issued by the designer and noted accordingly in the "issue/revisions" box hereon.

### TINA LISTER

2 RUTHERFORD AVENUE, HAMILTON

Revision

Issued for MV 22/04/13

The undersigned has reviewed and takes responsibility for this design, and has the qualifications and meets the requirements set out in the Ontario Building Code to be a designer.

Required unless design is exempt under Div. C - 3.2.5 of the Building Code

Adriano Passariello

115278

Name Signature

PCIN

Project No. PV21-017

Issue Date 15-12-2021

Drawn By JOSEPH FALZONE

Checked By MATTHEW RIBAU

Nor




Drawing Title


### REAR NORTH ELEVATION

-----

1/4 - 1 -

A03.3

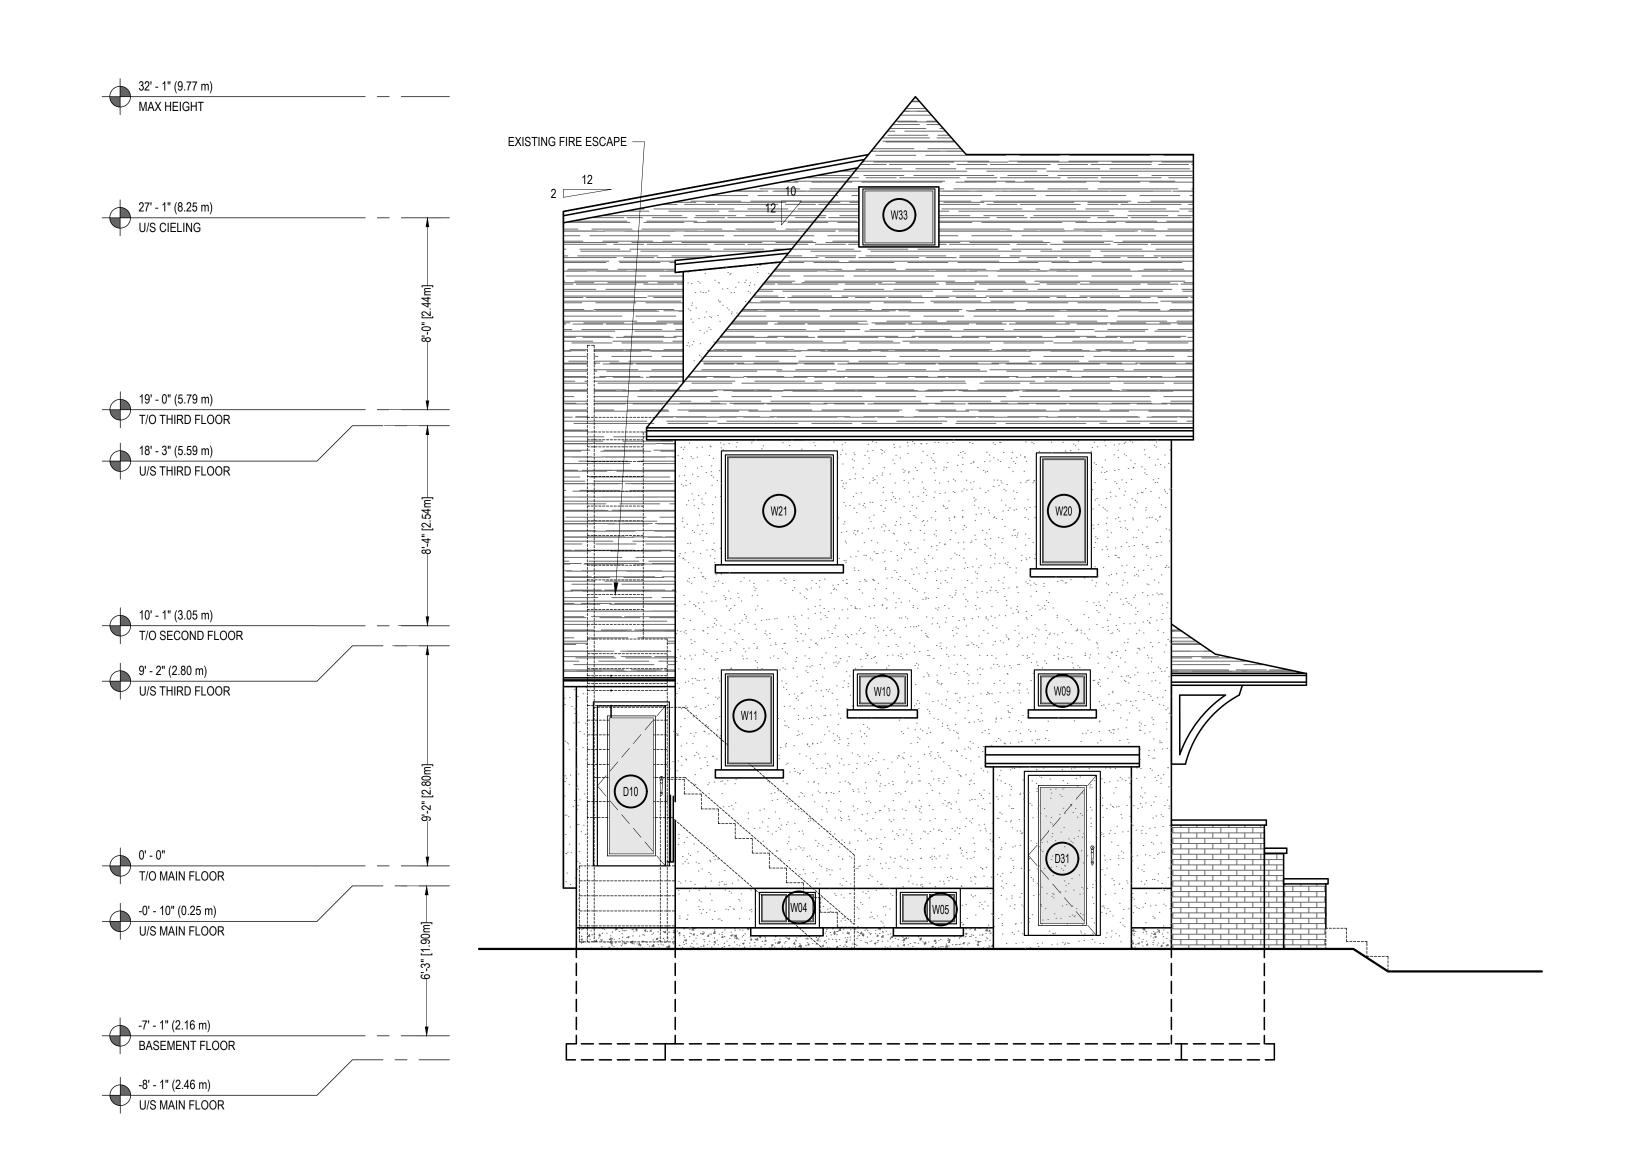

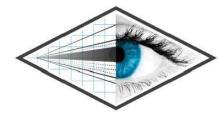

Perspective Views Inc. 126 Catharine Street N Hamilton, ON L8R 1J4 t 289.389.4502 www.perspectiveviews.com

### These Drawings are not to be scaled

All drawings, the design, and the details thereon remain the property of the architect and are not to be altered, re-used or reporduced without the designer's express written concent. The contractor, must field verify all dimensions and must confirm & correlate all details within the fill drawing package being responsible for same throughout construction, reporting any discrepancies to the designer prior to commencing the relevant work. All drawings, details & specifications represengted in the drawings are to be used for construction only when issued by the designer and noted accordingly in the "issue/revisions" box hereon.

### TINA LISTER

2 RUTHERFORD AVENUE, HAMILTON

### Revisions

Issued for MV 22/04/13

The undersigned has reviewed and takes responsibility for this design, and has the qualifications and meets the requirements set out in the Ontario Building Code to be a designer.

Adriano Passariello 115278 BCIN Name Signature BCIN

 Project No.
 PV21-017

 Issue Date
 15-12-2021

 Drawn By
 JOSEPH FALZONE

 Checked By
 MATTHEW RIBAU

### North




Drawing Title


### LEFT EAST ELEVATION

\_\_\_\_

Sheet I

A03.4

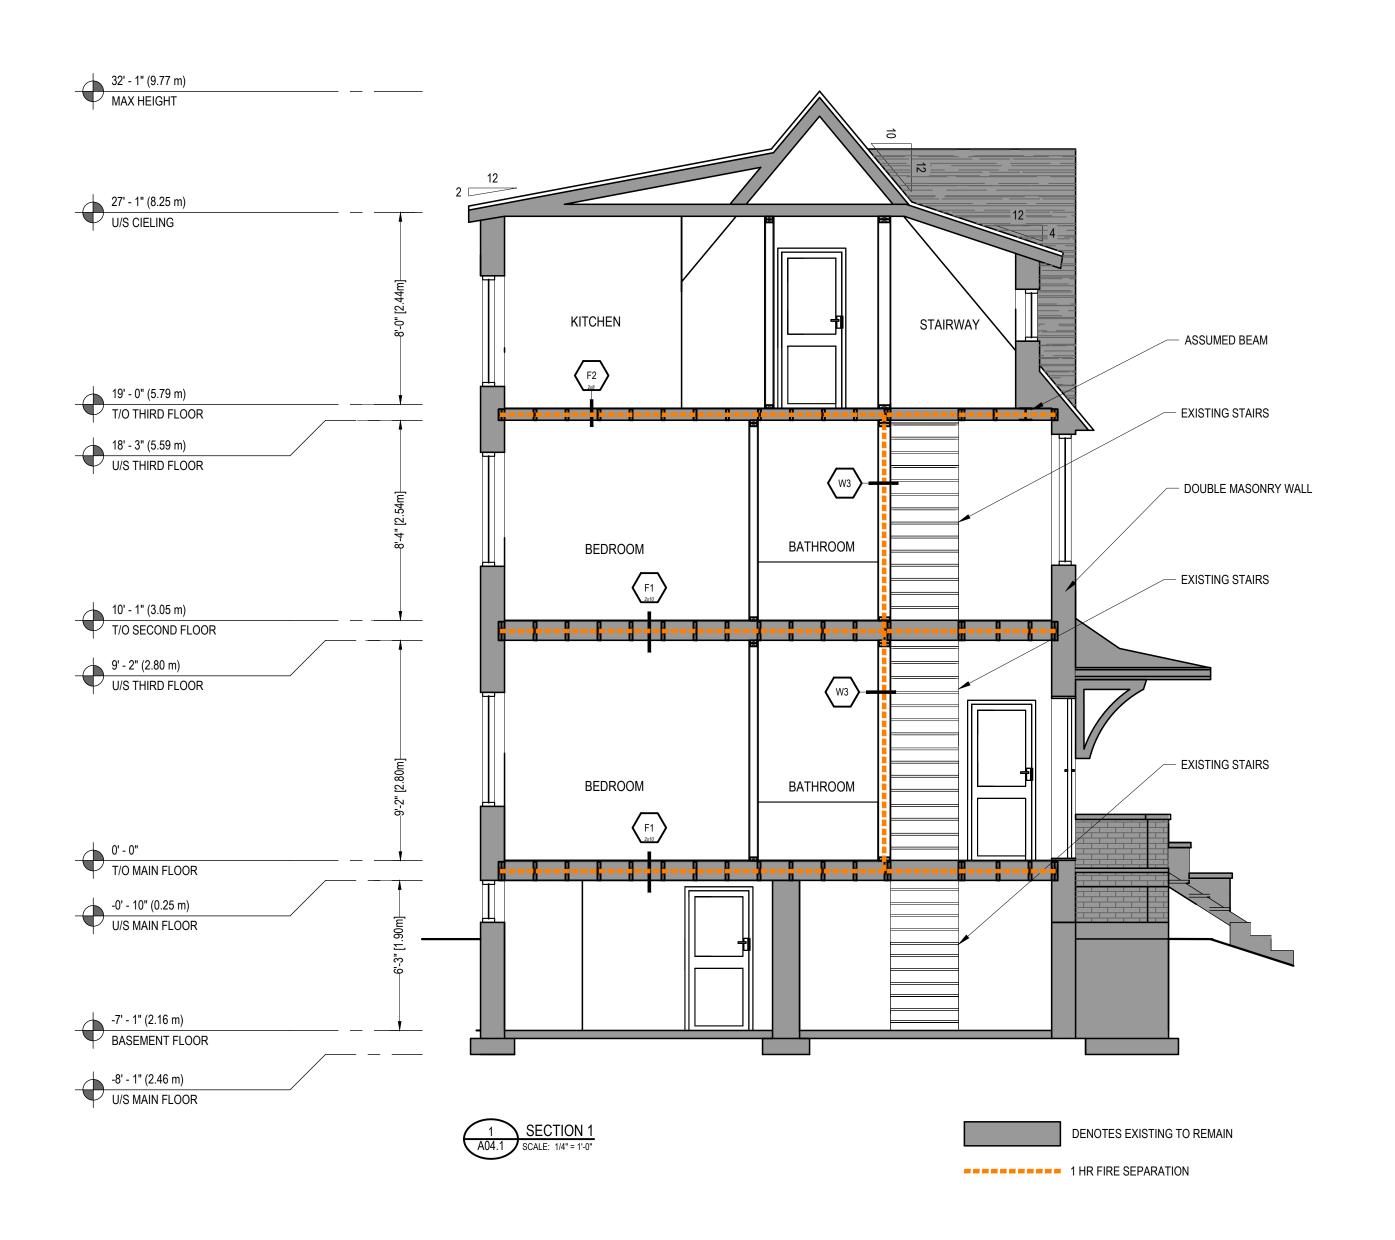

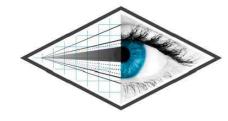

Perspective Views Inc. 126 Catharine Street N Hamilton, ON L8R 1J4 t 289.389.4502 www.perspectiveviews.com

#### These Drawings are not to be scaled

All drawings, the design, and the details thereon remain the property of the architect and are not to be altered, re-used or reporduced without the designer's express written concent. The contractor, must field verify all dimensions and must confirm & correlate all details within the fill drawing package being responsible for same throughout construction, reporting any discrepancies to the designer prior to commencing the relevant work. All drawings, details & specifications represengted in the drawings are to be used for construction only when issued by the designer and noted accordingly in the "issue/revisions" box hereon.

### TINA LISTER

2 RUTHERFORD AVENUE, HAMILTON

Revision

Issued for MV 22/04/13

The undersigned has reviewed and takes responsibility for this design, and has the qualifications and meets the requirements set out in the Ontario Building Code to be a designer.

Required unless design is exempt under Div. C - 3.2.5 of the Building Co.

Adriano Passariello 115278

 Project No.
 PV21-017

 Issue Date
 15-12-2021

 Drawn By
 JOSEPH FALZONE

 Checked By
 MATTHEW RIBAU

North




Drawing Title


SECTION

Scale

Sheet N

A04.1

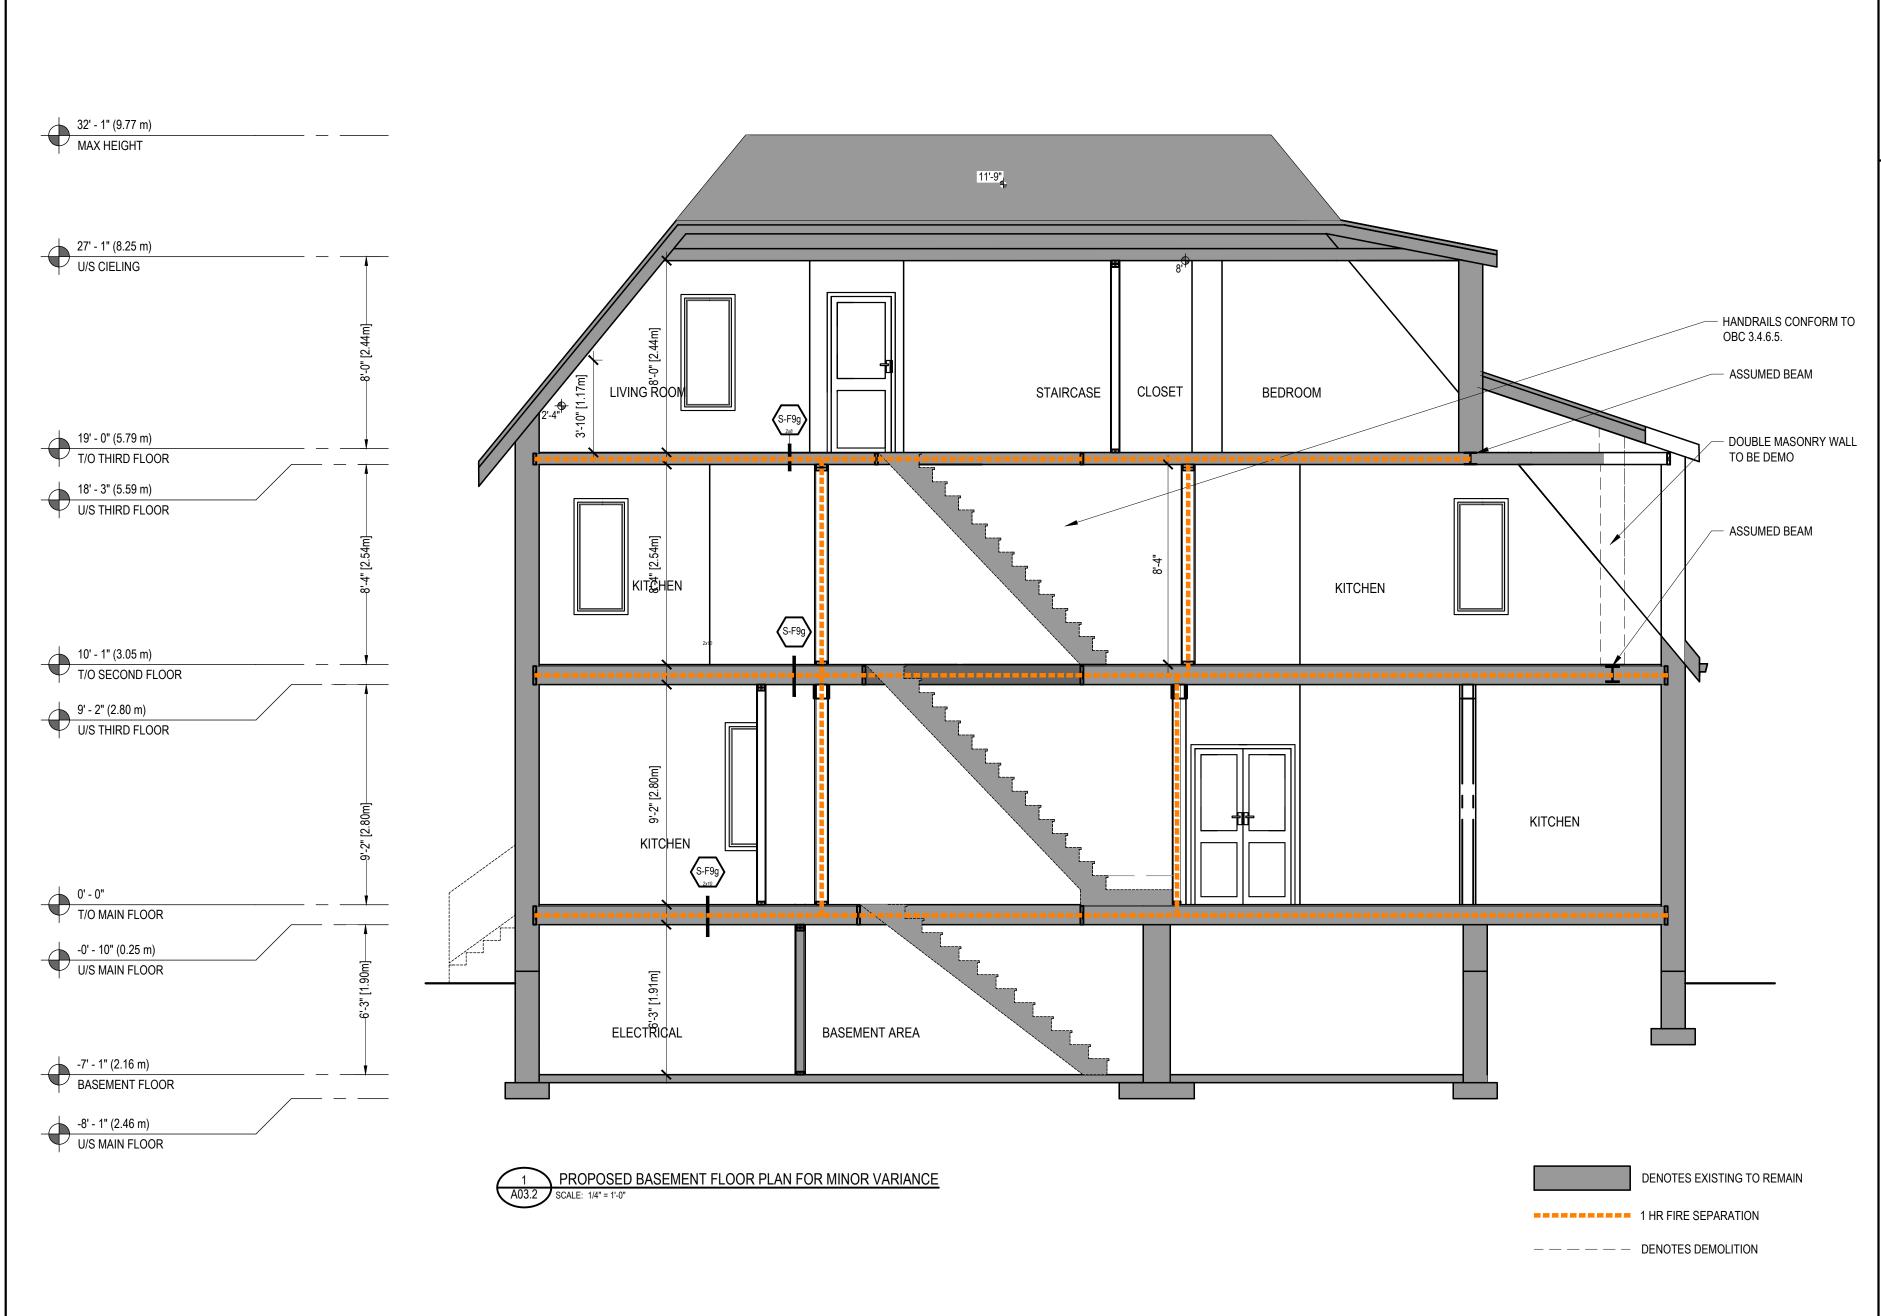

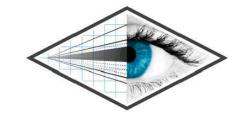

Perspective Views Inc. 126 Catharine Street N Hamilton, ON L8R 1J4 t 289.389.4502 www.perspectiveviews.com

### These Drawings are not to be scaled

All drawings, the design, and the details thereon remain the property of the architect and are not to be altered, re-used or reporduced without the designer's express written concent. The contractor, must field verify all dimensions and must confirm & correlate all details within the fill drawing package being responsible for same throughout construction, reporting any discrepancies to the designer prior to commencing the relevant work. All drawings, details & specifications represengted in the drawings are to be used for construction only when issued by the designer and noted accordingly in the "issue/revisions" box hereon.

### TINA LISTER

2 RUTHERFORD AVENUE, HAMILTON

\_Revisio

Issued for MV 22/04/13

The undersigned has reviewed and takes responsibility for this design, and has the qualifications and meets the requirements set out in the Ontario Building Code to be a designer.

Required unless design is exempt under Div. C - 3.2.5 of the Building Code

Adriano Passariello 115278

Project No. PV21-017
Issue Date 15-12-2021
Drawn By JOSEPH FALZONE
Checked By MATTHEW RIBAU

North




Drawing Title


SECTION 2

Scale 1/4" = 1'-0"

Sheet No

A04.2

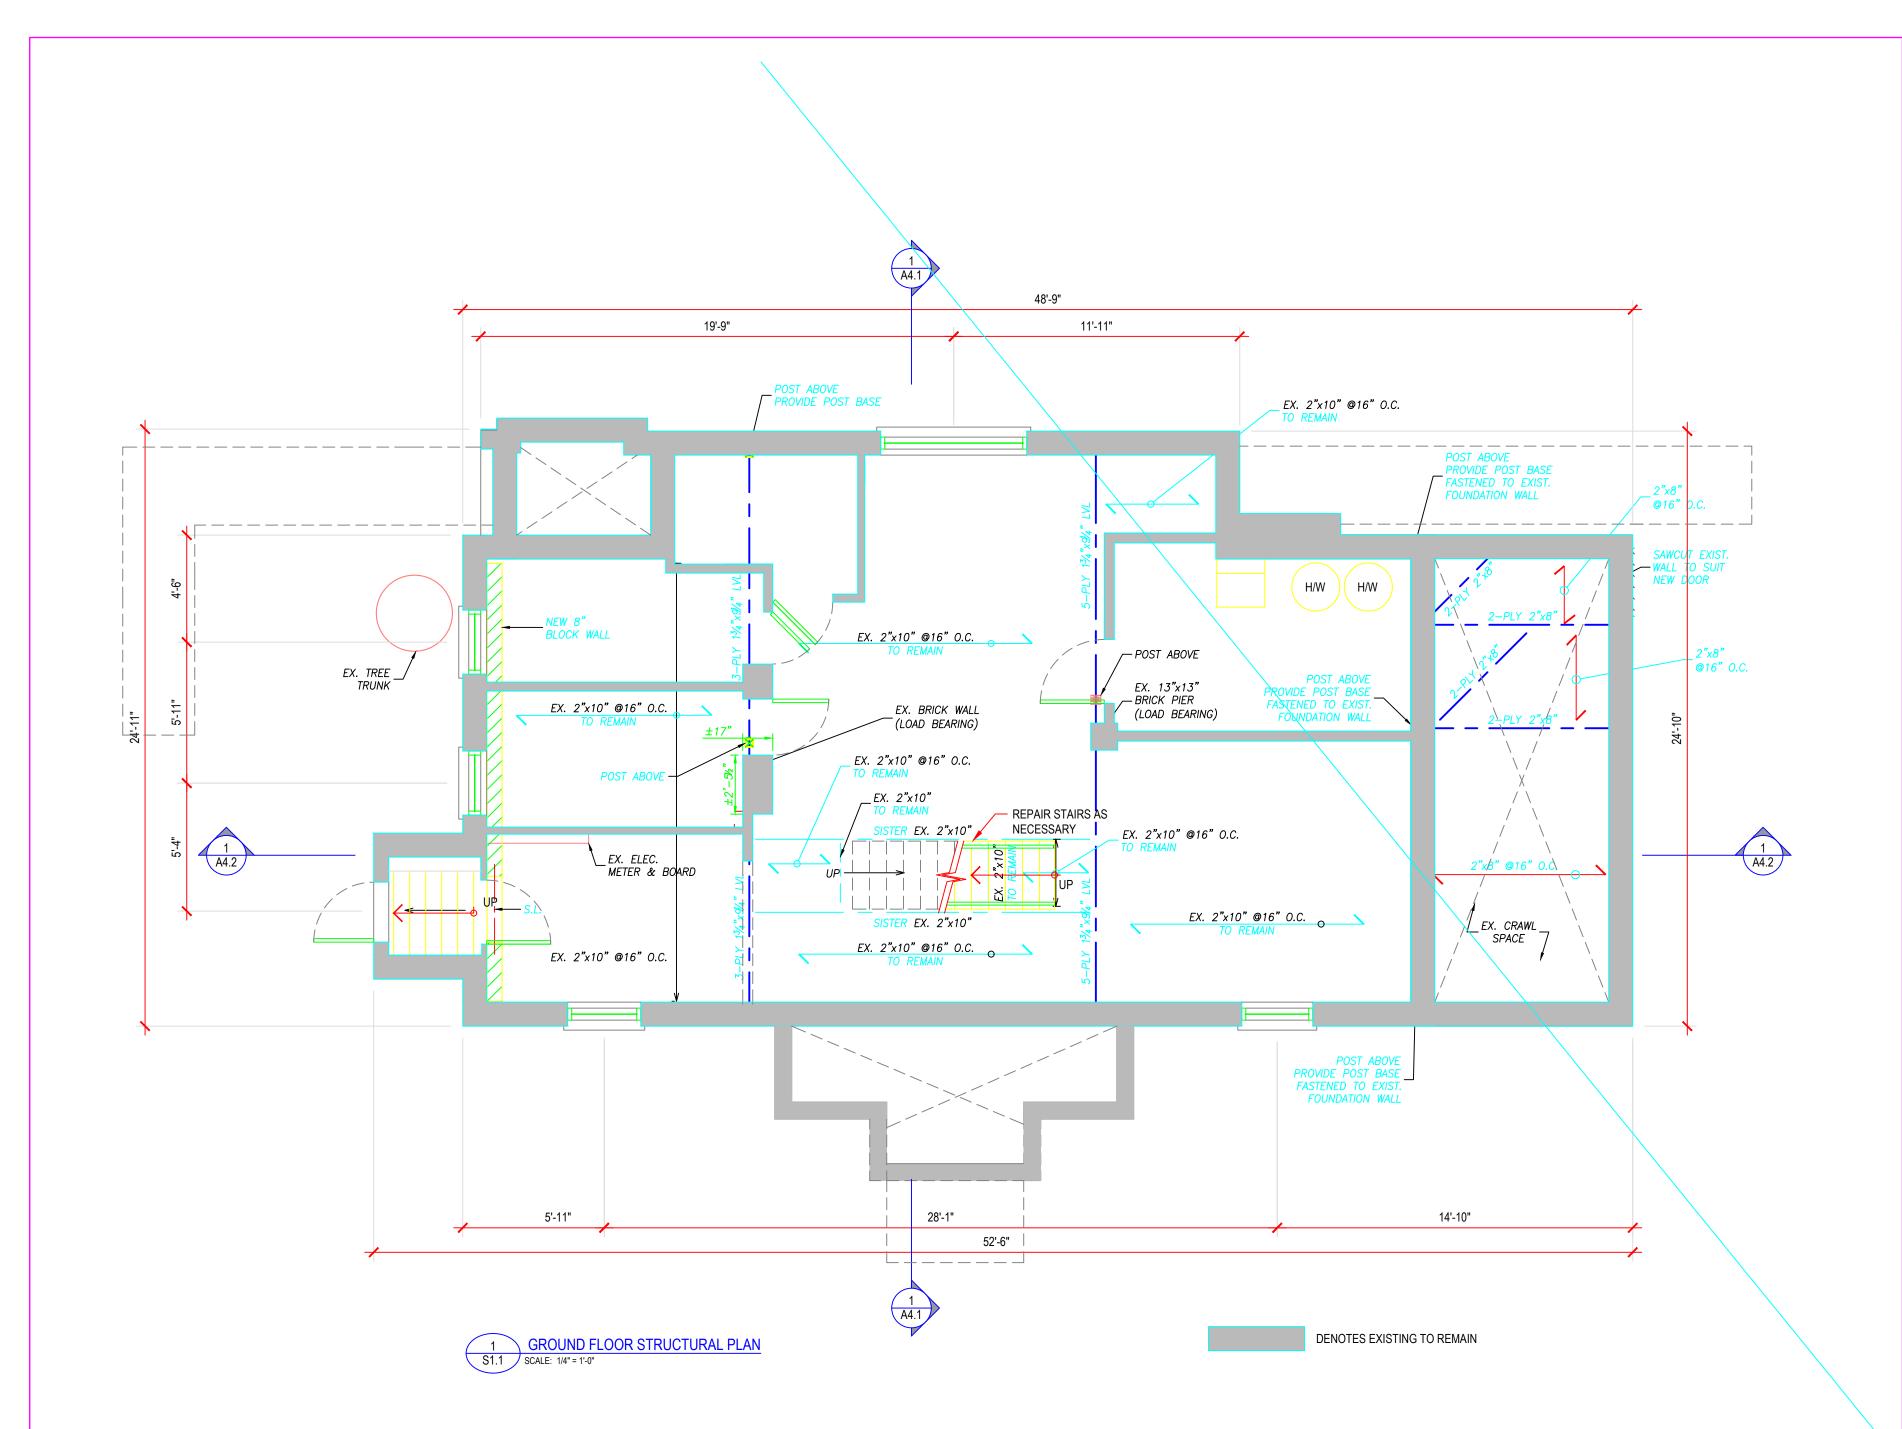

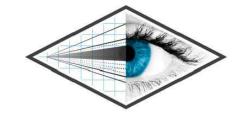

Perspective Views Inc. 126 Catharine Street N Hamilton, ON L8R 1J4 t 289.389.4502 www.perspectiveviews.com

#### These Drawings are not to be scaled

All drawings, the design, and the details thereon remain the property of the architect and are not to be altered, re-used or reporduced without the designer's express written concent. The contractor, must field verify all dimensions and must confirm & correlate all details within the fill drawing package being responsible for same throughout construction, reporting any discrepancies to the designer prior to commencing the relevant work. All drawings, details & specifications represengted in the drawings are to be used for construction only when issued by the designer and noted accordingly in the "issue/revisions" box hereon.

### TINA LISTER

2 RUTHERFORD AVENUE, HAMILTON

Revisions

Issued for MV 22/04/13

The undersigned has reviewed and takes responsibility for this design, and has the qualifications and meets the requirements set out in the Ontario Building Code to be a designer.

Qualification Information

Adriano Passariello 115278

Name Signature BCIN

Project No. PV21-017

Issue Date 15-12-2021

Drawn By JOSEPH FALZONE

Checked By MATTHEW RIBAU

North




Drawing Title

### GROUND FLOOR STRUCTURAL PLAN

1/4" = 1'-0"

S<sub>1.1</sub>

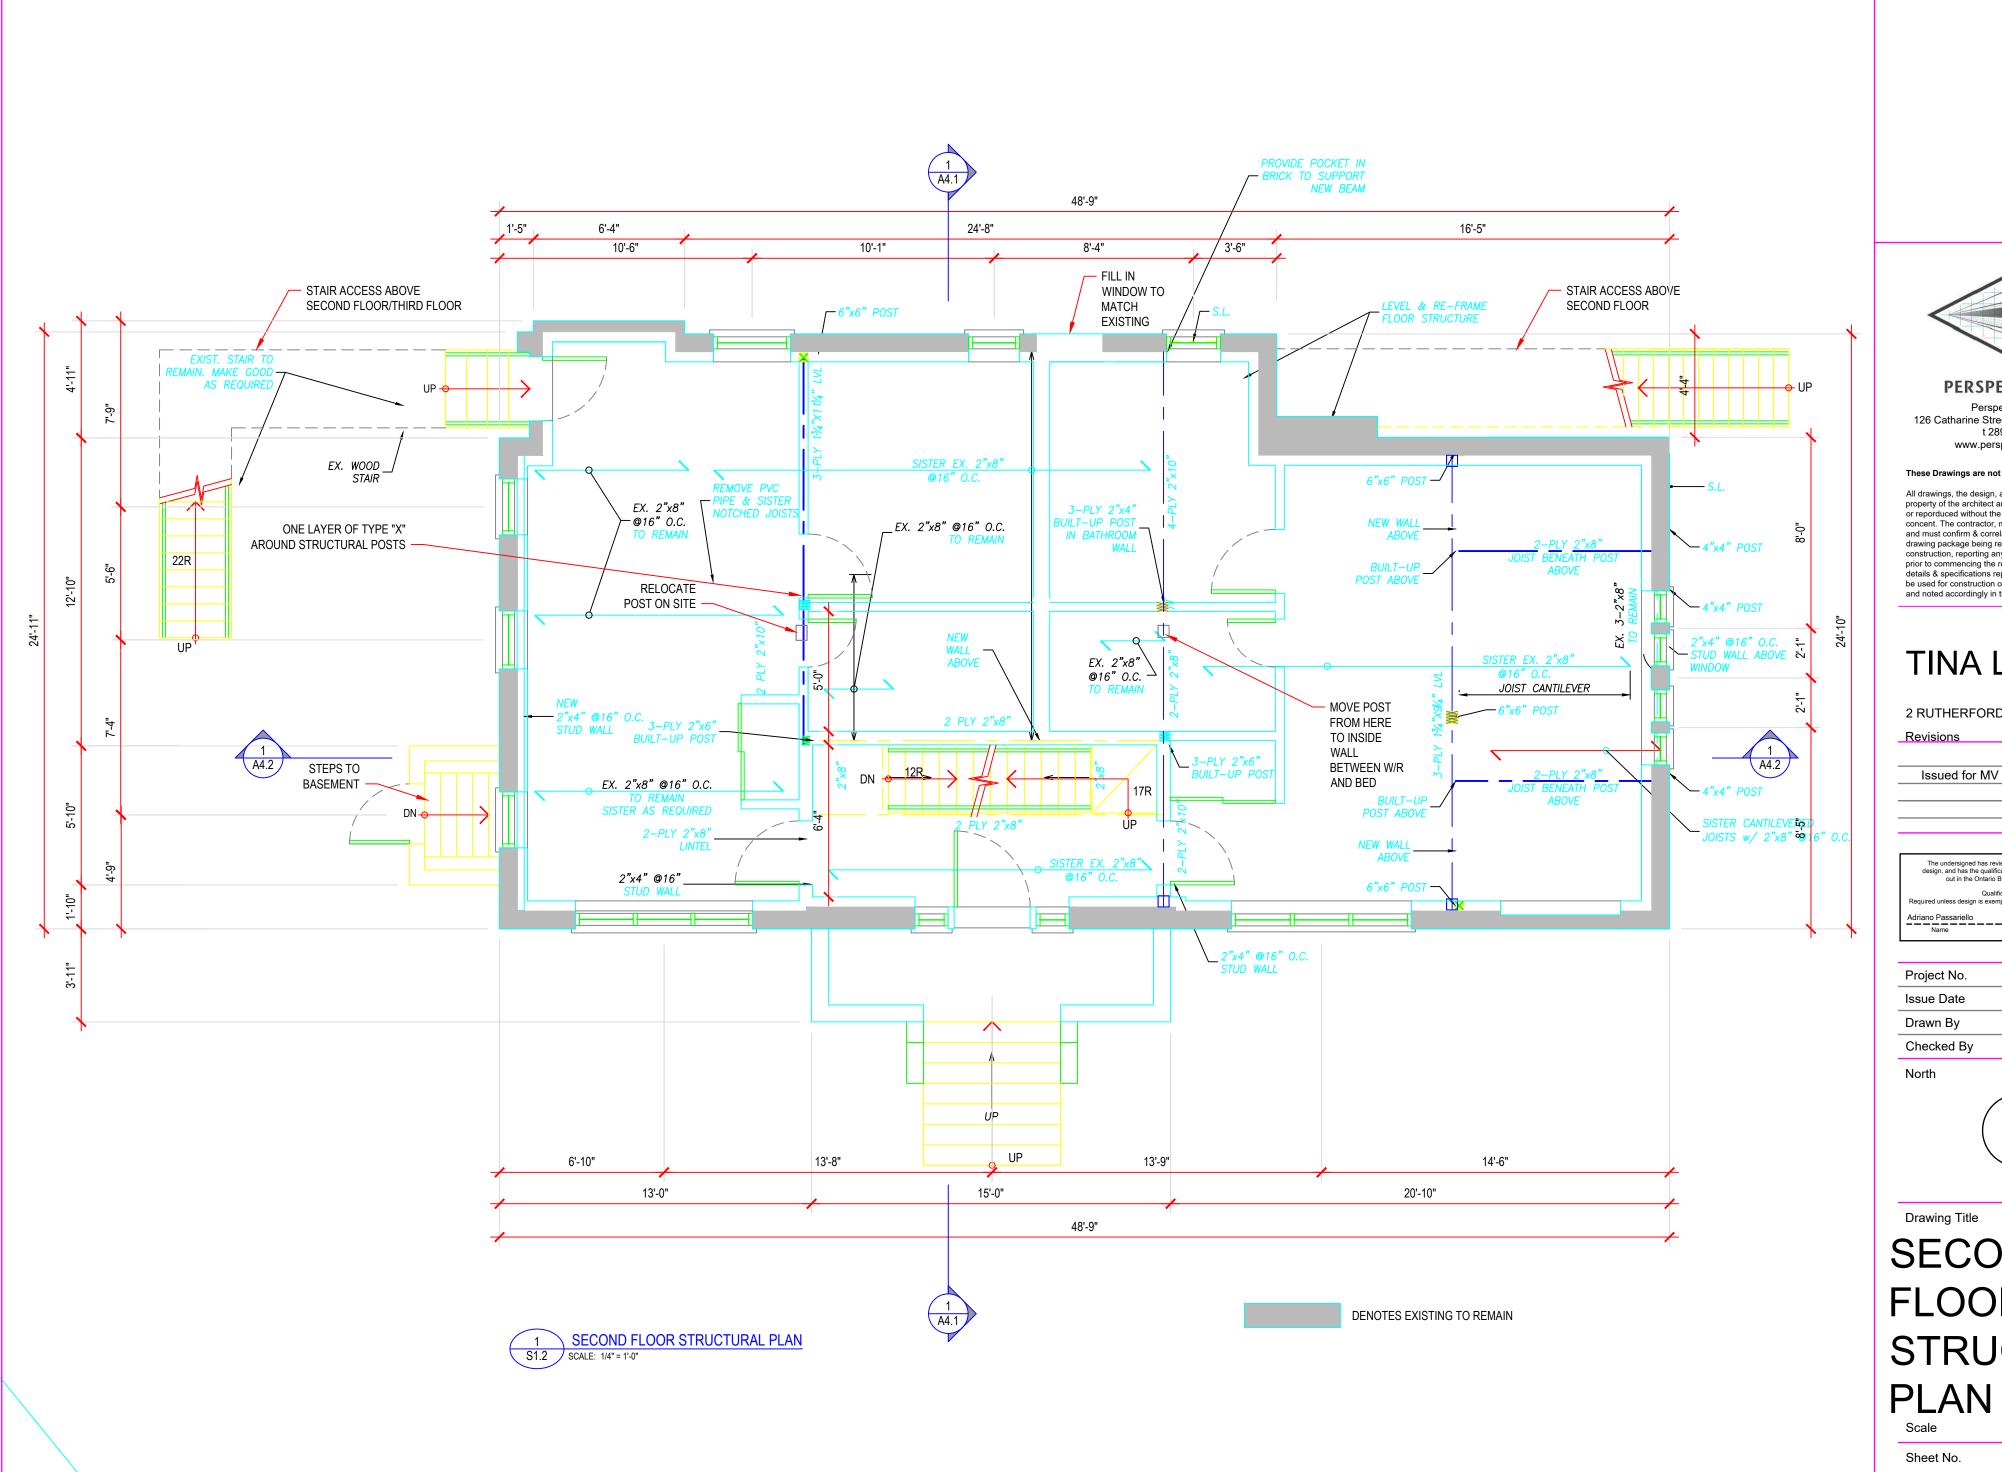



Perspective Views Inc. 126 Catharine Street N Hamilton, ON L8R 1J4 t 289.389.4502 www.perspectiveviews.com

### These Drawings are not to be scaled

All drawings, the design, and the details thereon remain the property of the architect and are not to be altered, re-used or reporduced without the designer's express written concent. The contractor, must field verify all dimensions and must confirm & correlate all details within the fill drawing package being responsible for same throughout construction, reporting any discrepancies to the designer prior to commencing the relevant work. All drawings, details & specifications represengted in the drawings are to be used for construction only when issued by the designer and noted accordingly in the "issue/revisions" box hereon.

### TINA LISTER

2 RUTHERFORD AVENUE, HAMILTON

Revisions

22/04/13

The undersigned has reviewed and takes responsibility for this design, and has the qualifications and meets the requirements set out in the Ontario Building Code to be a designer.


PV21-017 Project No. 15-12-2021 Issue Date JOSEPH FALZONE Drawn By Checked By MATTHEW RIBAU




Drawing Title

### SECOND **FLOOR** STRUCTURAL **PLAN**

S<sub>1.2</sub>

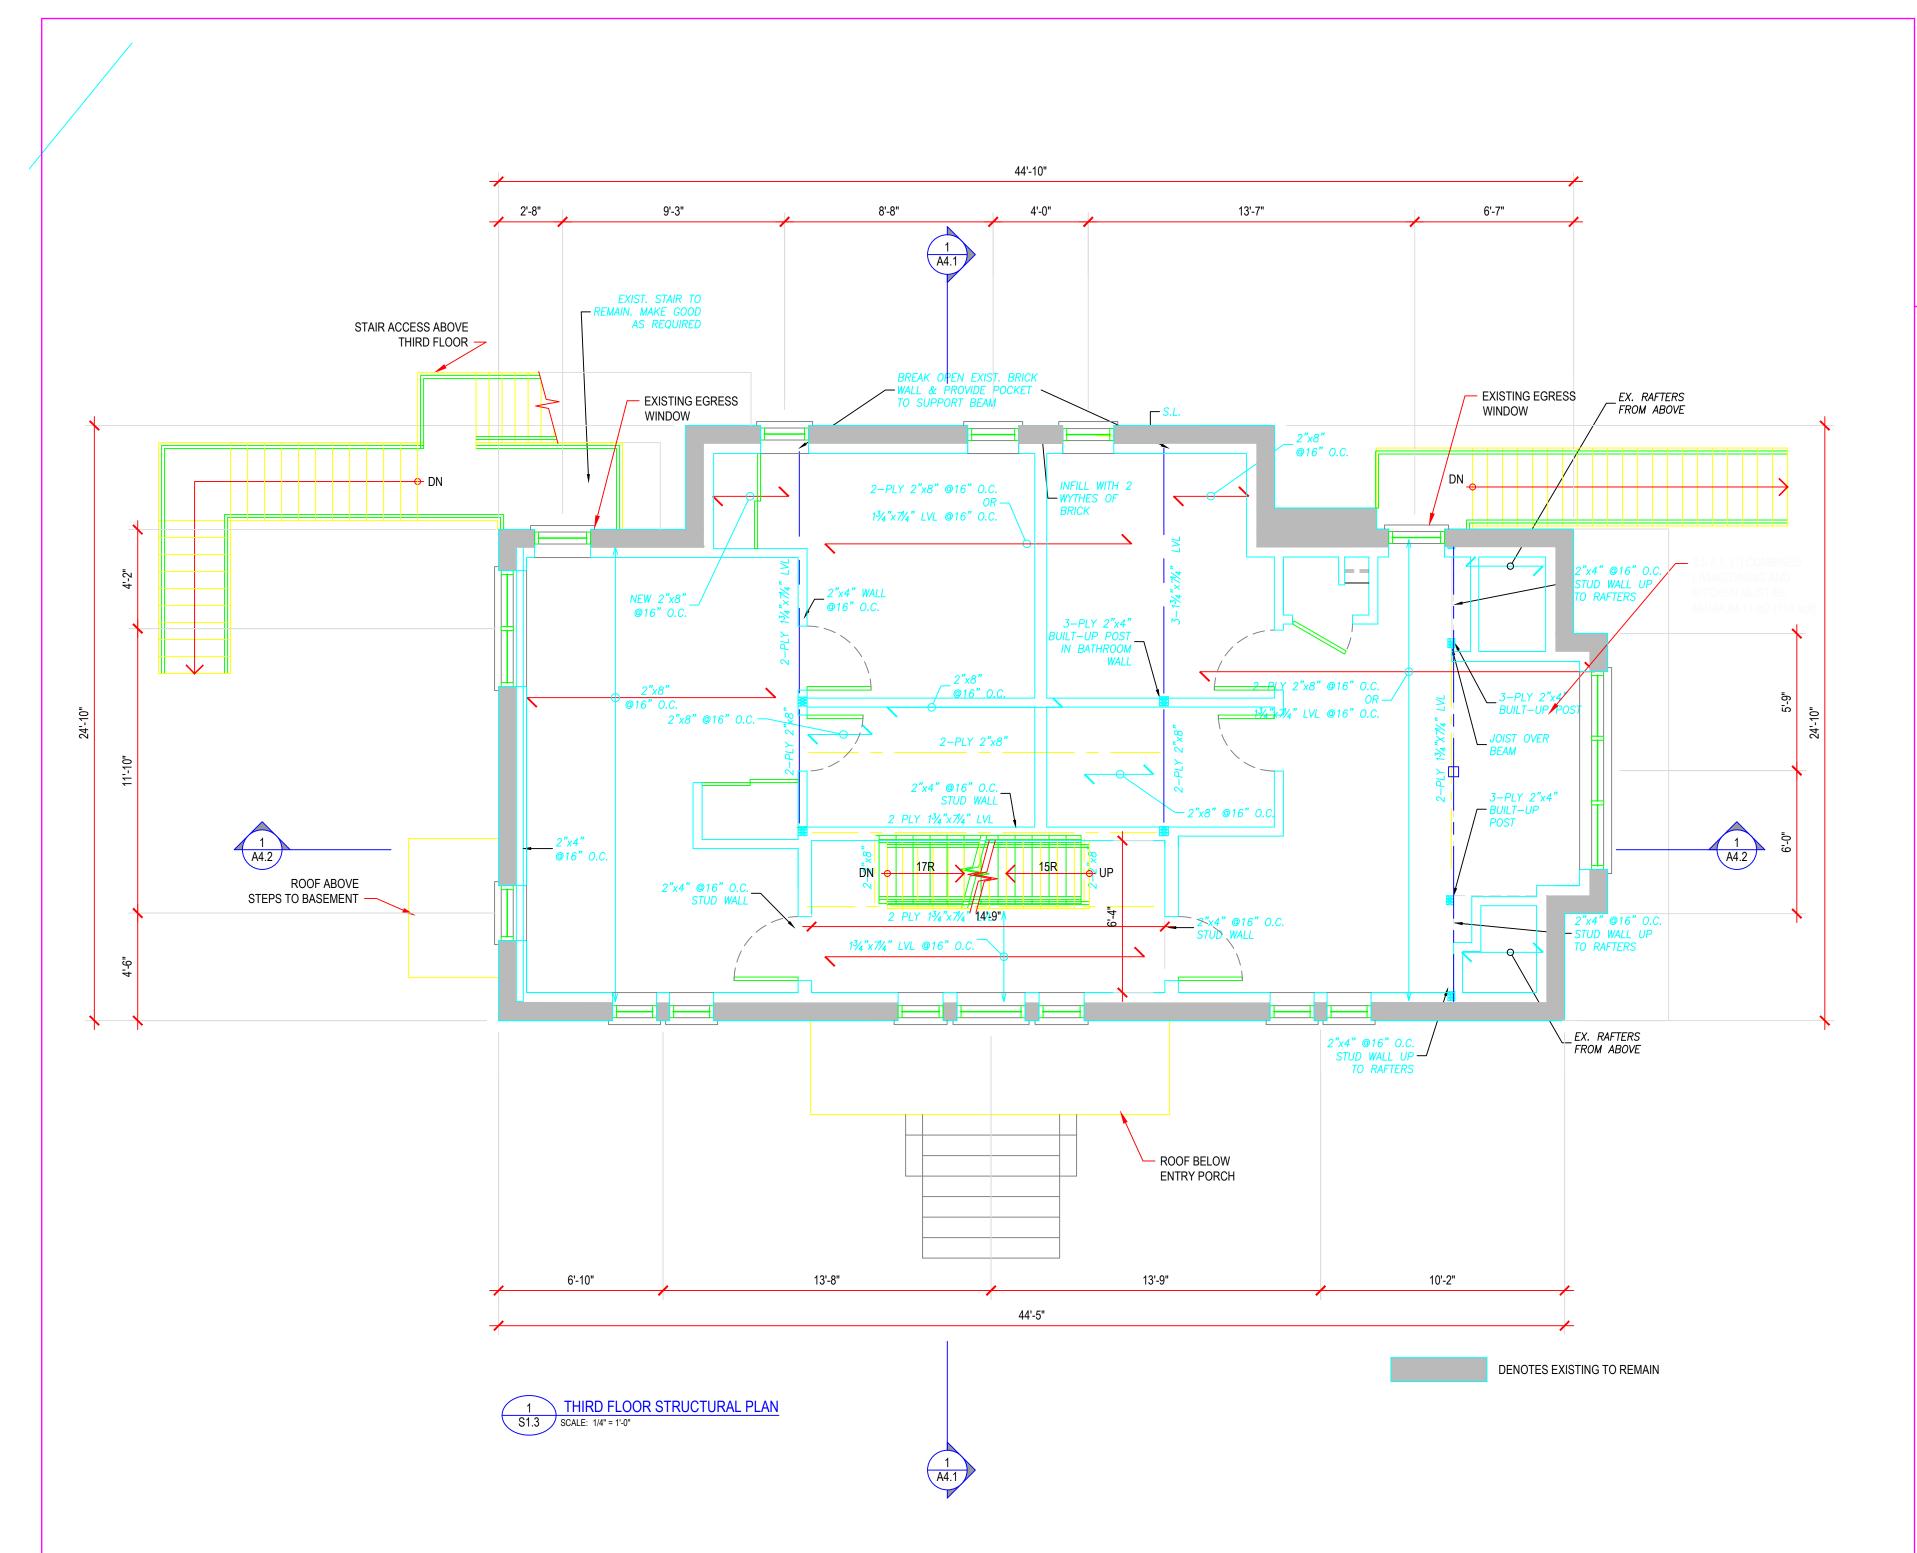

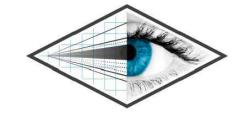

Perspective Views Inc. 126 Catharine Street N Hamilton, ON L8R 1J4 t 289.389.4502 www.perspectiveviews.com

#### These Drawings are not to be scaled

All drawings, the design, and the details thereon remain the property of the architect and are not to be altered, re-used or reporduced without the designer's express written concent. The contractor, must field verify all dimensions and must confirm & correlate all details within the fill drawing package being responsible for same throughout construction, reporting any discrepancies to the designer prior to commencing the relevant work. All drawings, details & specifications represengted in the drawings are to be used for construction only when issued by the designer and noted accordingly in the "issue/revisions" box hereon.

### TINA LISTER

2 RUTHERFORD AVENUE, HAMILTON

Revisions

Issued for MV 22/04/13

The undersigned has reviewed and takes responsibility for this design, and has the qualifications and meets the requirements set out in the Ontario Building Code to be a designer.

Qualification Information

Adriano Passariello 115278

Name Signature BCIN

Project No. PV21-017

Issue Date 15-12-2021

Drawn By JOSEPH FALZONE

Checked By MATTHEW RIBAU

North




Drawing Title

### THIRD FLOOR STRUCTURAL PLAN

Deale

Sheet N

S1.3

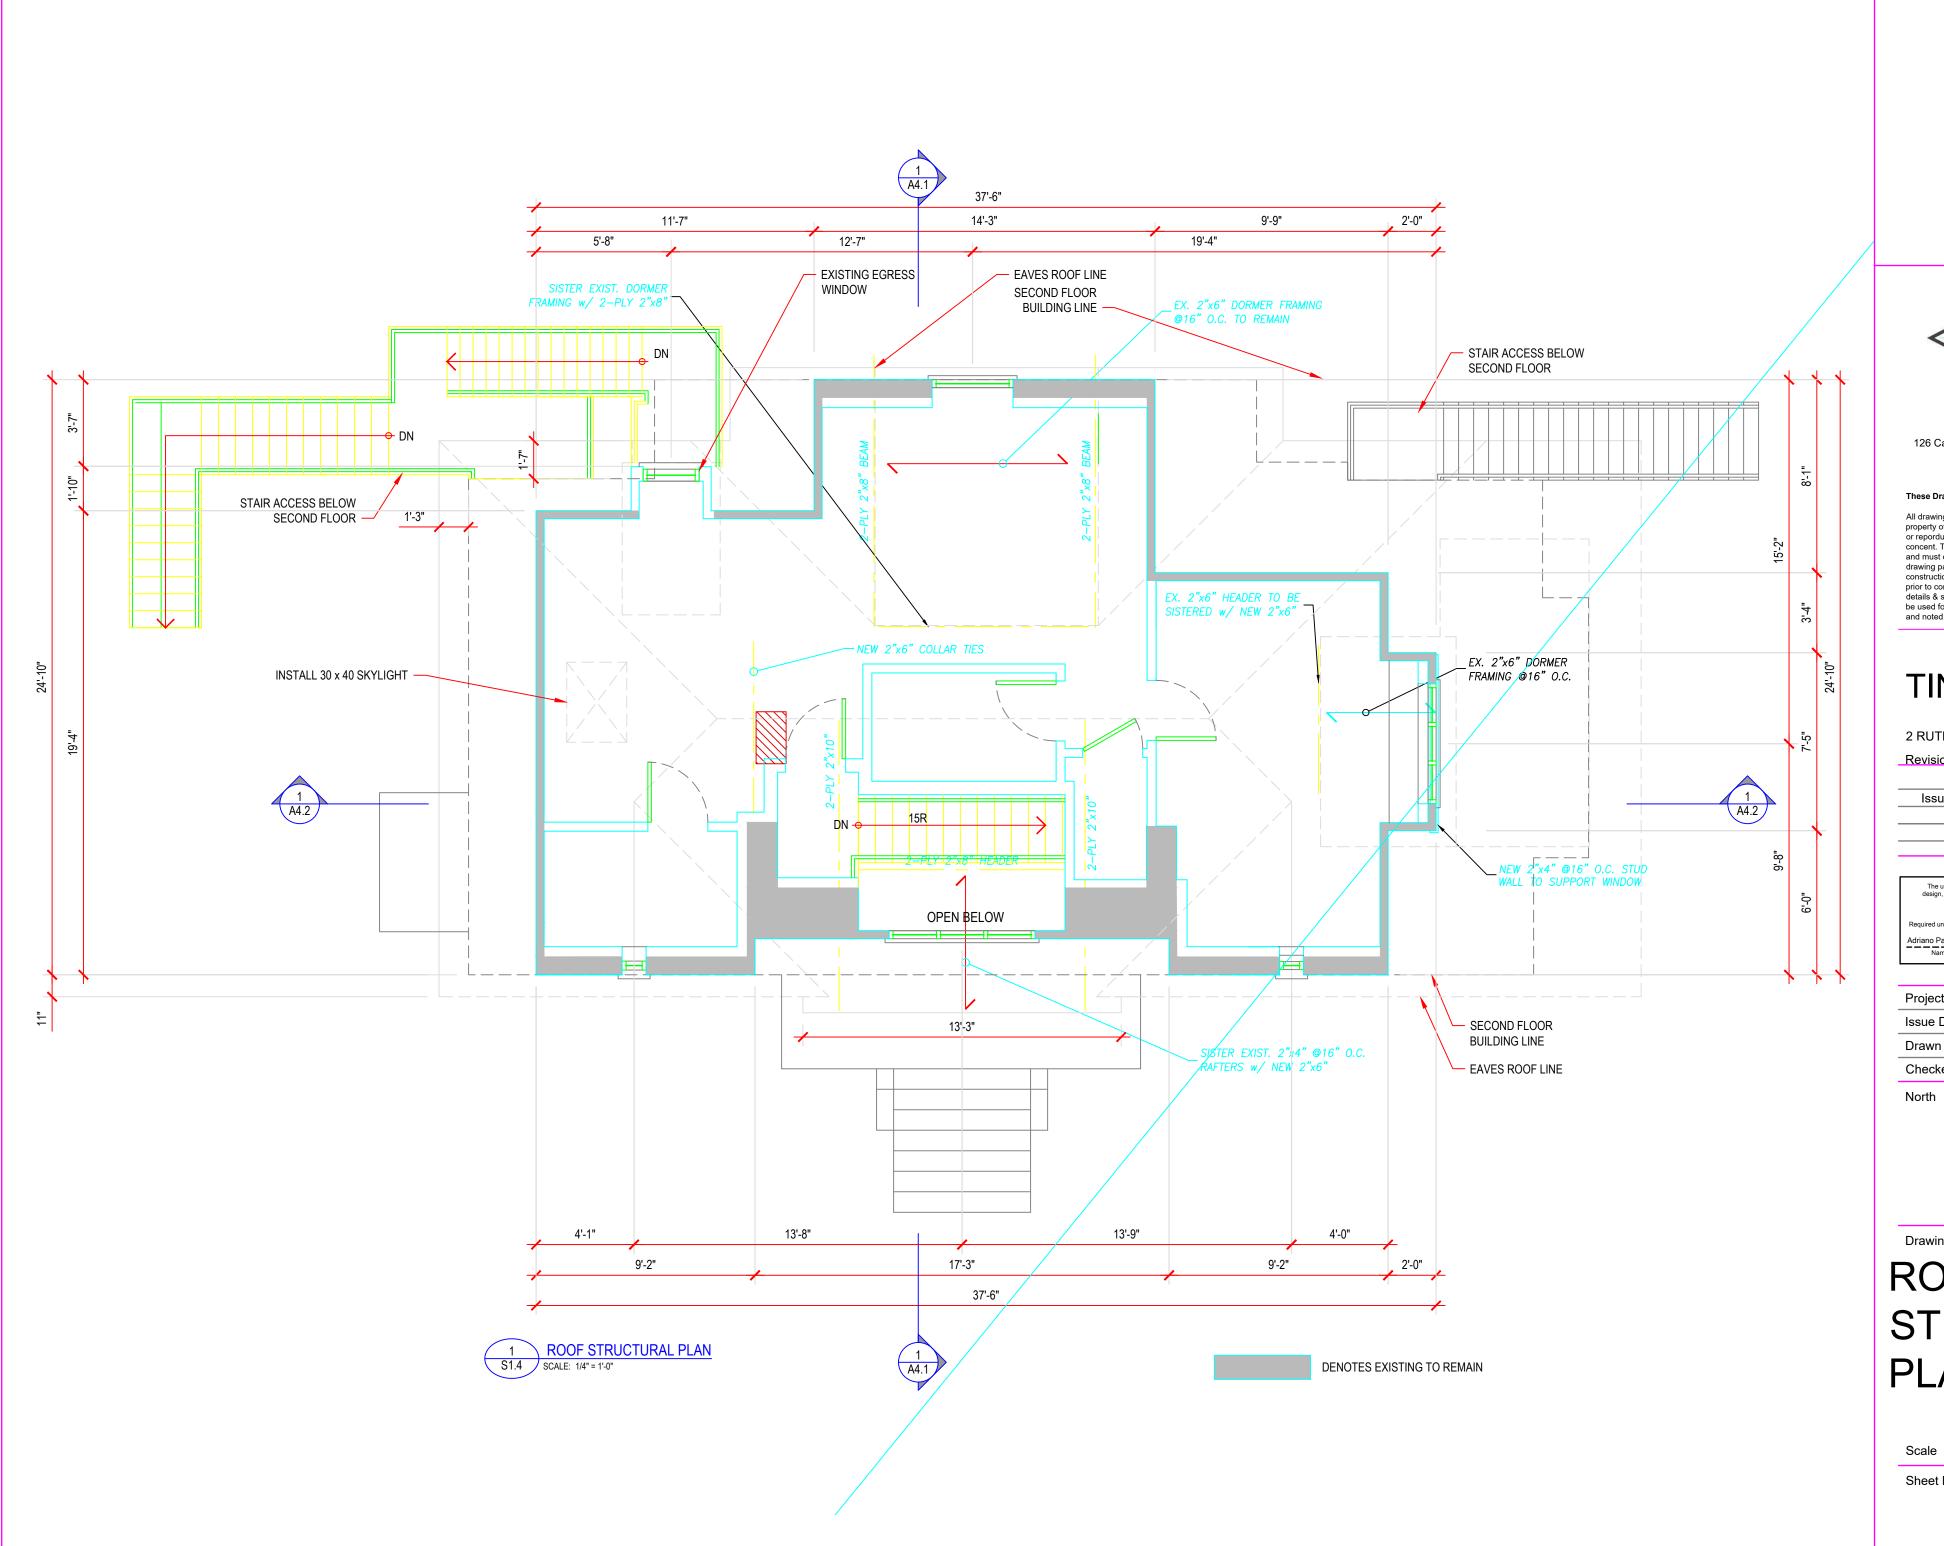



Perspective Views Inc. 126 Catharine Street N Hamilton, ON L8R 1J4 t 289.389.4502 www.perspectiveviews.com

### These Drawings are not to be scaled

All drawings, the design, and the details thereon remain the property of the architect and are not to be altered, re-used or reporduced without the designer's express written concent. The contractor, must field verify all dimensions and must confirm & correlate all details within the fill drawing package being responsible for same throughout construction, reporting any discrepancies to the designer prior to commencing the relevant work. All drawings, details & specifications represengted in the drawings are to be used for construction only when issued by the designer and noted accordingly in the "issue/revisions" box hereon.

### TINA LISTER

2 RUTHERFORD AVENUE, HAMILTON


Revisions

Issued for MV 22/04/13

The undersigned has reviewed and takes responsibility for this design, and has the qualifications and meets the requirements set out in the Ontario Building Code to be a designer. Adriano Passariello 115278

Name Signature BCIN

PV21-017 Project No. 15-12-2021 Issue Date JOSEPH FALZONE Drawn By Checked By MATTHEW RIBAU

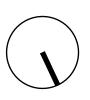

Drawing Title

### ROOF STRUCTURAL **PLAN**



**Committee of Adjustment** 

City Hall, 5<sup>th</sup> Floor, 71 Main St. W., Hamilton, ON L8P4Y5

Phone: (905) 546-2424 ext. 4221

Email: cofa@hamilton.ca

### **APPLICATION FOR A MINOR VARIANCE**

FOR OFFICE USE O	NLY.					
APPLICATION NO	DATE	APPLICATION RECEIVE	D			
PAID	DATE APPLICATION DEEMED COMPLETE					
SECRETARY'S SIGNATURE						
	The	Planning Act				
	Application for Mino	or Variance or for Permiss	ion			
	ning Act, R.S.O. 1990, Ch	ree of Adjustment for the Cit napter P.13 for relief, as des				
1, 2	NAME	MAILING ADDRESS				
Registered Owners(s)						
Applicant(s)*						
Agent or Solicitor						
any.	-	communications will be s				
3. Names and add		es, holders of charges or oth	er encumbrances:			

### Additional sheets can be submitted if there is not sufficient room to answer the following questions. Additional sheets must be clearly labelled

4.	Nature and extent of relief applied for:				
	We are extending the dormer in the second floor further out to match the existing wall below, and we are building it wider. This is to create appropriate space for the unit with the dormer. (Unit 202)				
	☐ Second Dwelling Unit ■ Reconstruction of Existing Dwelling				
5.	Why it is not possible to comply with the provisions of the By-law?				
	The renovation is within the building footprint, but the building footprint is outside the setbacks.				
6.	Legal description and Address of subject lands (registered plan number and lot number or other legal description and where applicable, <b>street and street number</b> ):				
	Address: 2 Rutherford Ave, Hamilton, ON L8M 1Y4 Roll Number: 03024200010 Bylaw Number: 76-229 Parent Bylaw Number: 6593 Former Hamilton Ward: 3 Zoning Description: Urban Protected Residential, Etc.				
7.	PREVIOUS USE OF PROPERTY				
	Residential Industrial Commercial				
	Agricultural  Vacant				
	Other				
8.1	If Industrial or Commercial, specify use				
8.2	Has the grading of the subject land been changed by adding earth or other material, i.e. has filling occurred?				
	Yes No Unknown				
8.3	Has a gas station been located on the subject land or adjacent lands at any time?  Yes ☐ No ■ Unknown ☐				
8.4	Has there been petroleum or other fuel stored on the subject land or adjacent lands?				
	Yes ☐ No ■ Unknown ☐				
8.5	Are there or have there ever been underground storage tanks or buried waste on the subject land or adjacent lands?				
	Yes ☐ No ■ Unknown ☐				
8.6	Have the lands or adjacent lands ever been used as an agricultural operation where cyanide products may have been used as pesticides and/or sewage sludge was applied to the lands?				
	Yes ☐ No ⊠ Unknown ☐				
8.7	Have the lands or adjacent lands ever been used as a weapon firing range?  Yes □ No ■ Unknown □				
8.8	Is the nearest boundary line of the application within 500 metres (1,640 feet) of the fill area of an operational/non-operational landfill or dump?				
	Yes ☐ No ■ Unknown ☐				
8.9	If there are existing or previously existing buildings, are there any building materials remaining on site which are potentially hazardous to public health (eg. asbestos, PCB's)?				
	Yes ☐ No ■ Unknown ☐				

8.10	Is there any reason to believe the subject land may have been contaminated by former uses on the site or adjacent sites?							
	Yes	No 🔳	Unkno	wn 🗌				
8.11	What information	did you use to d	etermin	e the answ	ers to 8.1	to 8.1	0 above?	
	The building and surrounded land		is reside	ential and l	nas been	for a v	ery long time	. The
8.12	If previous use of previous use inveland adjacent to the	ntory showing a	ll former	uses of th			•	
	Is the previous us	e inventory attac	ched?	Yes		No	x	
9.	ACKNOWLEDGE	EMENT CLAUS	E					
	I acknowledge that remediation of cor reason of its appro	ntamination on tl	he prop					
	April 26 2022	oval to this Appli	ication.	SIGNED	Chris Zavarise	Digitally signed to DNE CHICA Chief Erothrizzavanisel Residen   Jam the Locardian yours	ly Chris Zavanse Ons Zavanse Banazi com a subher of this document grang Yealen here this is a common	
	Date			Signature			r(s)	
				Chris Zav	arise			
				Print Nam	e of Owne	er(s)		
10.	Dimensions of lan	ds affected:Fror	ntage					
	Depth	7.82m	Ŭ					
	Area	10.51m						
	Width of street	270.35m2						_
10m 11. Particulars of all build <del>ings and structures on or proposed for the subject lands:</del> (Specify ground floor area, gross floor area, number of stories, width, length, etc.) Existing:_					•	— eight,		
	Main Floor: 105n 105m2 Stories: 2						2 Footprint:	
	Proposed							
	Main Floor: 105m 105m2 Stories: 2						n2 Footprint:	
12.	Location of all buil	•			ed for the	subjed	ct lands; (Spe	ecify
	Existing: Front: 2.31m(hou	uco) 0.11m/por	ob)					
	Rear: 0.48m Left: 4.93m	se) -o. i iiii(poid	ын) -					
	Right: 4.78m							
	Proposed:	100) 0.11m/nor	ch ovieti	ing)				
	Front: 2.31m(hou Rear: 0.48m	ъс) -∪. г пп(рого	ui,exist	iiig)				
	Left: 4.93m Right: 4.78m							

13.	Date of acquisition of subject lands: August 2018						
14.	Date of construction of all buildings and structures on subject lands:  TBD						
15.	Existing uses of the subject property (single family, duplex, retail, factory etc.):  Multi Family Dwelling (5 units)( maintaining 5 units)						
16.	Existing uses of abutting properties (single family, duplex, retail, factory etc.):  Single Family, Multi Family Dwellings						
17.	Length of time the existing uses of the subject property have continued:						
18.	Municipal services available: (check the appropriate space or spaces)  Water Yes  Connected Yes						
	Sanitary Sewer Yes Connected Yes						
10	Storm Sewers						
19.	Present Official Plan/Secondary Plan provisions applying to the land:						
20.	Present Restricted Area By-law (Zoning By-law) provisions applying to the land:						
	Bylaw Number: 76-229 Parent Bylaw Number: 6593						
21.	Has the owner previously applied for relief in respect of the subject property? (Zoning Bylaw Amendment or Minor Variance)      Yes  No						
	If yes, please provide the file number:  N/A						
	21.1 If a site-specific zoning by-law amendment has been received for the subject						
	property, has the two-year anniversary of the by-law being passed expired?						
	☐ Yes ☐ No						
	21.2 If the answer is no, the decision of Council, or Director of Planning and Chief Planner that the application for Minor Variance is allowed must be included. Failure to do so may result in an application not being "received" for processing.						
22.	Is the subject property the subject of a current application for consent under Section 53 of the <i>Planning Act</i> ?						
	☐ Yes     No						
23.	Additional Information (please include separate sheet if needed)						
	Latest Building Permit Submission: 2021 166351 000 00 R9 The proposed change in this Minor Variance does not extend the building footprint.						
24.	The applicant shall attach to each copy of this application a plan showing the dimensions of the subject lands and of all abutting lands and showing the location, size and type of all buildings and structures on the subject and abutting lands, and where required by the Committee of Adjustment such plan shall be signed by an Ontario Land Surveyor.						