

COMMITTEE OF ADJUSTMENT

City Hall, 5th floor, 71 Main Street West, Hamilton, ON L8P 4Y5
Telephone (905) 546-2424, ext. 4221, 3935

E-mail: cofa@hamilton.ca

NOTICE OF PUBLIC HEARING Minor Variance

You are receiving this notice because you are either:

- · Assessed owner of a property located within 60 metres of the subject property
- Applicant/agent on file, or
- Person likely to be interested in this application

| APPLICATION | HM/A-22:205 | SUBJECT | 95 CHEDOKE AVENUE, |
|-------------|----------------------|------------|---------------------------------|
| NO.: | | PROPERTY: | HAMILTON |
| ZONE: | "C" (Urban Protected | ZONING BY- | Zoning By-law former City of |
| | Residential) | LAW: | Hamilton 6593, as Amended Click |
| | · | | or tap here to enter text. |

APPLICANTS: Owners J. Hunter & B. Connolly

Agent Team Shane – L. Sayegh

The following variances are requested:

- A northly side yard width of 0.4m shall be provided instead of the minimum required 1.2m side yard width.
- 2. One (1) parking space shall be provided instead of the minimum required two (2) parking spaces.

PURPOSE & EFFECT: To permit the construction of a two-storey addition in the rear yard of the

existing single-family dwelling.

Notes:

i. Please be advised the variance to permit a reduced side yard width of 0.4 metres has been written as requested by the applicant based on the drawings provided the proposed addition is 0.7 metres from the northly side lot line.

This Notice must be posted by the owner of any land which contains seven or more residential units so that it is visible to all residents.

HM/A-22:205

This application will be heard by the Committee as shown below:

| DATE: | Thursday, July 28, 2022 |
|--------|--|
| TIME: | 3:10 p.m. |
| PLACE: | Via video link or call in (see attached sheet for details) |
| | To be streamed (viewing only) at |
| | www.hamilton.ca/committeeofadjustment |

For more information on this matter, including access to drawings illustrating this request and other information submitted:

- Visit www.hamilton.ca/committeeofadjustment
- Email Committee of Adjustment staff at cofa@hamilton.ca
- Call 905-546-CITY (2489) or 905-546-2424 extension 4221, 4130, or 3935

PUBLIC INPUT

Written: If you would like to submit written comments to the Committee of Adjustment you may do so via email or hardcopy. Please see attached page for complete instructions, <u>including deadlines</u> for submitting to be seen by the Committee.

Orally: If you would like to speak to this item at the hearing you may do so via video link, calling in, or attending in person. Please see attached page for complete instructions, including deadlines for registering to participate virtually.



HM/A-22:205

DATED: July 12, 2022

Jamila Sheffield, Secretary-Treasurer Committee of Adjustment Information respecting this application is being collected under the authority of the Planning Act, R.S.O., 1990, c. P. 13. All comments and opinions submitted to the City of Hamilton on this matter, including the name, address, and contact information of persons submitting comments and/or opinions, will become part of the public record and will be made available to the Applicant and the general public, and may include posting electronic versions.



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PARTICIPATION PROCEDURES

Written Submissions

Members of the public who would like to participate in a Committee of Adjustment meeting are able to provide comments in writing or via email in advance of the meeting. Comments can be submitted by emailing cofa@hamilton.ca or by mailing the Committee of Adjustment, City of Hamilton, 71 Main Street West, 5th Floor, Hamilton, Ontario, L8P 4Y5. Comments must be received by noon two days before the Hearing.

Comment packages are available two days prior to the Hearing and are available on our website: www.hamilton.ca/committeeofadjustment

Oral Submissions

Members of the public are also able to provide oral comments regarding Committee of Adjustment Hearing items by participating Virtually through Webex via computer or phone or by attending the Hearing In-person. Participation Virtually requires pre-registration in advance. Please contact staff for instructions if you wish to make a presentation containing visual materials.

1. Virtual Oral Submissions

Interested members of the public, agents, and owners <u>must register by noon the day</u> <u>before the hearing</u> to participate Virtually.

To register to participate Virtually by Webex either via computer or phone, please contact Committee of Adjustment staff by email cofa@hamilton.ca. The following information is required to register: Committee of Adjustment file number, hearing date, name and mailing address of each person wishing to speak, if participation will be by phone or video, and if applicable the phone number they will be using to call in.

A separate registration for each person wishing to speak is required. Upon registering for a meeting, members of the public will be emailed a link for the Webex meeting the Wednesday afternoon before the hearing. The link must not be shared with others as it is unique to the registrant.

2. In person Oral Submissions

Interested members of the public, agents, and owners who wish to participate in person must sign in at City Hall room 222 (2nd floor) no less than 10 minutes before the time of the Public Hearing as noted on the Notice of Public Hearing.

We hope this is of assistance and if you need clarification or have any questions, please email cofa@hamilton.ca or by phone at 905-546-2424 ext. 4221.

Please note: Webex (video) participation requires either a compatible computer or smartphone and an application (app/program) must be downloaded by the interested party in order to participate. It is the interested party's responsibility to ensure that their device is compatible and operating correctly prior to the Hearing.

RENOVATION TO: HUNTER

95 CHEDOKE AVENUE Hamilton ON L8P 4P2

GENERAL NOTES

1. O.B.C. TO BE UNDERSTOOD AS ONTARIO BUILDING CODE 2012 LATEST EDITION AND

2. ALL STAGES OF CONSTRUCTION SHALL CONFORM WITH O.B.C.

3. DO NOT SCALE DRAWINGS. 4. CONTRACTOR TO REVIEW AND VERIFY ALL DIMENSIONS PRIOR
TO AND DURING CONSTRUCTION. ALL DISCREPANCIES TO BE REPORTED TO DESIGNER.

5. ALL WALL & CEILINGS BETWEEN DWELLING UNIT AND GARAGE ARE TO BE GAS PROOFED AND INSULATED TO ENERGY EFFICIENCY SUMMARY 6. SEE ELEVATIONS AND FLOOR PLANS FOR WALL

AND CEILING HEIGHTS. ANY DISCREPANCIES TO BE

7. WOOD IN CONTACT WITH CONCRETE OR MASONRY TO BE SEPARATED WITH MINIMUM 2 MIL. POLY UNLESS OTHER WISE NOTED ON DRAWINGS.

REPORTED TO DESIGNER.

8. UNDERCUT ALL DOORS TO ROOMS WITHOUT 9. SMOKE AND CO.DETECTORS TO BE LOCATED AT EACH LEVEL. SMOKE ALARMS LOCATED IN EACH

BEDROOM AND ARE TO BE INTERCONNECTED.

10. ALL LIGHTING AND ELECTRICAL AS PER O.B.C. 11. PROVIDE SUMP PIT AND SEALED PIT COVER FOR

12. ATTIC ACCESS TO BE INSULATED MIN. R20 AND WEATHER STRIPPED.

13. WHERE CERAMIC FLOORING IS INSTALLED THE SUB-FLOOR SHALL BE REINFORCED AS PER O.B.C. 14. HVAC DRAWINGS TO BE DESIGNED BY OTHERS AS PER O.B.C. DRAWINGS TO BE PROVIDED TO TBOUMA DESIGN AND DRAFTING PRIOR TO FINALIZED WORKING DRAWINGS. DRAWINGS NOT FOR APPROVAL JUST TO BE PROPERLY

INCORPORATED INTO PLANS AND ON RECORD. 15. HRV / ERV TO BE BALANCE POST CONSTRUCTION

16. PROVIDE MIN. 6'-5" HEADROOM BELOW ALL BEAMS & DUCTWORK. 17. ALL EXHAUST FANS TO BE VENTED TO EXTERIOR. 18. VENTED RANGE HOODS TO BE VENTED TO EXTERIOR
WITH NON-COMBUSTIBLE DUCTING

MASONRY

1. ALL FLASHING TO CONFORM TO O.B.C. 9.20.13. 2. ALL BRICK OR STONE SILLS TO BE FLASHED IN ACCORDANCE WITH THE O.B.C. ALL STEEL LINTELS FOR MASONRY TO HAVE
MINIMUM 6" BEARING EACH END AND SUPPORTED
BACK TO FOUNDATION

DESIGNER

 REGISTRATION:
 NAME OF REGISTRATION FIRM TBOUMA DESIGN
 SIGNATED OR WOOD WITH STORM DOOR WITH INC. REGISTRATION NUMBER ASSIGNED BY DIRECTOR 104857 2. CONTRACTOR IS TO OBTAIN QUALIFIED

BE WEATH
DESIGNERS FOR ALL ENGINEERED
STRUCTURAL MEMBERS AND SYSTEMS WHERE
DEVICE. INDICATED DESIGNED BY OTHERS ON

DRAWINGS FOR FAILURE OF THE CONTRACTOR OR SUB-CONTRACTOR TO CARRY OUT THE WORK IN ACCORDANCE WITH THESE DRAWINGS

DIMENSIONS ON THE WORKING DRAWING SET.
ANY DISCREPANCIES ARE TO BE REPORTED TO THE DESIGNER PRIOR TO COMMENCEMENT OF WITH NO DIMENSION LESS THAN 15".

NOT BE MADE WITHOUT AGREEMENT BETWEEN
DESIGNER AND CONTRACTOR.

WIEWER UNLESS TRANSPARENT GLAZ.
PROVIDED IN DOOR OR A SIDELIGHT. DOCUMENTATION SHALL BE THE ONLY FORM OF ACCEPTANCE.

8. UNDERCUT ALL DOORS TO ROOMS WITHOUT RETURN AIR INLET.

CHANGES ARE TO BE MADE THE BUILDING DEPARTMENT WILL BE NOTIFIED FOR PURPOSE OF REVIEW PRIOR TO CONSTRUCTION. 8. UNDER NO CIRCUMSTANCE SHALL THE CONTRACTOR OR SUB-CONTRACTOR PROCEED IF THERE IS ANY UNCERTAINTY. DESIGNER SHALL BE CONTACTED.

STRUCTURAL

1. ALL LUMBER TO COMPLY WITH O.B.C SPECIFICATIONS AND STANDARDS.

9. THE DRAWINGS THAT ARE APPROVED AND STAMPED BY THE BUILDING DEPARTMENT ARE TO BE THE ONLY TRUE DRAWINGS AND ARE TO BE ACCESSIBLE TO ALL CONTRACTORS AND SUB-CONTRACTORS AT ALL TIMES WITH-IN THE LODGE STEET THE ALL WORK IS COMPLETED. JOB SITE TILL ALL WORK IS COMPLETED.

1. ALL STAIR COMPONENTS TO CONFORM TO • MIN. RUN = 8 1/4" • MIN TREAD = 9 1/4" • MIN. NOSING = 1"

• UNIFORM RISE / RUN

• MIN. WIDTH = 2'-10"

GUARDS:
• MIN. HEIGHT = 36"

 NON-CLIMBABLE EXTERIOR GUARDS:
• 2'-0" TO 5'-11" ABOVE FINISHED GRADE
• MINIMUM HEIGHT = 36" MINIMUM HEIGHT = 42"

ALL GUARDS TO BE CONSTRUCTED TO O.B.C. 9.8.8

DOORS AND WINDOWS

2. DOOR BETWEEN GARAGE AND DWELLING TO BE WEATHER STRIPPED AND GAS TIGHT EXTERIOR TYPE DOOR WITH SELF CLOSING

3. DOOR AT COLD STORAGE TO BE EXTERIOR 4. ALL WINDOWS AND DOORS AS PER ENERGY EFFICIENCY DESIGN SUMMARY OR ATTACHED BOP BY OTHERS.

4. SINGLE PAGES OF THESE DRAWINGS NOT TO BE READ INDEPENDENTLY OF ALL PAGES OF THE WHOLE DRAWING SET.

5. ALL EXTERIOR DOORS AND WINDOWS TO COMPLY WITH FORCED ENTRY REQUIREMENTS. O.B.C. 9.7.5.2. AND 9.7.6. 5. CONTRACTOR SHALL CHECK AND VERIFY ALL 6. FLOOR LEVELS CONTAINING BEDROOMS TO HAVE ONE OPERABLE WINDOW WITH A MINIMUM UNOBSTRUCTED OPEN AREA OF 3.8 SQ, FT,

6. ANY MODIFICATIONS TO THE DESIGN SHALL

VIEWER UNLESS TRANSPARENT GLAZING IS

7. WHEN DRAWINGS ARE TO BE MODIFIED OR 9. WINDOW VALUES REFER TO FLOOR PLAN EFFICIENCY SUMMARY

2. ALL STRUCTURAL LUMBER TO BE OF SPRUCE #2 OR BETTER.

TRUSS DESIGN AND LAYOUT TO BE DESIGNED BY OTHERS AND CONFORM TO O.B.C SPECIFICATIONS ALL DRAWINGS TO BE PROVIDED TO TBOUMA DESIGN AND DRAFTING, NOT FOR APPROVAL JUST TO BE PROPERLY INCORPORATED INTO PLANS AND ON RECORD. 4. AS NOTED ON DRAWINGS STUDS TO BE USED AS BEARING POINTS WHERE IT IS APPLICABLE. 5. ALL BEAMS TO HAVE MINIMUM 3 1/2" BEARING AT BOTH ENDS BEARING TO BE CONTINUOUS TO FOUNDATION

6. DOUBLE JOISTS AROUND STAIRWELL UNLESS OTHER WIDE NOTED BY PRE-ENGINEERED FLOOR DESIGNER.

FOUNDATION

CONTRACTOR TO VERIFY SOIL CONDITIONS
PRIOR TO PLACING OF FOOTINGS. ANY
ABNORMALITIES TO BE REPORTED TO
DESIGNER

2. STEP FOOTINGS TO BE DESIGNED AS PER O.B.C. 9.15.3.9.

• MAX RISE SHALL NOT EXCEED 23 5/8"

• MIN RUN SHALL NOT BE LESS THAN 23 5/8" 3. ALL FOOTINGS TO BEAR ON FIRM UNDISTURBED SOIL MIN. 4'-0" BELOW FINISHED GRADE AND MIN. BEARING CAPACITY OF 75 KPa 4. WALL HEIGHTS AND THICKNESS TO CONFORM TO O.B.C. 9.15.4.








| NO. | REVISION | DATE |
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| 1 | DESIGN 1.0 | 2022.02.22 |
| 2 | DESIGN 2.0 | 2022.03.22 |
| 3 | DESIGN 3.0 | 2022.04.29 |
| 4 | ISSUED FOR VARIANCE | 2022.05.31 |
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TITLE SHEET / GENERAL INFO

> PROJECT: HUNTER

PROJECT ADDRESS: 95 CHEDOKE AVENUE Hamilton ON L8P 4P2

DATE: 6/9/2022 DRAWING NO: AS NOTED PROJECT NO:

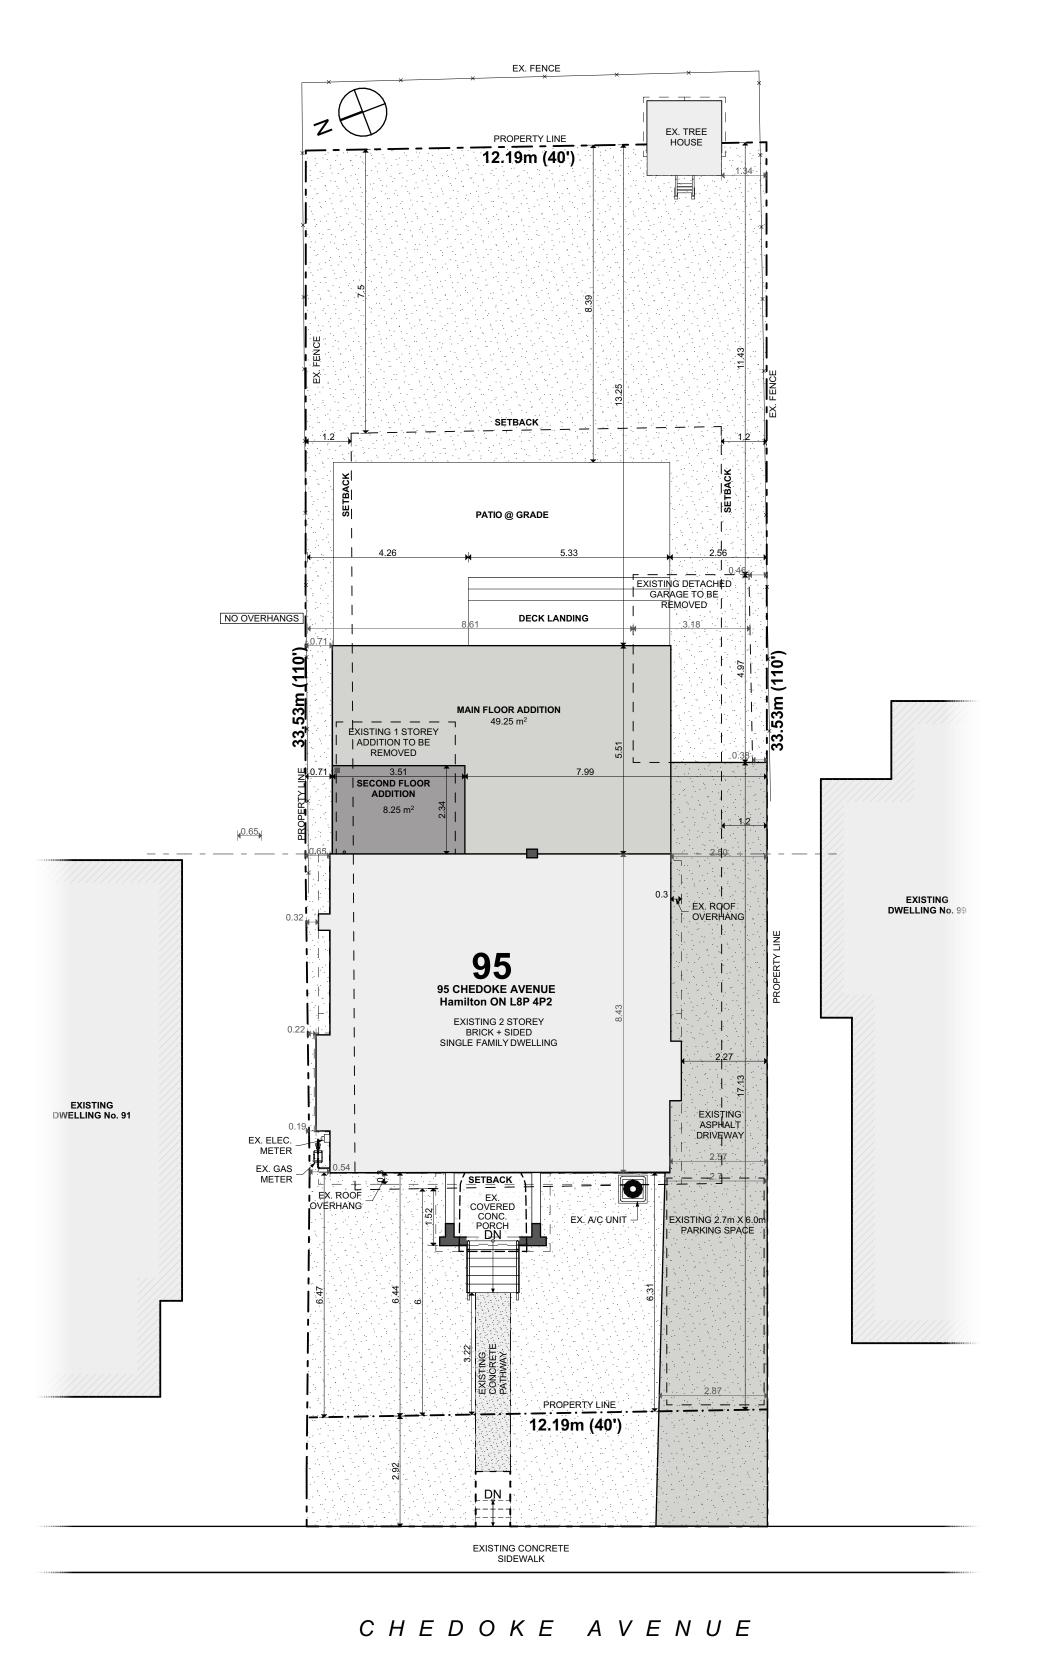

SITE PLAN LEGEND

EXISTING DWELLING

NEW ADDITIONS

COVERED PORCHES

DECK / PATIO

LANDSCAPE AREA

HARDSCAPE AREA

DRIVEWAY

- - - MUNICIPAL SETBACKS

PROPERTY LINE

EXISTING TO BE

REMOVED

----- HOUSE FOOTPRINT

SITE INFORMATION ADDRESS: 95 CHEDOKE AVENUE POSTAL CODE: L8P 4P2 MUNICIPALITY: HAMILTON BYLAW #: ZONING CODE:C SITE SPECIFIC BYLAW: MINOR VARIANCE #: ---LOT INFO LOT AREA (m²) LOT FRONTAGE LOT WIDTH (m) LOT DEPTH (m)
 Allowable
 Existing
 Proposed

 360
 408
 SAME

 12
 12.19
 SAME

 n/a
 12.19
 SAME

 n/a
 33.53
 SAME
 HOUSE INFO GROSS FLOOR AREA (m²) Allowable Existing Proposed n/a 228.6m2 296.91m2 Gross floor area calculations

Basement area:

Main floor area: 816sf / 75.8m2 1079sf / 100.24m2 944sf/87.7m2 1358sf/126.16m2 701sf/65.1m2 759sf/70.51m2 2461sf/228.6m2 3196sf/296.91m2 Second floor area: Area of all floors excluding the following:

1. 100sf for laundry if possible

2. 70sf for mechanical if possible

3. Attic spaces

4. Any area that is uninhabitable GROUND FLOOR AREA (m²) n/a 87.7 126.16
COVERAGE (%) n/a 26.6% 31%

Includes Accessory structures over 10sm gfa, all buildings measured to the outside of the walls, including cantilevered floor space and window projections

Excludes Carports, porches, decks, accessory structure under 10sm FLOOR AREA RATIO(%) n/a 56% 72.69% BUILDING HEIGHT (m) Burlington ONLY Max hgt. from clg. to t/o roof or flat roof n/a n/a 11.9 13.94 BUILDING DEPTH (m) <u>Definition:</u> from building wall closest to front line to building wall closest to the rear lot line GARAGE PROJECTION (m) GARAGE WIDTH (m) LANDSCAPING
LANDSCAPE AREA (%)
STREET WIDTH (m)
DRIVEWAY WIDTH (m)
PARKING SPACES Existing 64.4% 7.6 2.7 SAME SAME SAME SAME 2 9 Parking space sizing as follows: Hamilton: 2.7m x 6.0m, Burlington: 2.7m x 6.0m Parking Spaces Required is based on the amount of habitable rooms in Hamilton. (2) parking spaces are required for the first (8) habitable rooms. Every extra room requires an additional (0.5) parking space (rounding up always) SETBACKS FRONT (m) REAR (m) RIGHT (m) CORNER (m) ENCROACHMENTS
ROOF PROJECTION (m) Front & Rear Overhang including gutter Side

ARCHITECTURAL FEATURES (m) BAY WINDOW (m) PORCH - COVERED (m) PORCH - OPEN (m) DECK (m) ACCESSORY BUILDINGS

SIZE (m²)
HEIGHT (m)
SIDE/REAR SETBACK (m)
COVEDAGE (%)
 Allowable
 Existing
 Proposed

 n/a
 21m2
 n/a

 4
 2.4
 n/a

 0.45
 0.15/12.81
 n/a

 n/a
 5.1%
 n/a

 n/a
 n/a
 n/a
 MAX # OF STRUCTURES ZONING + PERMIT APPROVALS
MINOR VARIANCE (Refer to above)
CONSERVATION AUTHORITY
Region: Hamilton Required? YES NIAGARA ESCARPMENT CONTROL NO MINISTRY OF TRANSPORTATION ONTARIO Proximity to major highways. Use online mapping to determine SITE PLAN CONTROL / EXEMPTION ENVIRONMETAL SITE ASSESSMENT GREENBELT PROTECTED COUNTRYSIDE HERITAGE
PARKWAY BELT
FEDERAL AIRPORT AUTHORITY
SEPTIC
SURVEY REQ'D?





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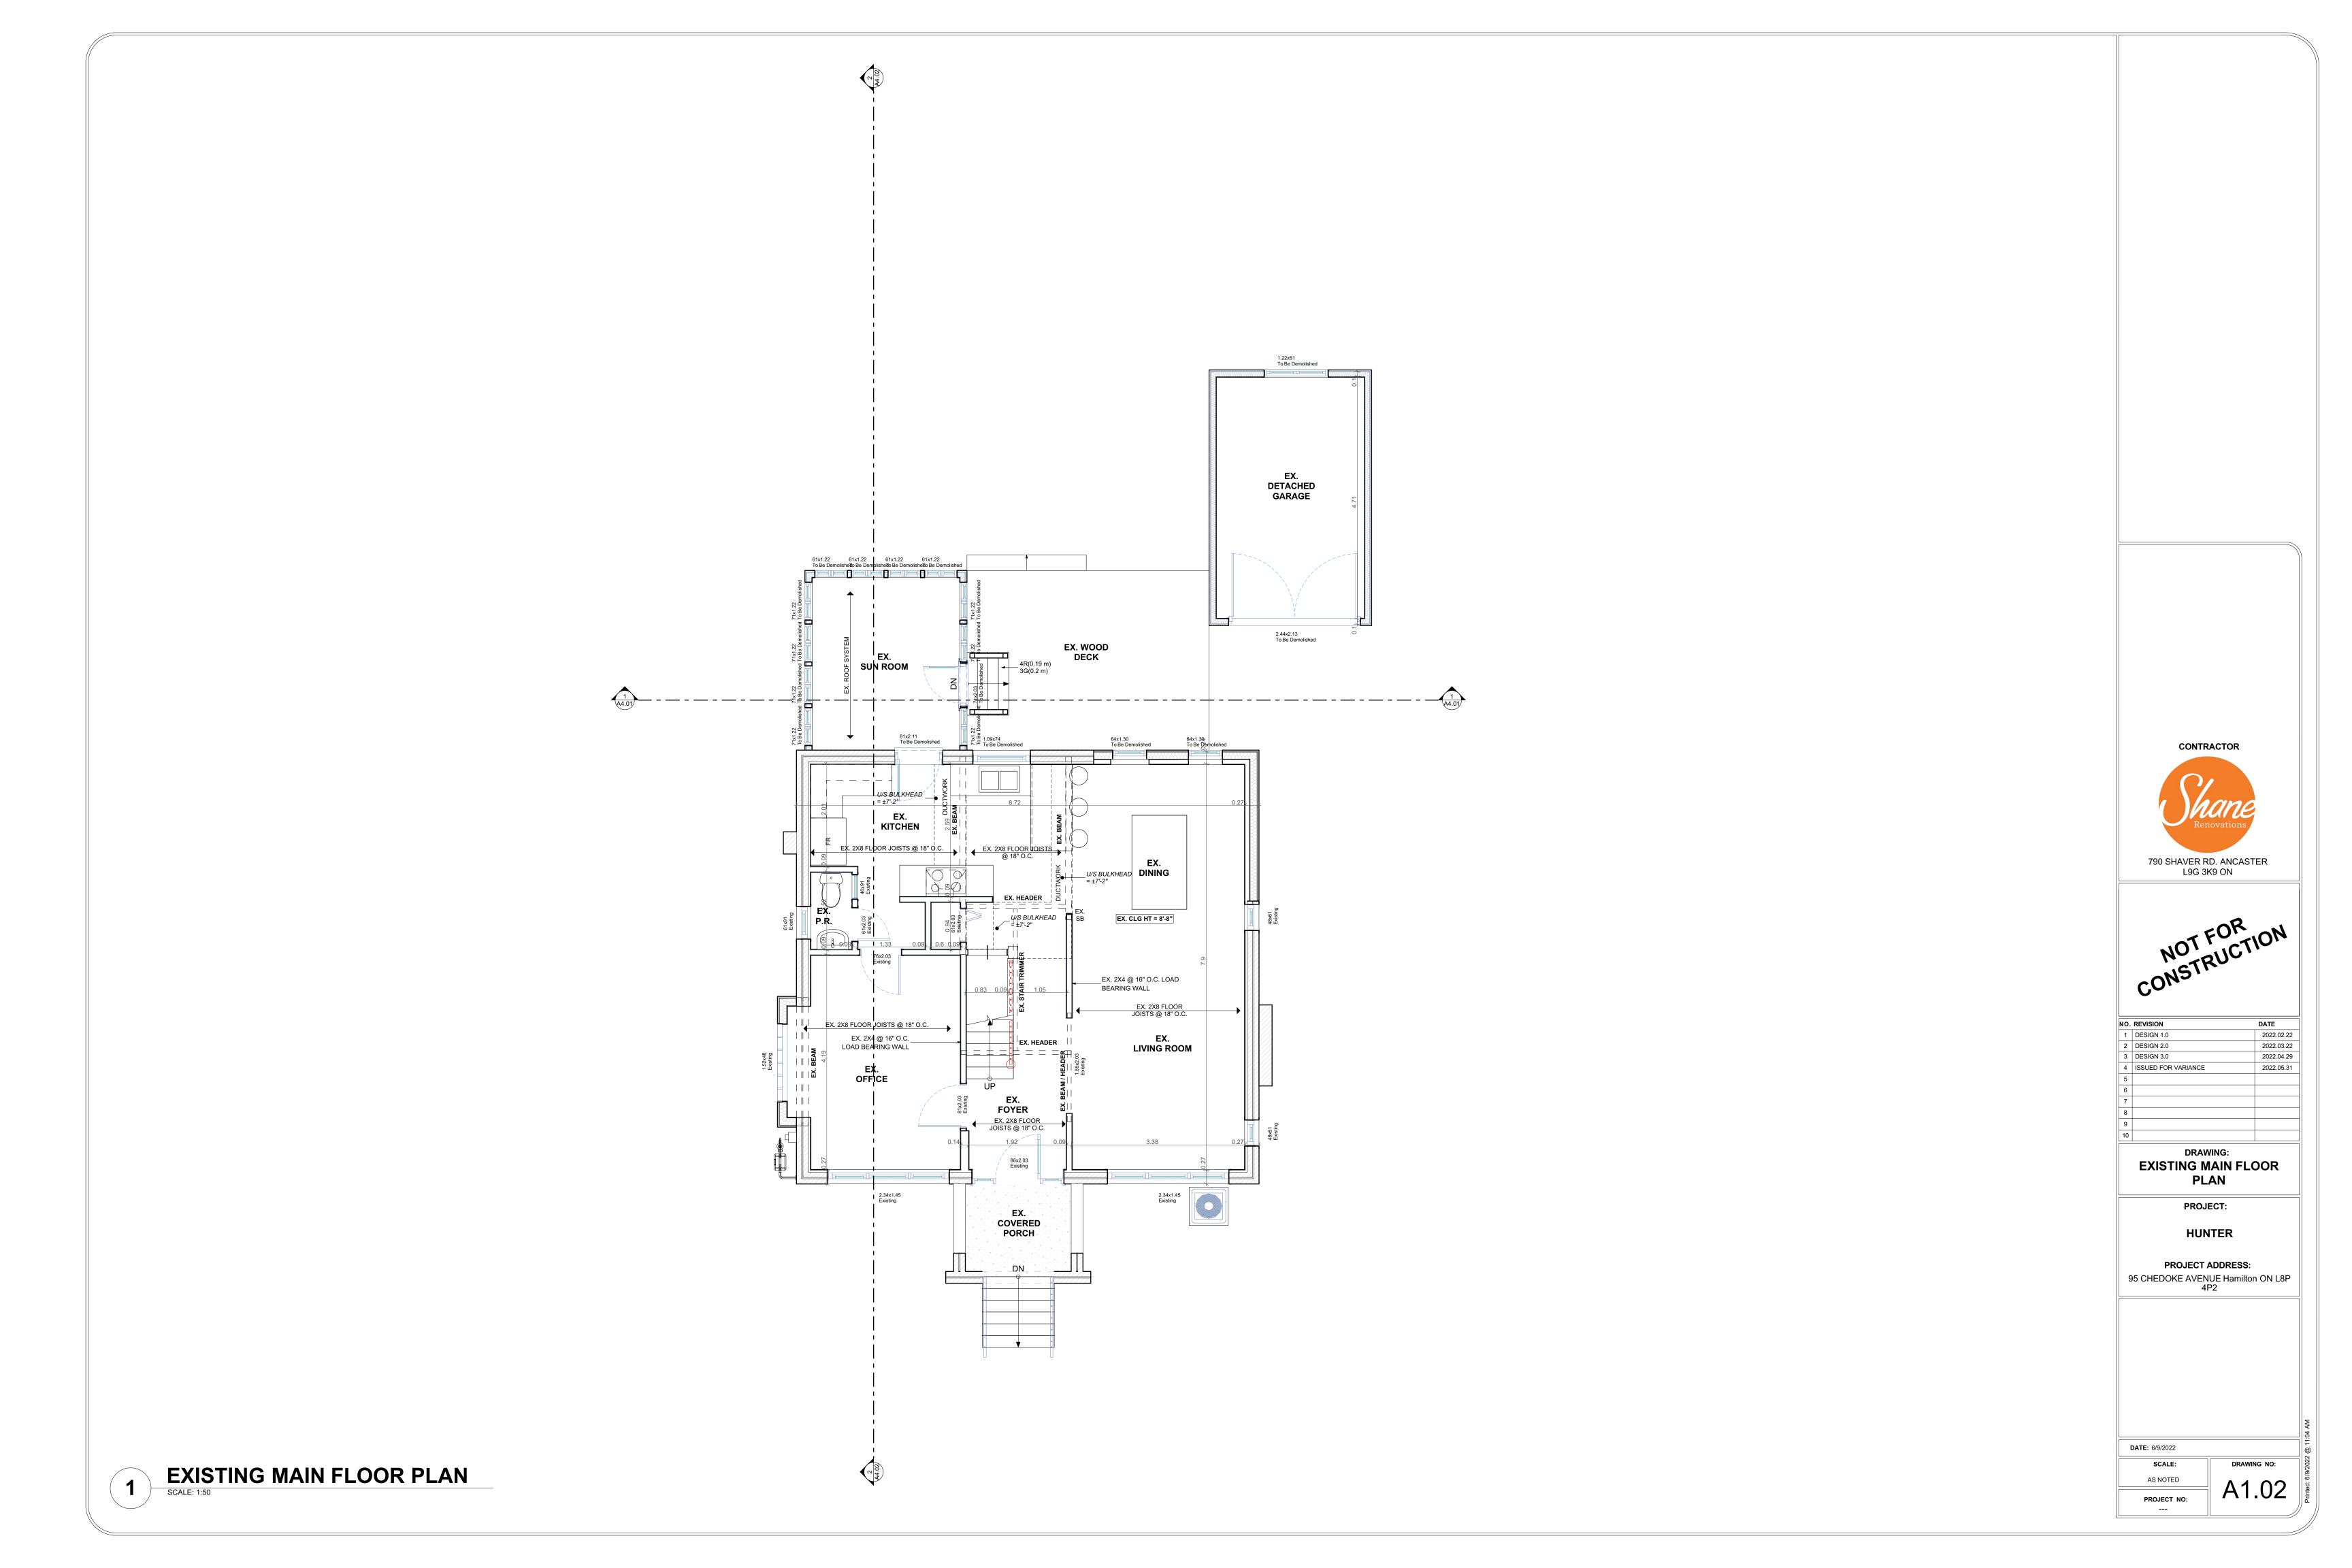
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| 3 | DESIGN 3.0 | 2022.04.29 |
| 4 | ISSUED FOR VARIANCE | 2022.05.31 |
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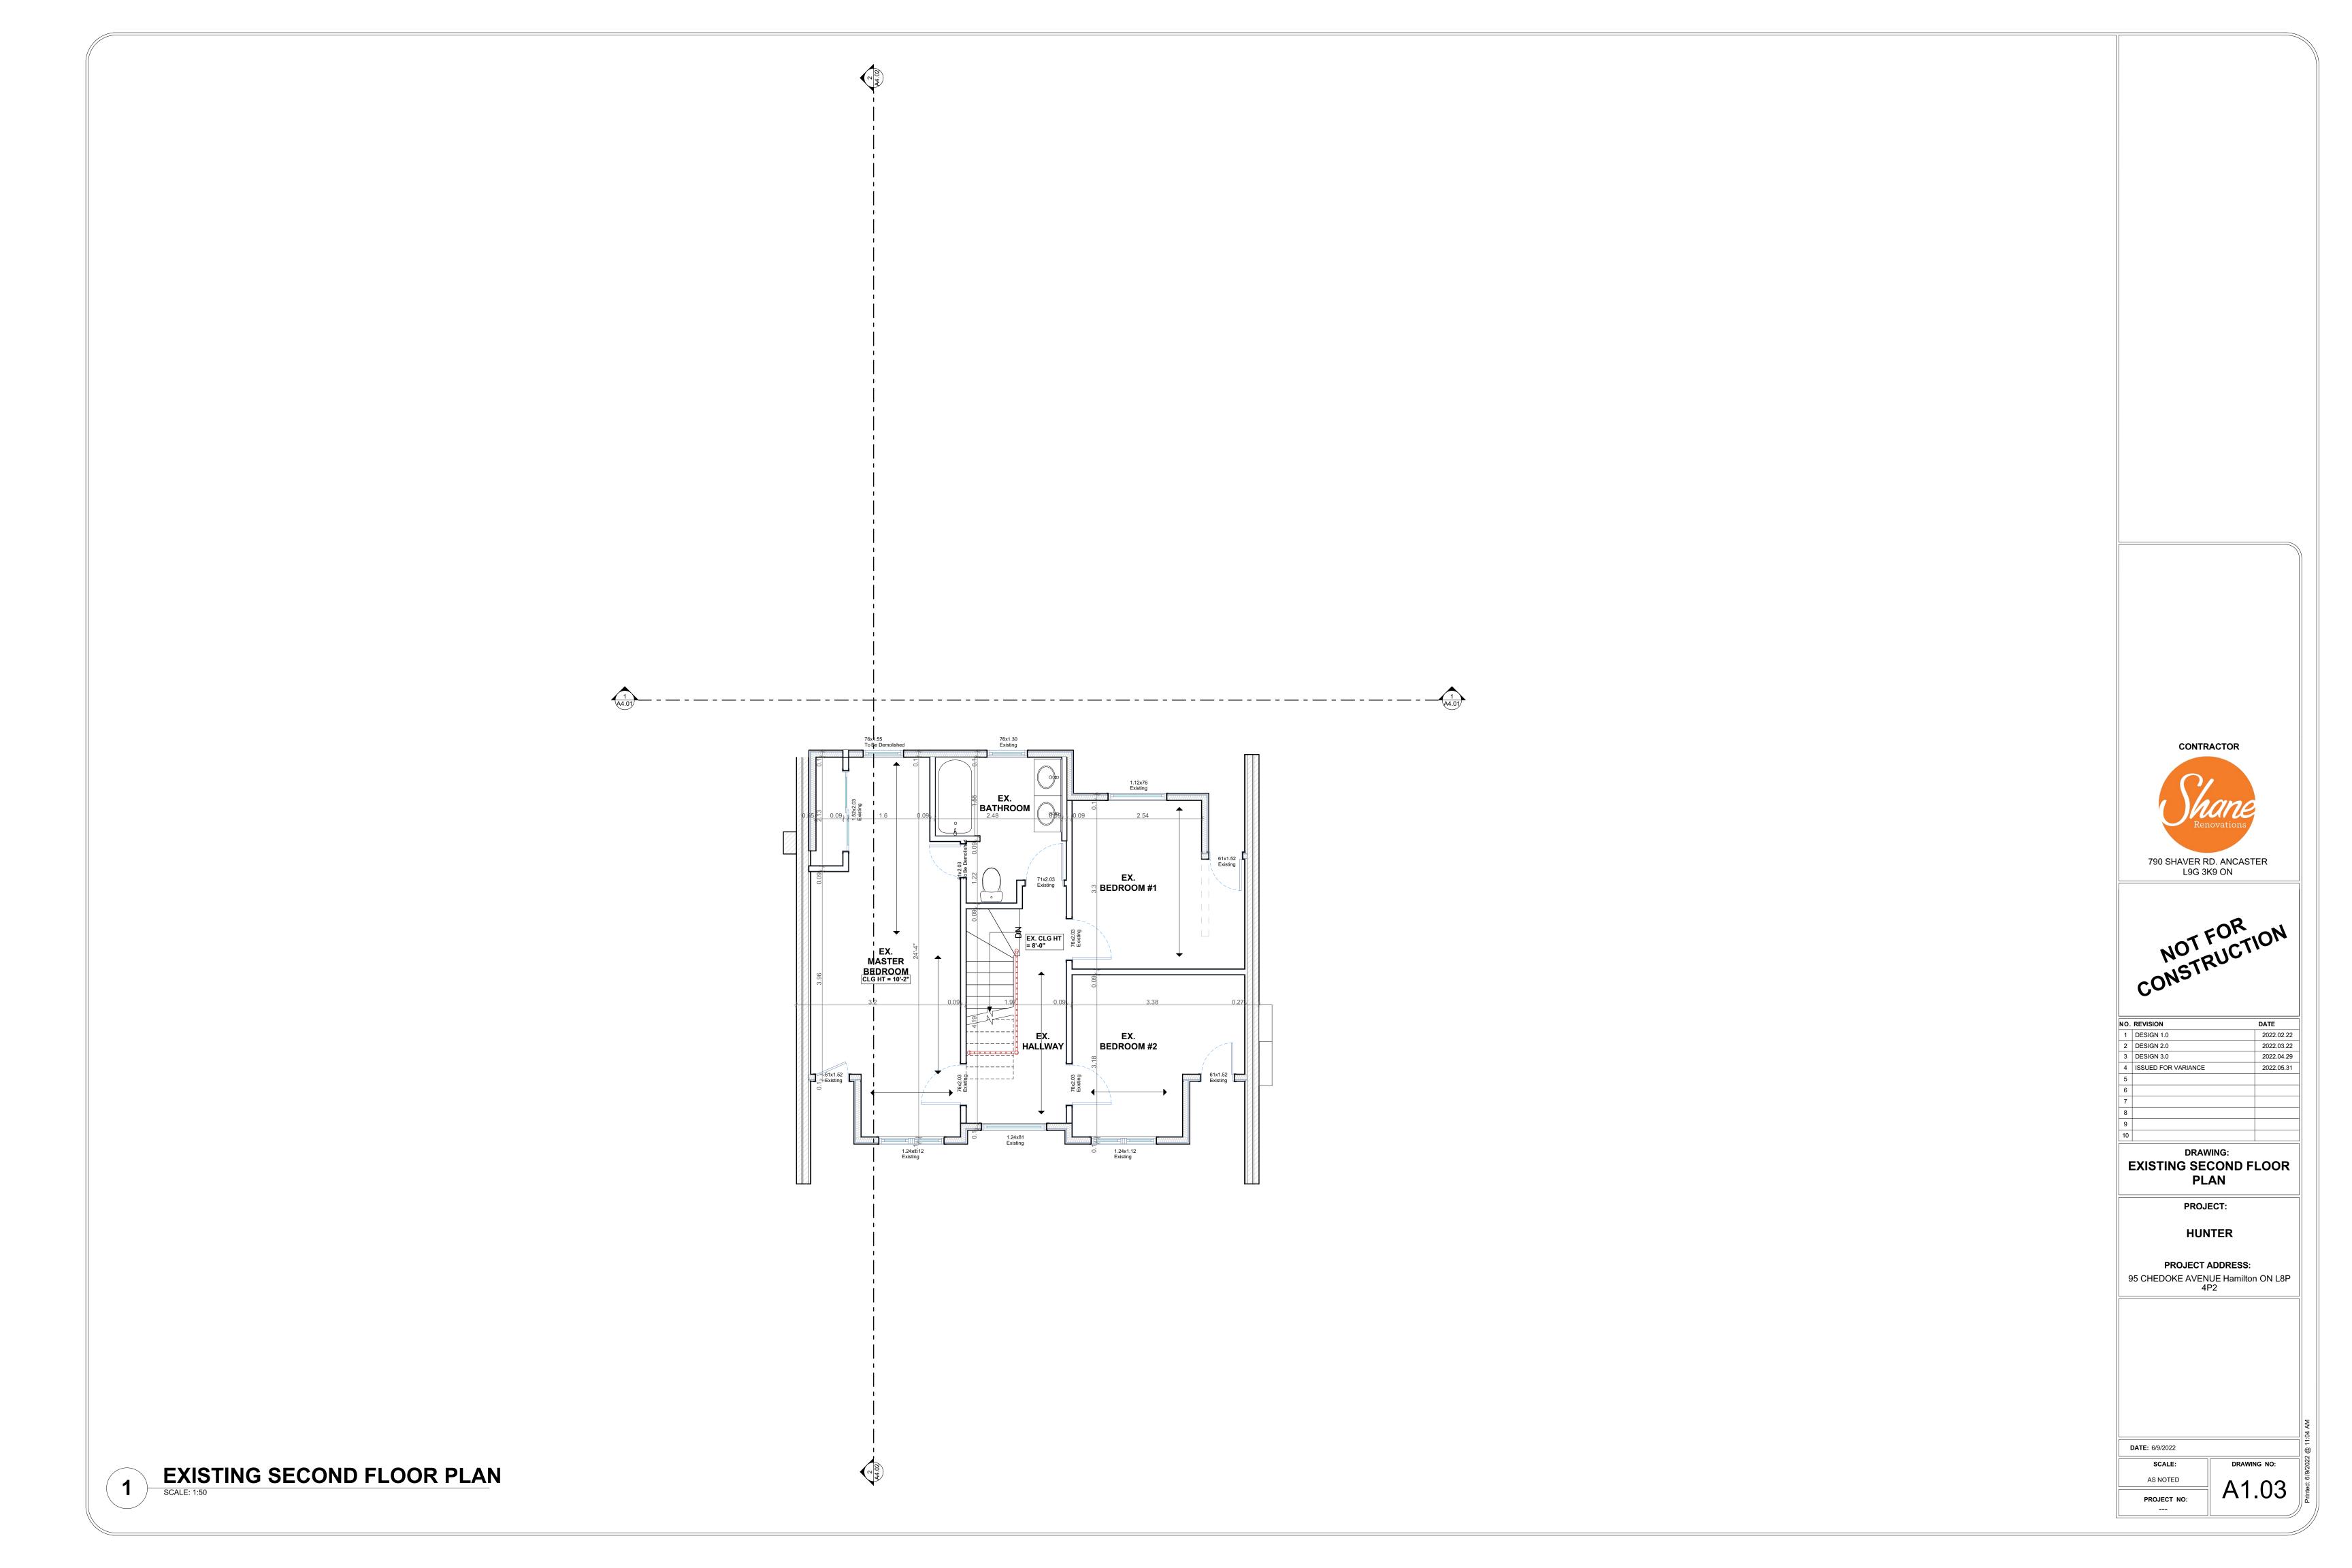
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SITE PLAN
SCALE: 1:100









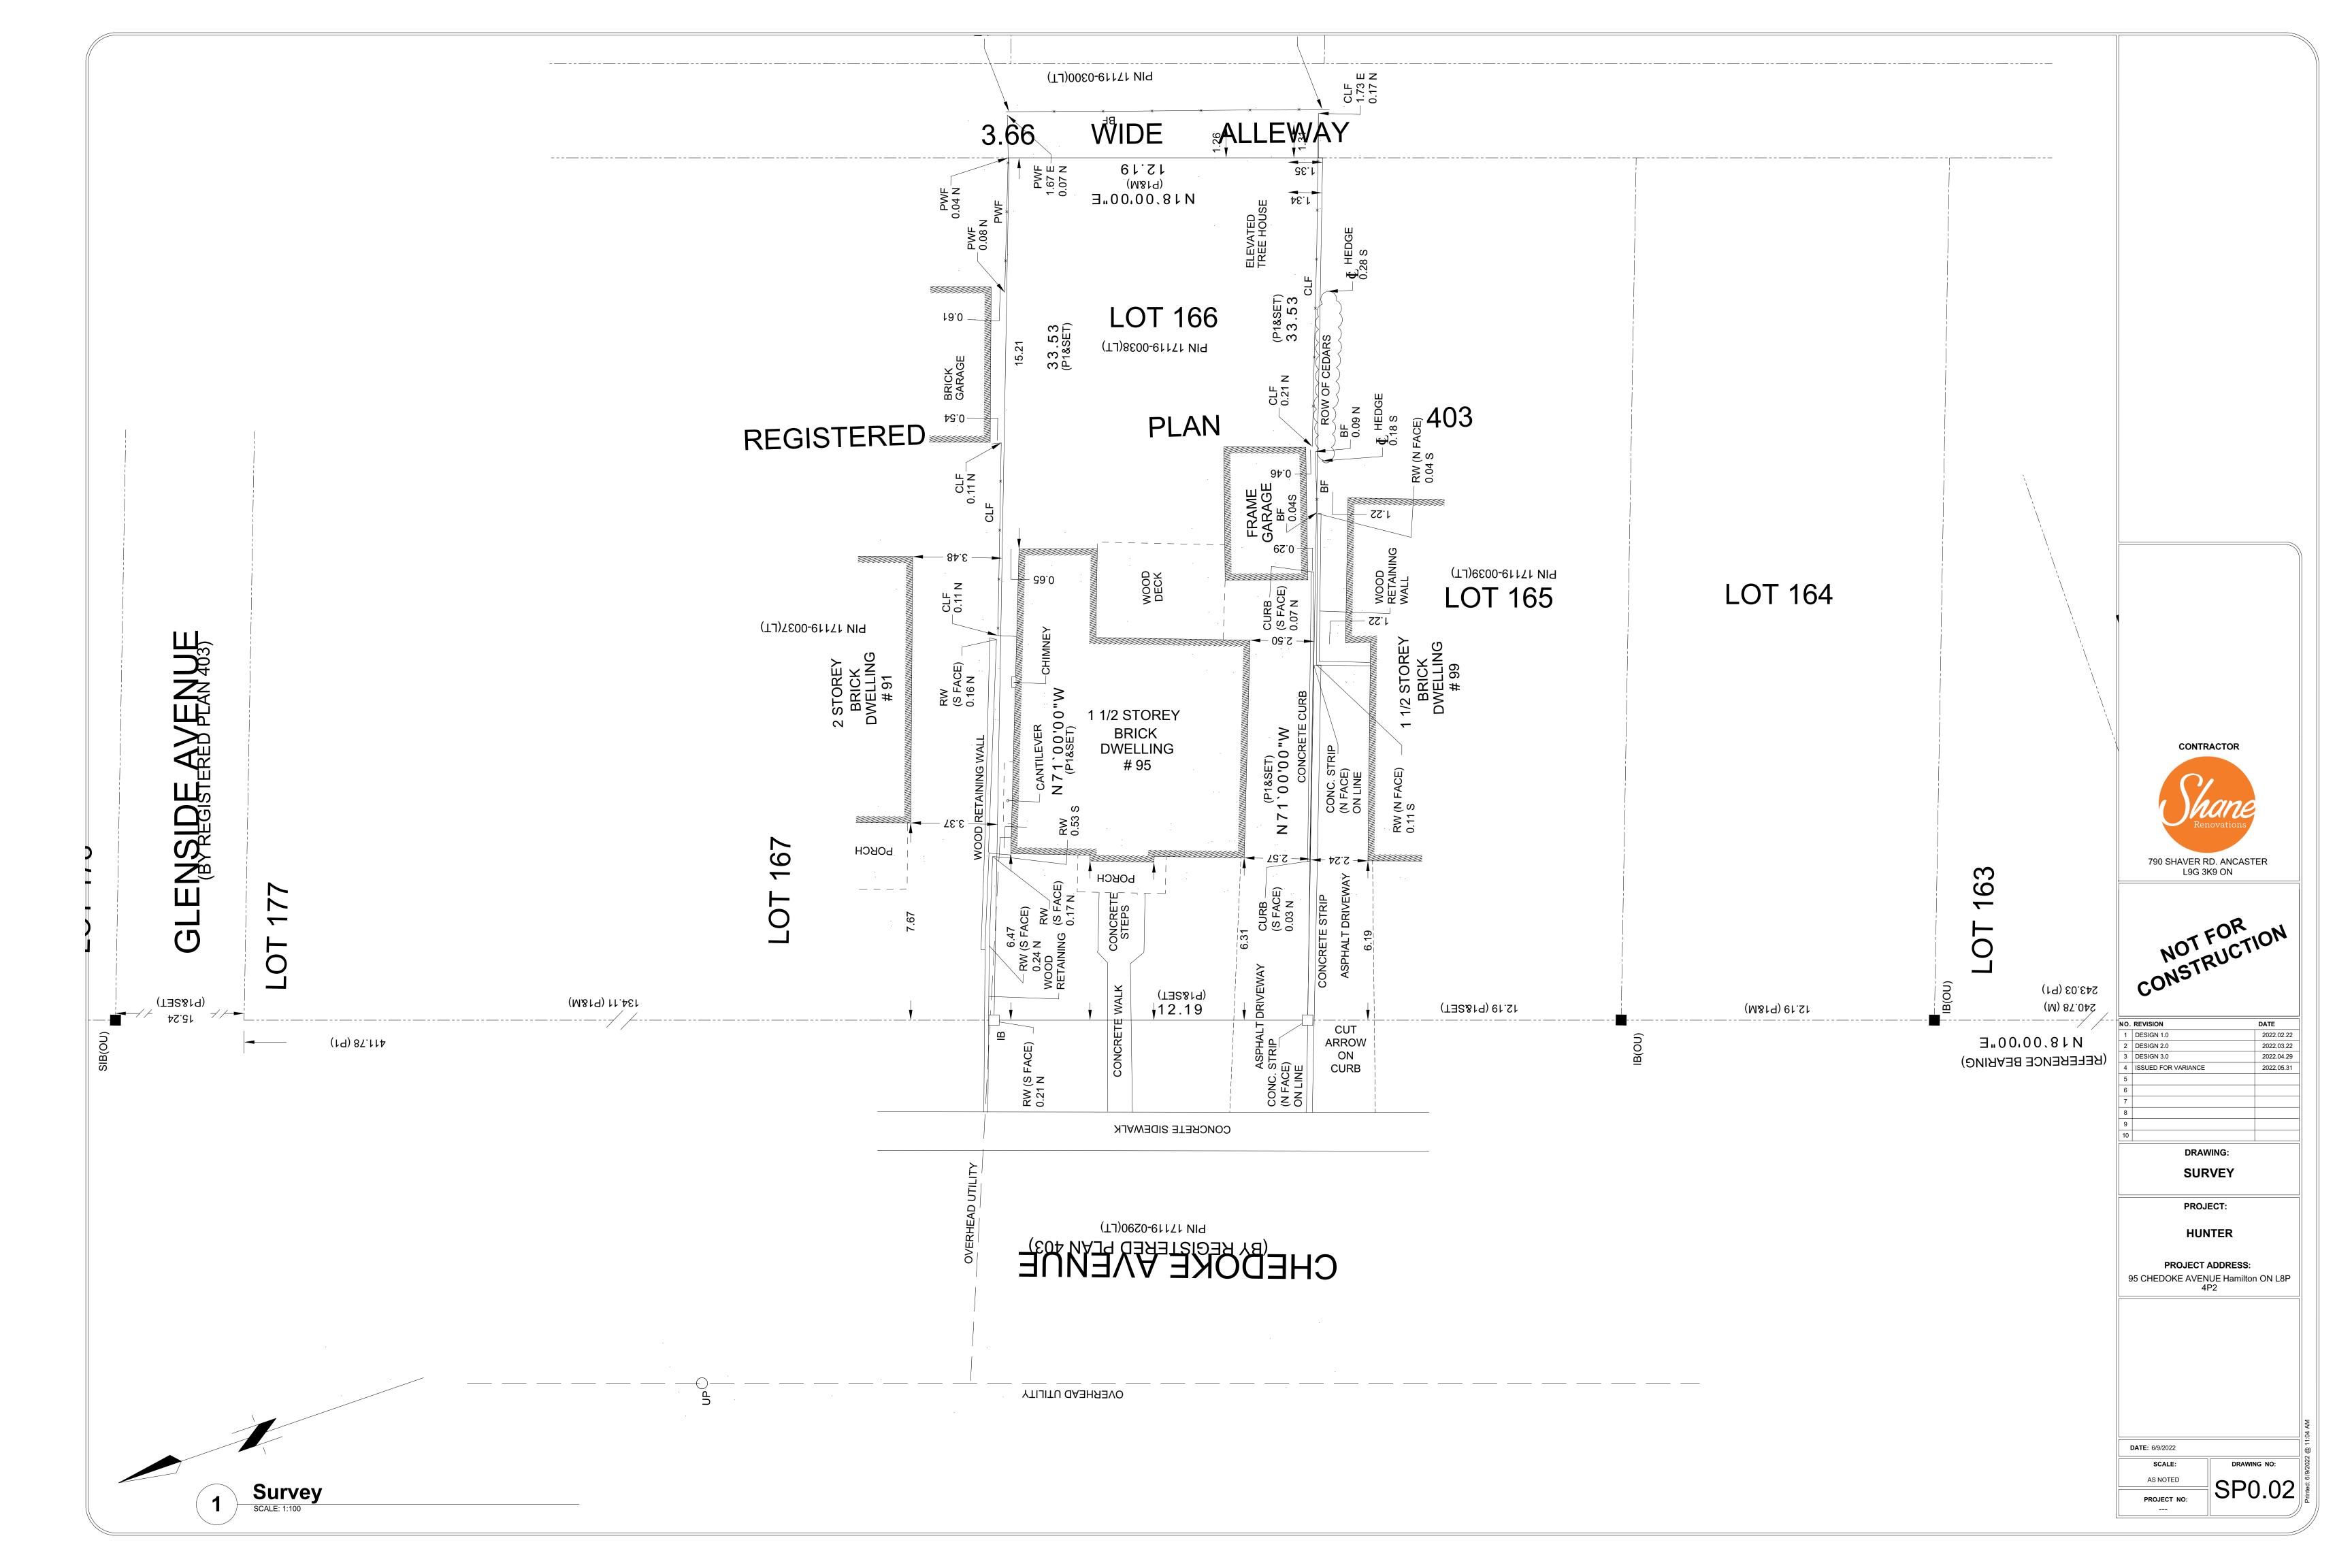

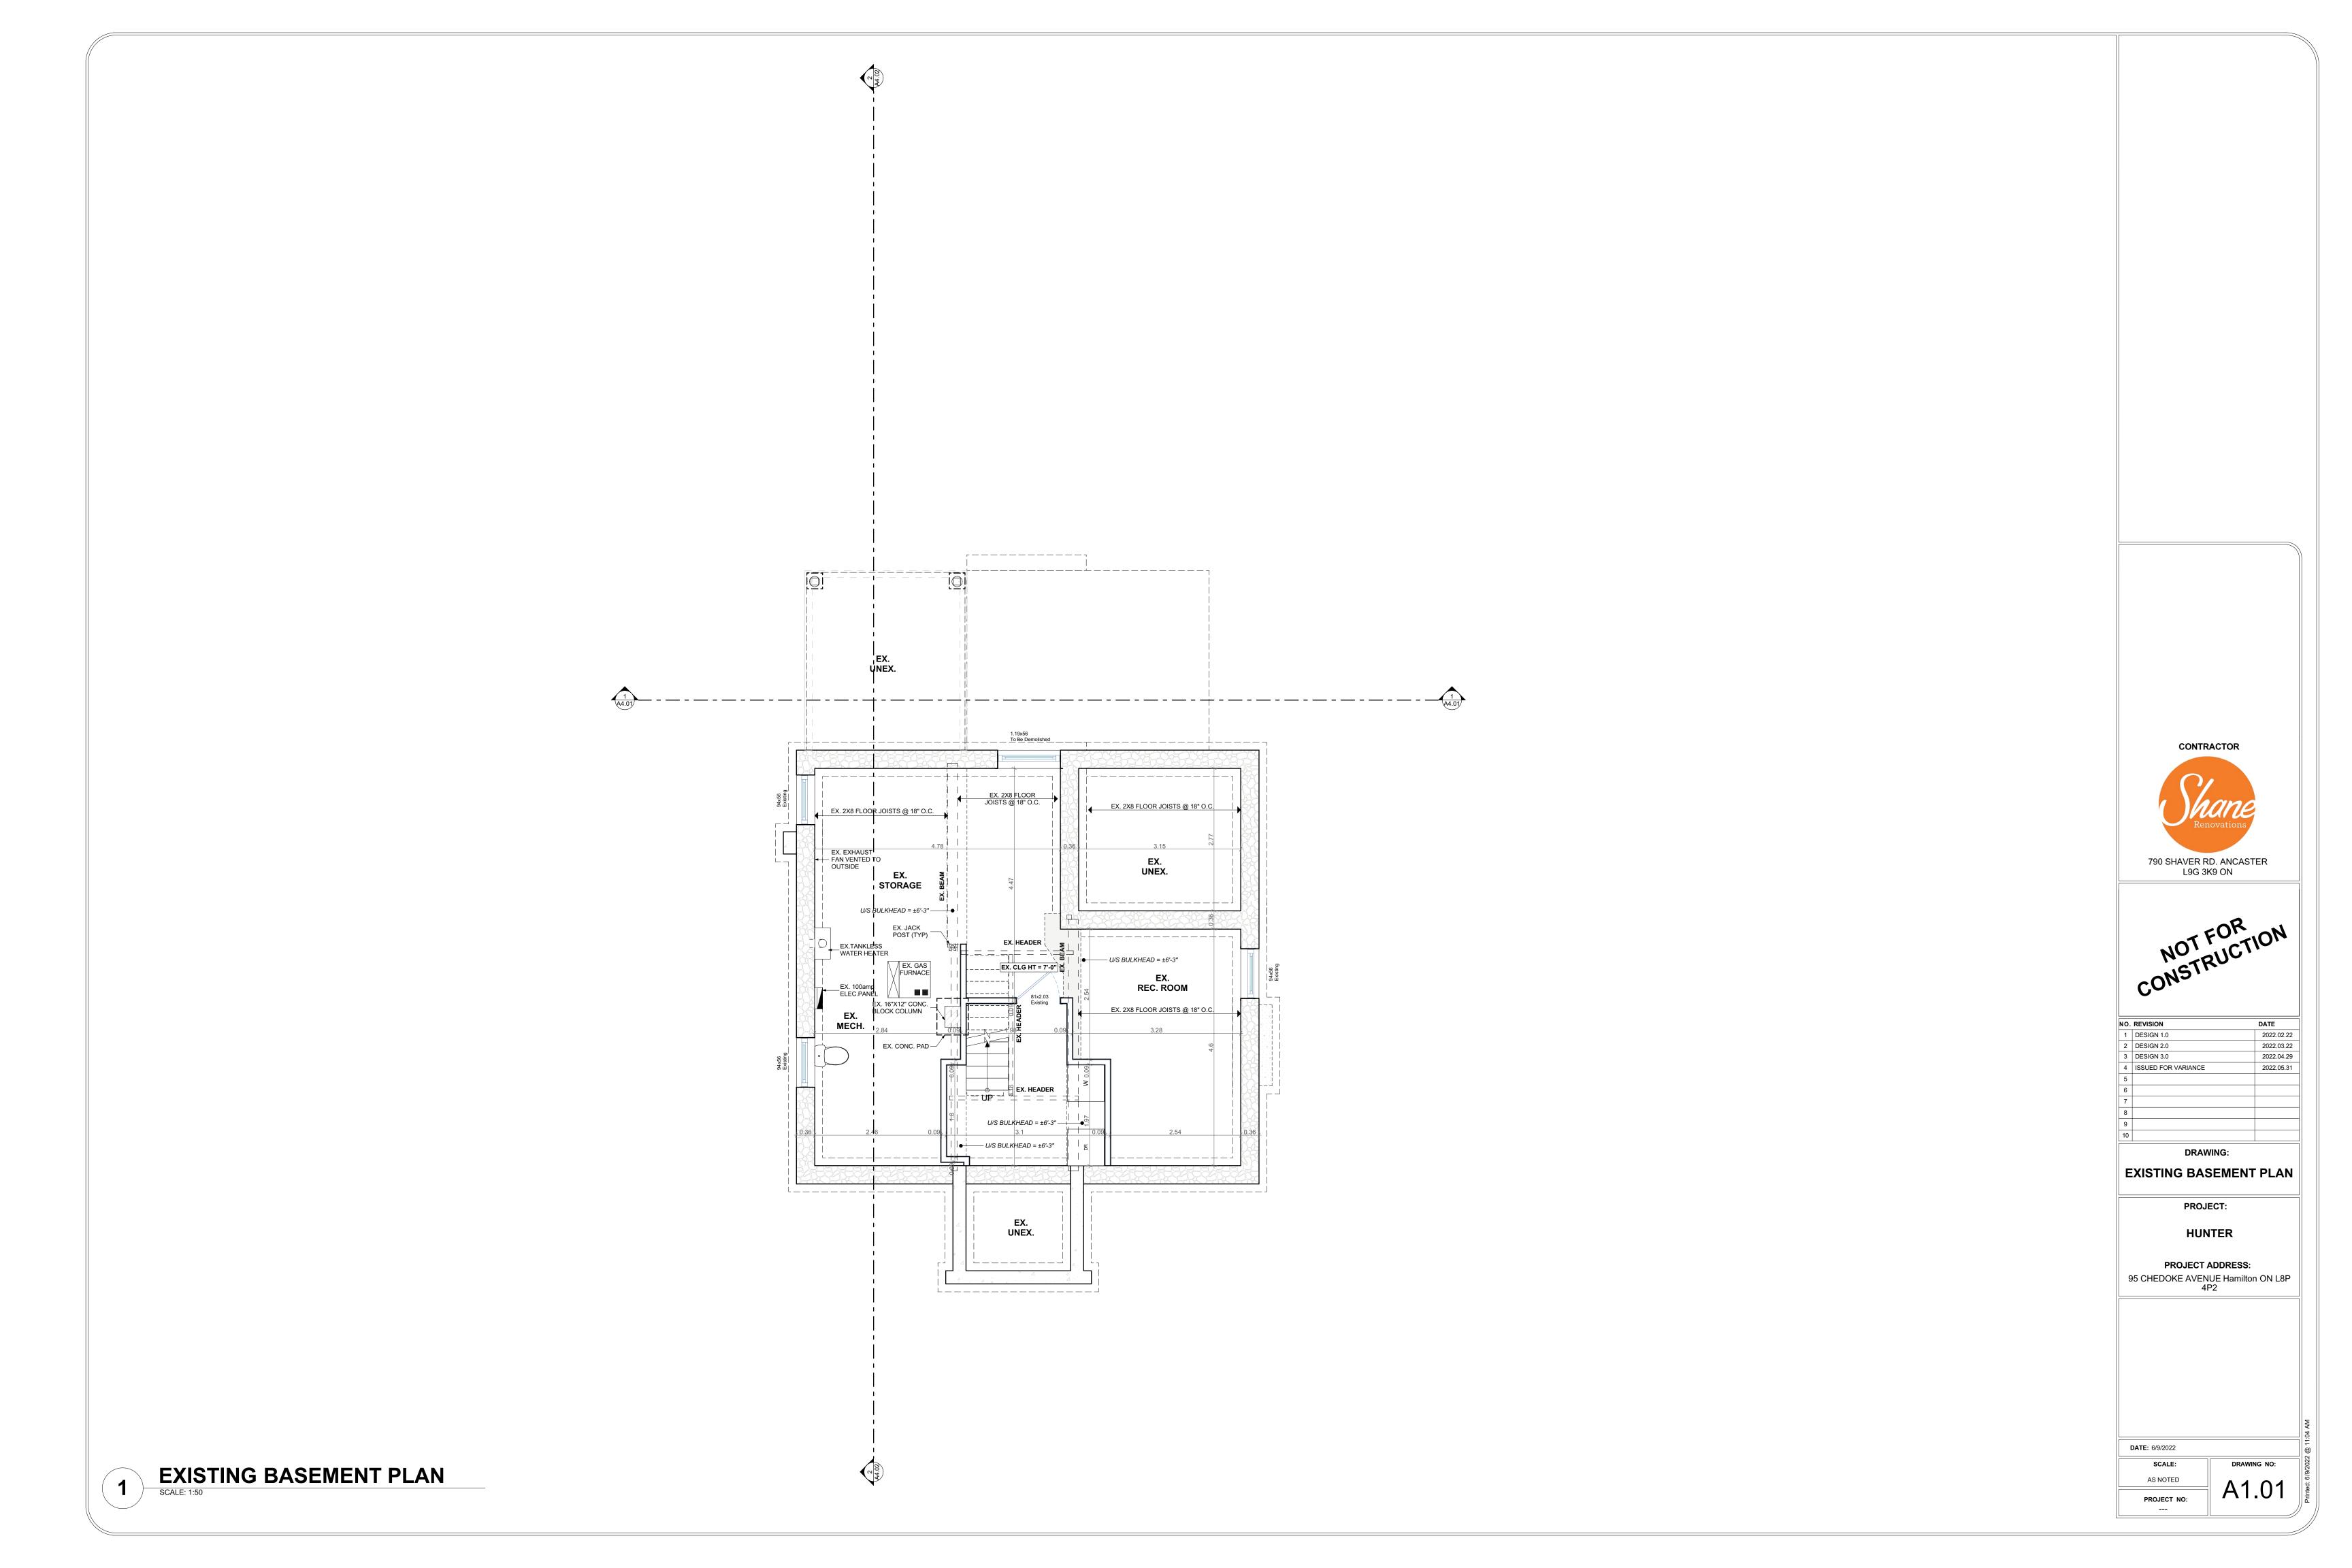ALL CONSTRUCTION TO COMPLY WITH ONTARIO BUILDING CODE GENERAL NOTES: DESIGN AND LAYOUT OF ALL PRE ENGINEERED STRUCTURAL MEMBERS FROM ROOF TRUSS SUPPLIER TO BE SUPPLIED BY MANUFACTURER PRIOR TO CONSTRUCTION SOLID BLOCKING TO BEARING BELOW TO BE PROVIDED AT ALL GIRDER TRUSS AND BEAM LOCATIONS (MIN. WIDTH EQUAL TO WIDTH OF BEARING POINT OVER) VERIFY WITH TRUSS DRAWINGS TRUSS MEMBERS SHALL NEVER BE NOTCHED, DRILLED OR CUT UNLESS NOTCHING OR DRILLING HAS BEEN ACCOUNTED FORIN THE DESIGN OF THE TRUSS WHEN RENOVATING. INSULATION TO BE EQUAL TO OR GREATER THAN EXISTING BEAM BEARING = MIN. 3-1/2" LINTEL BEARING = MIN. 1-1/2" RAFTER BEARING = MIN. 1-1/2" JOISTS BEARING = MIN. 1-1/2" CONTRACTOR TO CHECK AND VERIFY ALL SPECIFICATIONS AND DIMENSIONS PRIOR TO AND DURING CONSTRUCTION. ALL DISCREPENCIES TO BE REPORTED TO DESIGNER (519) 339-1493 PROVIDE TEMPORARY BRACING/SHORING FOR ALL EXISTING FLOOR JOISTS & WALLS DURING CONSTRUCTION & INSTALLATION OF NEW BEAMS & FLOOR JOISTS AS REQ. (TYP.) NOTE ABOUT MATCHING INSULATION IN OLDER HOMES THE ENERGY EFFICIENCY OF EXISTING BUILDINGS SHALL COMPLY WITH PART 11 OF DIVISION B OF THE BUILDING CODE FOR RENOVATION. SB-12, 1.1.1.1. ENERGY EFFICIENCY CONSTRUCTION MAY BE CARRIED OUT TO MAINTAIN THE EXISTING PERFORMANCE LEVEL OF ALL OR PART OF AN EXISTING BUILDING, BY THE REUSE, RELOCATION OR EXTENSION OF THE SAME OR SIMILAR MATERIALS OR COMPONENTS, TO RETAIN THE EXISTING CHARACTER, STRUCTURAL UNIQUENESS, HERITAGE VALUE, OR AESTHETIC APPEARANCE OF ALL OR PART OF THE BUILDING, IF THE CONSTRUCTION WILL NOT ADVERSELY AFFECT THE EARLY NEW ADDITION AREA: 48.75 m² WARNING AND EVACUATION SYSTEMS, FIRE SEPARATIONS OR THE STRUCTURAL ADEQUACY OR WILL NOT CREATE AN UNHEALTHY ENVIRONMENT IN THE BUILDING. 11.3.3.1. BASIC RENOVATION (SEE APPENDIX A) WHERE THE FRAMING SYSTEMS ARE BEING ALTERED TO MATCH EXISTING FRAMING, LESSER AMOUNTS AND EXTENT OF A A INSULATION AND VAPOR BARRIER IS ACCEPTABLE. PART 11 COMPLIANCE ALTERNATIVE, TABLE 11.5.1.1.C. (CONT'D), C199 -12.2.1.1. (3) SMOKE ALARMS 9.10.19 (1) Within dwelling units sufficient smoke alarms conforming to CAN/ULS-531 shall be installed so that (a) There is at least one smoke alarm on each storey, including basements, and (b) On any storey of a dwelling unit containing sleeping rooms, a smoke alarm is installed, (i) in each sleeping room, and (ii) in a location between the sleeping rooms and remainder of the storey, and if the sleeping rooms are served by a hallway, the smoke alarm shall be located in the hallway (2) Smoke alarms shall have a visual signalling component conforming to the requirements in 18.5.3. of NFPA 72. The visual signalling component need not be integrated with the smoke alarm provided it is interconnected Interconnect smoke alarms to be permantly connected and have a battery backup as per OBC 9.10.19.4 TABLE 3.1.1.21. (IP) Thermal Performance Requirements for Additions to Existing Buildings CEILING WITH ATTIC SPACE CEILING WITHOUT ATTIC SPACE EXPOSED FLOOR WALLS ABOVE GRADE BASEMENT WALLS BELOW GRADE SLAB R20 c.i. or R12 + R10 c.i. EDGE OF BELOW GRADE SLAB HEATED SLAB WINDOWS AND SLIDING GLASS DOORS ENERGY RATING EXISTING RUBBLE 0.28U 25 DEMOLISHED EX. 2X8 FLOOR JOISTS @ 18" O.C. ELECTRICAL FACILITIES SHALL BE PROVIDED AS PER ONTARIO BUILDING CODE 2012 AS PER 9.34 FAN VENTED TO OUTSIDE U/S BULKHEAD = ±6'-3" EXISTING RUBBLE FOUNDATION TO BE DEMOLISHED EX.TANKLESS ---- U/S BULKHEAD = ±6'-3" FURNACE EX. 16"X12" CONC. EX. 2X8 FLOOR JOISTS @ 18" O.C. BLOCK COLUMN EX. MECH. EX. CONC. PAD — EX. HEADER U/S BULKHEAD = ±6'-3" EX. UNEX. - — — — — — — — L_______

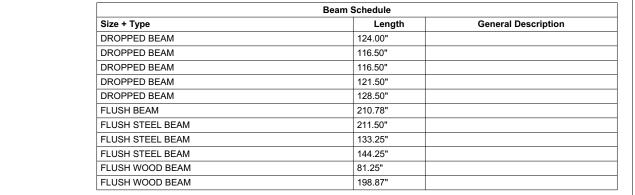



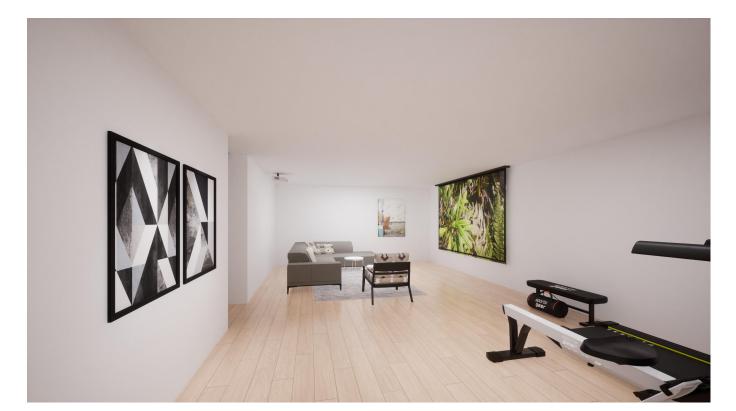



| NO. | REVISION | DATE | |
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| | DRAWING: PROPOSED BASEMENT | | |

PLAN

PROJECT: HUNTER

PROJECT ADDRESS: 95 CHEDOKE AVENUE Hamilton ON L8P 4P2

DATE: 6/9/2022 SCALE: DRAWING NO: AS NOTED A1.04 PROJECT NO:

PROPOSED BASEMENT PLAN

ALL CONSTRUCTION TO COMPLY WITH ONTARIO BUILDING CODE

GENERAL NOTES:

DESIGN AND LAYOUT OF ALL PRE ENGINEERED STRUCTURAL MEMBERS FROM ROOF TRUSS SUPPLIER TO BE SUPPLIED BY MANUFACTURER PRIOR TO CONSTRUCTION

SOLID BLOCKING TO BEARING BELOW TO BE PROVIDED ATALL GIRDER TRUSS AND BEAM LOCATIONS (MIN. WIDTH EQUAL TO WIDTH OF BEARING POINT OVER) VERIFY WITH TRUSS DRAWINGS

TRUSS MEMBERS SHALL NEVER BE NOTCHED, DRILLED OR CUT UNLESS NOTCHING OR DRILLING HAS BEEN ACCOUNTED FORIN THE DESIGN OF THE TRUSS

WHEN RENOVATING. INSULATION TO BE EQUAL TO OR GREATER THAN EXISTING

BEAM BEARING = MIN. 3-1/2" LINTEL BEARING = MIN. 1-1/2" RAFTER BEARING = MIN. 1-1/2" JOISTS BEARING = MIN. 1-1/2"

CONTRACTOR TO CHECK AND VERIFY ALL SPECIFICATIONS AND DIMENSIONS PRIOR TO AND DURING CONSTRUCTION. ALL

DISCREPENCIES TO BE REPORTED TO DESIGNER (519) 339-1493

PROVIDE TEMPORARY BRACING/SHORING FOR ALL EXISTING FLOOR JOISTS & WALLS DURING CONSTRUCTION & INSTALLATION OF NEW BEAMS & FLOOR JOISTS AS REQ. (TYP.)

NOTE ABOUT MATCHING INSULATION IN OLDER HOMES

THE ENERGY EFFICIENCY OF EXISTING BUILDINGS SHALL COMPLY WITH PART 11 OF DIVISION B OF THE BUILDING CODE FOR RENOVATION. SB-12, 1.1.1.1. ENERGY EFFICIENCY

CONSTRUCTION MAY BE CARRIED OUT TO MAINTAIN THE EXISTING PERFORMANCE LEVEL OF ALL OR PART OF AN EXISTING BUILDING, BY THE REUSE, RELOCATION OR EXTENSION OF THE SAME OR SIMILAR MATERIALS OR COMPONENTS, TO RETAIN THE EXISTING CHARACTER, STRUCTURAL UNIQUENESS, HERITAGE VALUE, OR AESTHETIC APPEARANCE OF ALL OR PART OF THE BUILDING, IF THE CONSTRUCTION WILL NOT ADVERSELY AFFECT THE EARLY WARNING AND EVACUATION SYSTEMS, FIRE SEPARATIONS OR THE STRUCTURAL ADEQUACY OR WILL NOT CREATE AN UNHEALTHY ENVIRONMENT IN THE BUILDING. 11.3.3.1. BASIC RENOVATION (SEE APPENDIX A)

WHERE THE FRAMING SYSTEMS ARE BEING ALTERED TO MATCH EXISTING FRAMING, LESSER AMOUNTS AND EXTENT OF INSULATION AND VAPOR BARRIER IS ACCEPTABLE. PART 11 COMPLIANCE ALTERNATIVE, TABLE 11.5.1.1.C. (CONT'D), C199 -12.2.1.1. (3)

SMOKE ALARMS

9.10.19
(1) Within dwelling units sufficient smoke alarms conforming to CAN/ULS-531 shall be installed so that

(a) There is at least one smoke alarm on each storey, including basements, and

(b) On any storey of a dwelling unit containing sleeping rooms, a smoke alarm is installed,
(i) in each sleeping room, and

(ii) in a location between the sleeping rooms and remainder of the storey, and if the sleeping rooms are served by a hallway, the smoke alarm shall

(2) Smoke alarms shall have a visual signalling component conforming to the requirements in 18.5.3. of NFPA 72. The visual signalling component need not be integrated with the smoke alarm provided it is interconnected

Interconnect smoke alarms to be permantly connected and have a battery backup as per OBC 9.10.19.4

TABLE 3.1.1.21. (IP) Thermal Performance Requirements for Additions to Existing Buildings

CEILING WITH ATTIC SPACE CEILING WITHOUT ATTIC SPACE


CEILING WITHOUT ATTIC SPACE
EXPOSED FLOOR
WALLS ABOVE GRADE
BASEMENT WALLS
BELOW GRADE SLAB
EDGE OF BELOW GRADE SLAB
HEATED SLAB
WINDOWS AND SLIDING GLASS DOORS
ENERGY RATING

BUILDING CODE 2012 AS PER 9.34

0.28U 25

ELECTRICAL FACILITIES SHALL BE PROVIDED AS PER ONTARIO


R20 c.i. or R12 + R10 c.i.

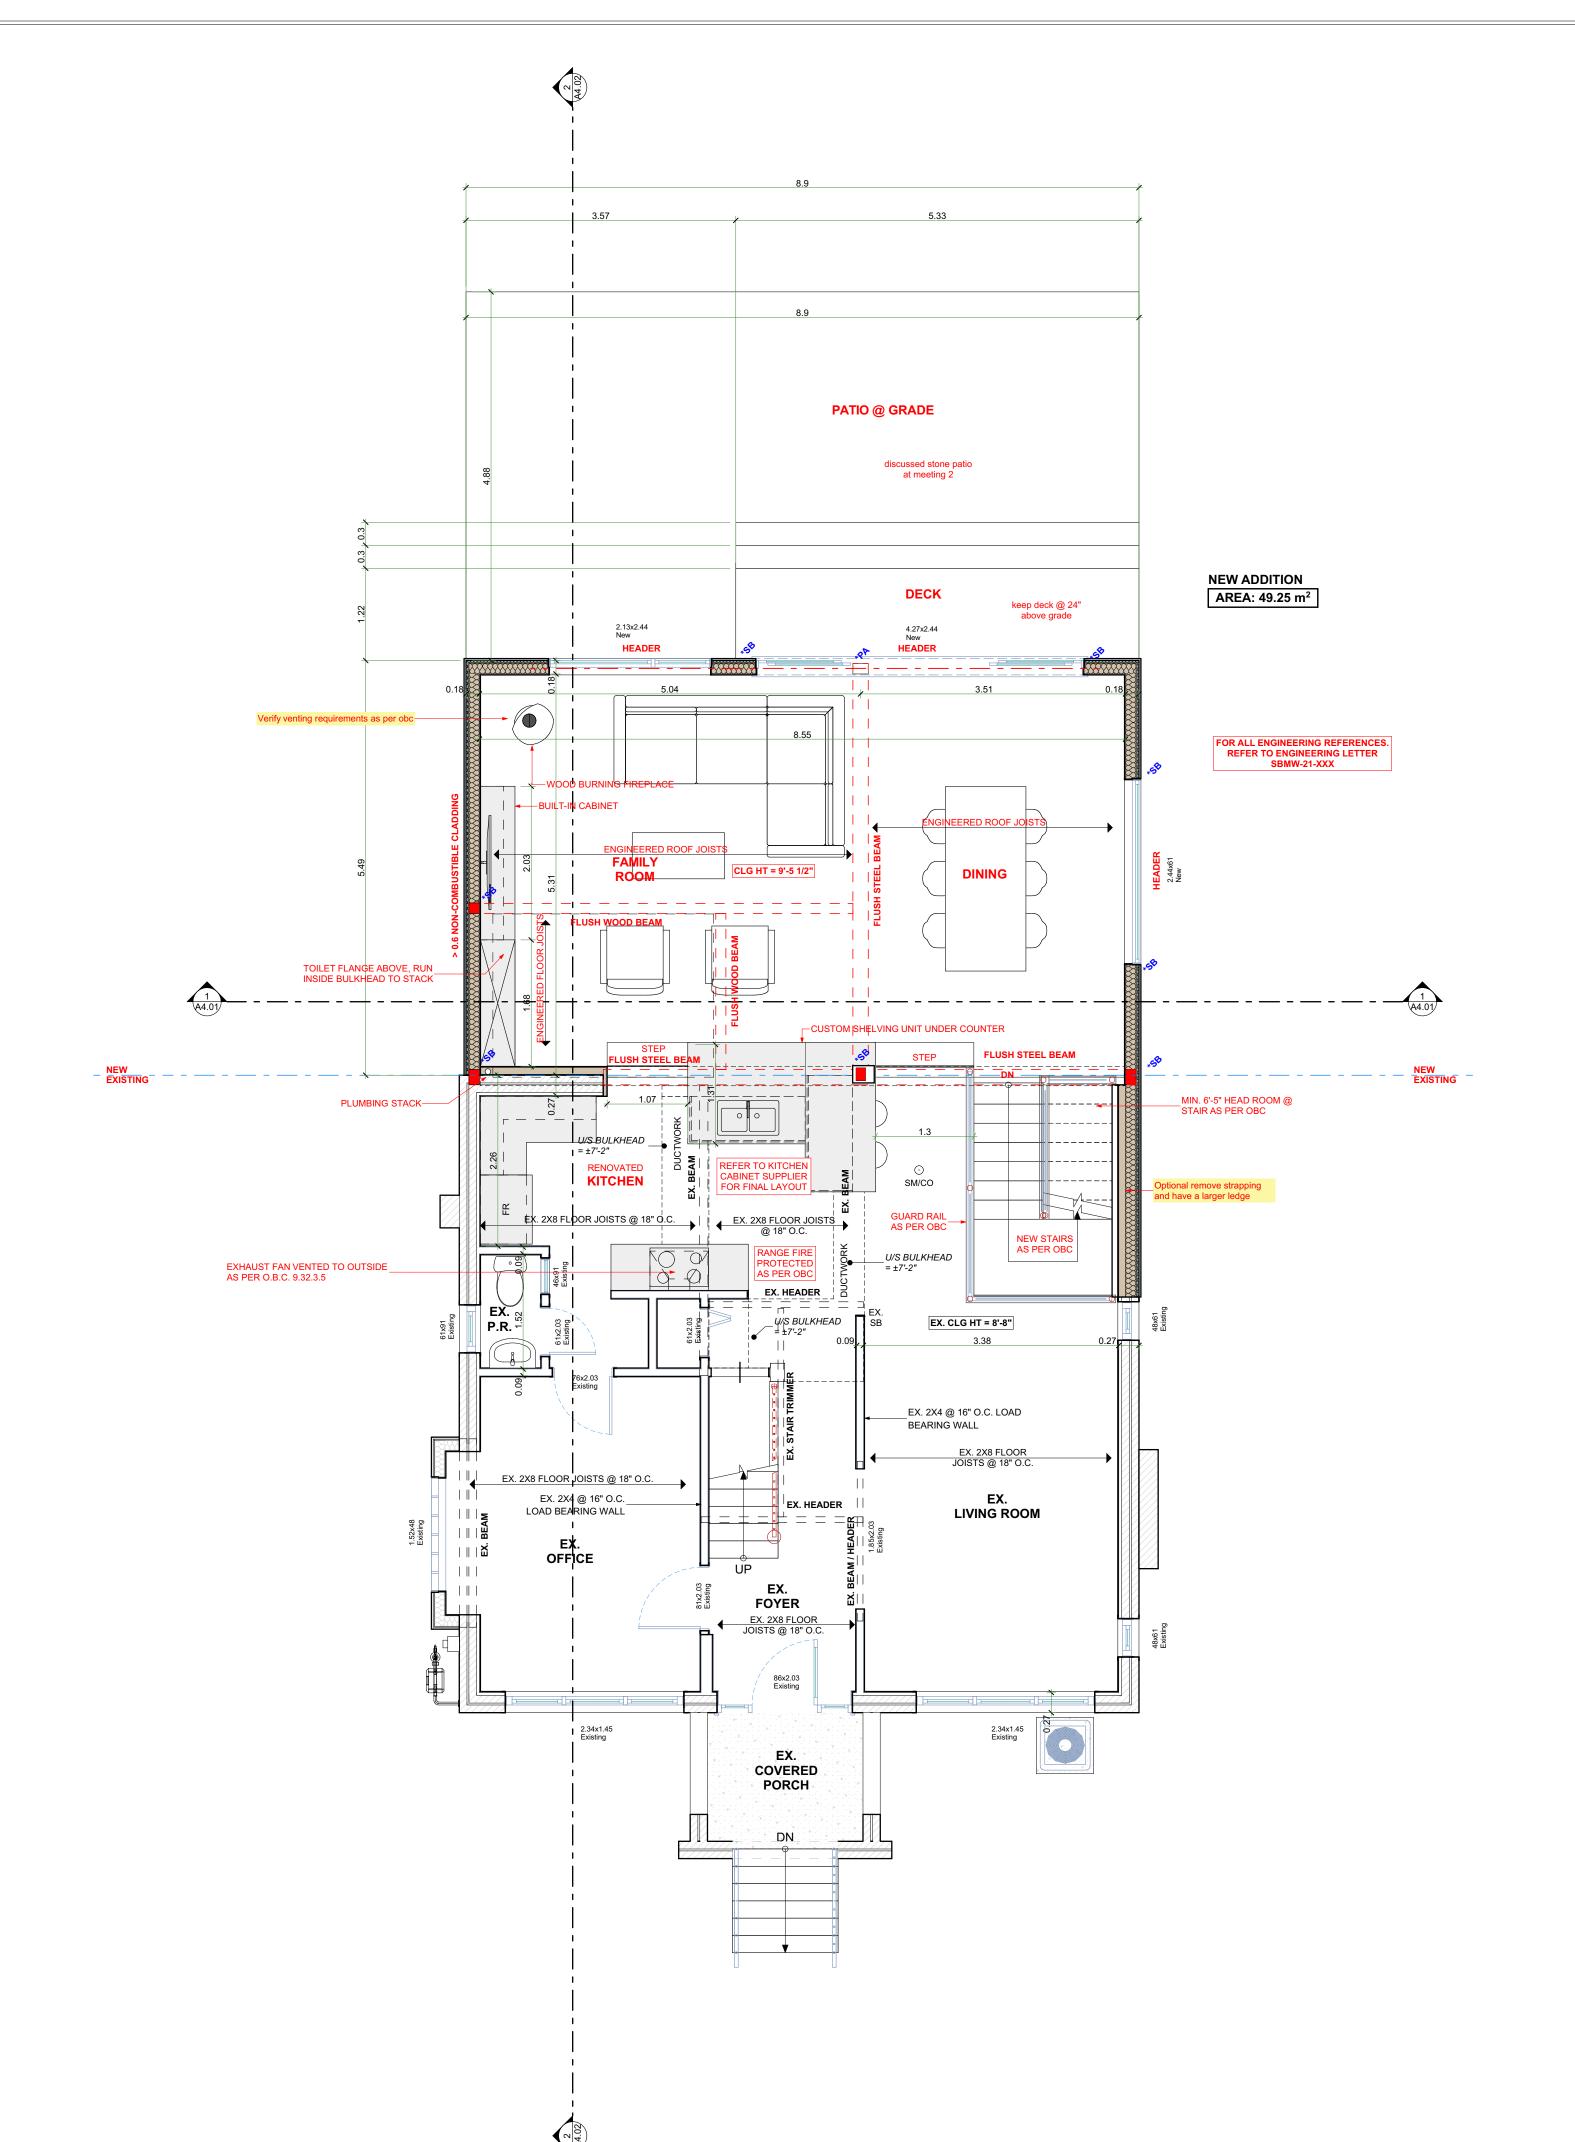

| Beam Schedule | | | |
|------------------|---------|---------------------|--|
| Size + Type | Length | General Description | |
| DROPPED BEAM | 124.00" | | |
| DROPPED BEAM | 116.50" | | |
| DROPPED BEAM | 116.50" | | |
| DROPPED BEAM | 121.50" | | |
| DROPPED BEAM | 128.50" | | |
| FLUSH BEAM | 210.78" | | |
| FLUSH STEEL BEAM | 211.50" | | |
| FLUSH STEEL BEAM | 133.25" | | |
| FLUSH STEEL BEAM | 144.25" | | |
| FLUSH WOOD BEAM | 81.25" | | |
| FLUSH WOOD BEAM | 198.87" | | |





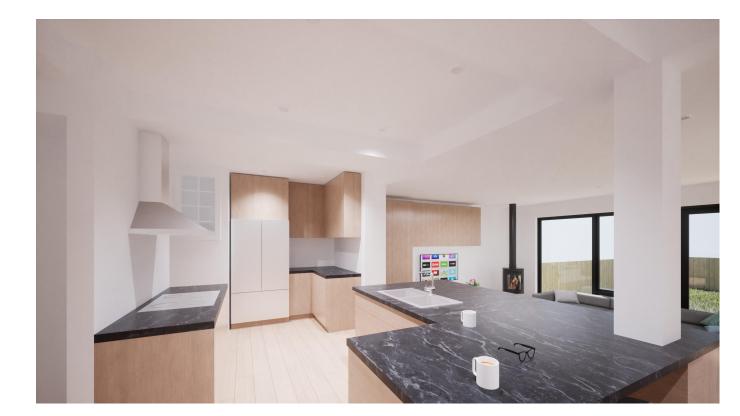




DATE

NO. REVISION

| 1 | DESIGN 1.0 | 2022.02.22 |
|----|---|------------|
| 2 | DESIGN 2.0 | 2022.03.22 |
| 3 | DESIGN 3.0 | 2022.04.29 |
| 4 | ISSUED FOR VARIANCE | 2022.05.31 |
| 5 | | |
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| | PROPOSED MAIN FL PLAN | .OOR |
| | PROJECT: | |
| | HUNTER | |
| 9 | PROJECT ADDRESS: 95 CHEDOKE AVENUE Hamiltor 4P2 | n ON L8P |
| | | |

DATE: 6/9/2022 DRAWING NO: AS NOTED A1.05 PROJECT NO:

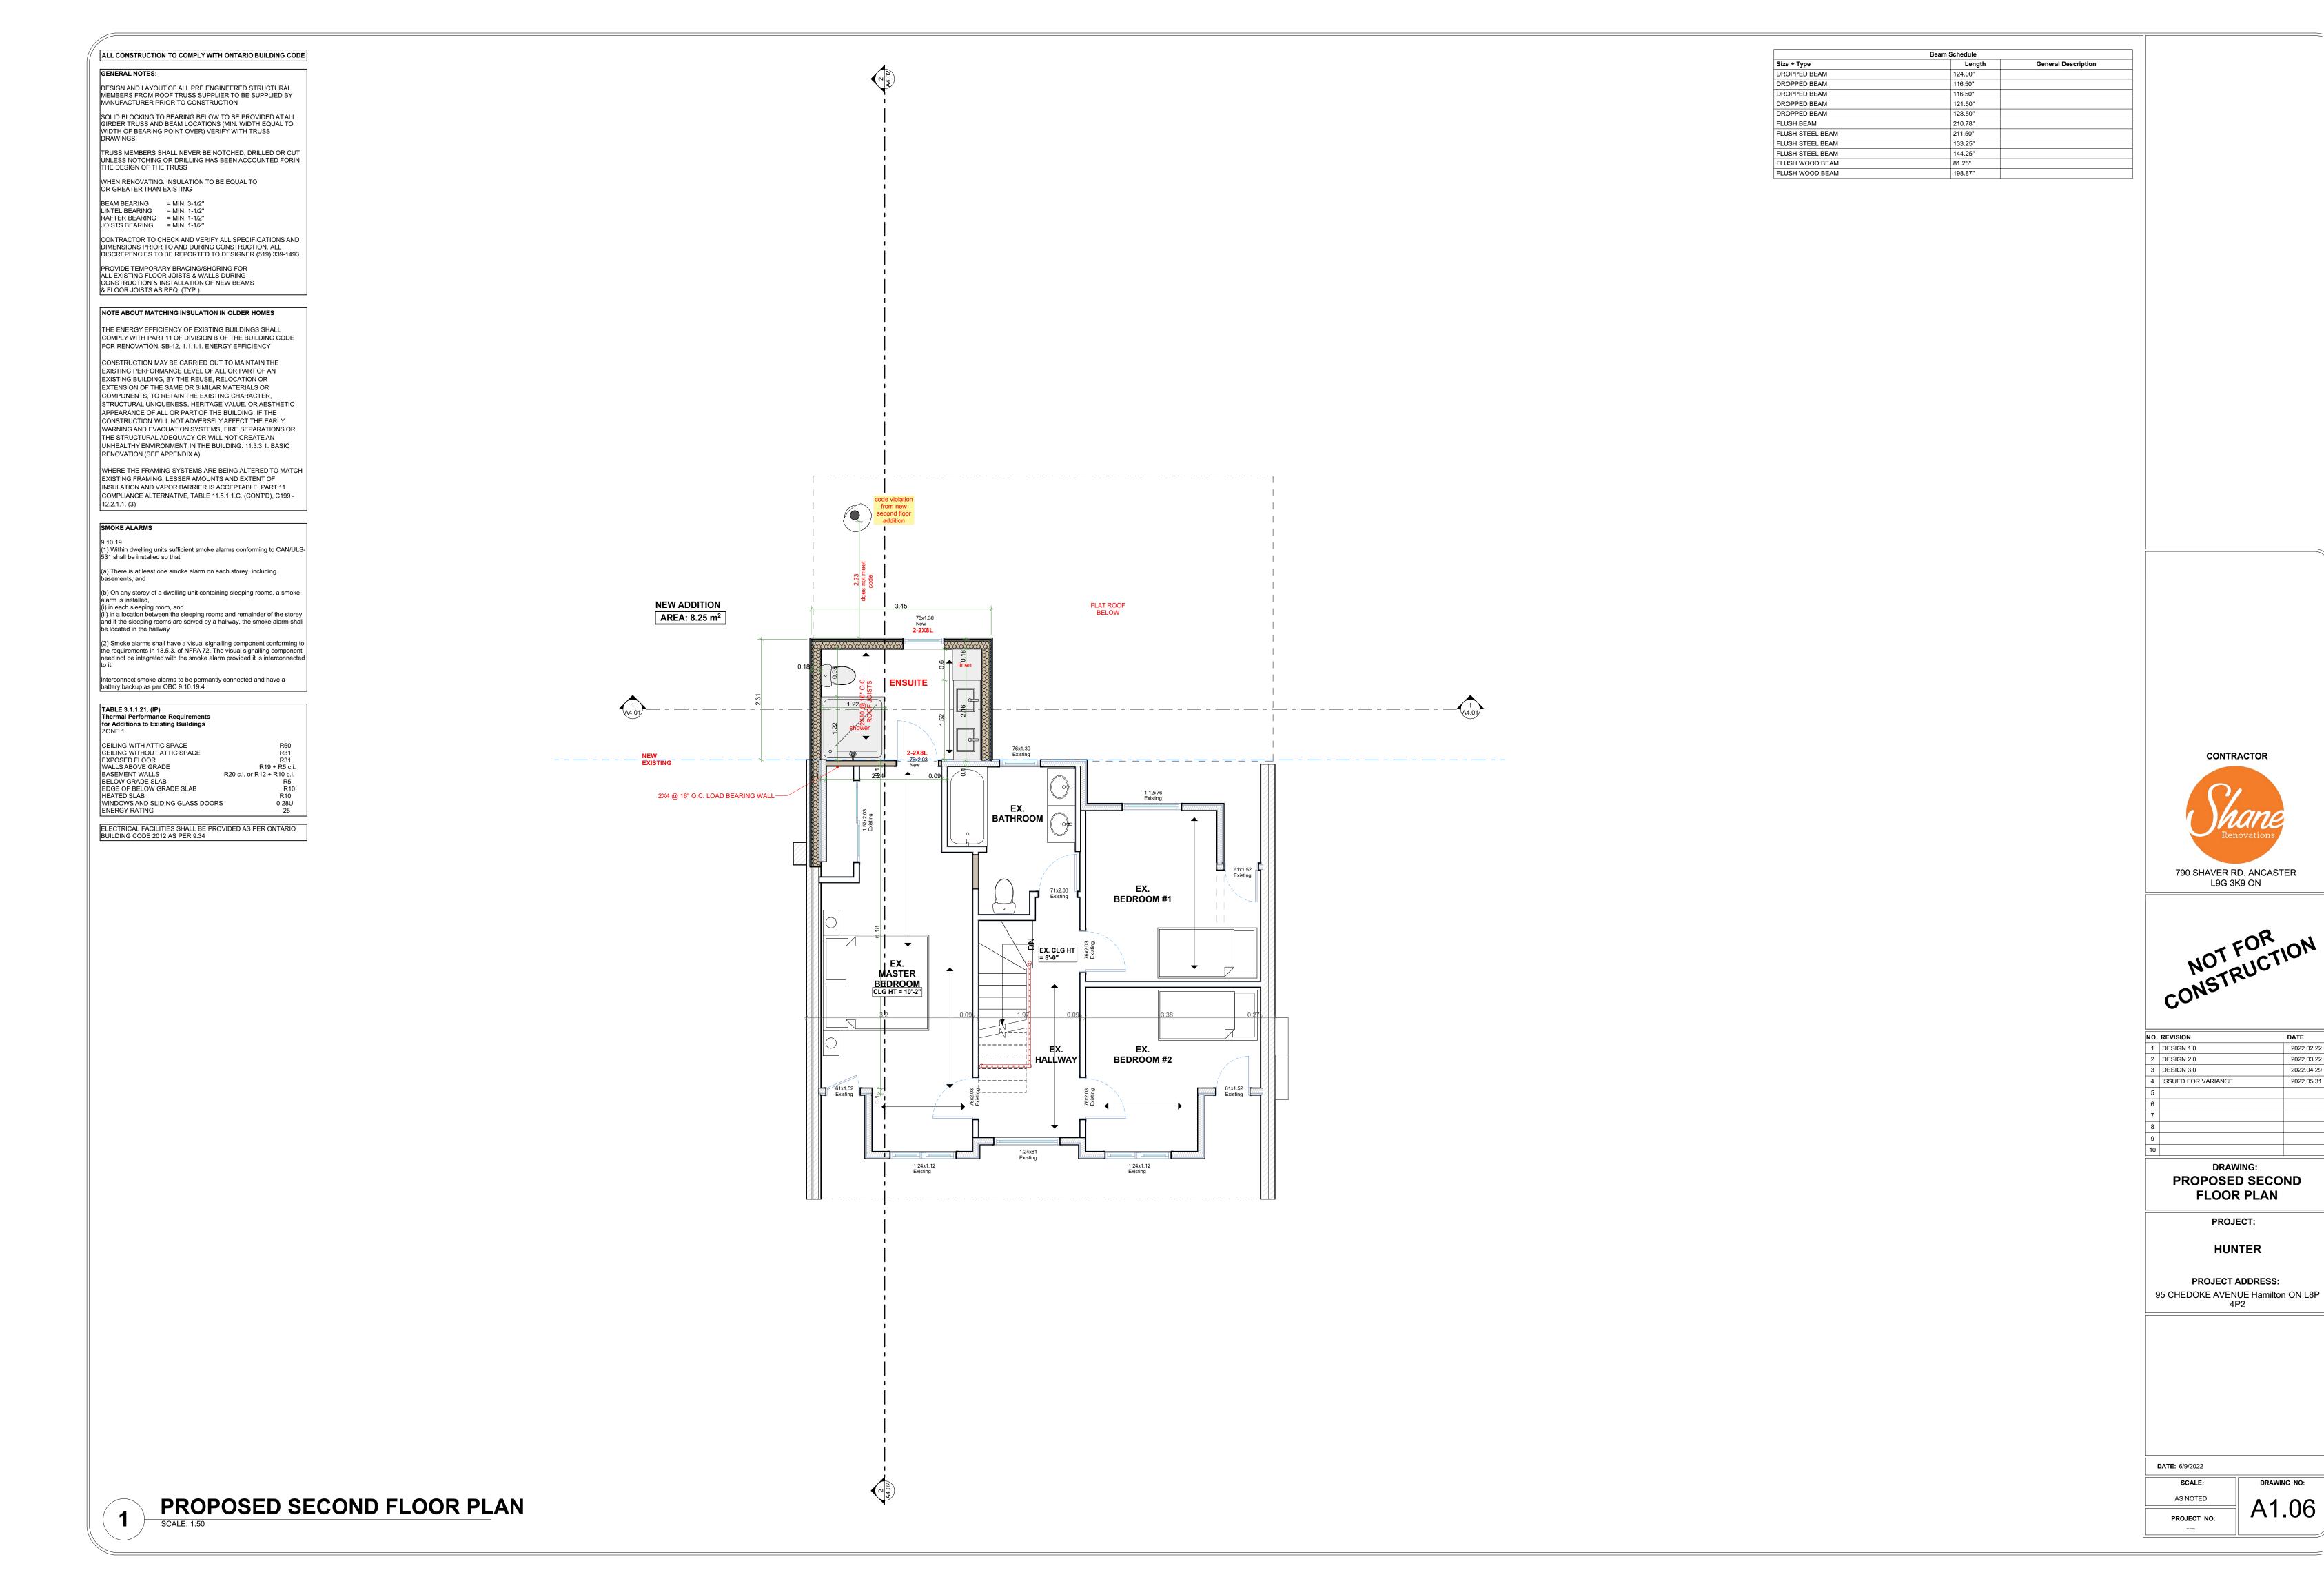

DATE

2022.02.22

2022.03.22

2022.04.29

2022.05.31

DRAWING NO:





CONSTRUCTION

| REVISION | DATE |
|---------------------|---|
| DESIGN 1.0 | 2022.0 |
| DESIGN 2.0 | 2022.0 |
| DESIGN 3.0 | 2022.0 |
| ISSUED FOR VARIANCE | 2022.0 |
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| | DESIGN 2.0 DESIGN 3.0 ISSUED FOR VARIANCE |

DRAWING:
EXISTING FRONT
ELEVATION

PROJECT:
HUNTER

PROJECT ADDRESS:

95 CHEDOKE AVENUE Hamilton ON L8P


4P2

DATE: 6/9/2022

SCALE: DRAWING NO:
AS NOTED

PROJECT NO:

AS 1

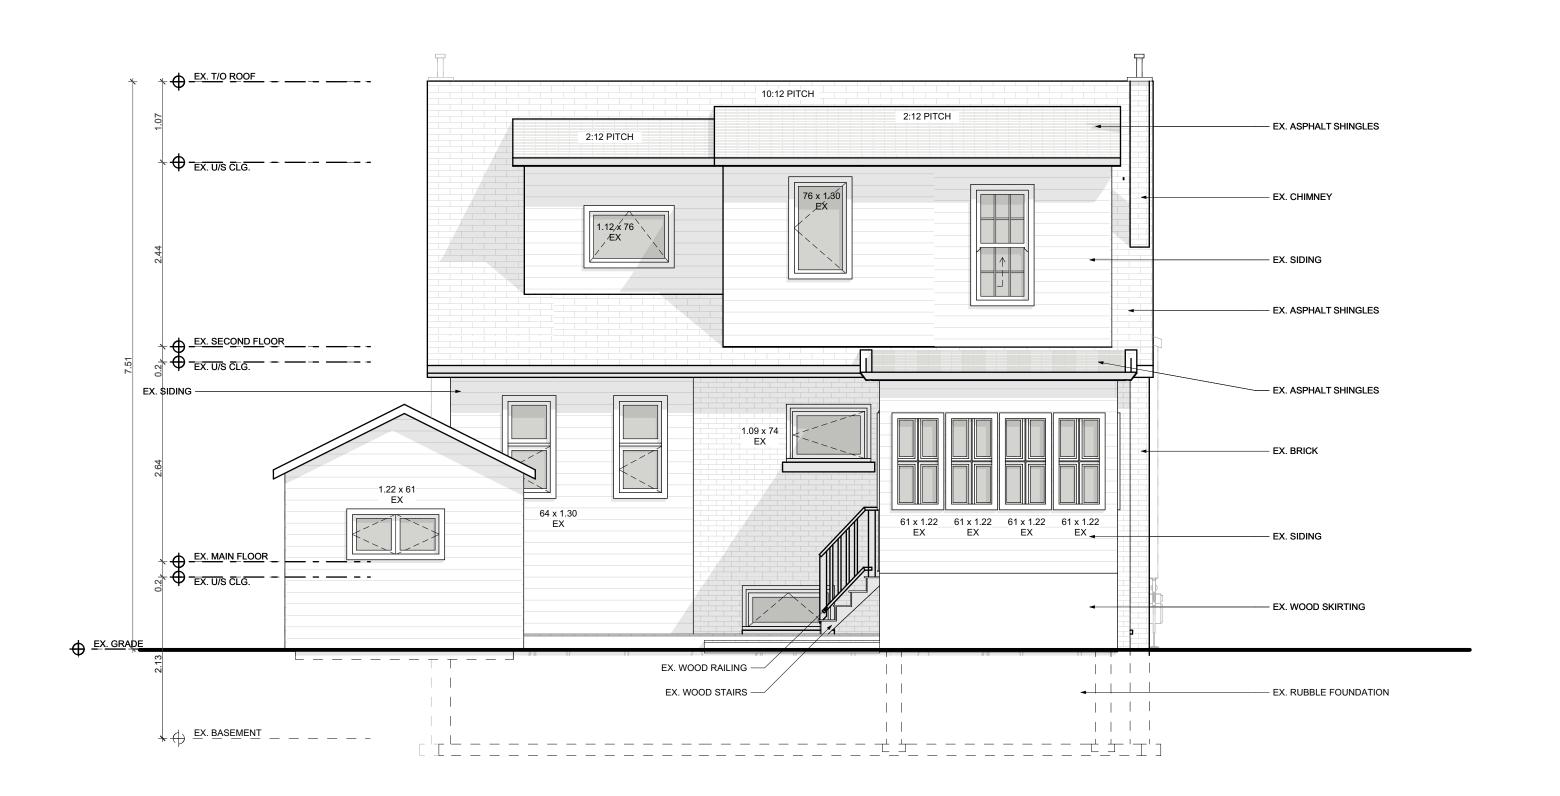



| NO. | REVISION | DATE |
|-----|---------------------|-----------|
| 1 | DESIGN 1.0 | 2022.02.2 |
| 2 | DESIGN 2.0 | 2022.03.2 |
| 3 | DESIGN 3.0 | 2022.04.2 |
| 4 | ISSUED FOR VARIANCE | 2022.05.3 |
| 5 | | |
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| | DRAWING: | |

EXISTING REAR ELEVATION


PROJECT:

HUNTER

PROJECT ADDRESS:

95 CHEDOKE AVENUE Hamilton ON L8P 4P2

DATE: 6/9/2022 DRAWING NO: AS NOTED A2.02 PROJECT NO:

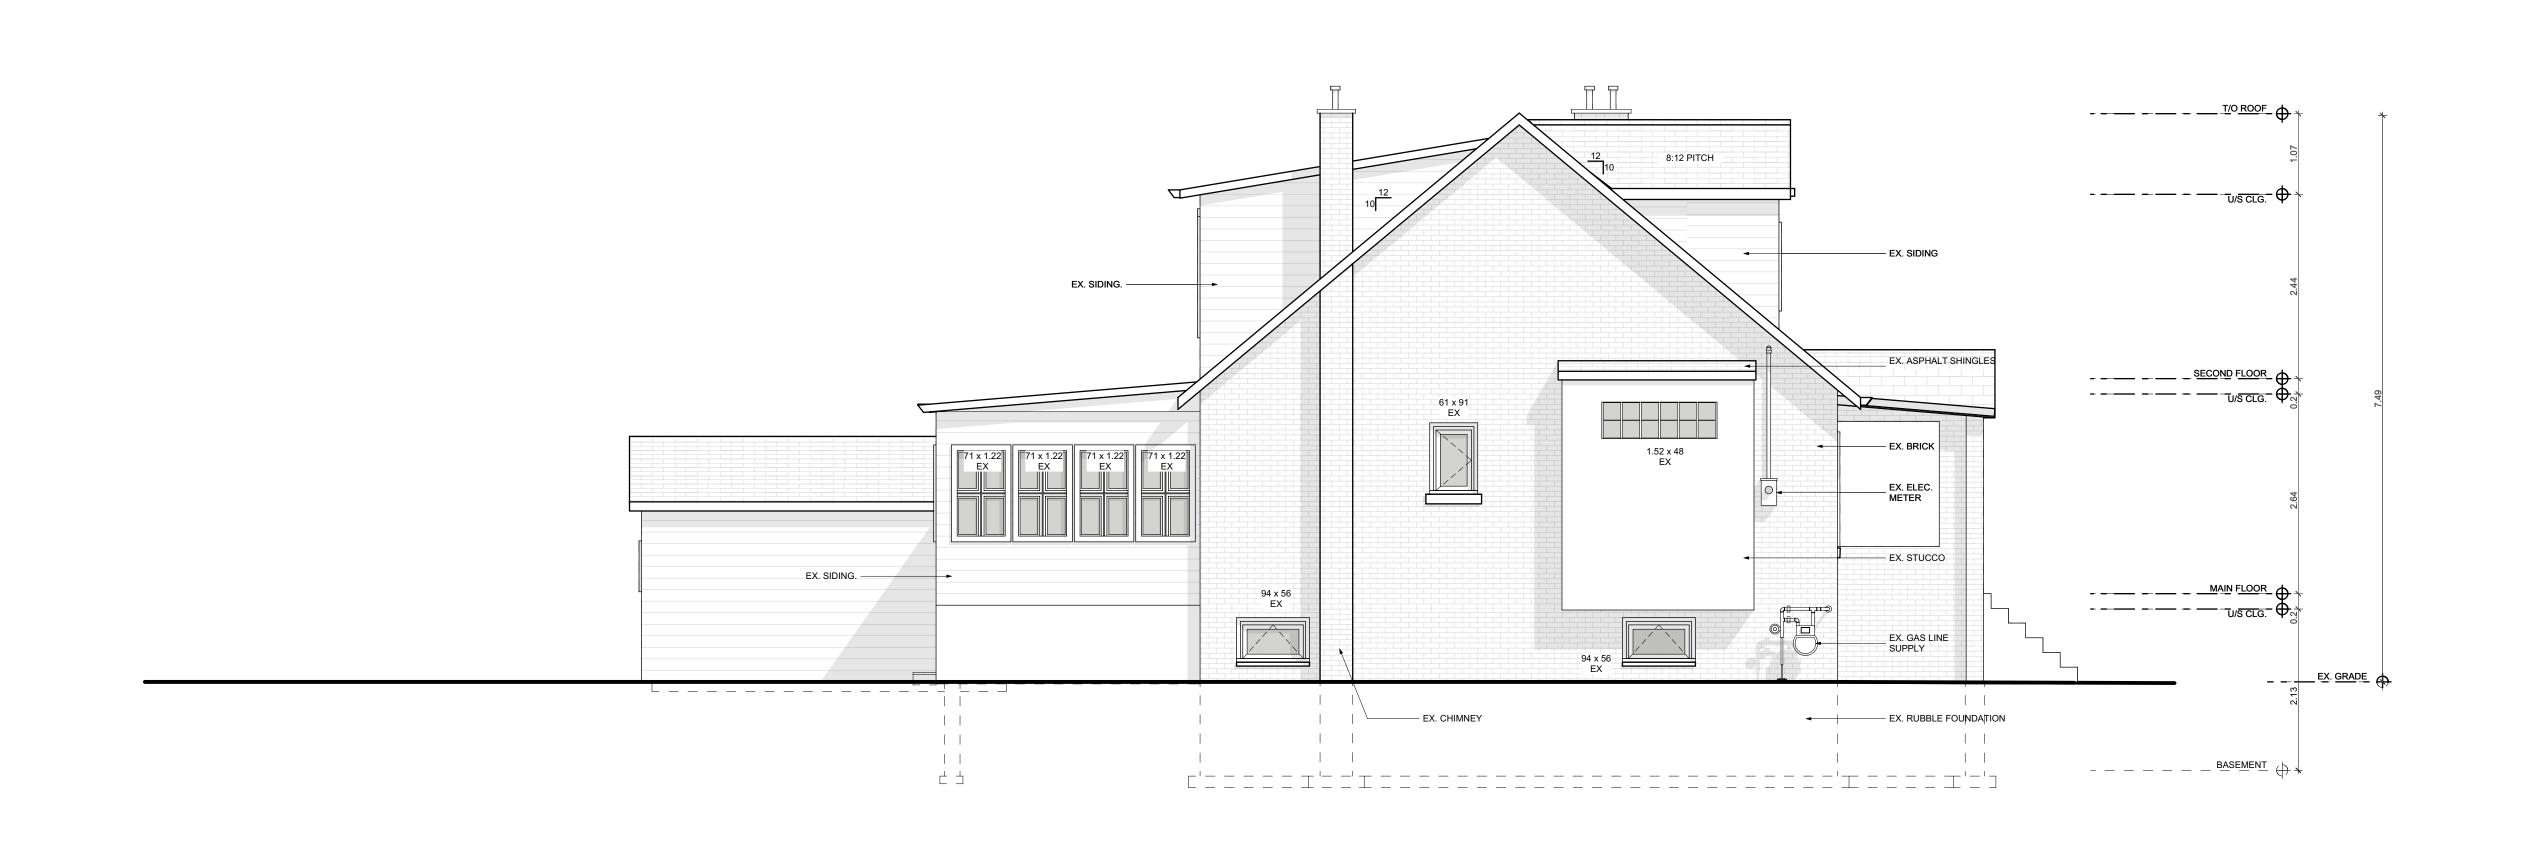




| NO. | REVISION | DATE |
|-----|---------------------|------------|
| 1 | DESIGN 1.0 | 2022.02.2 |
| 2 | DESIGN 2.0 | 2022.03.2 |
| 3 | DESIGN 3.0 | 2022.04.29 |
| 4 | ISSUED FOR VARIANCE | 2022.05.3 |
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| | DRAWING: | |

EXISTING LEFT ELEVATION

PROJECT: HUNTER

PROJECT ADDRESS: 95 CHEDOKE AVENUE Hamilton ON L8P 4P2

DATE: 6/9/2022 DRAWING NO: AS NOTED A2.03 PROJECT NO:

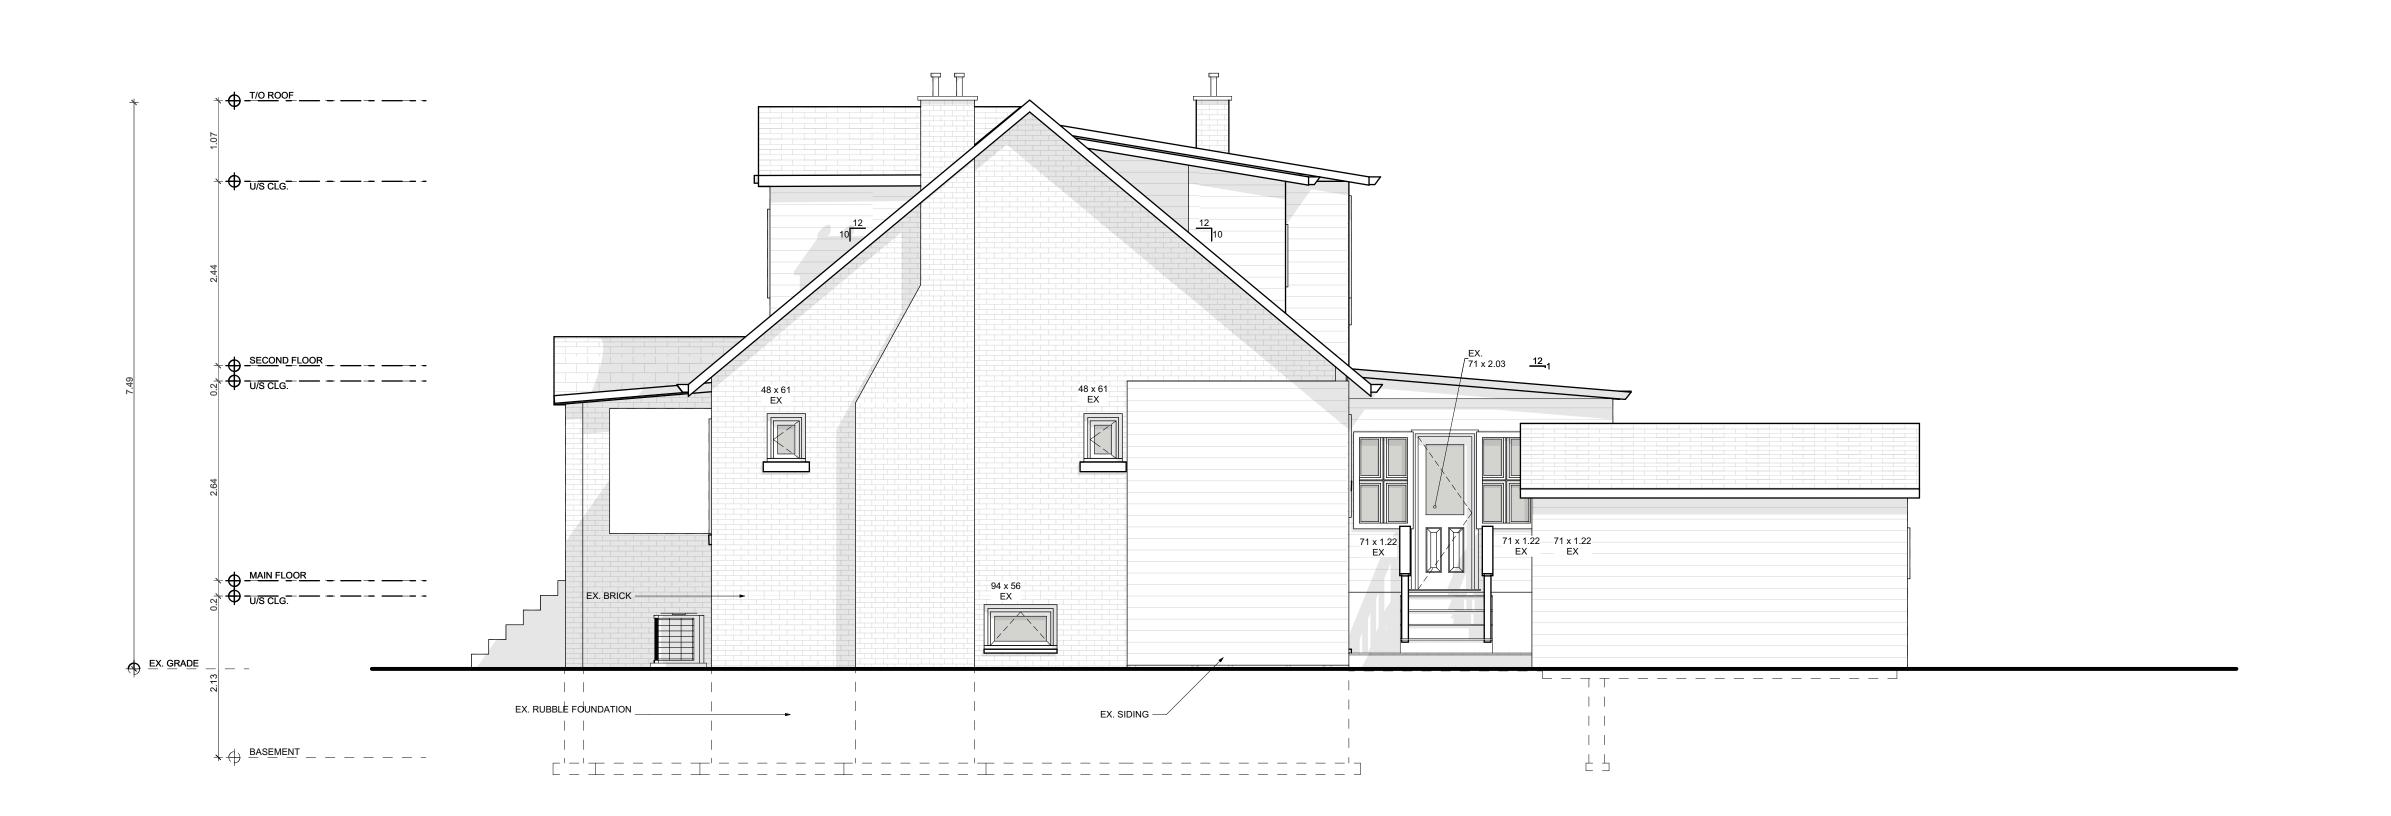



| NO. | REVISION | DATE |
|-----|---------------------|------------|
| 1 | DESIGN 1.0 | 2022.02.22 |
| 2 | DESIGN 2.0 | 2022.03.22 |
| 3 | DESIGN 3.0 | 2022.04.29 |
| 4 | ISSUED FOR VARIANCE | 2022.05.31 |
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| | DRAWING: | · |

EXISTING RIGHT ELEVATION

PROJECT:


HUNTER

PROJECT ADDRESS: 95 CHEDOKE AVENUE Hamilton ON L8P 4P2

DATE: 6/9/2022 DRAWING NO: AS NOTED

PROJECT NO:

A2.04

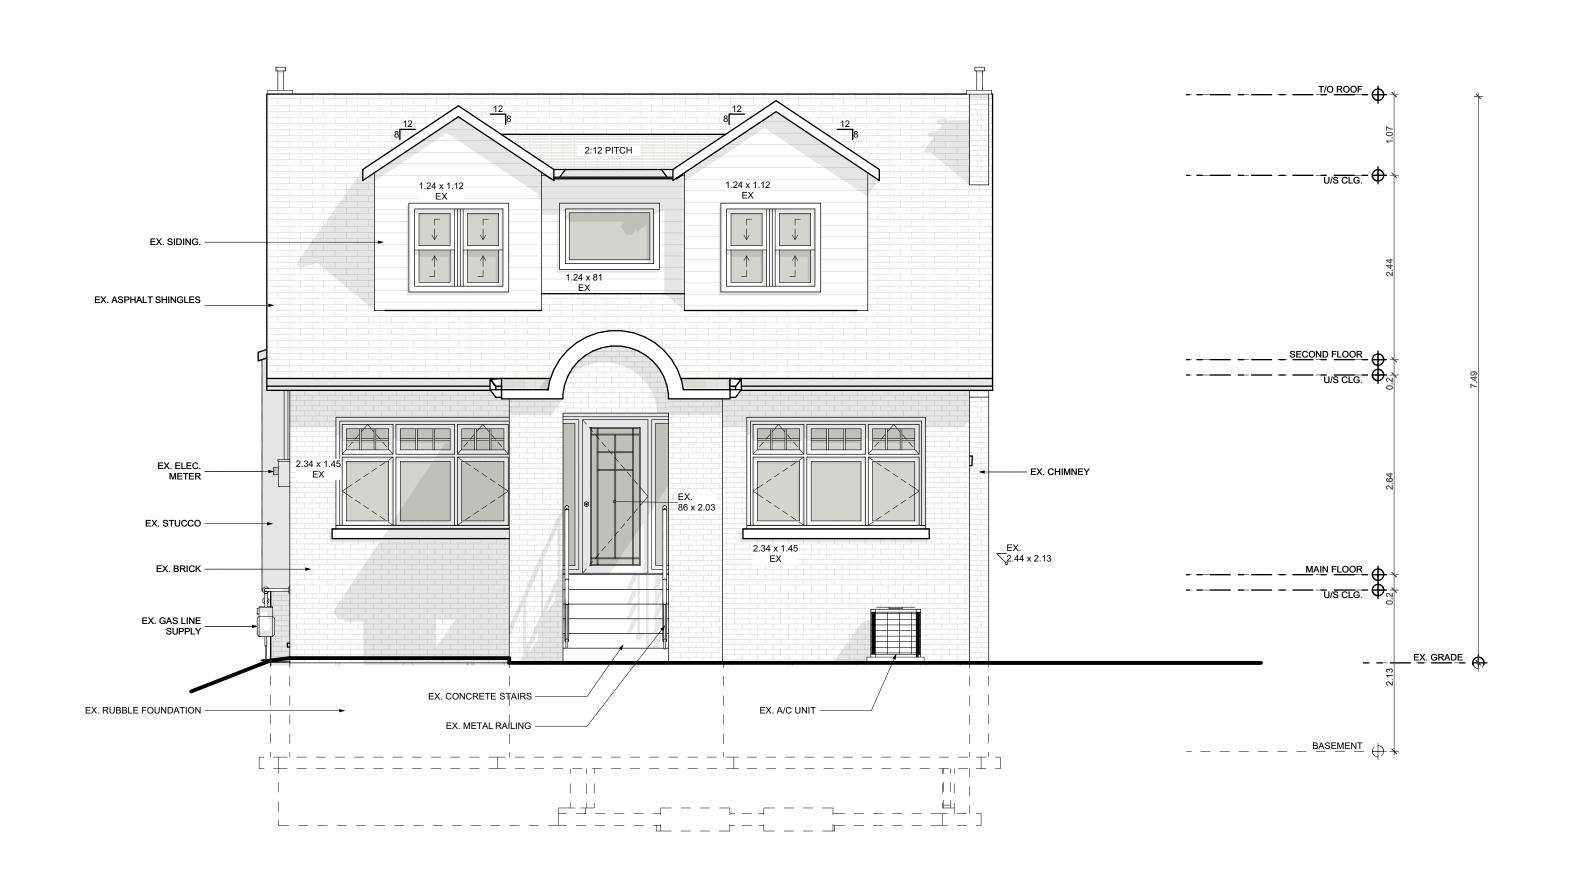



| NO. | REVISION | DATE |
|-----|------------------------|-----------|
| 1 | DESIGN 1.0 | 2022.02.2 |
| 2 | DESIGN 2.0 | 2022.03.2 |
| 3 | DESIGN 3.0 | 2022.04.2 |
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PROJECT: HUNTER


PROJECT ADDRESS:

95 CHEDOKE AVENUE Hamilton ON L8P 4P2

DATE: 6/9/2022 DRAWING NO: AS NOTED A2.05

PROJECT NO:

1 PROPOSED FRONT ELEVATION
SCALE: 1:50

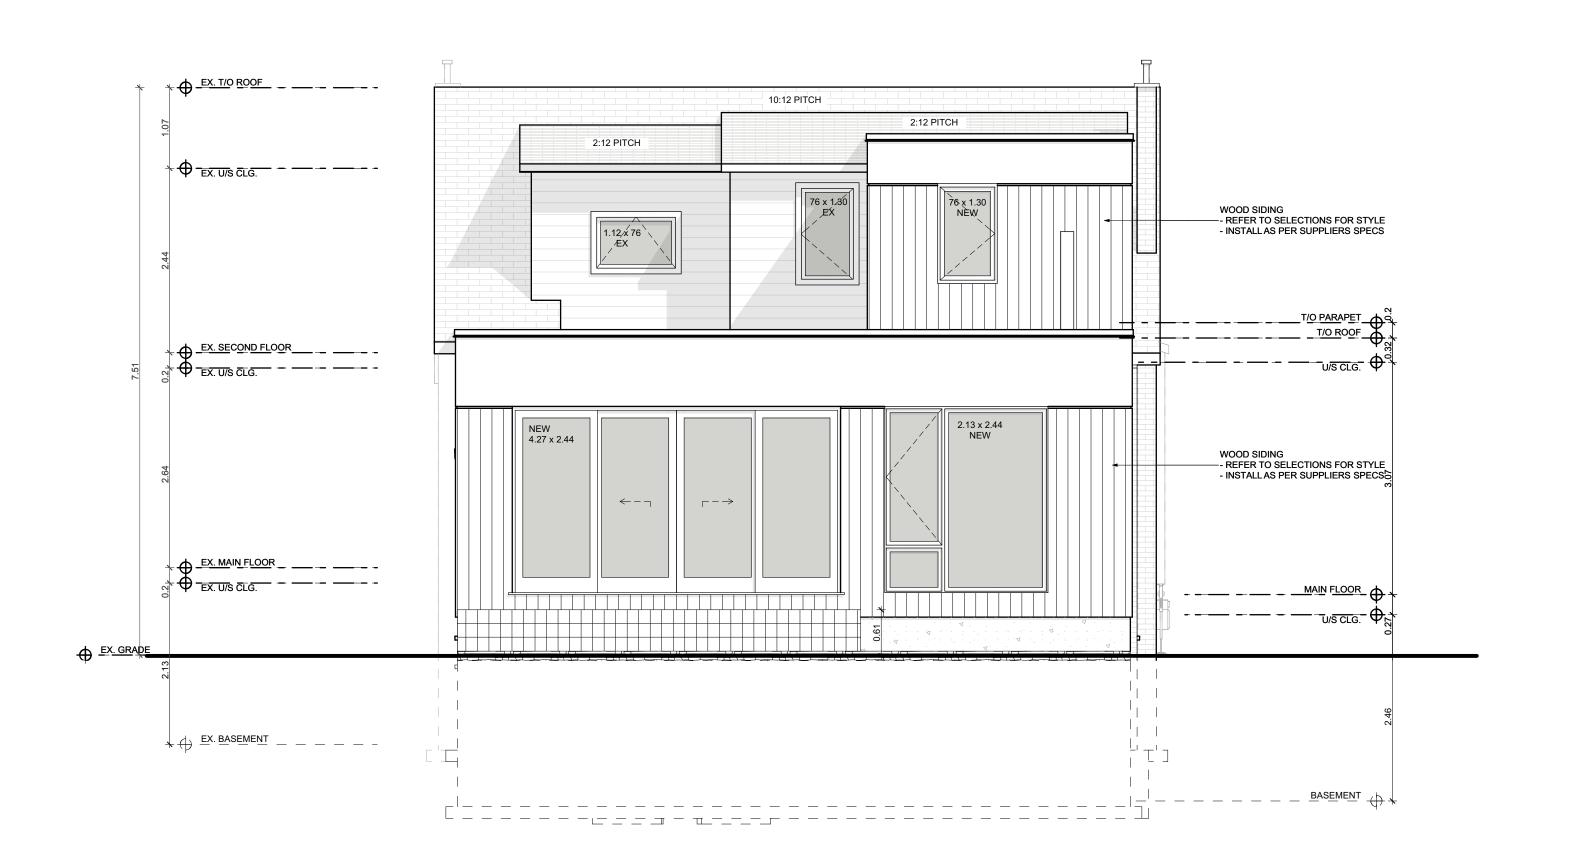



CONSTRUCTION

| NO. | REVISION | DATE |
|-----|---------------------|------------|
| 1 | DESIGN 1.0 | 2022.02.22 |
| 2 | DESIGN 2.0 | 2022.03.22 |
| 3 | DESIGN 3.0 | 2022.04.29 |
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DRAWING:
PROPOSED REAR
ELEVATION

PROJECT:
HUNTER

PROJECT ADDRESS:

95 CHEDOKE AVENUE Hamilton ON L8P

4P2

DATE: 6/9/2022


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CONSTRUCTION

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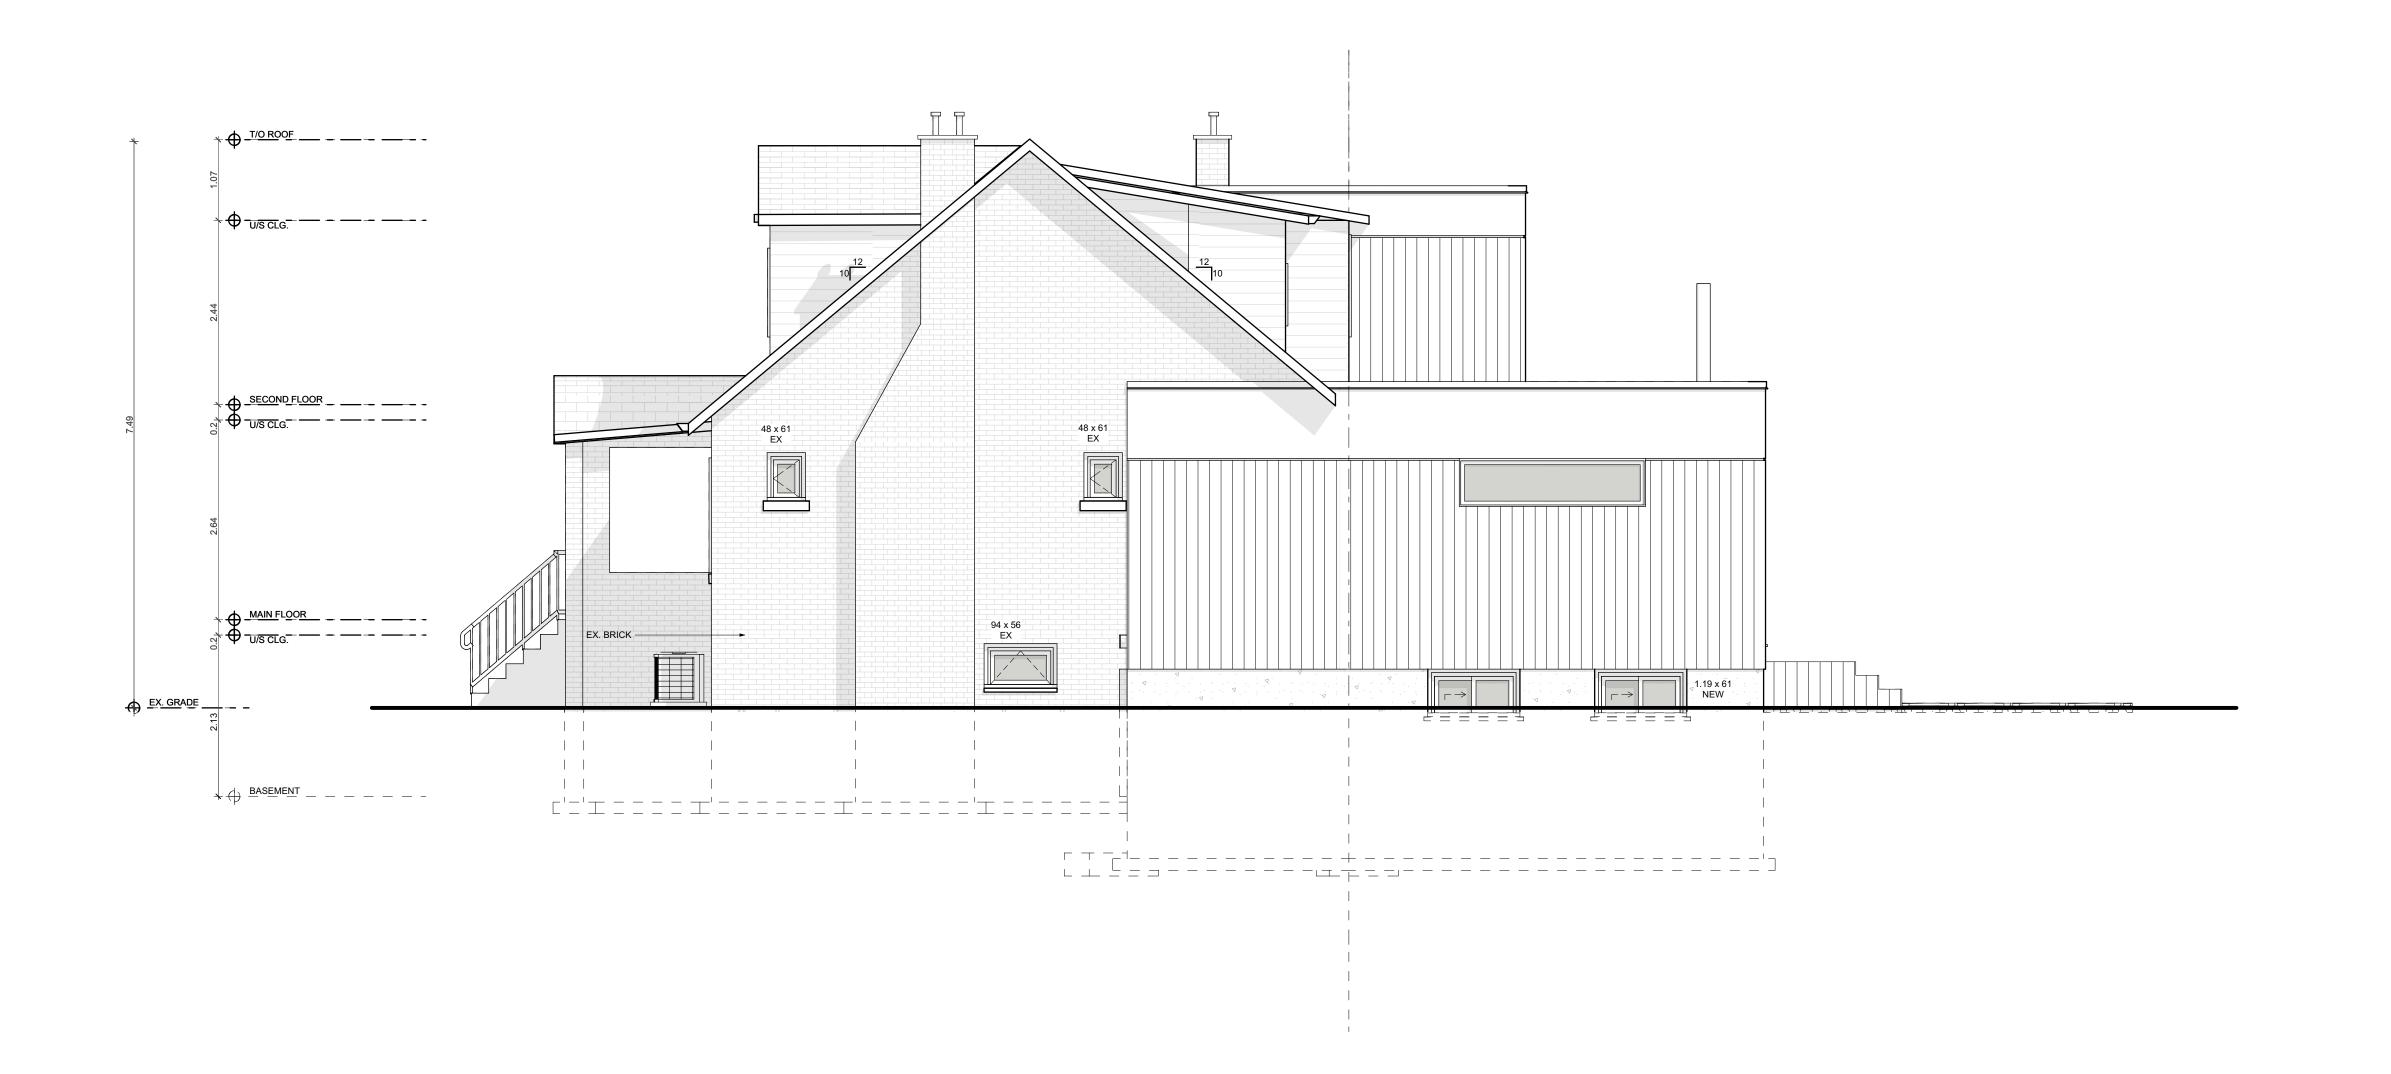
DRAWING: PROPOSED LEFT ELEVATION

PROJECT:
HUNTER

PROJECT ADDRESS: 95 CHEDOKE AVENUE Hamilton ON L8P 4P2

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| DATE : 6/9/2022 | | 6 |
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| AS NOTED | A207 | - |
| PROJECT NO: | A2.07 | Printed |

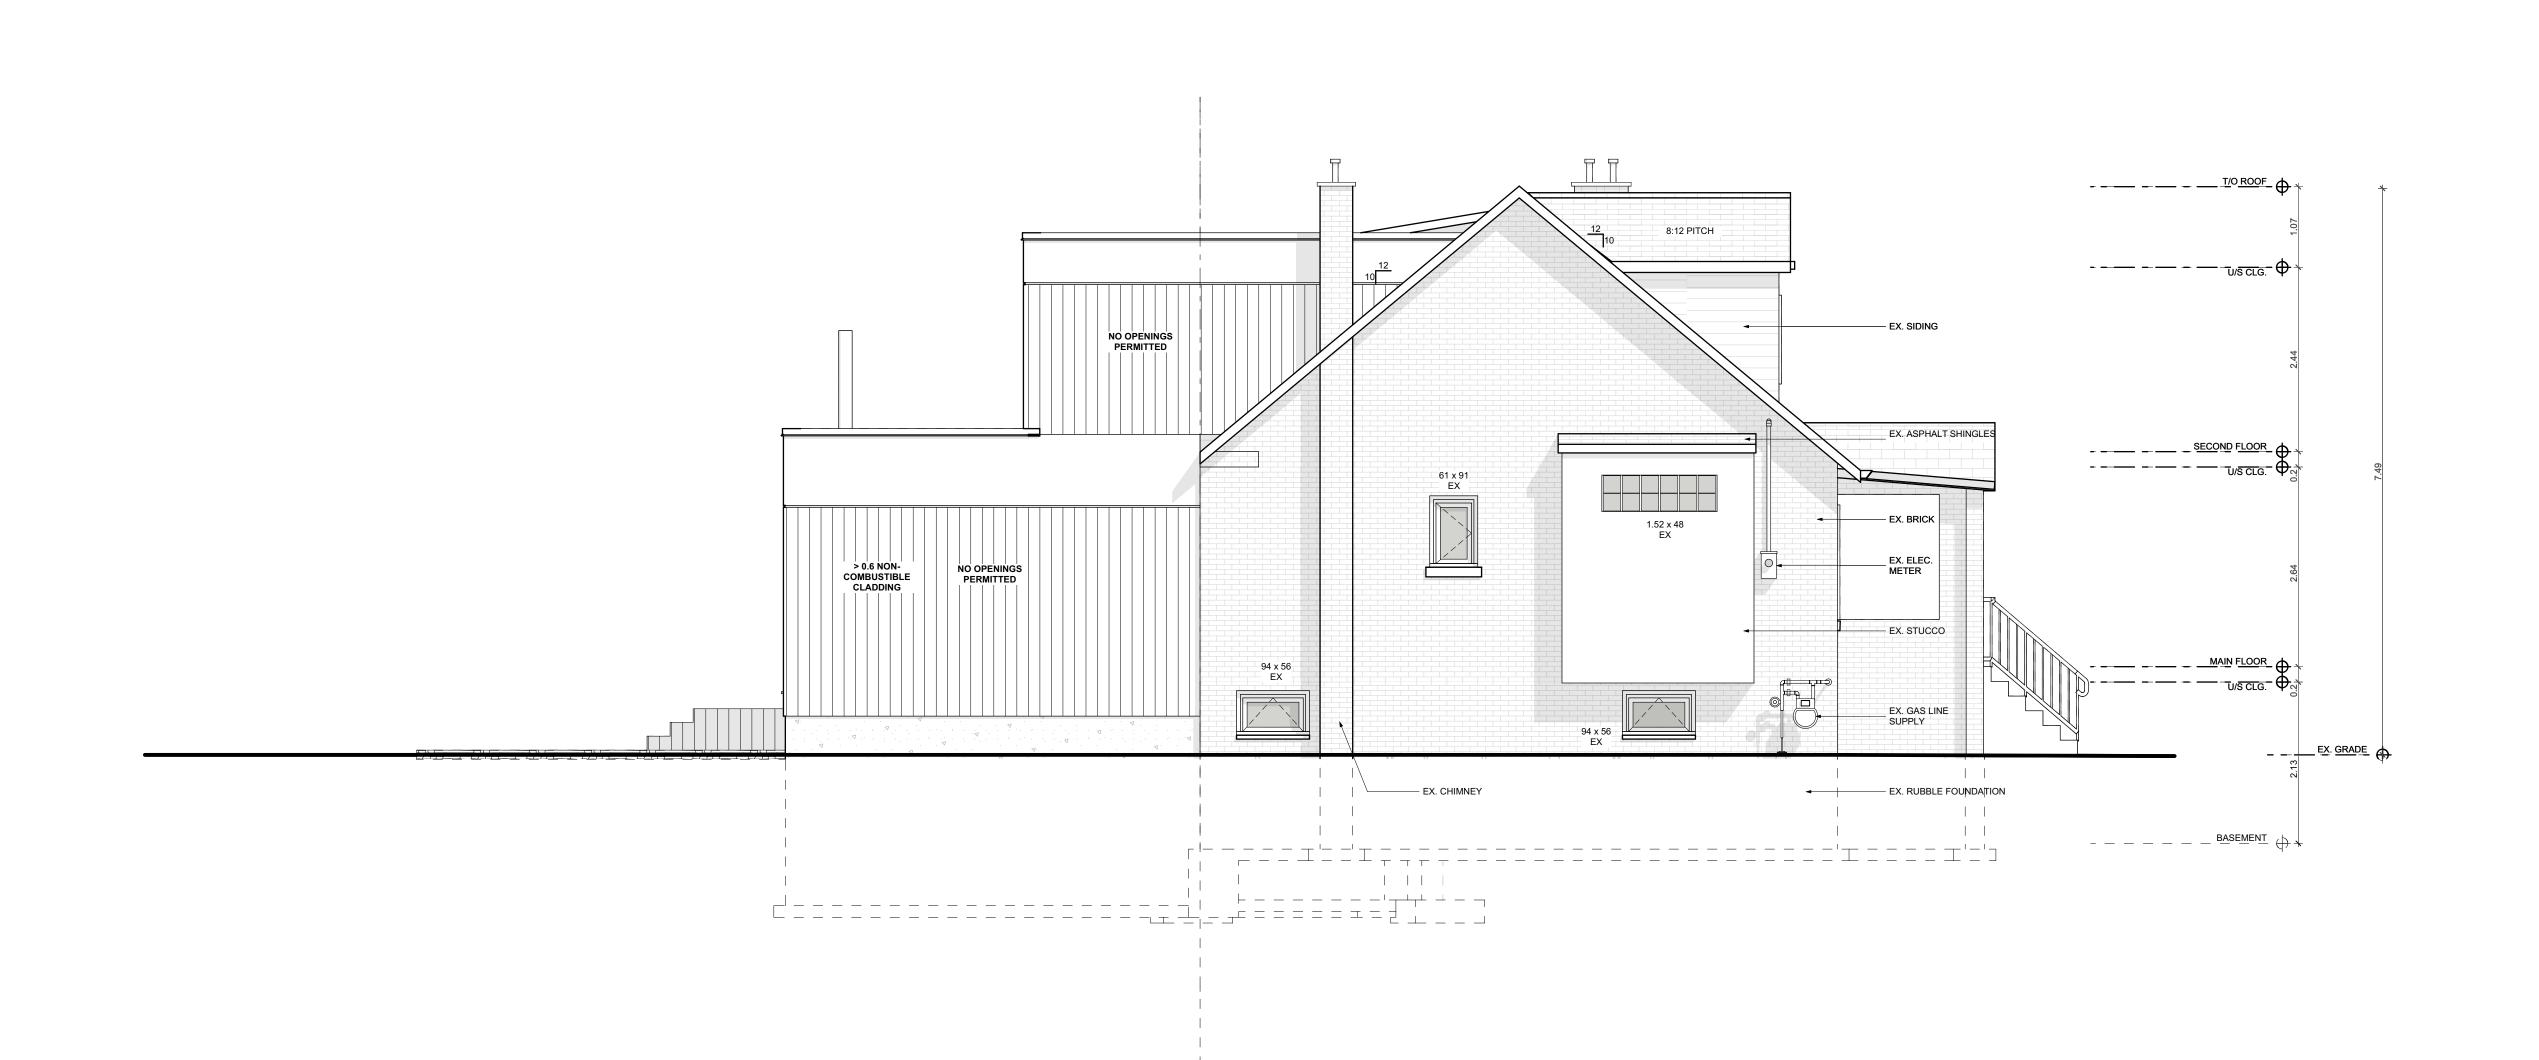



| REVISION | DATE |
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| DESIGN 1.0 | 2022.02.22 |
| DESIGN 2.0 | 2022.03.22 |
| DESIGN 3.0 | 2022.04.29 |
| ISSUED FOR VARIANCE | 2022.05.31 |
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| DRAWING: | · |
| | DESIGN 2.0 DESIGN 3.0 ISSUED FOR VARIANCE |

PROPOSED RIGHT **ELEVATION**

> PROJECT: HUNTER

PROJECT ADDRESS: 95 CHEDOKE AVENUE Hamilton ON L8P 4P2

DATE: 6/9/2022 DRAWING NO: AS NOTED A2.08 PROJECT NO:



Committee of Adjustment

City Hall, 5th Floor, 71 Main St. W., Hamilton, ON L8P4Y5

Phone: (905) 546-2424 ext. 4221

Email: cofa@hamilton.ca

APPLICATION FOR A MINOR VARIANCE

| FOR OFFICE USE ONLY | ſ. |
|--------------------------|----------------------------------|
| APPLICATION NO. | DATE APPLICATION RECEIVED |
| PAID | DATE APPLICATION DEEMED COMPLETE |
| SECRETARY'S SIGNATURE | |

The Planning Act

Application for Minor Variance or for Permission

The undersigned hereby applies to the Committee of Adjustment for the City of Hamilton under Section 45 of the *Planning Act*, R.S.O. 1990, Chapter P.13 for relief, as described in this application, from the Zoning By-law.

| 1, 2 | NAME | MAILING ADDRESS | |
|-------------------------|------------------------------------|-----------------|--|
| Registered Owners(s) | James Hunter & Barbara Connolly | | |
| Applicant(s)* | Louie Sayegh (TEAN SHANE) | | |
| Agent or Solicitor | Louie Sayegh (TEAN SHANE) | | |

Note: Unless otherwise requested all communications will be sent to the agent, if any.

3. Names and addresses of any mortgagees, holders of charges or other encumbrances:

TD Canada Trust Hamilton Cline 938 King Street West, ON L8S1K8

Additional sheets can be submitted if there is not sufficient room to answer the following questions. Additional sheets must be clearly labelled

| 4. | Nature and extent of relief applied for: | | | | | |
|-----|--|--|--|--|--|--|
| | 1.To permit a left side yard side setback of 0.4m instead of the required side yard setback of 1.2m | | | | | |
| | 2. Reduce required parking spaces from (2) to (1). | | | | | |
| | Second Dwelling Unit Reconstruction of Existing Dwelling | | | | | |
| 5. | Why it is not possible to comply with the provisions of the By-law? | | | | | |
| | 1. The proposed addition is within the required setback. The new proposed wall does not project past the existing building wall. 2. There is only space for (1) parking spot | | | | | |
| | and the state of t | | | | | |
| 6. | Legal description and Address of subject lands (registered plan number and lot number or other legal description and where applicable, street and street number): | | | | | |
| | 95 Chedoke Avenue. | | | | | |
| | L8P 4P2 Lot # 166, Plot # 403 | | | | | |
| | | | | | | |
| 7. | PREVIOUS USE OF PROPERTY | | | | | |
| | Residential Industrial Commercial | | | | | |
| | Agricultural Vacant | | | | | |
| | Other N/A | | | | | |
| | | | | | | |
| 8.1 | If Industrial or Commercial, specify use N/A | | | | | |
| 8.2 | Has the grading of the subject land been changed by adding earth or other material, i.e. has filling occurred? | | | | | |
| | Yes ☐ No ■ Unknown ☐ | | | | | |
| 8.3 | Has a gas station been located on the subject land or adjacent lands at any time? Yes ☐ No ■ Unknown ☐ | | | | | |
| 8.4 | Has there been petroleum or other fuel stored on the subject land or adjacent lands? | | | | | |
| | Yes ☐ No ■ Unknown ☐ | | | | | |
| 8.5 | Are there or have there ever been underground storage tanks or buried waste on the subject land or adjacent lands? | | | | | |
| | Yes ☐ No ■ Unknown ☐ | | | | | |
| 8.6 | Have the lands or adjacent lands ever been used as an agricultural operation where cyanide products may have been used as pesticides and/or sewage sludge was applied to the lands? | | | | | |
| | Yes No Unknown | | | | | |
| 8.7 | Have the lands or adjacent lands ever been used as a weapon firing range? | | | | | |
| | Yes ☐ No ■ Unknown ☐ | | | | | |
| 8.8 | Is the nearest boundary line of the application within 500 metres (1,640 feet) of the fill area of an operational/non-operational landfill or dump? | | | | | |
| 0.0 | Yes ☐ No ■ Unknown ☐ | | | | | |
| 8.9 | If there are existing or previously existing buildings, are there any building materials remaining on site which are potentially hazardous to public health (eg. asbestos, PCB's)? | | | | | |
| | Yes ☐ No ■ Unknown ☐ | | | | | |

| DocuSign Env | velope ID: B88A2BFA-2254-4 | 4BF6-A397-507E | 2CF9461C | | | | | |
|--|---|----------------|-----------------------------|--------------|--------------|-----------|-------------|---------------|
| 8.10 Is there any reason to believe the subject land may have been contaminated by uses on the site or adjacent sites? | | | | | | | d by former | |
| | Yes | No 🔳 | Unkno | wn | | | | |
| 8.11 | What information of Previous uses of | | | | wers to 8. | 1 to 8.10 | 0 above | ∍? |
| | T TOVIOUS USSS S. | | |) - | | | | |
| 8.12 | If previous use of previous use inver land adjacent to the | ntory showin | ng all forme | er uses of t | | | • | • |
| | Is the previous use | e inventory ៖ | attached? | Yes | | No | | N/A |
| 9. | ACKNOWLEDGE | MENT CLA | USE | | | | | |
| | I acknowledge that remediation of con reason of its appro- 6/2/2022 | ntamination o | on the prop Application. | erty which | h is the sul | | this Ap | plication – b |
| | Date | | | Signatur | e Property | / Owner | (S) | _ |
| | | | | James | Hunter | Ва | arbara | Connolly |
| | | | | Print Nar | me of Owr | ner(s) | | _ |
| 10. | Dimensions of land | ds affected: | | | | | | |
| | Frontage | 12.19 | | | | | | |
| | Depth | 33.53 | | | | | | |
| | Area | 408 | | | | | | |
| | Width of street | 7.6 | | | | | | |
| 11. | Particulars of all buildings and structures on or proposed for the subject lands: (Specify ground floor area, gross floor area, number of stories, width, length, height, etc.) | | | | | | | |
| | Existing:_ See site plan | | | | | | | |
| | See site plair | | | | | | | |
| | Proposed | | | | | | | |
| | See site plan | | | | | | | |
| | | | | | | | | |
| 12. | Location of all build distance from side | | | | sed for the | e subjec | t lands | ; (Specify |
| | Existing: | | | | | | | _ |
| | See site plan | | | | | | | |
| | | | | | | | | |
| | | | | | | | | |
| | Proposed: | | | | | | | |
| | See site plan | | | | | | | |
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