

COMMITTEE OF ADJUSTMENT

City Hall, 5th floor, 71 Main Street West, Hamilton, ON L8P 4Y5
Telephone (905) 546-2424, ext. 4221, 3935

E-mail: cofa@hamilton.ca

NOTICE OF PUBLIC HEARING Minor Variance

You are receiving this notice because you are either:

- Assessed owner of a property located within 60 metres of the subject property
- Applicant/agent on file, or
- Person likely to be interested in this application

APPLICATION	SC/A-22:231	SUBJECT	35 UPPER LAKE AVENUE,
NO.:		PROPERTY:	STONEY CREEK
ZONE:	R2 and OS (Residential Two;	ZONING BY-	Zoning By-law former City of
	Open Space)	LAW:	Stoney Creek 3692-92, as
			Amended

APPLICANTS: Owner – William & Sharon Houston

Agent – Sean Lachepele

The following variances are requested:

1. One (1) parking space shall be provided instead of the minimum required two (2) parking spaces.

PURPOSE & EFFECT: To permit the construction of an addition in the Northerly and Southerly side yards and a front porch expansion in the front and Northerly side yard

Notes:

- 1. Insufficient information has been provided for parking within the proposed garage and the driveway within the front yard. Section 6.3.4 of Stoney Creek Zoning By- Law 3692-92 requires a minimum number of two (2) parking spaces per dwelling of which only one may be provided in the required front yard. Tandem parking is permitted. Parking spaces within the attached, private garage shall be 6.0 m x 3.0 m. The proposed garage does not appear to provide ample space for the required parking space. As such, a variance has be added to address this.
- 2. Be advised, as per Section 4.10.2 b) of Stoney Creek Zoning By-Law 3692-92, any parking space other than a 90 degree parking space shall have a width of 3.0 m and a length of 6.0 m. Insufficient information has been provided regarding parking spaces on the driveway. Should the parking space within the driveway not meet the required dimensions of a parking space, additional variances may be required.
- 3. Insufficient information has been provided for the front porch stairs. An unenclosed porch, including the stairs, may project into any required front yard 1.5 metres. It appears that the proposed front

SC/A-22:231

- porch stairs encroach beyond the maximum permitted 1.5 metres. Should the porch and stairs encroach further than the permitted 1.5 metres, additional variances may be required.
- 4. Be advised, a portion of the property is within the OS (Open Space) zone which does not permit a Single Family Dwelling or Uses, Buildings or Structures accessory to the Single Family Dwelling use. Insufficient information has been provided regarding the location of the proposed addition(s) to the Single Family Dwelling in relation to the Open Space zone. Should any portion of the proposed expansion to the Single Family Dwelling be within the Open Space zone, additional variances may be required.

This Notice must be posted by the owner of any land which contains seven or more residential units so that it is visible to all residents.

This application will be heard by the Committee as shown below:

DATE:	Thursday, August 11, 2022	
TIME:	2:05 p.m.	
PLACE:	Via video link or call in (see attached sheet for details)	
	2 nd floor City Hall, room 222 (see attached sheet for	
	details), 71 Main St. W., Hamilton	
	To be streamed (viewing only) at	
	www.hamilton.ca/committeeofadjustment	

For more information on this matter, including access to drawings illustrating this request and other information submitted:

- Visit www.hamilton.ca/committeeofadjustment
- Visit Committee of Adjustment staff at 5th floor City Hall, 71 Main St. W., Hamilton
- Call 905-546-CITY (2489) or 905-546-2424 extension 4221, 4130, or 3935

PUBLIC INPUT


Written: If you would like to submit written comments to the Committee of Adjustment you may do so via email or hardcopy. Please see attached page for complete instructions, <u>including deadlines</u> for submitting to be seen by the Committee.

Orally: If you would like to speak to this item at the hearing you may do so via video link, calling in, or attending in person. Please see attached page for complete instructions, including deadlines for registering to participate virtually and instructions for check in to participate in person.




DATED: July 26, 2022

Jamila Sheffield, Secretary-Treasurer Committee of Adjustment Information respecting this application is being collected under the authority of the Planning Act, R.S.O., 1990, c. P. 13. All comments and opinions submitted to the City of Hamilton on this matter, including the name, address, and contact information of persons submitting comments and/or opinions, will become part of the public record and will be made available to the Applicant and the general public, and may include posting electronic versions.

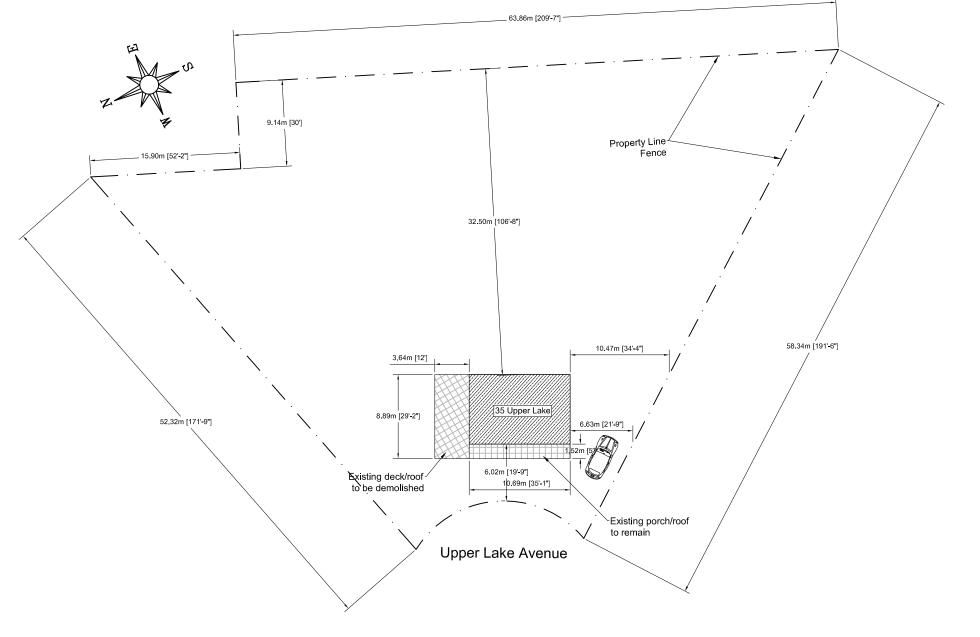



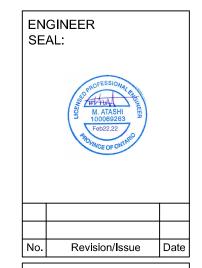


35 Upper Lake Avenue Stoney Creek Ontario

TITLE:

Existing Site Plan

SCALE:	DRAWING NO.
DESIGNED BY:	004.04
APPROVED BY:	SP1.01

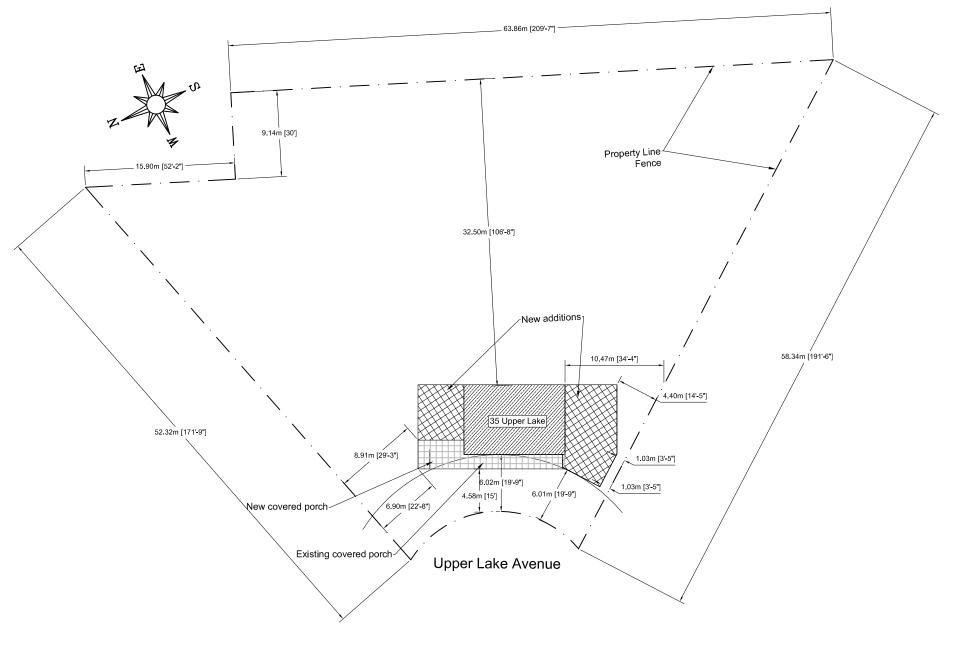

Proposed Site Plan

Scale 1:400

BUILDING AND SITE STATISTICS RESIDENTIAL BUILDING ZONE R2 LOT AREA = 2399 m^2 MAXIMUM LOT COVERAGE 40% HEIGHT OF BUILDING = 7.42 m MAXIMUM HEIGHT OF BUILDING = 11 m

LOT COVERAGE (SQ.m)				
	EXISTING	PROPOSED	TOTAL	%
FIRST FLOOR	78.77	81.39	160.16	6.7
COVERED PORCH/DECK (SEE NOTE 1)	16.25+32.36	14.87	31.12	1.3
TOTAL			191.28	8

NOTE1-PART OF EXISTING COVERED PORCH/DECK WHICH IS 32.36m² TO BE DEMOLISHED



PROJECT:

35 Upper Lake Avenue Stoney Creek Ontario

TITLE:

Proposed Site Plan


SauzTeq Engineering Inc.

www.Sauzteq.ca Tel: 905-330-2431 Email: info@sauzteq.ca

SCALE:	DRAWING NO.
DESIGNED BY:	0.04.00
APPROVED BY:	SP1.02

NEW ADDITION FOR THE EXISTING RESIDENTIAL BUILDING LOCATED AT 35 UPPER LAKE AVENUE, HAMILTON, ONTARIO

SHEET INDEX	
S0.01	COVER SHEET
SP1.01	EXISTING SITE PLAN
SP1.02	PROPOSED SITE PLAN
S1.01	EXISTING PLAN AT BASEMENT
S1.02	EXISTING PLAN AT FIRST FLOOR
S1.03	EXISTING PLAN AT SECOND FLOOR
S1.04	PROPOSED PLAN AT BASEMENT
S1.05	PROPOSED PLAN AT FIRST LEVEL
S1.06	PROPOSED PLAN AT SECOND LEVEL
S1.07	PROPOSED ROOF PLAN
S2.01	EAST VIEW
S2.02	WEST VIEW
S2.03	NORTH VIEW
S2.04	SOUTH VIEW
S2.05	SECTION A
S2.06	SECTION B
S5.01	SCHEDULES, GENERAL NOTES

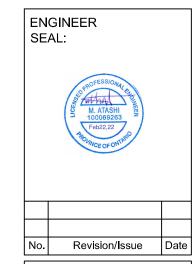


PROJECT:


35 Upper Lake Avenue Stoney Creek Ontario

TITLE:

Cover Page

SCALE:	DRAWING NO.
DESIGNED BY:	S0.01
APPROVED BY:	30.01

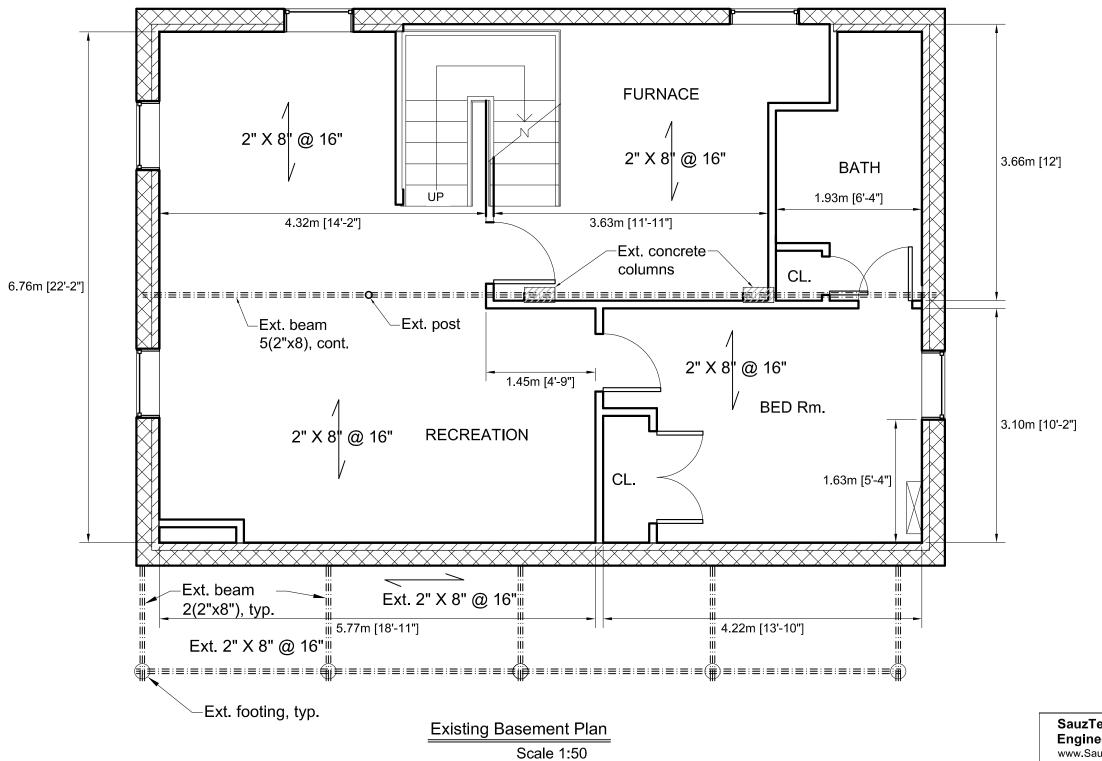

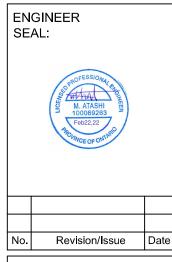



35 Upper Lake Avenue Stoney Creek Ontario

TITLE: Existing Basement Plan

SauzTeq Engineering Inc. www.Sauzteq.ca Tel: 905-330-2431

SCALE: DRAWING NO. DESIGNED BY: S1.01 APPROVED Email: info@sauzteq.ca

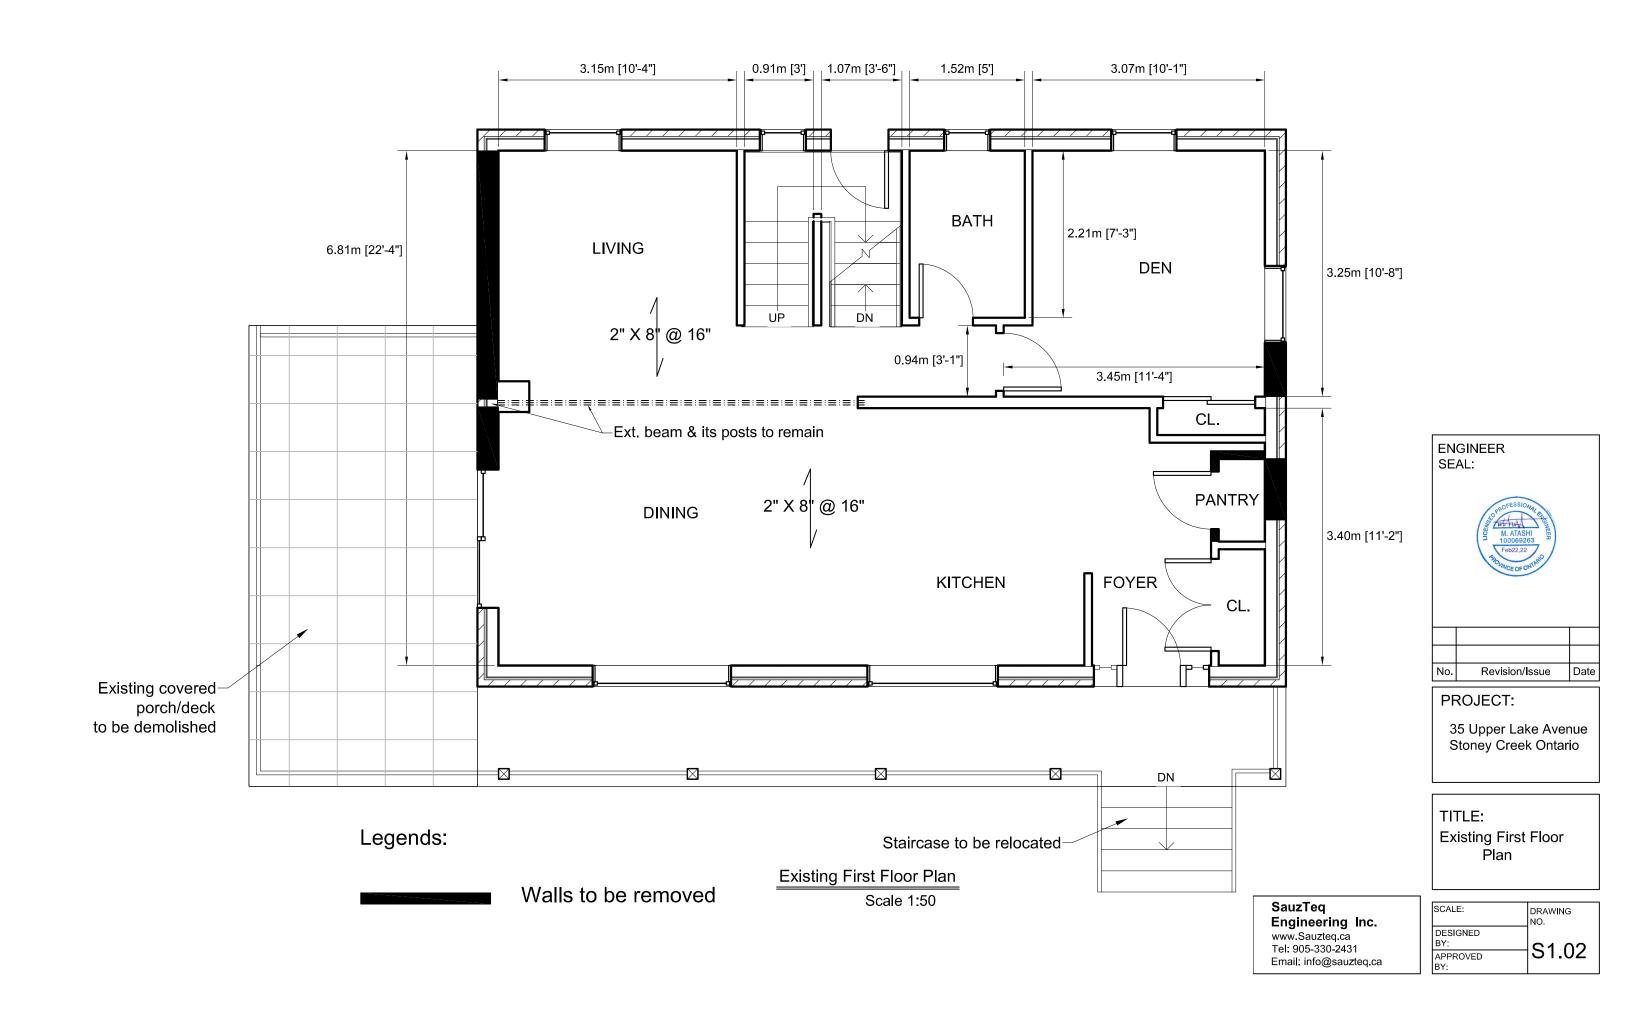

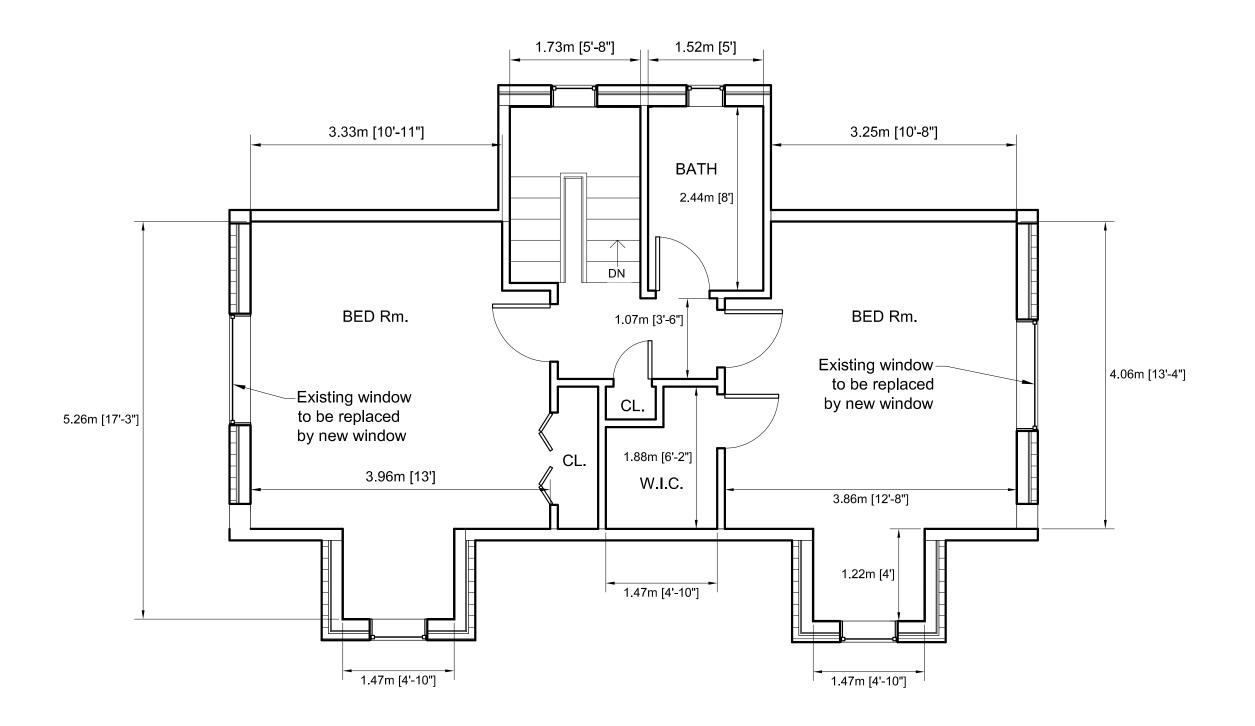



35 Upper Lake Avenue Stoney Creek Ontario


TITLE: Existing Second Floor Plan

SauzTeq Engineering Inc. www.Sauzteq.ca Tel: 905-330-2431 Email: info@sauzteq.ca

SCALE:	DRAWING NO.
DESIGNED BY:	C4 02
APPROVED BY:	31.03

Existing Second Floor Plan

Scale 1:50

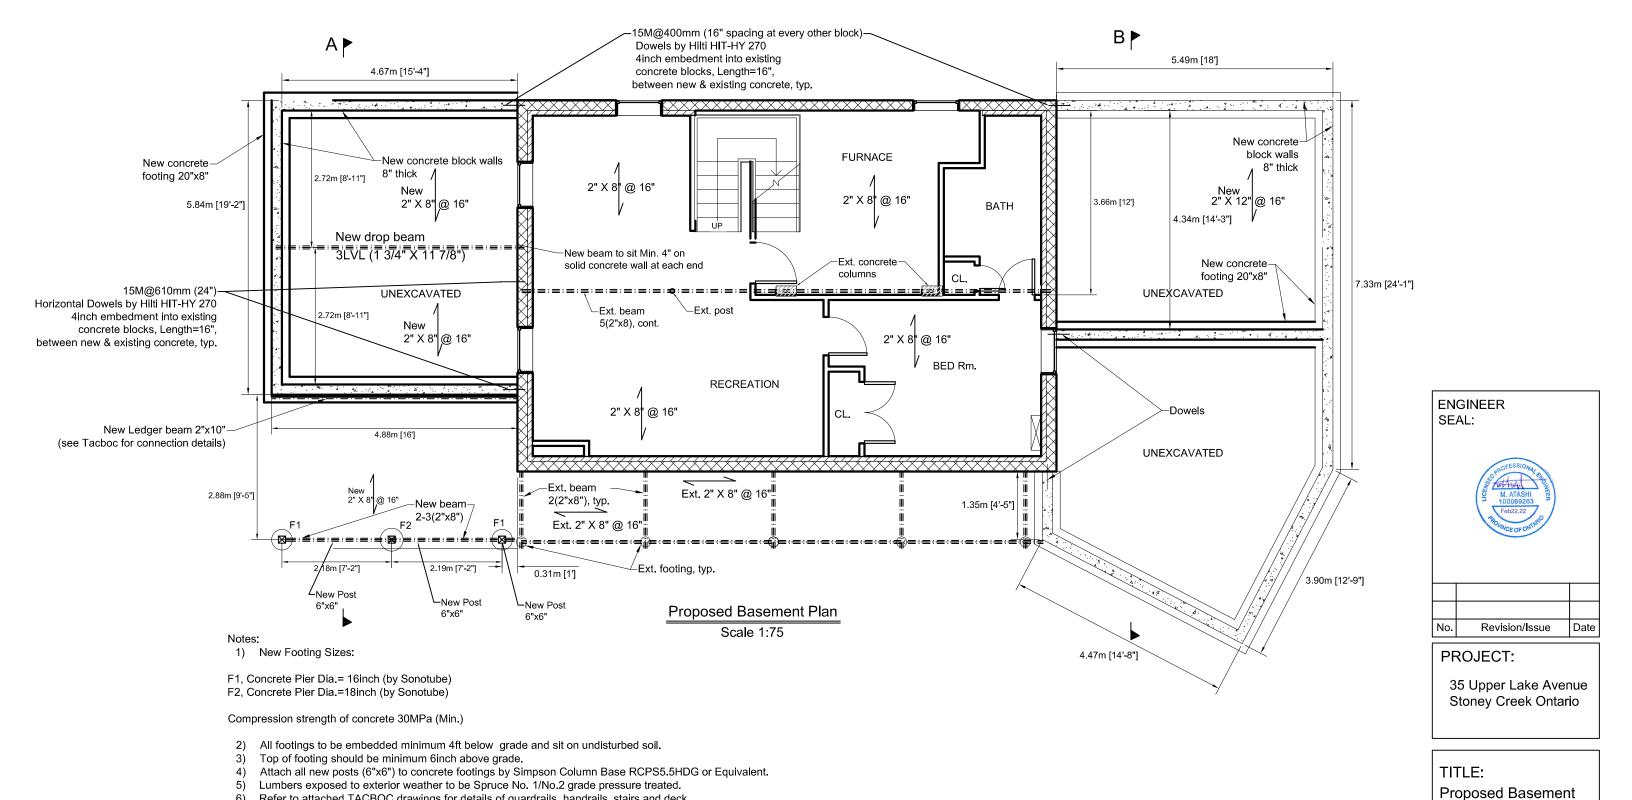


Refer to attached TACBOC drawings for details of guardrails, handrails, stairs and deck.

7) Do not damage or disturb soil under existing footings.

SauzTeq Engineering Inc. www.Sauzteq.ca

Tel. 905-330-2431 Email: info@sauzteq.ca SCALE: DRAWING DESIGNED S1.04 APPROVED

Plan

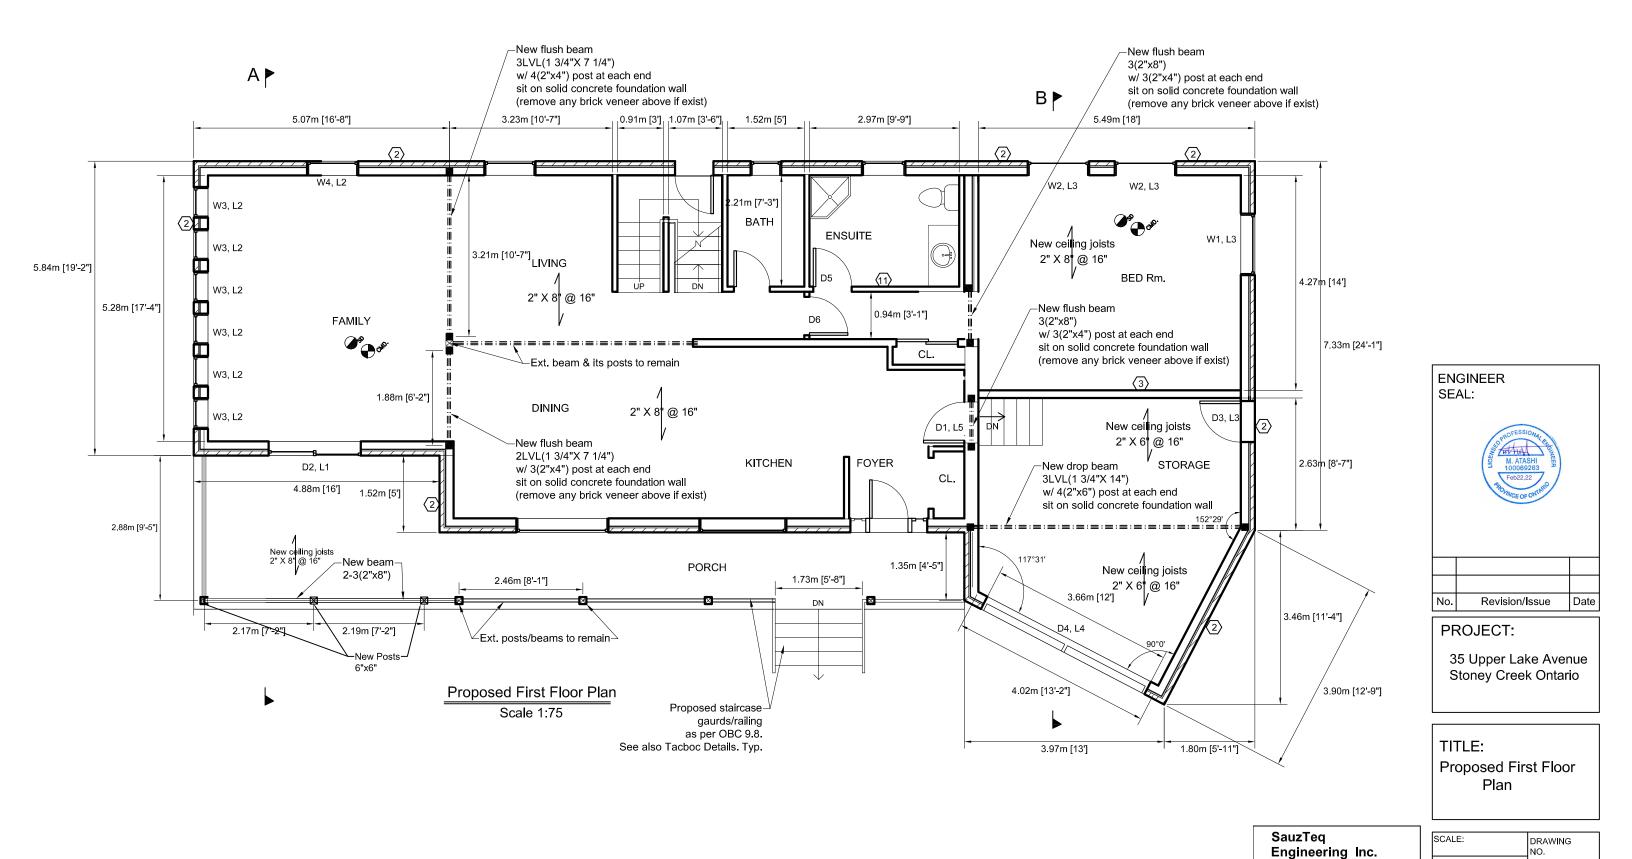

DESIGNED BY:


APPROVED

S1.05

www.Sauzteq.ca

Tel. 905-330-2431

Email: info@sauzteq.ca

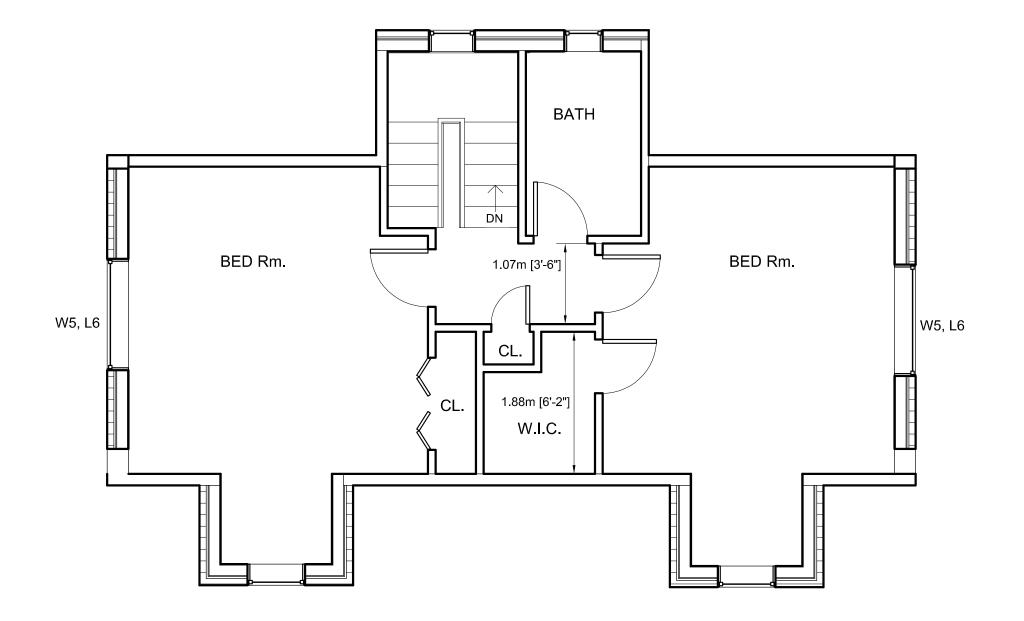






35 Upper Lake Avenue Stoney Creek Ontario

TITLE:

Proposed Second Floor Plan

SCALE:	DRAWING NO.
DESIGNED BY:	S1.06
APPROVED BY:	

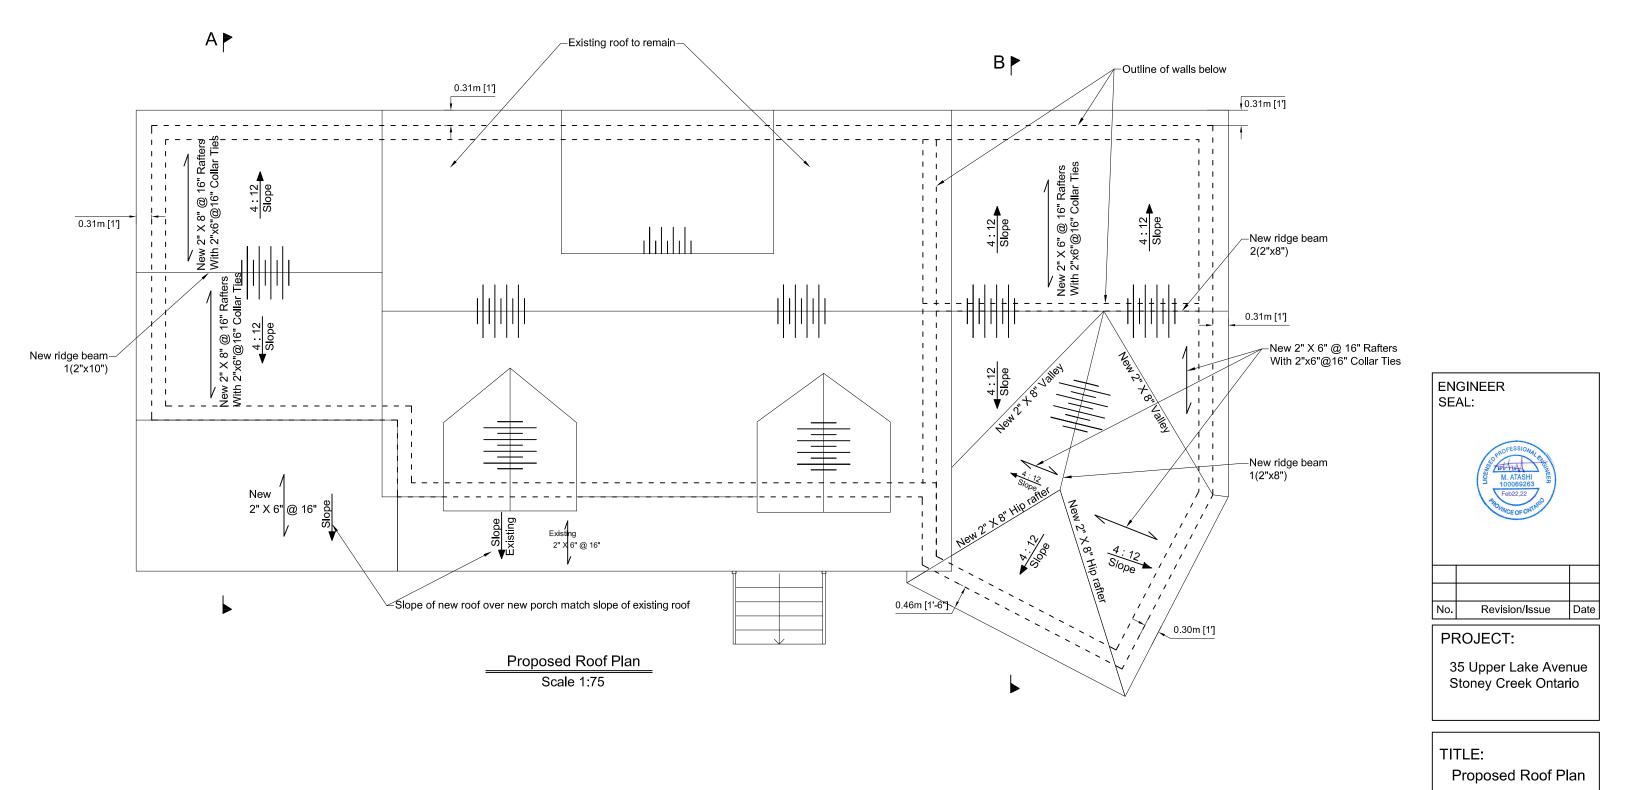

SCALE:


DESIGNED
BY:
APPROVED
BY:

SauzTeq

Engineering Inc.


Email: info@sauzteq.ca

www.Sauzteq.ca Tel: 905-330-2431

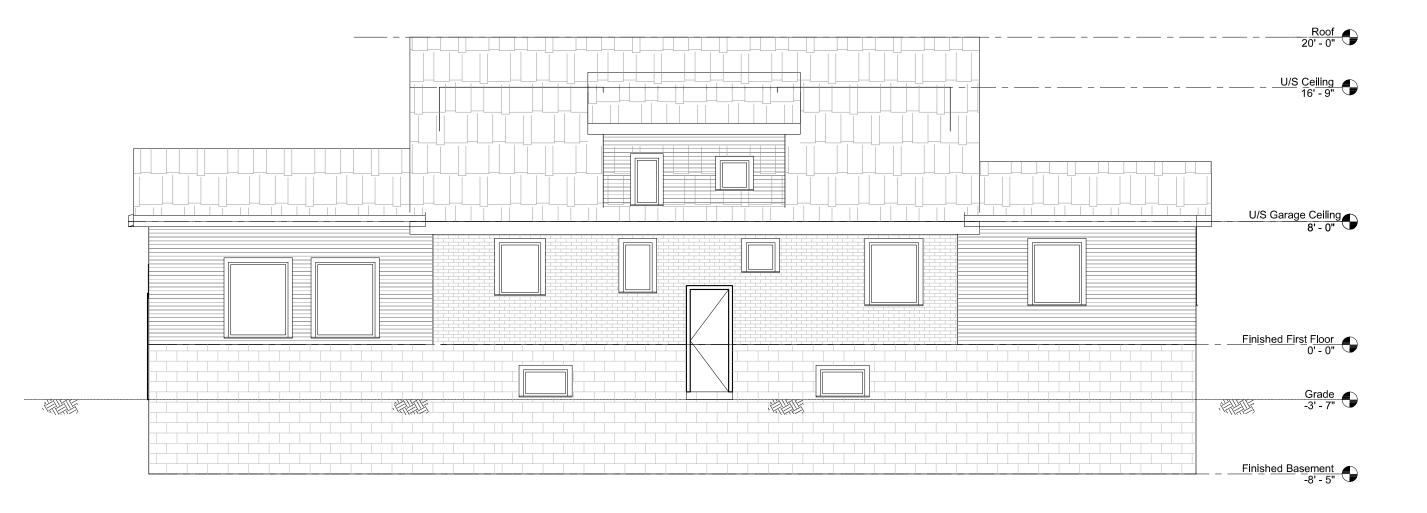

East View

Scale 1:75

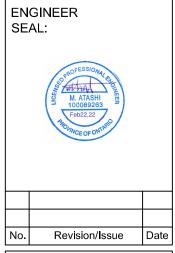

PROJECT:

35 Upper Lake Avenue Stoney Creek Ontario

TITLE:

East View

SCALE:	DRAWING NO.
DESIGNED BY:	00.04
APPROVED BY:	52.01





West View

Scale 1:75


PROJECT:

35 Upper Lake Avenue Stoney Creek Ontario

TITLE:

West View

SCALE:	DRAWING NO.
DESIGNED BY:	
APPROVED BY:	S2.02

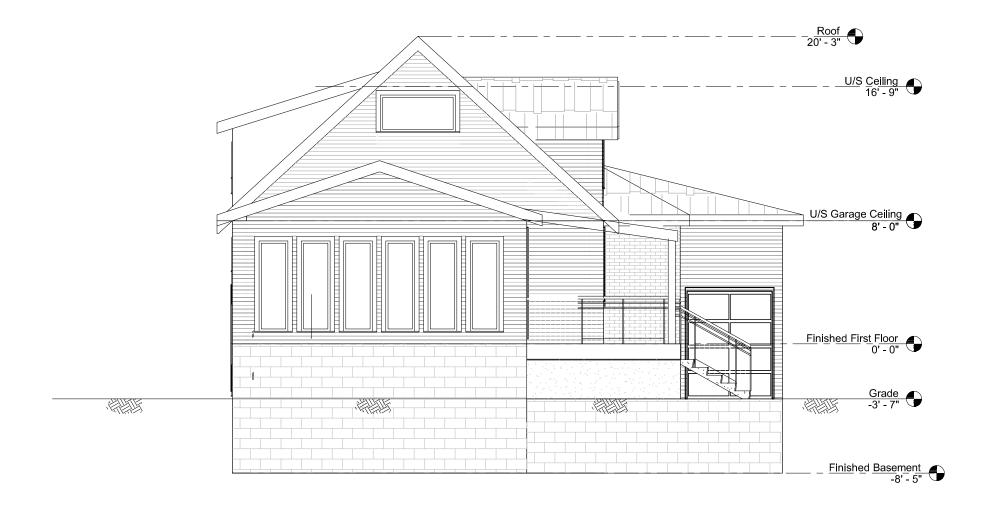

North View

Scale 1:75




PROJECT:

35 Upper Lake Avenue Stoney Creek Ontario

TITLE:

North View

SCALE:	DRAWING
	NO.
DESIGNED	
BY:	0000
APPROVED	─ S2.03
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ID1.	1

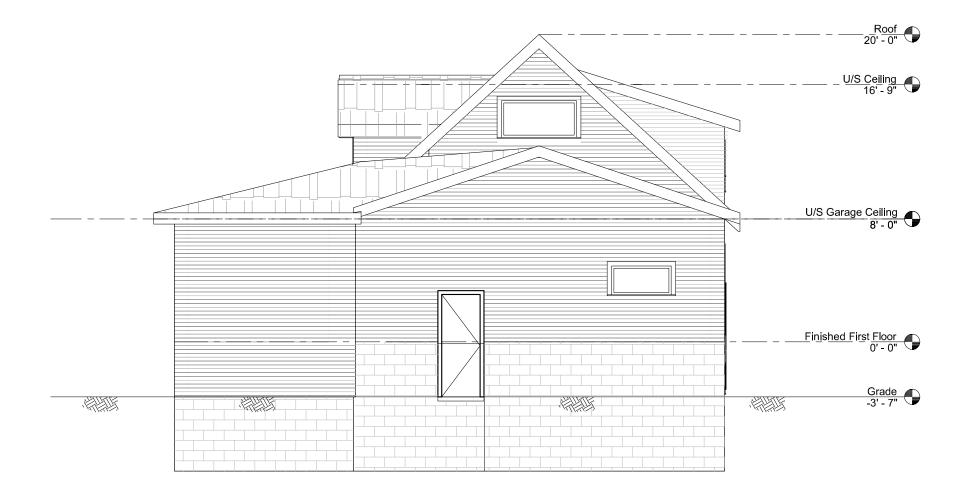

South View

Scale 1:75




PROJECT:

35 Upper Lake Avenue Stoney Creek Ontario

TITLE:

South View

DRAWING
NO.
⊣""
⊢ S2.04
J 32.04

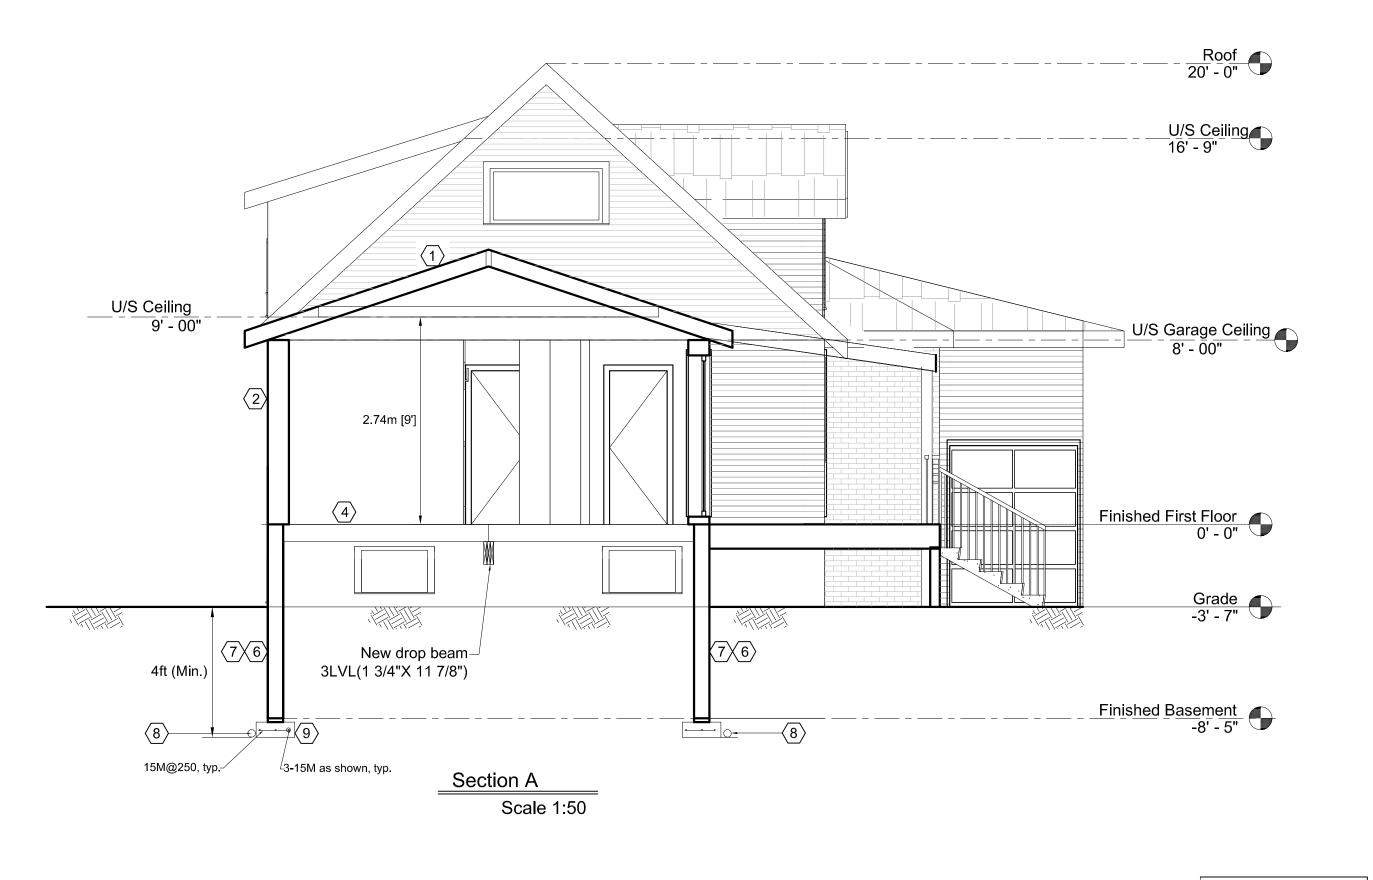




PROJECT: 35 Upper Lake Avenue Stoney Creek Ontario

TITLE: Section A

SauzTeq Engineering Inc. www.Sauzteq.ca Tel: 905-330-2431

Email: info@sauzteq.ca

SCALE:	DRAWING NO.
DESIGNED BY:	S2.05
APPROVED BY:	7 32.03

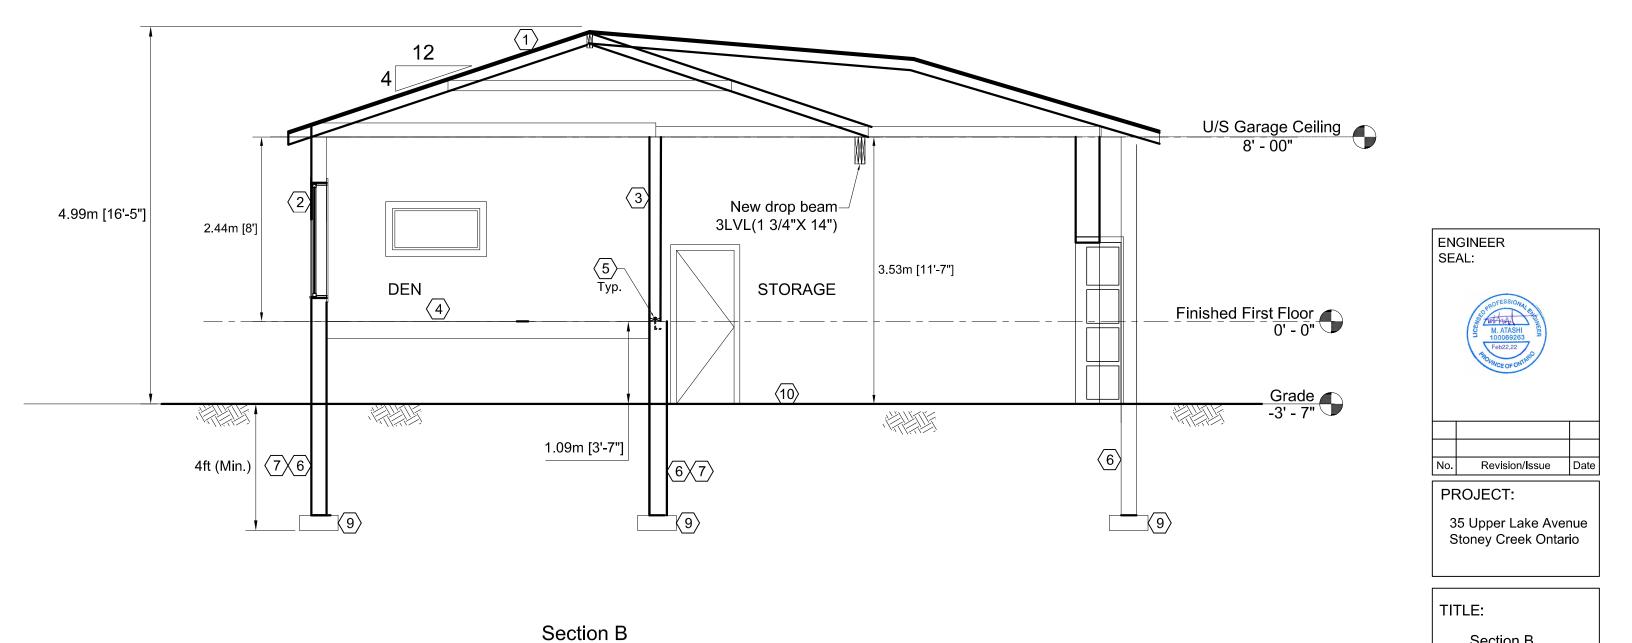

Scale 1:50

Section B

DRAWING NO.

S2.06

SCALE:

DESIGNED BY: APPROVED

	DOOR SCHEDULE
D1	NEW EXTERIOR 32"(W)X80"(H), WITH SELF CLOSING DEVICE & AIR TIGHT/GAS PROOF
D2	NEW PATIO DOOR 72"(W)X80"(H)
D3	NEW EXTERIOR 32"(W)X80"(H)
D4	NEW GARAGE DOOR 144"(W)X84"(H)
D5	NEW INTERIOR 28"(W)X80"(H)
D6	NEW INTERIOR 30"(W)X80"(H)

	LINTEL SCHEDULE
L1	3(2"X10") W/ 3(2"X6") POST EACH SIDE
L2	2(2"X8") W/ 3(2"X6") POST EACH SIDE
L3	3(2"X8") W/ 3(2"X6") POST EACH SIDE
L4	3LVL(1 3/4"X9 1/2") W/ 4(2"X6") POST EACH SIDE
L5	2(2"X8") W/ 3(2"X4") POST EACH SIDE & STEEL ANGLE L 3.5"X3.5"X0.25" W/ 6INCH BEARING EACH SIDE,
L6	2(2"X8") W/ 3(2"X4") POST EACH SIDE

	WINDOW SCHEDULE
W1	NEW 48"(W)X24"(H)
W2	NEW 48"(W)X60"(H)
W3	NEW 24"(W)X72"(H)
W4	NEW 40"(W)X50"(H)
W5	NEW 60"(W)X36"(H)

LEGENDS:



SMOKE ALARM



CARBONMONOXIDE DETECTOR

CONSTRUCTION NOTES:

ROOF CONSTRUCTION WITH ATTIC SPACE

210 (9.5KG/M²) ASPHALT SHINGLES, 5/8" (16) PLYWOOD SHEATHING WITH "H" CLIPS ON RAFTERS, 3' (915) STRIP, AS PER O.B.C. 9.26.5.2 EAVE PROTECTION, METAL EAVE TROUGH ON ALUM. FASCIA AND VENTED SOFFIT. ATTIC VENTILATION 1:300 OF INSULATED CEILING AREA WITH 50% AT EAVES. WITH R60 INSULATION.

SIDE WALL CONSTRUCTION W/CONTINUOUSE INSULATION

VINYL SIDING ATTACHED TO FURRING MEMBERS ON APPROVED AIR/WATER BARRIER AS PER O.B.C. 9.27.3. ON EXTERIOR TYPE 1" THICK RIGID INSULATION (JOINTS UNTAPED) MECHANICAL FASTENED AS PER MANUFACTURERS SPECIFICATIONS ON 3/8"(9.5) EXT. GRADE SHEATHING ON 2"X6"(38X140) STUDS@16"(406) O.C., R19 INSULATION BETWEEN STUDS, APPROVED 6 MIL. POLYETHYLENE AIR/VAPOUR BARRIER ON 1/2"(12.7). (GYPSUM WALL BOARD INTERIOR FINISH (GYPSUM SHEATHING, RIGID INSULATION AND FIBERBOARD SHALL NOT BE USED FOR THE ATTACHMENT OF SIDING (9.23.16.3.(1))

5 FUME-PROOF INSULATED INTERIOR WALL IN GARAGE

1/2"(12.7) THICK G.W.B. ON HOUSE INTERIOR SIDE OF 6 MIL. POLY. AIR/VAPOUR BARRIER ON 2"X6"@16" (38X140 @406) O.C. 2 TOP PLATES & 1 BOTTOM PLATE, C/W. R-24 BATT INSULATION BETWEEN ON 2 LAYERS G.W.B. WITH STAGGERED JOINTS COVERED WITH F.P. TAPE AND COMPOUND FINISHED WITH PAINT AS SELECTED BY OWNER.

(4) EXPOSED FLOOR

FINISHED FLOOR ON 5/8"(16) T & G SUB FLOOR ON JOISTS AS SHOWN WITH R31 SPRAY FOAM INSULATION BETWEEN JOISTS AND 5/8" THICK CEMENT BOARD UNDERNEATH.

SILL PLATE

2"x6" (38X140) SILL PLATE FASTENED TO FOUNDATION WALL WITH 1/2"(12.7) DIA. ANCHOR BOLTS SPACED 4'(1219) OCS. X 6"(150) LONG. ANCHOR BOLTS WITH NUTS AND WASHERS TO BE EMBEDDED NOT LESS THAN 4"(100) IN THE FOUNDATION. GROUT WITH 16.7MPA GROUT. SILL PLATE TO BE LEVELED ON A FULL BED OF MORTAR OR IF TOP OF FOUNDATION IS PERFECTLY LEVELED.AN APPROVED SILL PLATE GASKET OR LAYER OF MINERAL WOOL AT LAST 1"(25) THICK TO BE PROVIDED. ALL AS PER OBC.9.23.6.

6 FOUNDATION WALL

8"(203) THICK CONCRETE BLOCK FOUNDATION WALL, COMPRESSION STRENGTH OF BLOCK 20MPa WITH TYPE "S" MORTAR AT JOINTS. WITH 2 COATS BITUMINOUS DAMP PROOFING & DRAINAGE LAYER FROM GRADE TO FOOTING ON.

7 DAMP PROOFING MATERIAL: CONFORM TO 9.13.2.2(1)

(8) DRAIN TILE OR PIPE

DRAIN TILE AND PIPE TO BE 4"(100) MIN. DIA. AND INSTALLED ON UNDISTURBED SOIL AND CONNECT TO EXISTING DRAIN TILE. THE TOP AND SIDES OF DRAIN PIPE OR TILE TO BE COVERED WITH NOT LESS THAN 150MM OF CRUSHED STONE OR OTHER COARSE CLEAN GRANULAR MATERIAL. ALL AS PER OBC 9.14.3. SHALL NOT ACCUMULATE NEAR THE BUILDING OR AFFECT SURFACE DRAINAGE OF ADJACENT PROPERTIES.

CONCRETE FOOTING

NEW CONCRETE FOOTING 20"X8" WITH REBARS AS SHOWN AT SAME LEVEL OF EXISTING FOOTINGS WITH COMPRESSION STRENGTH OF CONCRETE 30MPa TO SIT ON UNDISTURBED SOIL. (MINIMUM FOOTING DEPTH 4FT BELOW GRADE).

GARAGE SLAB

4" (102) MIN. 25MPa (3600psi) CONCRETE SLAB C/W 6X6 6/6 W.W.M. IN CENTER OF SLAB ON 4" (102) COARSE GRANULAR FILL WITH COMPACTED SUB-BASE OR COMPACTED NATIVE FILL. SLOPE TO FRONT @ 1% MIN..

11) INTERIOR PARTITION

(NON LOAD BEARING), 1/2"(12.7) THICK G.W.B. EACH SIDE OF 2"X4" (38X89) WOOD STUDS @16"(406) O.C. FINISHED WITH PAINT AS SELECTED BY OWNER.

GENERAL NOTES:

1-ALL INFORMATION IS SHOWN AS EXISTING SHALL BE CHECKED AND VERIFIED BY THE CONTRACTOR PRIOR TO COMMENCEMENT OF ANY WORK. IF ANY DISCREPANCIES FOUND IN DRAWINGS, INFORM THE ENGINEER BEFORE PROCEEDING THE WORK

2-CONTRACTOR TO CAREFULLY EXAMINE ALL EXISTING SITE CONDITIONS AND BUILDING COMPONENTS, SO THAT A CLEAR AND COMPREHENSIVE UNDERSTANDING OF THE SCOPE OF WORK IS ACHIEVED.

3-VERIFY DIRECTION OF EXISTING JOISTS AS SHOWN ON DRAWINGS. REPORT TO ENGINEER IF FOUND DISCREPANCIES BEFORE START OF CONSTRUCTION.

4-WHERE EXISTING CONSTRUCTION TO REMAIN IS DAMAGED BY CONTRACTOR'S DEMOLITION WORK, THE CONSTRUCTION MUST BE REPAIRED TO MATCH EXISTING.

5-THE EXISTING UTILITIES SHOULD BE PROTECTED AND RELOCATED IF REQUIRED.

6-IT IS THE CONTRACTOR'S RESPONSIBILITY WHEN DEMOLISHING THE EXISTING WALLS AND CEILINGS TO ENSURE THAT ELECTRICAL SERVICES WITHIN WALLS AND CEILING ARE NOT LIVE.

7-AT LOCATIONS WHERE EXISTING WALLS, PIPING, DUCTWORK, AND MILLWORK ARE TO BE REMOVED, CONTRACTOR SHALL REPAIR AND MAKE GOOD AFFECTED SURFACES TO MATCH EXISTING.

8-MATERIAL. ALL STEEL SECTIONS TO MEET CSA G40.20/G40.21, W SECTION GRADE 350W. STEEL PLATES AND ANGLES GRADE 300W, STEEL HOLLOW SECTIONS GRADE 350W. COMPRESSION STRENGTH OF CONCRETE 30MPA (MINIMUM).

9-MATERIAL FOR LUMBERS IS S-P-F, SELECT STRUCTURAL. LUMBERS EXPOSED TO EXTERIOR WEATHER TO BE PRESSURE TREATED.


10-MATERIAL FOR LVL BEAMS IS 2.0E (FROM WEST FRASER TIMBER), LVL SCREWS FROM FLATLOK

11- USE SIMPSON HANGERS TO ATTACH JOISTS TO NEW BEAMS. FOR NUMBER AND TYPE OF FASTENERS REFER TO SUPPLIER INSTRUCTION.

12-WELDING TO COMPLY WITH CSA W59 AND BE CARRIED OUT BY CERTIFIED WELDERS. WELDING ELECTRODES TO BE E480XX. BEFORE START OF WELDING, MAKE ALL WELDING SURFACES CLEAN FROM RUST.

13-DO SITE MEASUREMENTS FOR EXACT SIZES OF NEW BEAMS AND POST.

14-PROVIDE TEMPORARY SUPPORT FOR EXTERIOR WALLS BEFORE MAKING NEW OPENINGS.

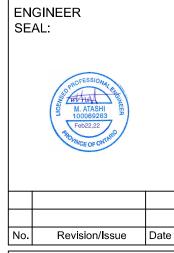

PROJECT:

35 Upper Lake Avenue Stoney Creek Ontario

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Schedules, Notes

SCALE:	DRAWING NO.
DESIGNED BY:	OF 01
APPROVED BY:	─ S5.01



Committee of Adjustment

City Hall, 5th Floor, 71 Main St. W., Hamilton, ON L8P4Y5

Phone: (905) 546-2424 ext. 4221

Email: cofa@hamilton.ca

APPLICATION FOR A MINOR VARIANCE

FOR OFFICE USE O	NLT.			
APPLICATION NO	DATE APPLICATION RECEIVED			
PAID	DATE APPLICATION DEEMED COMPLETE			
SECRETARY'S SIGNATURE				
	The	Planning Act		
	Application for Mino	or Variance or for Permiss	sion	
The undersigned here Section 45 of the <i>Plan</i> application, from the Z	<i>nning Act</i> , R.S.O. 1990, Ch	ee of Adjustment for the Cit apter P.13 for relief, as des	ty of Hamilton under scribed in this	
1, 2	NAME	MAILING ADDRESS		
Registered Owners(s)	William James Houston Sharen Lynn Houston			
Applicant(s)*	As Above			
Agent or Solicitor	3ean Lachapele			
Note: Unless any.	otherwise requested all	communications will be s	ent to the agent, if	
3. Names and add	dresses of any mortgagee	s, holders of charges or oth	er encumbrances:	
	Dank of Ca. 17 Gweensto L8G-1			
	L8G-1	B8		

Additional sheets can be submitted if there is not sufficient room to answer the following questions. Additional sheets must be clearly labelled

Nature and extent of relief applied for:
☐ Second Dwelling Unit ☐ Reconstruction of Existing Dwelling
Why it is not possible to comply with the provisions of the By-law?
FROHT SET BACK FOR REQUIRED PARKING SPACES
Legal description and Address of subject lands (registered plan number and lot number or other legal description and where applicable, street and street number):
35 UPPERLAKE AVE STOLLET CLEEK
PREVIOUS USE OF PROPERTY
Residential Industrial Commercial
Agricultural Vacant
Other
If Industrial or Commercial, specify use
Has the grading of the subject land been changed by adding earth or other material, i.e. has filling occurred?
Yes ☐ No ☑ Unknown ☐
Has a gas station been located on the subject land or adjacent lands at any time? Yes □ No ☑ Unknown □
Has there been petroleum or other fuel stored on the subject land or adjacent lands? Yes \(\subseteq \) \(\
Are there or have there ever been underground storage tanks or buried waste on the subject land or adjacent lands?
Yes ☐ No ☒ Unknown ☐
Have the lands or adjacent lands ever been used as an agricultural operation where cyanide products may have been used as pesticides and/or sewage sludge was applied to the lands?
Yes No 🗹 Unknown
Have the lands or adjacent lands ever been used as a weapon firing range? Yes ☐ No ☑ Unknown ☐
Is the nearest boundary line of the application within 500 metres (1,640 feet) of the fill area of an operational/non-operational landfill or dump? Yes No Unknown
If there are existing or previously existing buildings, are there any building materials remaining on site which are potentially hazardous to public health (eg. asbestos, PCB's)?
Yes No V Unknown

8.10	Is there any reason to believe the subject land may have been contaminated by former uses on the site or adjacent sites? Yes No Unknown
8.11	What information did you use to determine the answers to 8.1 to 8.10 above? House was built in 1952, prior to that this area was farm land
	FRIS area was tarm land
8.12	If previous use of property is industrial or commercial or if YES to any of 8.2 to 8.10, a previous use inventory showing all former uses of the subject land, or if appropriate, the land adjacent to the subject land, is needed.
	Is the previous use inventory attached? Yes \[\] No \[\]
9.	ACKNOWLEDGEMENT CLAUSE I acknowledge that the City of Hamilton is not responsible for the identification and remediation of contamination on the property which is the subject of this Application – by reason of its approval to this Application.
	Date Signature Property Owner(s) Print Name of Owner(s)
10.	Dimensions of lands affected: Frontage 34,06 m Depth 58,34 m Area 1987.06 m² Width of street
11.	Particulars of all buildings and structures on or proposed for the subject lands: (Specify ground floor area, gross floor area, number of stories, width, length, height, etc.) Existing:
	STORET & HALF 78.77 M2
	Proposed
	TWO SIDE ADDITIONS, ONE STOREY
	81.39 m² TOTAL OF 160.16 m²
12.	Location of all buildings and structures on or proposed for the subject lands; (Specify distance from side, rear and front lot lines) Existing:
	8.91 M FROLL LOT LIHES @ PIDES 6.02 M FROM FROMT 32.50 M FROM REAR
	Proposed: 8.91 m Flor RIGHT 1.03 FROM LEFT 6.02 m ERON FRONT 32.50 m FROM RPONT

13.	Date of acquisition of subject lands:
14.	Date of construction of all buildings and structures on subject lands:
15.	Existing uses of the subject property (single family, duplex, retail, factory etc.):
16.	Existing uses of abutting properties (single family, duplex, retail, factory etc.):
17.	Length of time the existing uses of the subject property have continued:
18.	Municipal services available: (check the appropriate space or spaces)
	Water Connected
	Sanitary Sewer Connected
	Storm Sewers
19.	Present Official Plan/Secondary Plan provisions applying to the land:
	2518003480208 000 NEIGBOURHUUPS
	Z J 1300 J 130 ZO S CCC NCIBOURINOUS
20.	Present Restricted Area By-law (Zoning By-law) provisions applying to the land:
	R2 + OS
21.	Has the owner previously applied for relief in respect of the subject property? (Zoning Bylaw Amendment or Minor Variance) Yes No If yes, please provide the file number:
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	21.1 If a site-specific zoning by-law amendment has been received for the subject property, has the two-year anniversary of the by-law being passed expired? Yes No
	21.2 If the answer is no, the decision of Council, or Director of Planning and Chief Planner that the application for Minor Variance is allowed must be included. Failure to do so may result in an application not being "received" for processing.
22.	Is the subject property the subject of a current application for consent under Section 53 of the <i>Planning Act?</i>
	☐ Yes
23.	Additional Information (please include separate sheet if needed)
20.	Additional information (ploade include departure executive executi
24.	The applicant shall attach to each copy of this application a plan showing the dimensions of the subject lands and of all abutting lands and showing the location, size and type of all buildings and structures on the subject and abutting lands, and where required by the Committee of Adjustment such plan shall be signed by an Ontario Land Surveyor.