Hamilton

COMMITTEE OF ADJUSTMENT

City Hall, 5th floor, 71 Main Street West, Hamilton, ON L8P 4Y5
Telephone (905) 546-2424, ext. 4221, 3935

E-mail: cofa@hamilton.ca

NOTICE OF PUBLIC HEARING Minor Variance

You are receiving this notice because you are either:

- Assessed owner of a property located within 60 metres of the subject property
- Applicant/agent on file, or
- Person likely to be interested in this application

| APPLICATION | HM/A-22:264 | SUBJECT | 93 CLINE AVENUE N, |
|-------------|-----------------------------|------------|-------------------------------|
| NO.: | | PROPERTY: | HAMILTON |
| ZONE: | "C/S-1361" (Urban Protected | ZONING BY- | Zoning By-law former City of |
| | Residential Etc.) | LAW: | Hamilton 6593, as Amended 96- |
| | · | | 109 |

APPLICANTS: Owner – Leonard Kofman & S. O'Neill

Agent - Team Shane - L. Sayegh

The following variances are requested:

- 1. A maximum floor area ratio factor of 0.82 shall be permitted, permitting a maximum gross floor area of 250 square metres, instead of the permitted maximum floor area ratio factor of 0.45, allowing a maximum gross floor area of 137.96 square metres.
- 2. A maximum building height of three (3) storeys and a10.80 metres shall be permitted, instead of the requirement that no building or structure shall exceed 2 storeys and 9.0 metres in height.
- 3. A minimum front yard depth of 3.80 metres shall be permitted, instead of the minimum required front yard depth of 6.0 metres.
- 4. A minimum westerly side yard of 0.40 metres shall be permitted, instead of the minimum required side yard of 0.9 metres.
- 5. An uncovered porch which does not extend more than 1.0 metres above the first floor level, shall be permitted to project into the required front yard and distant 1.16 metres from the street line, instead of the requirement that an uncovered porch may project into a required yard if distant at least 1.5 metres from the street line.
- 6. One (1) parking space shall be provided, instead of the four (4) parking spaces required.
- 7. An eave/gutter may project 0.41 metres into the required westerly side yard and extend right to the westerly lot line, instead of the requirement that an eave/gutter may project into a required side yard not more than one-half of its width (i.e. 0.45 metres), or 1.0 metre, whichever is the lesser.

HM/A-22:264

PURPOSE & EFFECT: Proposal to construct a third-storey addition with a gross floor area of 60.50

square metres and the reconstruction of an uncovered porch in the front

yard of the existing single-family dwelling, notwithstanding that:

Notes:

1. It is unclear from the Elevation Drawings provided if the lower level of the principle dwelling shall be considered a "storey" as per the definition of "basement" provided in Hamilton Zoning By-law 6593. Therefore, the number of storeys being proposed could not be confirmed and variance No. 1 has been written as requested by the applicant. Note that as per By-law No. 96-109, no building shall exceed two (2) storeys, and 9.0 metres in height.

- 2. Please note that the subject lot is a lot of record, as defined in Hamilton Zoning By-law No. 6593. Therefore, as per Section 18(3)(v) the minimum required westerly side yard is 0.9 metres, as opposed to the 1.2 metre side yard indicated in the submitted application.
- 3. Please note that should Variance No. 4 be granted to allow for a minimum westerly side yard of 0.40 metes, as per Section 18(3)(vi)(b), an eave/gutter would be permitted to project 0.20 metres into the westerly side yard. Therefore, variance No. 7 has been included to allow for a projection of 0.41 metres for the eave/gutter as indicated on the submitted Site Plan. The applicant shall ensure that eaves and gutters do not encroach beyond the property line onto the adjacent private property. Otherwise, the applicant shall be required to enter into an encroachment agreement and establish the necessary maintenance easements, which must be properly registered on title with the abutting neighbour.
- 4. Please note that the percentage of the gross area of the front yard that is landscaping has not been indicated. As per Section 18(14)(i) and 18A(14a), not less than 50% of the gross area of the front yard shall be used for a landscaped area excluding concrete, asphalt, gravel, pavers, or other similar materials. Additional variances may be required if compliance with Section 18(14)(i) and 18A(14a), is not possible.
- 5. The proposed development is subject to the issuance of a building permit in the normal manner. Be advised that Ontario Building Code regulations may require specific setbacks and construction types.

This Notice must be posted by the owner of any land which contains seven or more residential units so that it is visible to all residents.

This application will be heard by the Committee as shown below:

| DATE: | Thursday, September 8, 2022 | |
|--------|---|--|
| TIME: | 2:30 p.m. | |
| PLACE: | Via video link or call in (see attached sheet for details) | |
| | 2 nd floor City Hall, room 222 (see attached sheet for | |
| | details), 71 Main St. W., Hamilton | |
| | To be streamed (viewing only) at | |
| | www.hamilton.ca/committeeofadjustment | |

HM/A-22:264

For more information on this matter, including access to drawings illustrating this request and other information submitted:

- Visit www.hamilton.ca/committeeofadjustment
- Visit Committee of Adjustment staff at 5th floor City Hall, 71 Main St. W., Hamilton
- Call 905-546-CITY (2489) or 905-546-2424 extension 4221, 4130, or 3935

PUBLIC INPUT

Written: If you would like to submit written comments to the Committee of Adjustment you may do so via email or hardcopy. Please see attached page for complete instructions, <u>including deadlines</u> for submitting to be seen by the Committee.

Orally: If you would like to speak to this item at the hearing you may do so via video link, calling in, or attending in person. Please see attached page for complete instructions, including deadlines for registering to participate virtually and instructions for check in to participate in person.



DATED: August 23, 2022

Jamila Sheffield, Secretary-Treasurer Committee of Adjustment Information respecting this application is being collected under the authority of the Planning Act, R.S.O., 1990, c. P. 13. All comments and opinions submitted to the City of Hamilton on this matter, including the name, address, and contact information of persons submitting comments and/or opinions, will become part of the public record and will be made available to the Applicant and the general public, and may include posting electronic versions.



COMMITTEE OF ADJUSTMENT

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Telephone (905) 546-2424, ext. 4221, 3935

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PARTICIPATION PROCEDURES

Written Submissions

Members of the public who would like to participate in a Committee of Adjustment meeting are able to provide comments in writing or via email in advance of the meeting. Comments can be submitted by emailing cofa@hamilton.ca or by mailing the Committee of Adjustment, City of Hamilton, 71 Main Street West, 5th Floor, Hamilton, Ontario, L8P 4Y5. Comments must be received by noon two days before the Hearing.

Comment packages are available two days prior to the Hearing and are available on our website: www.hamilton.ca/committeeofadjustment

Oral Submissions

Members of the public are also able to provide oral comments regarding Committee of Adjustment Hearing items by participating Virtually through Webex via computer or phone or by attending the Hearing In-person. Participation Virtually requires pre-registration in advance. Please contact staff for instructions if you wish to make a presentation containing visual materials.

1. Virtual Oral Submissions

Interested members of the public, agents, and owners <u>must register by noon the day</u> <u>before the hearing</u> to participate Virtually.

To register to participate Virtually by Webex either via computer or phone, please contact Committee of Adjustment staff by email cofa@hamilton.ca. The following information is required to register: Committee of Adjustment file number, hearing date, name and mailing address of each person wishing to speak, if participation will be by phone or video, and if applicable the phone number they will be using to call in.

A separate registration for each person wishing to speak is required. Upon registering for a meeting, members of the public will be emailed a link for the Webex meeting the Wednesday afternoon before the hearing. The link must not be shared with others as it is unique to the registrant.

2. In person Oral Submissions

Interested members of the public, agents, and owners who wish to participate in person must sign in at City Hall room 222 (2nd floor) no less than 10 minutes before the time of the Public Hearing as noted on the Notice of Public Hearing.

We hope this is of assistance and if you need clarification or have any questions, please email cofa@hamilton.ca or by phone at 905-546-2424 ext. 4221.

Please note: Webex (video) participation requires either a compatible computer or smartphone and an application (app/program) must be downloaded by the interested party in order to participate. It is the interested party's responsibility to ensure that their device is compatible and operating correctly prior to the Hearing.

RENOVATION TO: KOFMAN

93 Cline Avenue N Hamilton ON L8S 3Z5

Scope of work:

1. Proposing a third level addition to accommodate additional bedrooms, one ensuite bathroom and office space.

GENERAL NOTES

1. O.B.C. TO BE UNDERSTOOD AS ONTARIO BUILDING CODE 2012

2. ALL STAGES OF CONSTRUCTION SHALL CONFORM WITH O.B.C. 3. DO NOT SCALE DRAWINGS.

4. CONTRACTOR TO REVIEW AND VERIFY ALL DIMENSIONS PRIOR TO AND DURING CONSTRUCTION. ALL DISCREPANCIES TO BE REPORTED TO DESIGNER.

6. SEE ELEVATIONS AND FLOOR PLANS FOR WALL AND CEILING HEIGHTS. ANY DISCREPANCIES TO BE REPORTED TO DESIGNER. 7. WOOD IN CONTACT WITH CONCRETE OR MASONRY TO BE

8. SMOKE AND CO.DETECTORS TO BE LOCATED AT EACH LEVEL SMOKE ALARMS LOCATED IN EACH BEDROOM AND ARE TO BE INTERCONNECTED AS PER 9.10.19, 9.33.4.

SEPARATED WITH MINIMUM 2 MIL. POLY UNLESS OTHER WISE

9. ALL LIGHTING AND ELECTRICAL AS PER O.B.C. 9.34.

10. ATTIC ACCESS TO BE INSULATED MIN. R20 AND WEATHER BE REINFORCED AS PER O.B.C. 9.30.6.3.

TIMES WITH-IN THE JOB SITE TILL ALL WORK IS COMPLETED. 12. PROVIDE MIN. 6'-5" HEADROOM BELOW ALL BEAMS & DUCTWORK. 13. STUD WALL REINFORCEMENT SHALL BE INSTALLED IN "MAIN BATHROOMS" WITHIN A DWELLING UNIT ACCORDING TO OBC

14.BLOCKING IN WALLS - WHERE INDICATED, BLOCKING IS TO BE INSTALLED BETWEEN OR AGAINST STUDS IN THE WALLS ADJACENT TO THE TOILET, SHOWER AND/OR BATHTUB TO SUPPORT INSTALLATION OF GRAB BARS IN ACCORDANCE WITH

15.BLOCKING LOCATION IN WALLS TO BE IN ACCORDANCE WITH GRAB BAR REQUIREMENTS OF OBC 3.8. **MECHANICAL**

1. ALL EXHAUST FANS TO BE VENTED TO EXTERIOR. EXHAUST FAN RANGE HOODS TO BE VENTED TO EXTERIOR WITH NON-

2. DRYER VENTING AS PER OBC 9.32.1.4.

3. HVAC DRAWINGS TO BE DESGINED BY OTHERS AS PER OBC DRAWINGS TO BE PROVIDED TO TBOUMA DESIGN AND DRAFTING PRIOR TO FINALIZED WORKING DRAWINGS. DRAWINGS NOT FOR APPROVAL JUST TO BE PROPERLY INCORPORATED INTO PLANS

5. UNLESS EXEMPT BY ENERGY AUDIT, EACH DWELLING MUST HAE A DRAIN WATER HEAT RECOVERY AS PER ENERGY EFFICIENCY PACKAGE SELECTED. ENSURE A MIN. OF (2) SHOWER DRAIN INTO

4. HRV / ERV TO BE BALANCED POST CONSTRUCTION

6. EVERY STOREY WHERE PLUMBING IS OR MAY BE INSTALLED INCLUDING THE BASEMENT OF HOUSE EXTEND VENTING FOR FUTURE CONNECTIONS PROVIDE A VENT PIPE AT LEAST 1 1/2" IN SIZE AS PER OBC 7.5.5.5.(2)

BACKWATER VALVE REQUIRED TO BE INSTALLED ON THE SANITAR' BUILDING DRAIN AS PER OBC 7.4.6.4. (MAINLINE 'ADAPT-A-VALVE

8. PROVIDE SUMP PIT AND SEALED COVER FOR DRAINAGE AS PER

1. REGISTRATION NAME OF REGISTRATION FIRM TBOUMA DESIGN INC. REGISTRATION NUMBER ASSIGNED BY DIRECTOR 104857

2. CONTRACTOR IS TO OBTAIN QUALIFIED DESIGNERS FOR ALL DESIGNED BY OTHERS ON DRAWINGS

3. DESIGNER ASSUMES NO RESPONSIBILITY FOR FAILURE OF THE CONTRACTOR OR SUB-CONTRACTOR TO CARRY OUT THE WORK IN ACCORDANCE WITH THESE DRAWINGS

5. ALL WALL & CEILINGS BETWEEN DWELLING UNIT AND GARAGE ARE
TO BE GAS PROOFED AND INSULATED TO ENERGY EFFICIENCY
SUMMARY

5. ALL EXTERIOR DOORS AND WINDOWS TO COME AND INSULATED TO ENERGY EFFICIENCY
OF ALL PAGES OF THESE DRAWINGS NOT TO BE READ INDEPENDENTLY
OF ALL PAGES OF THE WHOLE DRAWING SET. OF ALL PAGES OF THE WHOLE DRAWING SET. 5. CONTRACTOR SHALL CHECK AND VERIFY ALL DIMENSIONS ON THE WORKING DRAWING SET. ANY DISCREPANCIES ARE TO BE REPORTED

TO THE DESIGNER PRIOR TO COMMENCEMENT OF WORK. 6. ANY MODIFICATIONS TO THE DESIGN SHALL NOT BE MADE WITHOUT DOCUMENTATION SHALL BE THE ONLY FORM OF ACCEPTANCE.

7. WHEN DRAWINGS ARE TO BE MODIFIED OR CHANGES ARE TO BE MADE 9. EGRESS WINDOWS / WELLS SHALL BE AS PER OBC 9.9.10.1 THE BUILDING DEPARTMENT WILL BE NOTIFIED FOR PURPOSE OF REVIEW PRIOR TO CONSTRUCTION. 8. UNDER NO CIRCUMSTANCE SHALL THE CONTRACTOR OR SUB-

CONTRACTOR PROCEED IF THERE IS ANY UNCERTAINTY. DESIGNER SHALL BE CONTACTED. 11. WHERE CERAMIC FLOORING IS INSTALLED THE SUB-FLOOR SHALL 9. THE DRAWINGS THAT ARE APPROVED AND STAMPED BY THE BUILDING DEPARTMENT ARE TO BE THE ONLY TRUE DRAWINGS AND ARE TO BE ACCESSIBLE TO ALL CONTRACTORS AND SUB-CONTRACTORS AT ALL

1. ALL STAIR COMPONENTS TO CONFORM TO O.B.C. STANDARDS. 2. MAX. NOSING = 1" UNIFORM RUN / RISE

- 4" MAXIMUM OPENINGS - NON-CLIMBABLE

EXTERIOR GUARDS:
- 2'-0" TO 5'-11" ABOVE FINISHED GRADE MIN. HEIGHT = 36"
OVER 5'-11" ABOVE GRADE MIN. HEIGHT = 42"

ALL GUARDS TO BE CONSTRUCTED TO O.B.C. STANDARDS

- MAX HEIGHT = 38"

FLOOR AREA CALCULATION

DOORS AND WINDOWS

1. ALL EXTERIOR DOORS TO BE METAL INSULATED OR WOOD WITH STORM

2. DOOR BETWEEN GARAGE AND DWELLING TO BE WEATHER STRIPPED AND GAS TIGHT EXTERIOR TYPE DOOR WITH SELF CLOSING DEVICE. 3. DOOR AT COLD STORAGE TO BE EXTERIOR TYPE DOOR.

4. ALL WINDOWS AND DOORS AS PER ENERGY EFFICIENCY DESIGN SUMMARY OR ATTACHED BOP BY OTHERS. 5. ALL EXTERIOR DOORS AND WINDOWS TO COMPLY WITH FORCED ENTRY

WITH A MINIMUM UNOBSTRUCTED OPEN AREA OF 3.8 SQ, FT, WITH NO

7. MAIN ENTRANCE DOORS TO HAVE DOOR VIEWER UNLESS TRANSPARENT GLAZING IS PROVIDED IN DOOR OR A SIDELIGHT. 8. UNDERCUT ALL DOORS TO ROOMS WITHOUT RETURN AIR INLET.

1. ALL LUMBER TO COMPLY WITH O.B.C SPECIFICATIONS AND STANDARDS. 2. ALL STRUCTURAL LUMBER TO BE OF SPRUCE #2 OR BETTER.

3. ALL PRE-ENGINEERED FLOOR AND ROOF TRUSS DESIGN AND LAYOUT TO BE DESIGNED BY OTHERS AND CONFORM TO O.B.C SPECIFICATIONS ALL DRAWINGS TO BE PROVIDED TO TBOUMA DESIGN AND DRAFTING, NOT FOR APPROVAL JUST TO BE PROPERLY INCORPORATED INTO PLANS AND ON

4. AS NOTED ON DRAWINGS STUDS TO BE USED AS BEARING POINTS WHERE IT 5. ALL BEAMS TO HAVE MINIMUM 3 1/2" BEARING AT BOTH ENDS BEARING TO BE

6. DOUBLE JOISTS AROUND STAIRWELL UNLESS OTHER WIDE NOTED BY PRE-

7. TRUSS FABRICATORS ENGINEER CERTIFIED DRAWINGS REQUIRED FOR APPROVAL BY BUILDING DEPARTMENT

8. SOLID BLOCKING TO BEARING BELOW TO BE PROVIDED AT ALL GIRDER TRUSS AND BEAM LOCATIONS (IN. WIDTH EQUAL TO WIDTH OF BEARING POINT OVER) VERIFY WITH TRUSS DRAWINGS **FOUNDATION**

1. CONTRACTOR TO VERIFY SOIL CONDITIONS PRIOR TO PLACING OF FOOTINGS. ANY ABNORMALITIES TO BE REPORTED TO DESIGNER

2. STEP FOOTINGS TO BE DESIGNED AS PER O.B.C. 9.15.3.9. - MAX RISE SHALL NOT EXCEED 23 5/8" - MIN RUN SHALL NOT BE LESS THAN 23 5/8"

3. ALL FOOTINGS TO BEAR ON FIRM UNDISTURBED SOIL MIN. 4'-0" BELOW INISHED GRADE AND MIN. BEARING CAPACITY OF 75 KPa 4. WALL HEIGHTS AND THICKNESS TO CONFORM TO O.B.C. 9.15.4.

MASONRY

1. ALL FLASHING TO CONFORM TO O.B.C. 9.20.13.

2. ALL BRICK OR STONE SILLS TO BE FLASHED IN ACCORDANCE WITH THE 3. ALL STEEL LINTELS FOR MASONRY TO HAVE MINIMUM 6" BEARING EACH END

4. WHERE NEW POINT LOAD(S) FROM ABOVE BEAR ON EXISTING BLOCK WALLS. FILL TOP COARSE SOLID MIN. 7 1/2" DEEP AS PER 9.15.5.2.

ENERGY EFFICIENCY COMPLIANCE DESIGN

SB-12, TABLE 3.1.1.21. (IP) (ZONE 1) THERMAL PERFORMANCE REQUIREMENTS FOR ADDITIONS TO EXISTING

FOR HEATING OTHER THAN ELECTRIC SPACE HEATING CEILING WITH ATTIC SPACE:. EILING WITHOUT ATTIC SPACE: EXPOSED FLOOR: WALLS ABOVE GRADE:.. R20ci or R12 + R10ci BELOW GRADE SLAB:....EDGE OF BELOW GRADE SLAB: HEATED SLAB:... ..MAX U-VALUE 1.6 VINDOWS AND SLIDING GLASS DOORS:...

ENERGY RATING 25 MAX U-VALUE 2.8 MIN. AFUE 96% MIN. EFF. 80%

AREA CALCULATIONS: CONFORMING TO OBC 3.1.1.(7). TOTAL PROPOSED GROSS AREA OF WALLS:

TOTAL PROPOSED GLAZING: RATIO(%):

SPACE HEATING EQUIPMENT:

DOMESTIC HOT WATER HEATER: ..

1. WHERE A MINIMUM R VALUE. MAXIMUM U VALUE. OR MINIMUM EFFECTIVE R VALUE ARE SPECIFIED FOR A COMPONENT, THE COMPONENT ONLY NEEDS O CONFIRM TO ONE OF THE REQUIREMENTS

WHERE A DWELLING UNIT HAS A WALKOUT BASEMENT, THE THERMAL PERFORMANCE OF THE EXTERIOR BASEMENT WALL SHALL BE NOT LESS THAT THAT REQUIRED FOR THE ABOVE GRADE WALL FOR: a) THE BASEMENT WALL CONTAINING THE DOOR OPENING AND b) ANY BASEMENT WALL THAT HAS AN EXPOSED WALL ABOVE THE GROUND

LEVEL EXCEEDING 50% OF THAT BASEMENT WALL AREA.


FOR HOMES OLDER THAN 5 YEARS

ci MEANS CONTINUOUS INSULATION

. THE ENERGY EFFICIENCY OF EXISTING BUILDINGS SHALL COMPLY WITH PART 11 OF DIVISION B OF THE BUILDING CODE FOR RENOVATION. SB-12,

CONSTRUCTION MAY BE CARRIED OUT TO MAINTAIN THE EXISTING PERFORMANCE LEVEL OF ALL OR PART OF AN EXISTING BUILDING, BY THE REUSE, RELOCATION OR EXTENSION OF THE SAME OR SIMILAR MATERIALS OR COMPONENTS, TO RETAIN THE EXISTING CHARACTER, STRUCTURAL UNIQUENESS, HERITAGE VALUE, OR AESTHETIC APPEARANCE OF ALL OR PART OF THE BUILDING, IF THE CONSTRUCTION WILL NOT ADVERSELY AFFECT THE EARLY WARNING AND EVACUATION SYSTEMS, FIRE SEPARATIONS OR THE STRUCTURAL ADEQUACY OR WILL NOT CREATE AN UNHEALTHY ENVIRONMENT IN THE BUILDING. AS PER 11.3.3.1. BASIC RENOVATION (SEE APPENDIX A)

WHERE THE FRAMING SYSTEMS ARE BEING ALTERED TO MATCH EXISTING FRAMING, LESSER AMOUNTS AND EXTENT OF INSULATION AND VAPOR BARRIER IS ACCEPTABLE. PART 11 COMPLIANCE ALTERNATIVE, TABLE 1.5.1.1.C. (CONT'D), C199 - 12.2.1.1. (3)

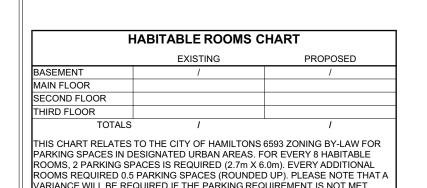













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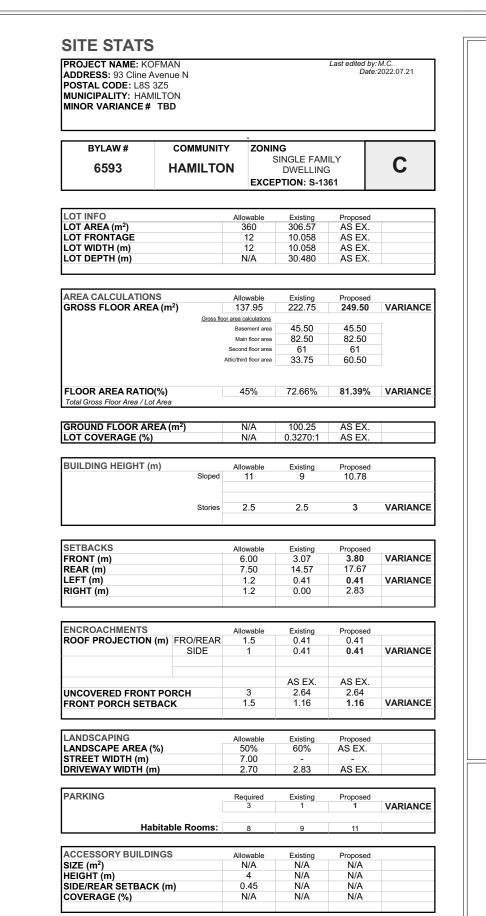
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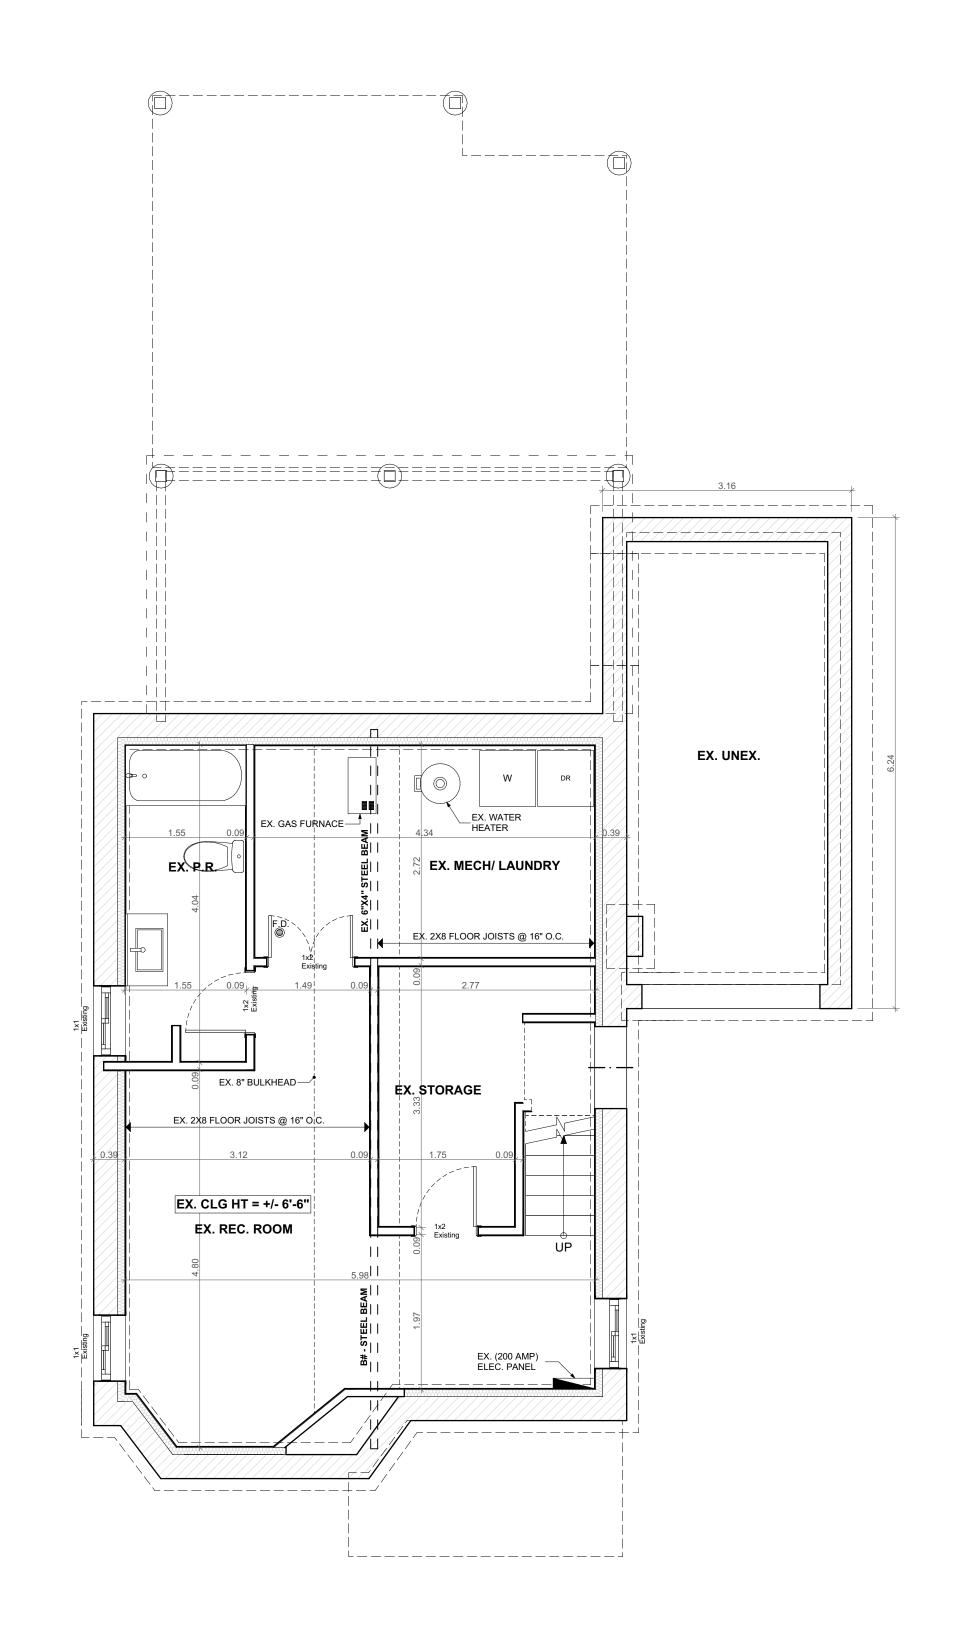
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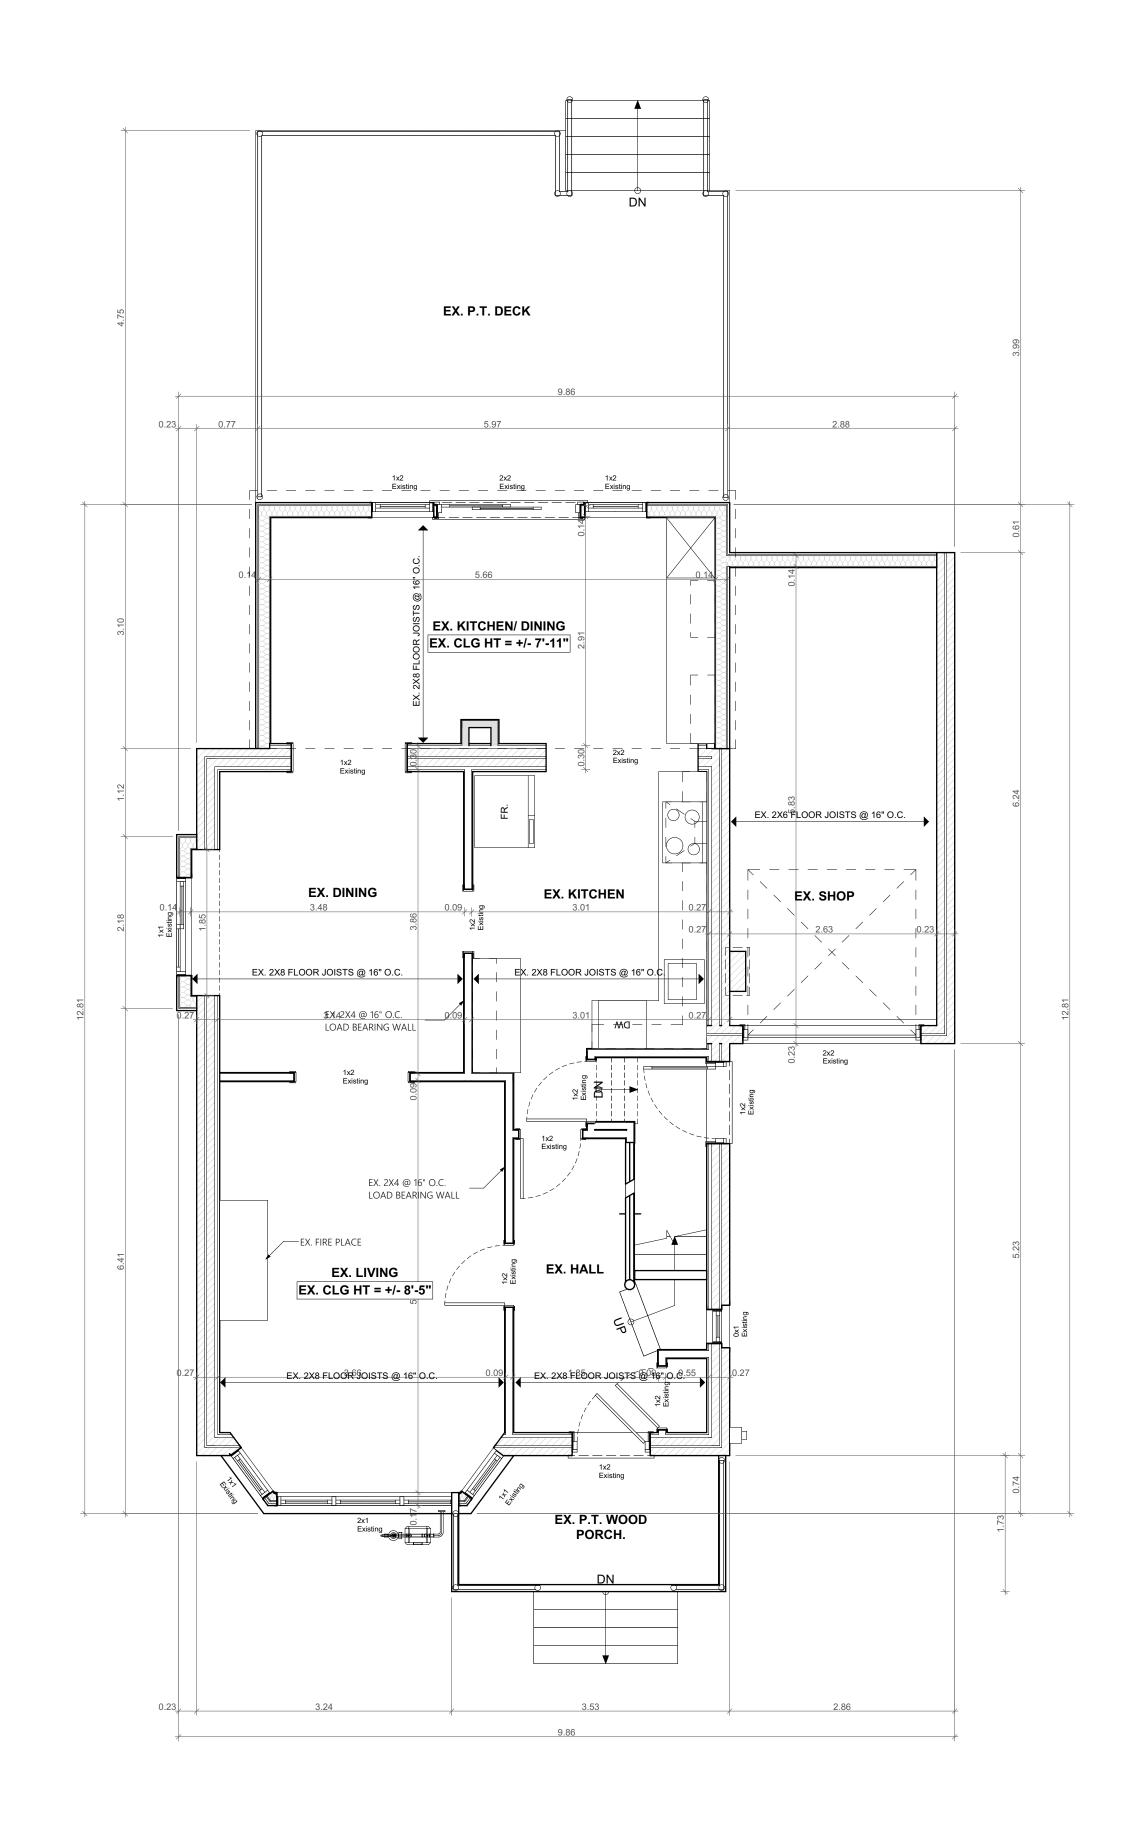
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PROJECT: **KOFMAN**

PROJECT ADDRESS: 93 Cline Avenue N Hamilton ON L8S 3Z5

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CONSTRUCTION

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93 Cline Avenue N Hamilton ON L8S 3Z5
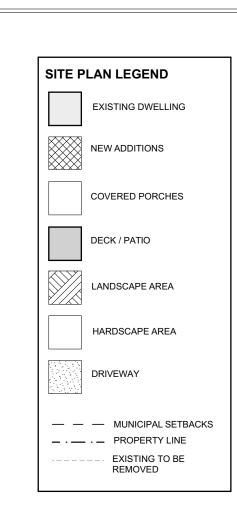
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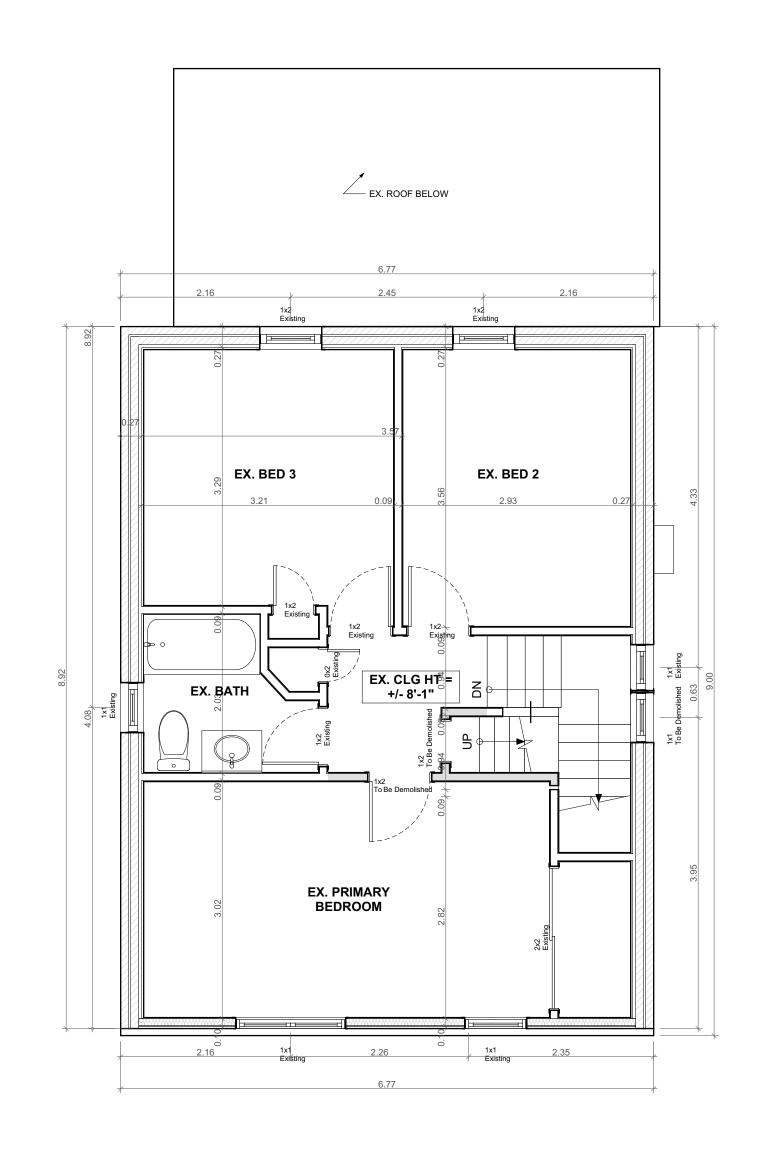
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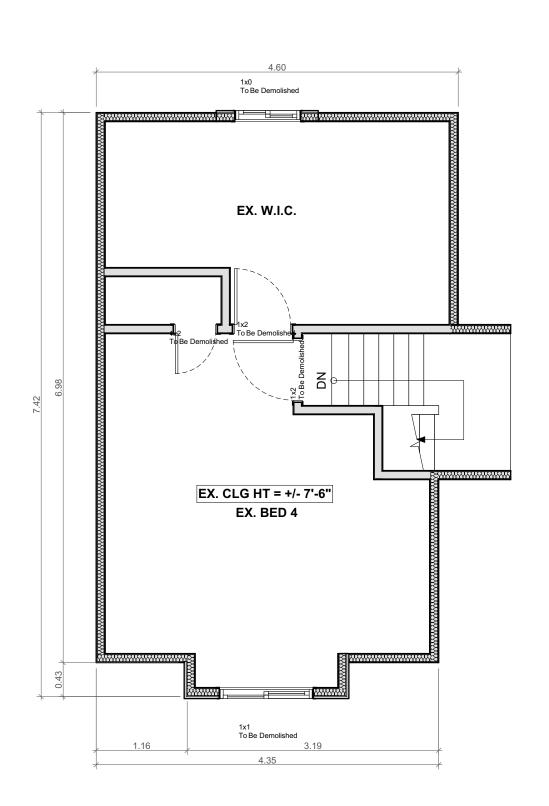
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PROJECT: **KOFMAN**

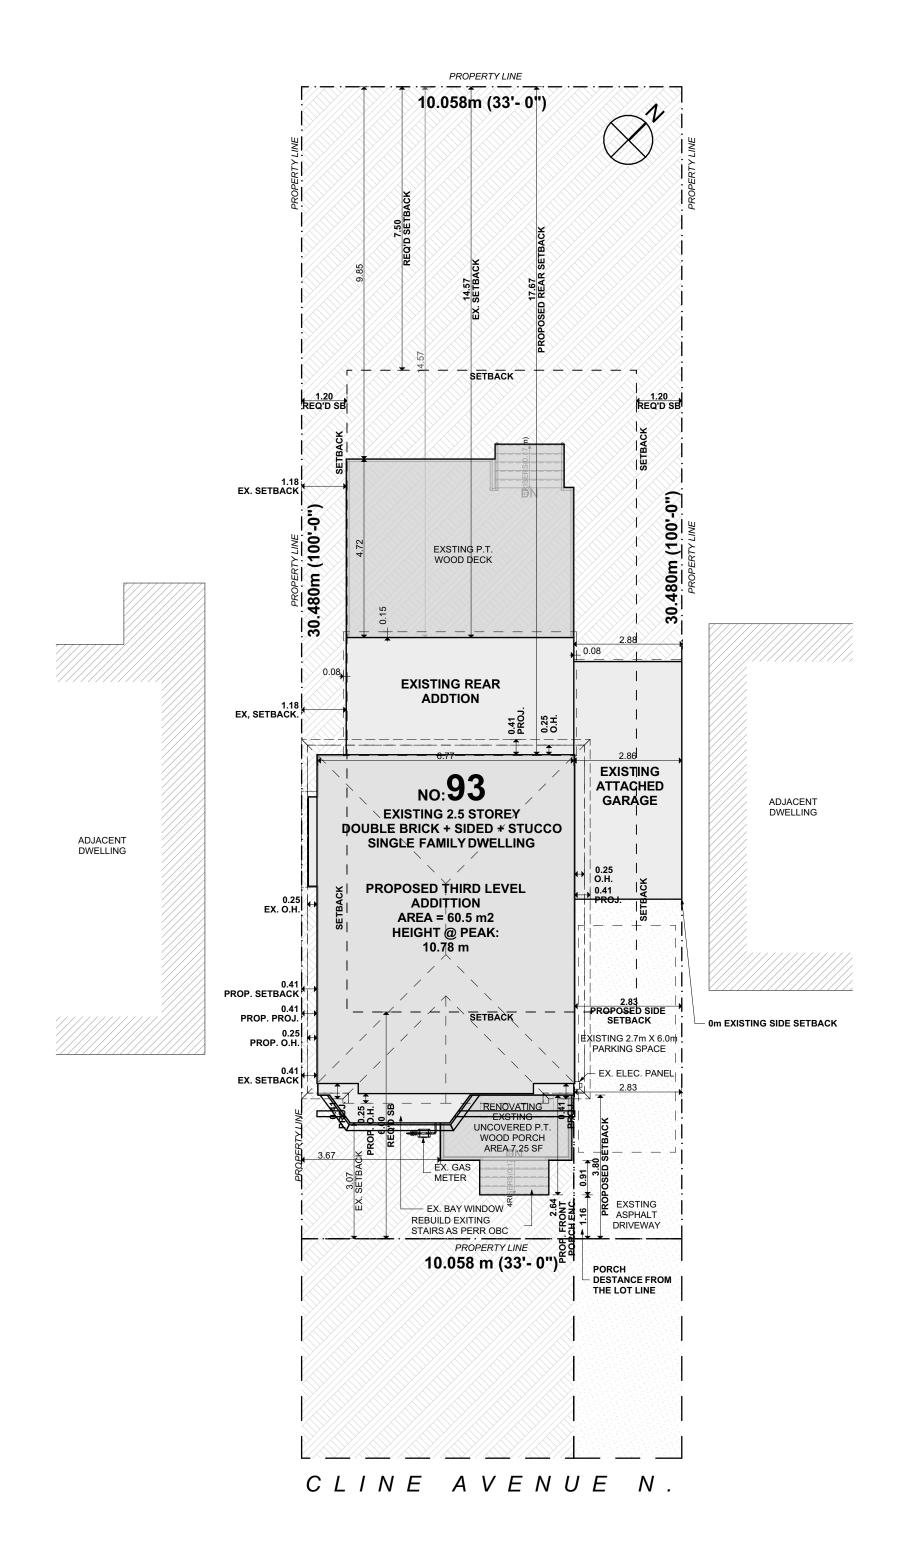PROJECT ADDRESS: 93 Cline Avenue N Hamilton ON L8S 3Z5

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93 Cline Avenue N Hamilton ON L8S 3Z5


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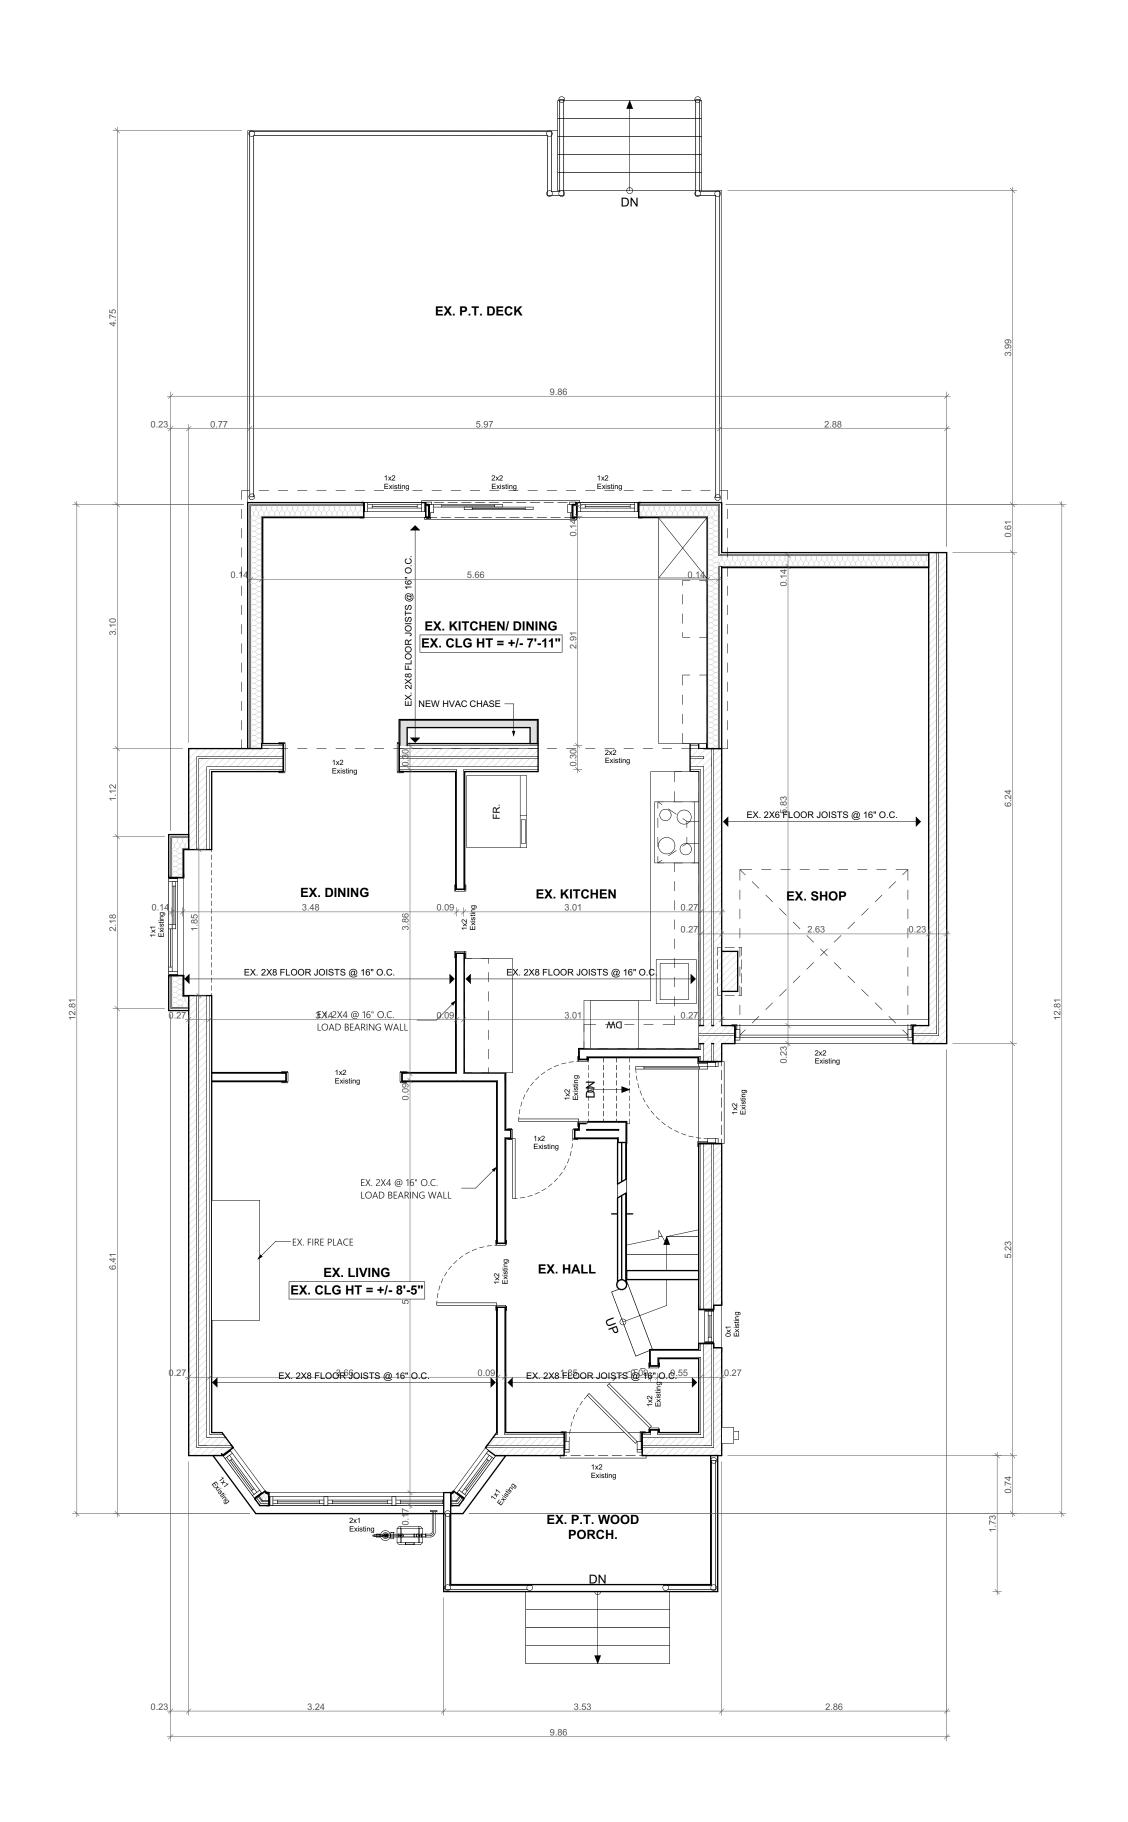


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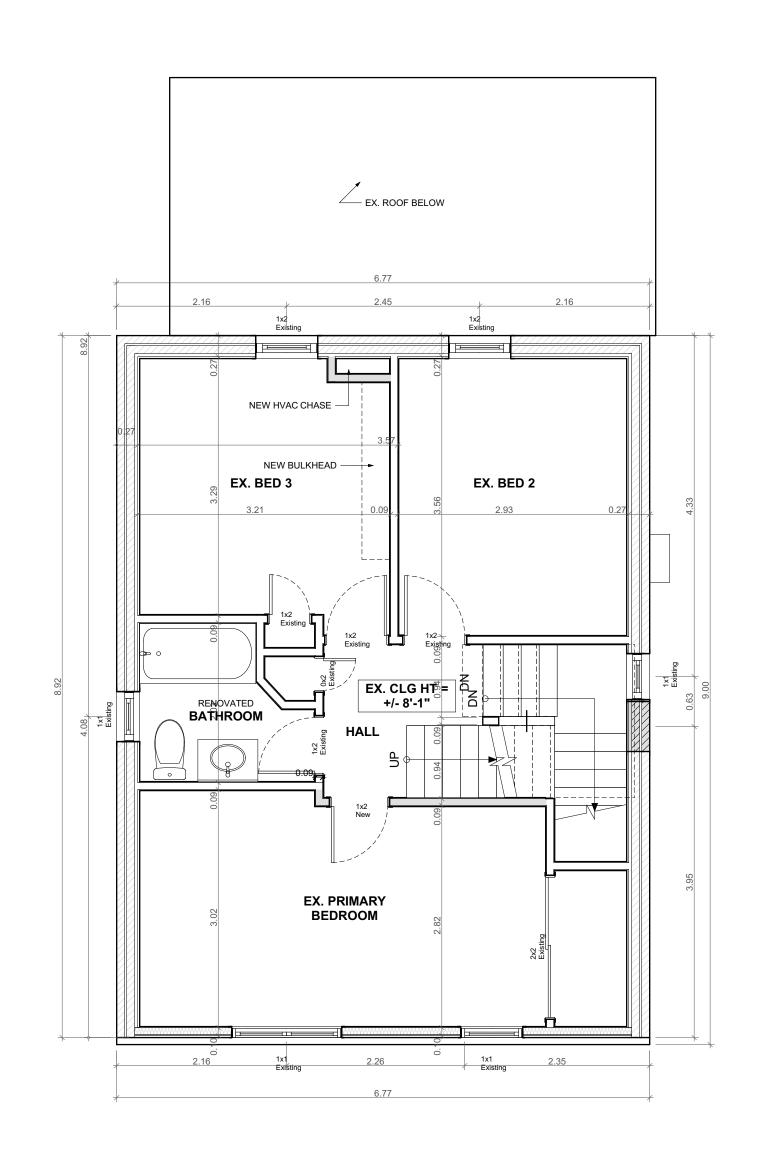
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PROJECT ADDRESS: 93 Cline Avenue N Hamilton ON L8S 3Z5

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2 ISSUED FOR MINOR VARIANCE

NO. REVISION 1 DESIGN 1.2


PROJECT:

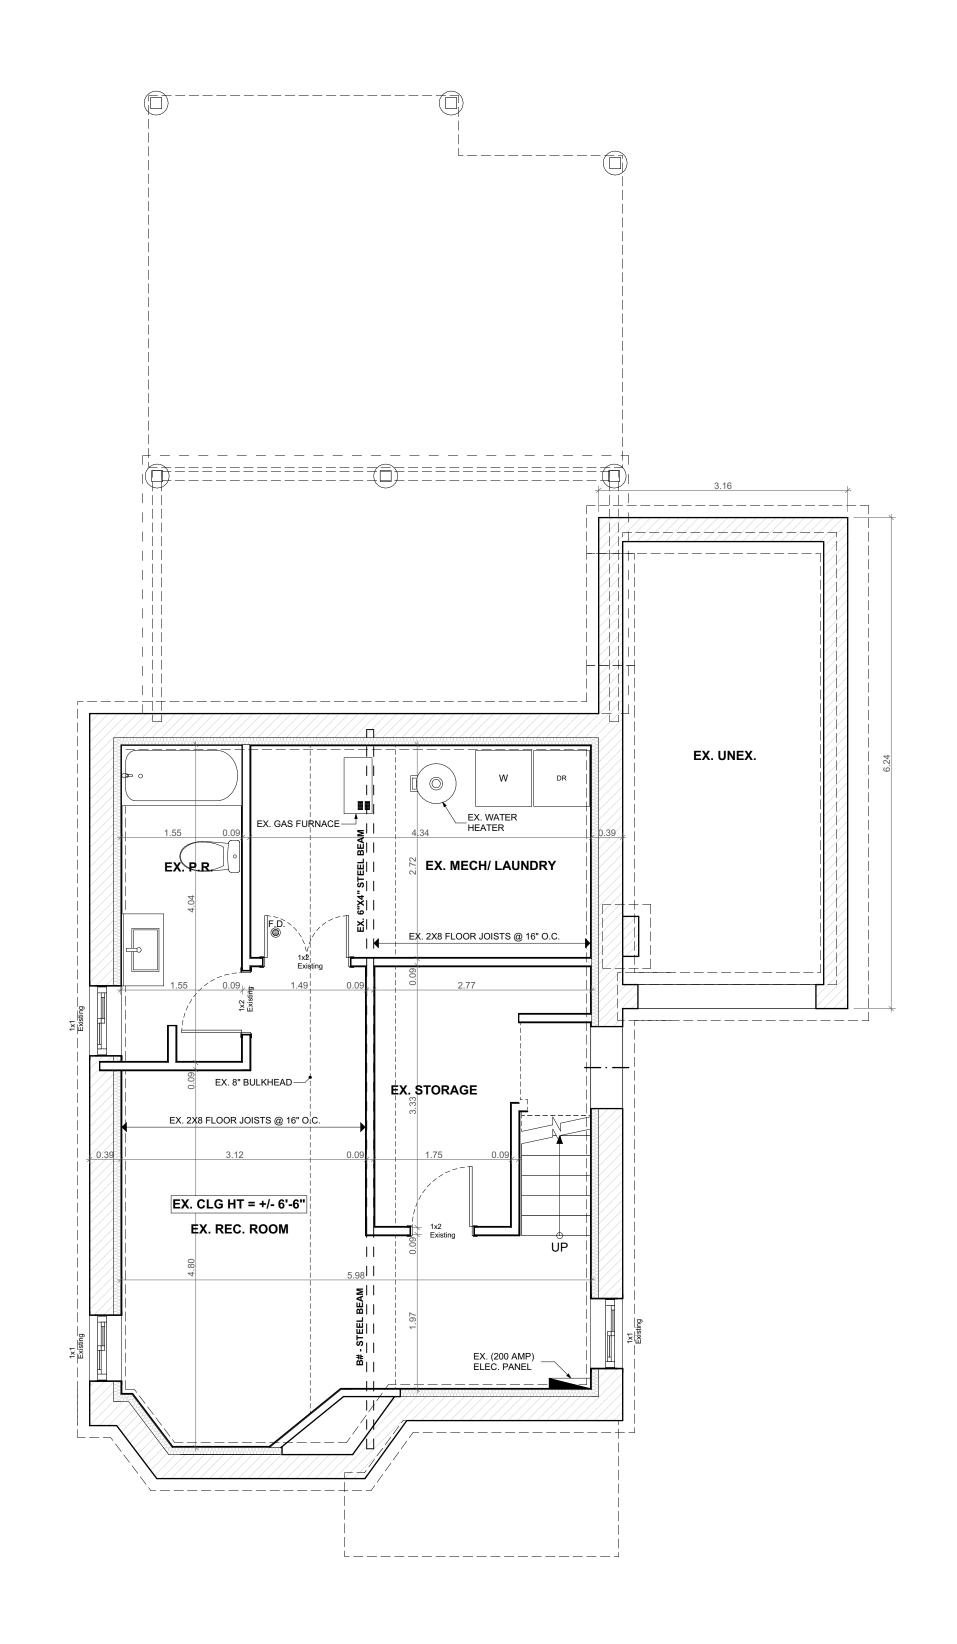KOFMAN

PROJECT ADDRESS: 93 Cline Avenue N Hamilton ON L8S 3Z5

DATE: 2022-07-29

AS NOTED A1.07 PROJECT NO:

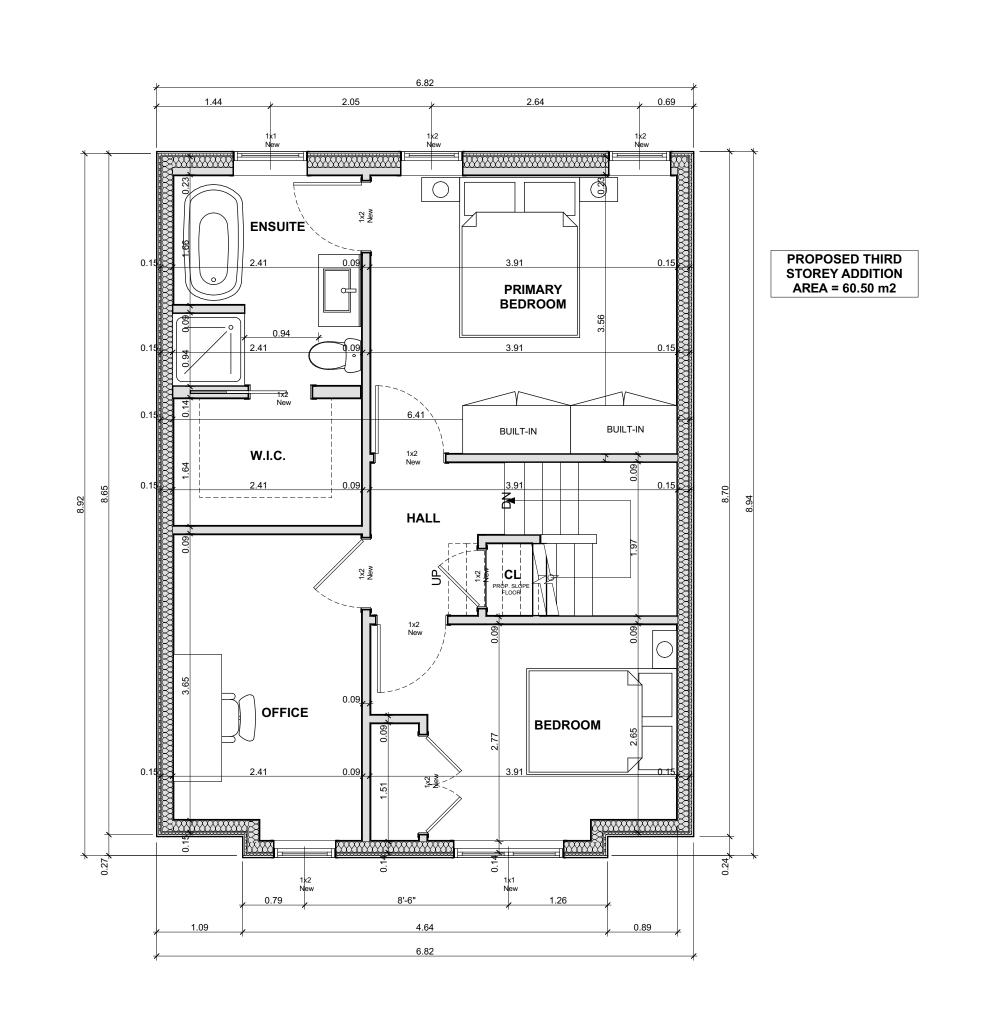



2022.07.04

2022.07.29

NO. REVISION 1 DESIGN 1.2

| DRAWING: PROPOSED THIRD FLOOI PLAN | | |
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2 ISSUED FOR MINOR VARIANCE

PROJECT: **KOFMAN**


PROJECT ADDRESS: 93 Cline Avenue N Hamilton ON L8S 3Z5

DATE: 2022-07-29 AS NOTED A1.08

PROJECT NO:

1 PROPOSED THIRD FLOOR PLAN

SCALE: 1/4" = 1'-0"

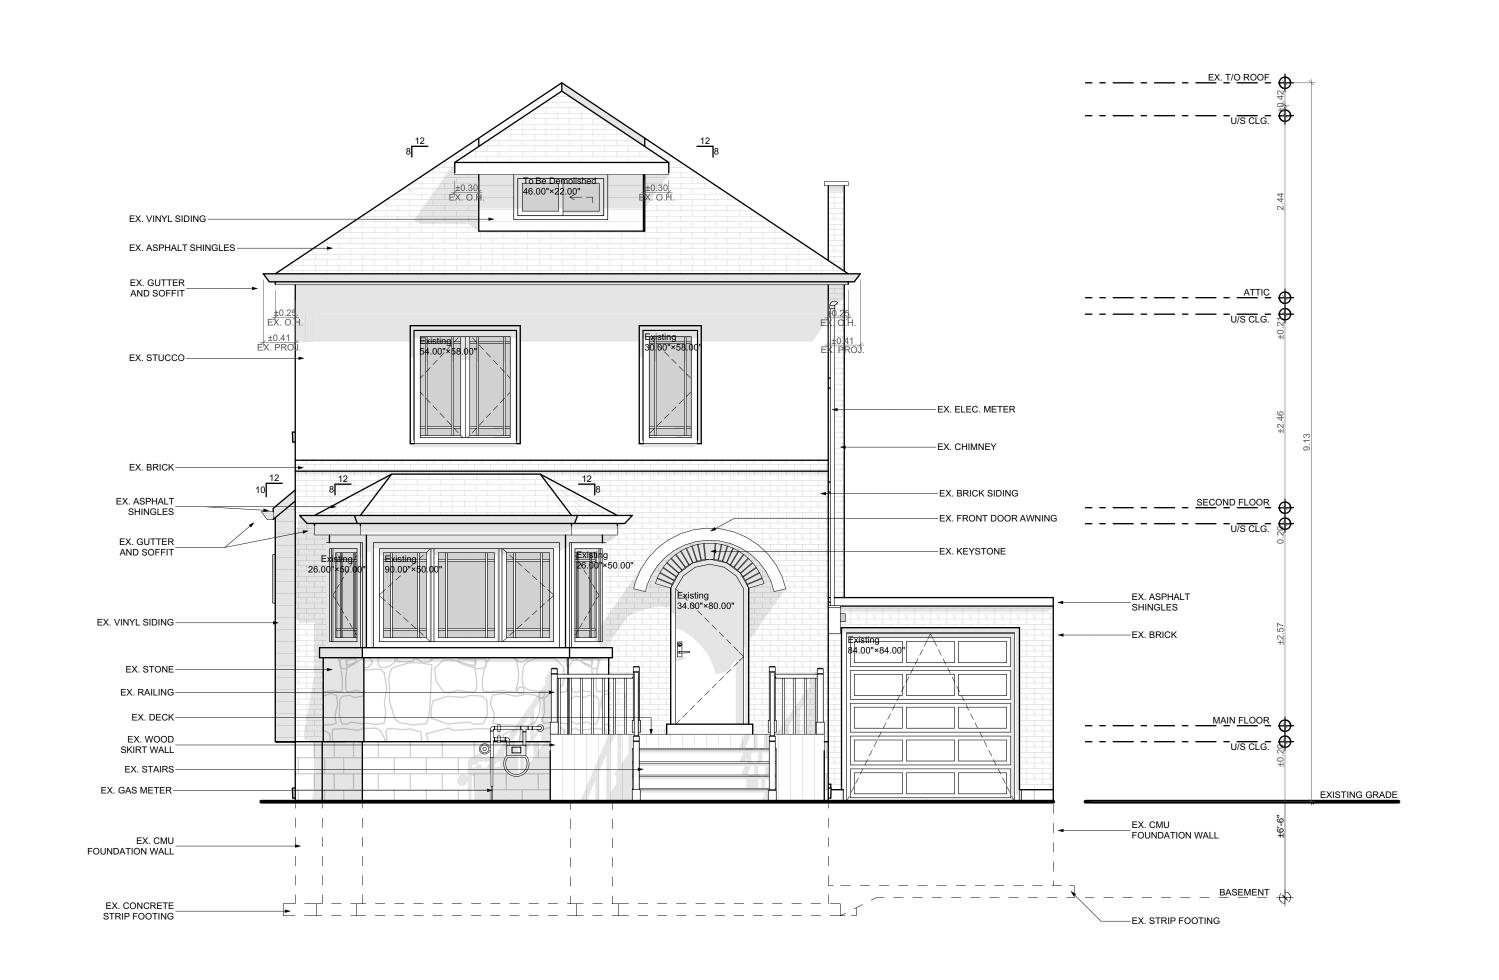



2022.07.04

2022.07.29

| | DRAWING: EXISTING FRON ELEVATION | Т |
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NO. REVISION


1 DESIGN 1.2

2 ISSUED FOR MINOR VARIANCE

PROJECT: **KOFMAN**

PROJECT ADDRESS: 93 Cline Avenue N Hamilton ON L8S 3Z5

DATE: 2022-07-29 DRAWING NO: SCALE: AS NOTED A2.01 PROJECT NO:

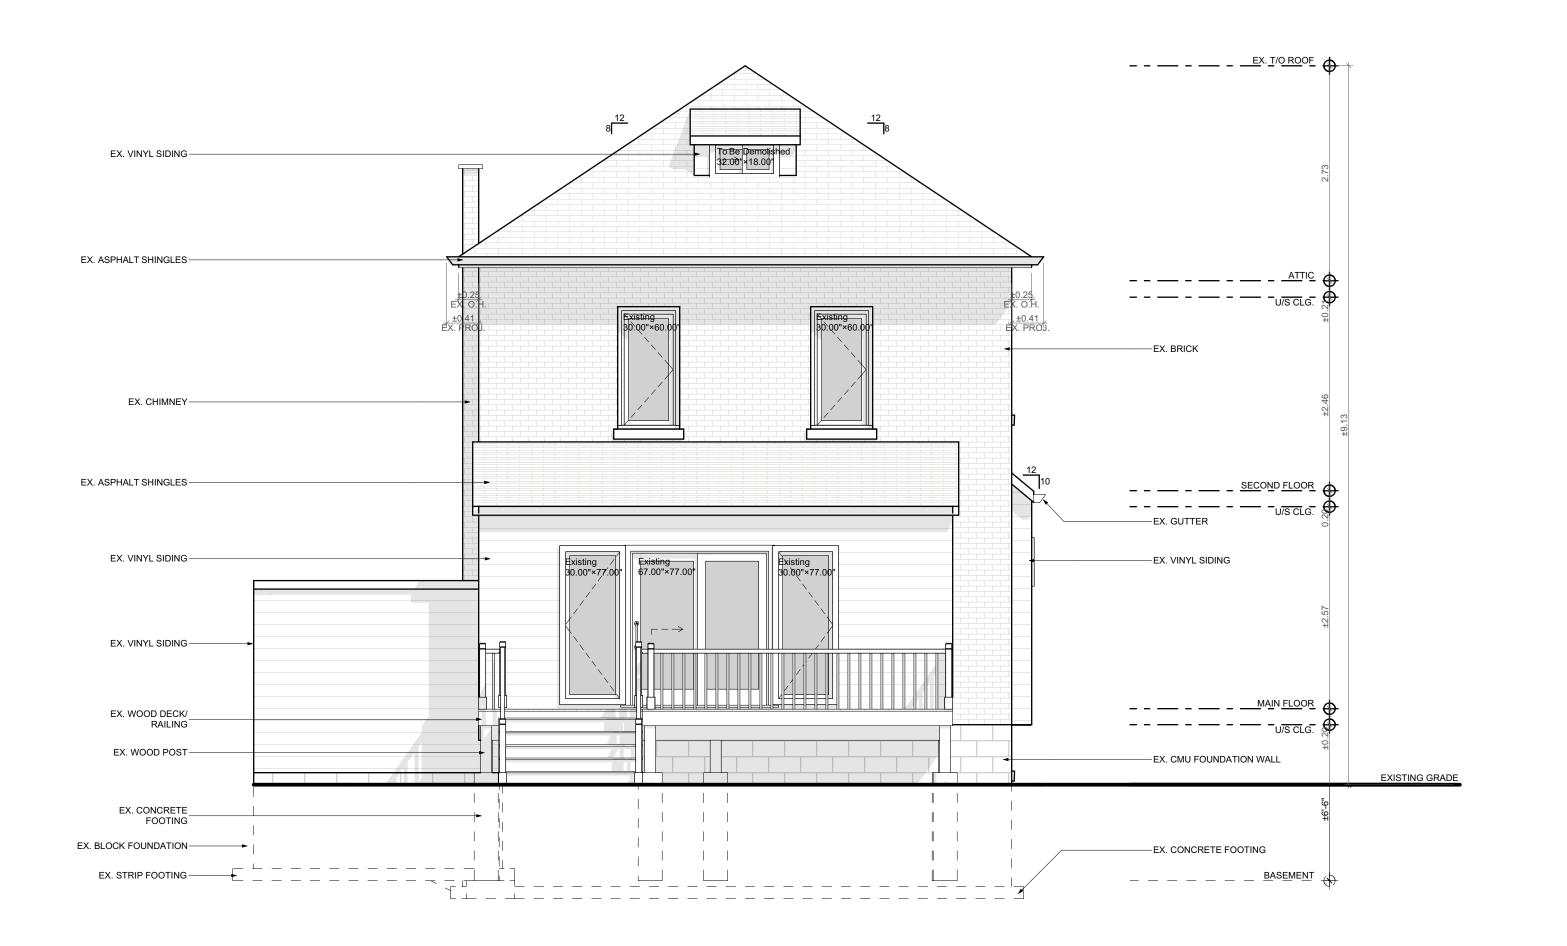




| NO. | REVISION | DATE |
|-----|---------------------------|----------|
| 1 | DESIGN 1.2 | 2022.07. |
| 2 | ISSUED FOR MINOR VARIANCE | 2022.07. |
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PROJECT: **KOFMAN**

PROJECT ADDRESS: 93 Cline Avenue N Hamilton ON L8S 3Z5

DATE: 2022-07-29

DRAWING NO: SCALE: AS NOTED A2.02 PROJECT NO:



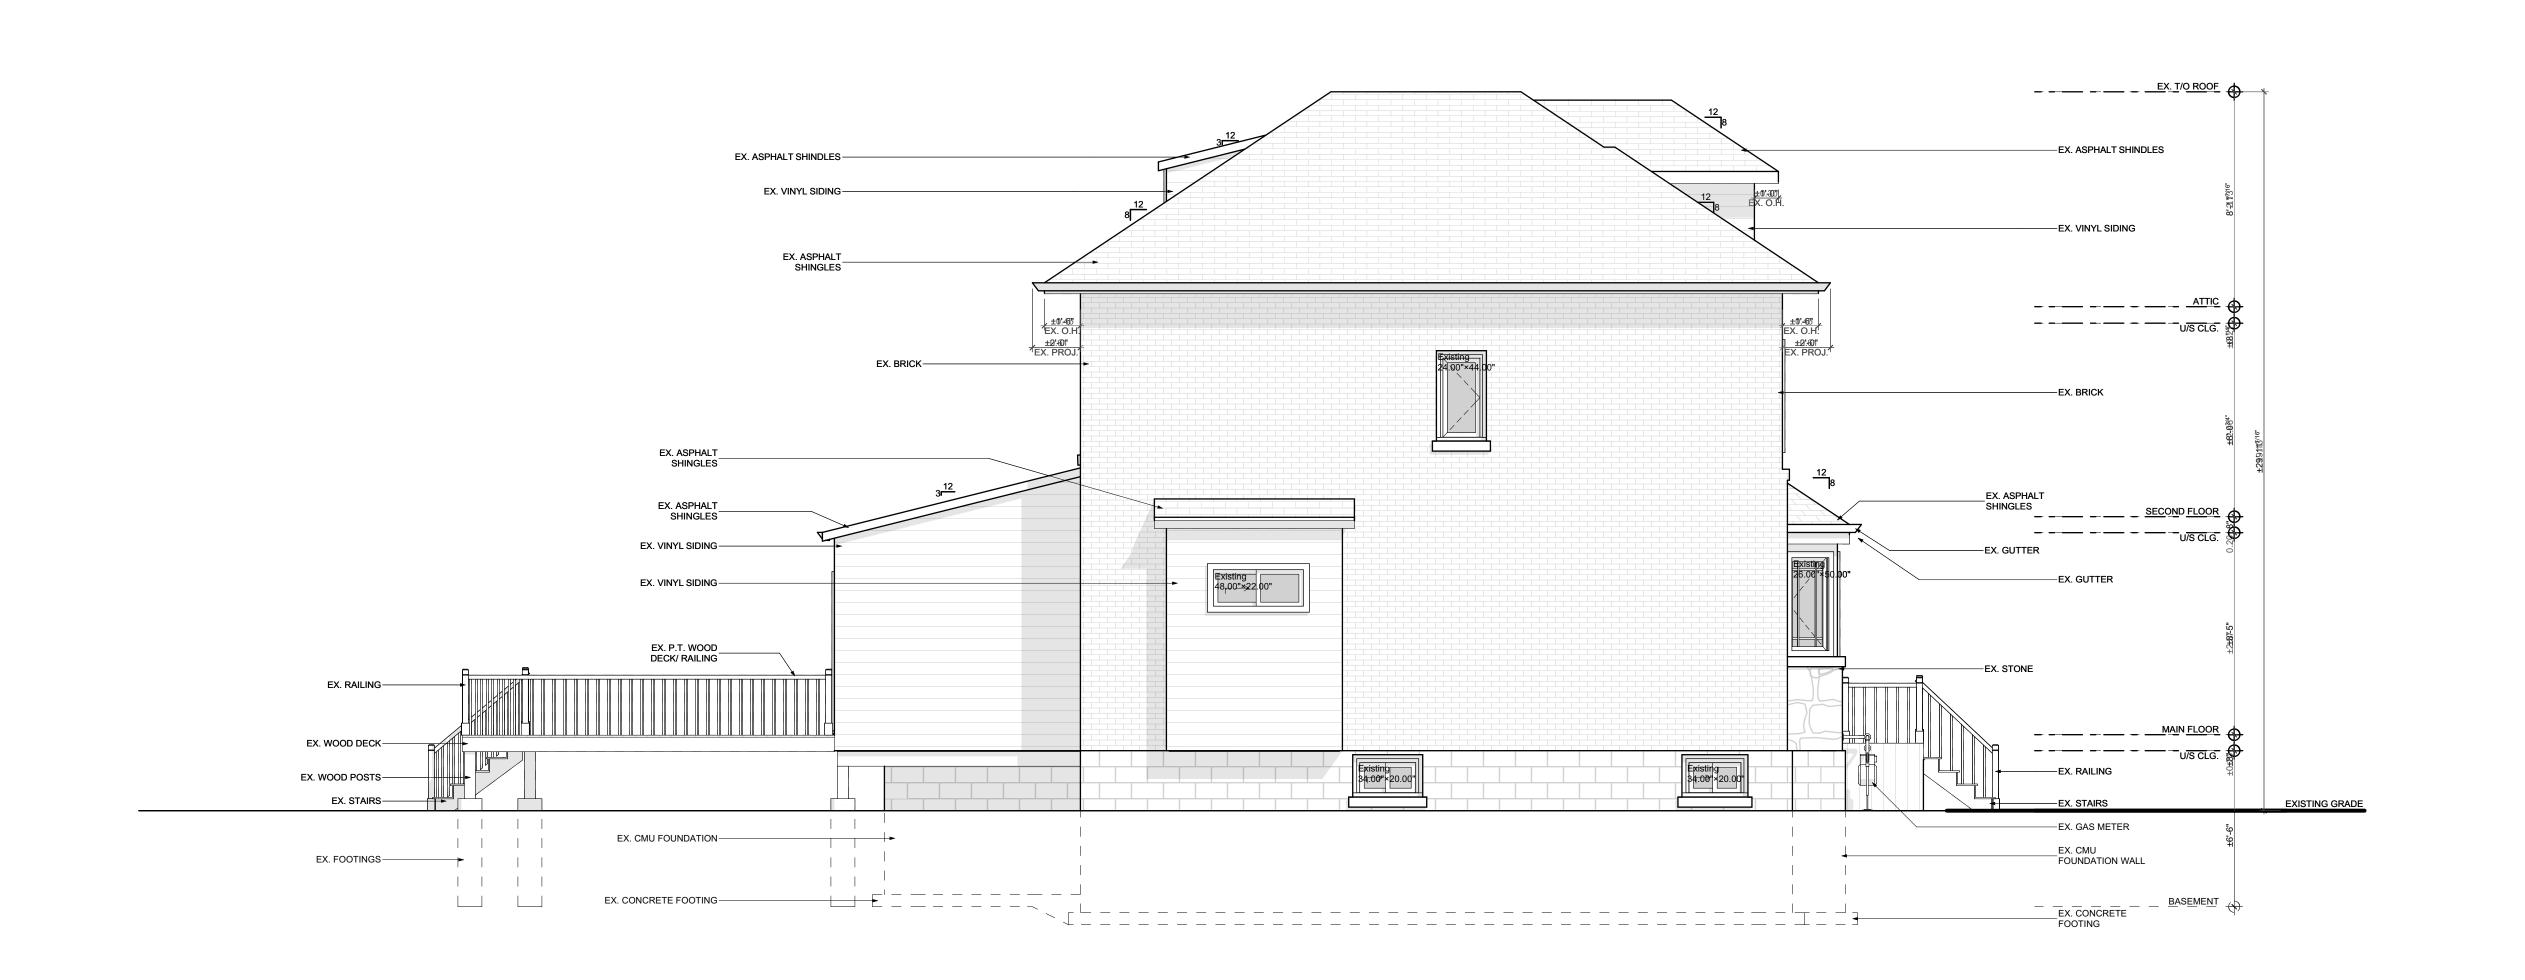

2022.07.04

2022.07.29

NO. REVISION

1 DESIGN 1.2

2 ISSUED FOR MINOR VARIANCE


| E | EXISTING LEFT ELEVATION | | |
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PROJECT: **KOFMAN**

PROJECT ADDRESS: 93 Cline Avenue N Hamilton ON L8S 3Z5

DATE: 2022-07-29

DRAWING NO: SCALE: AS NOTED A2.03 PROJECT NO:



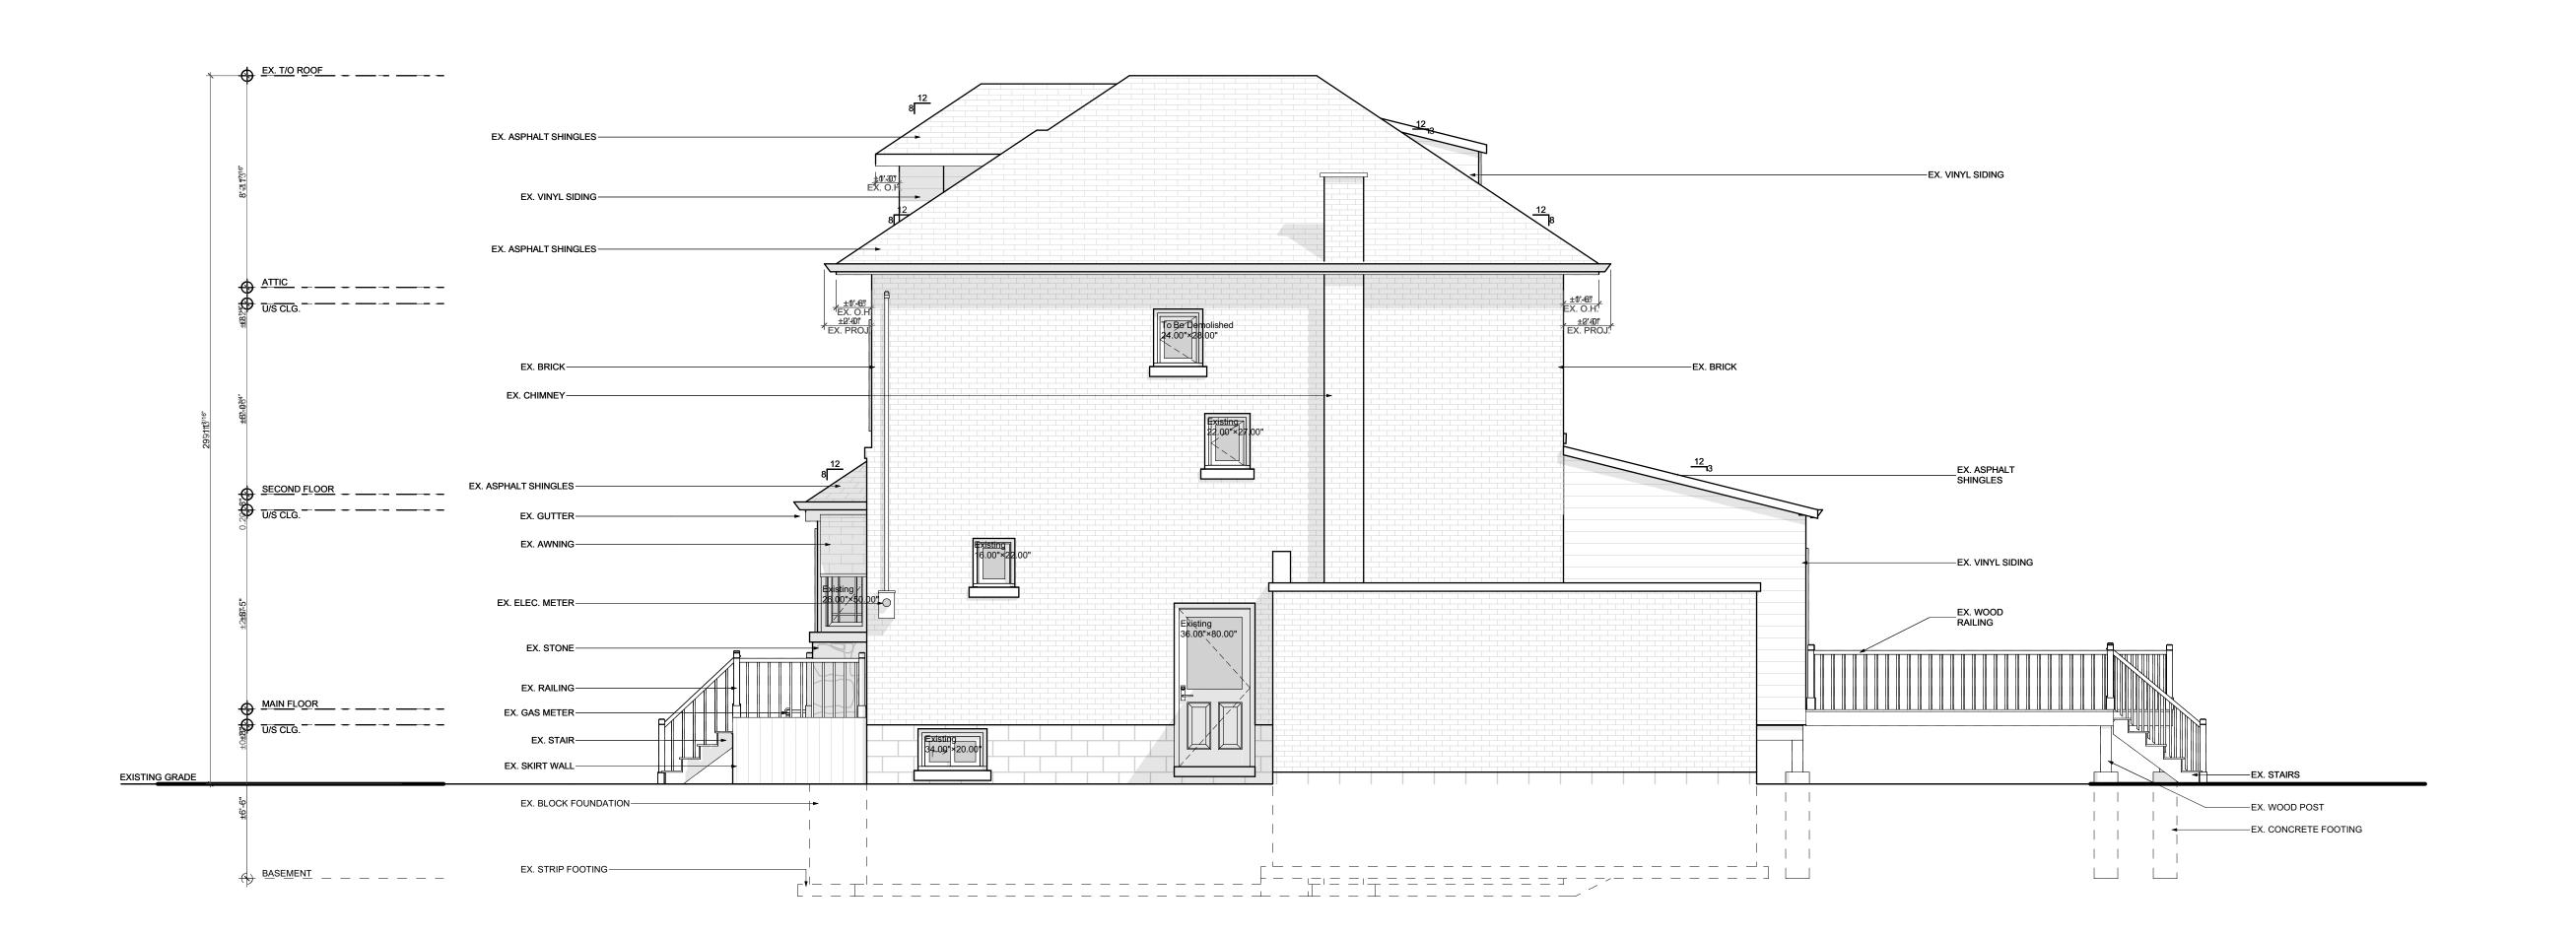

DATE2022.07.04

| 2 | ISSUED FOR MINOR VARIANCE | 2022.07.29 |
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NO. REVISION

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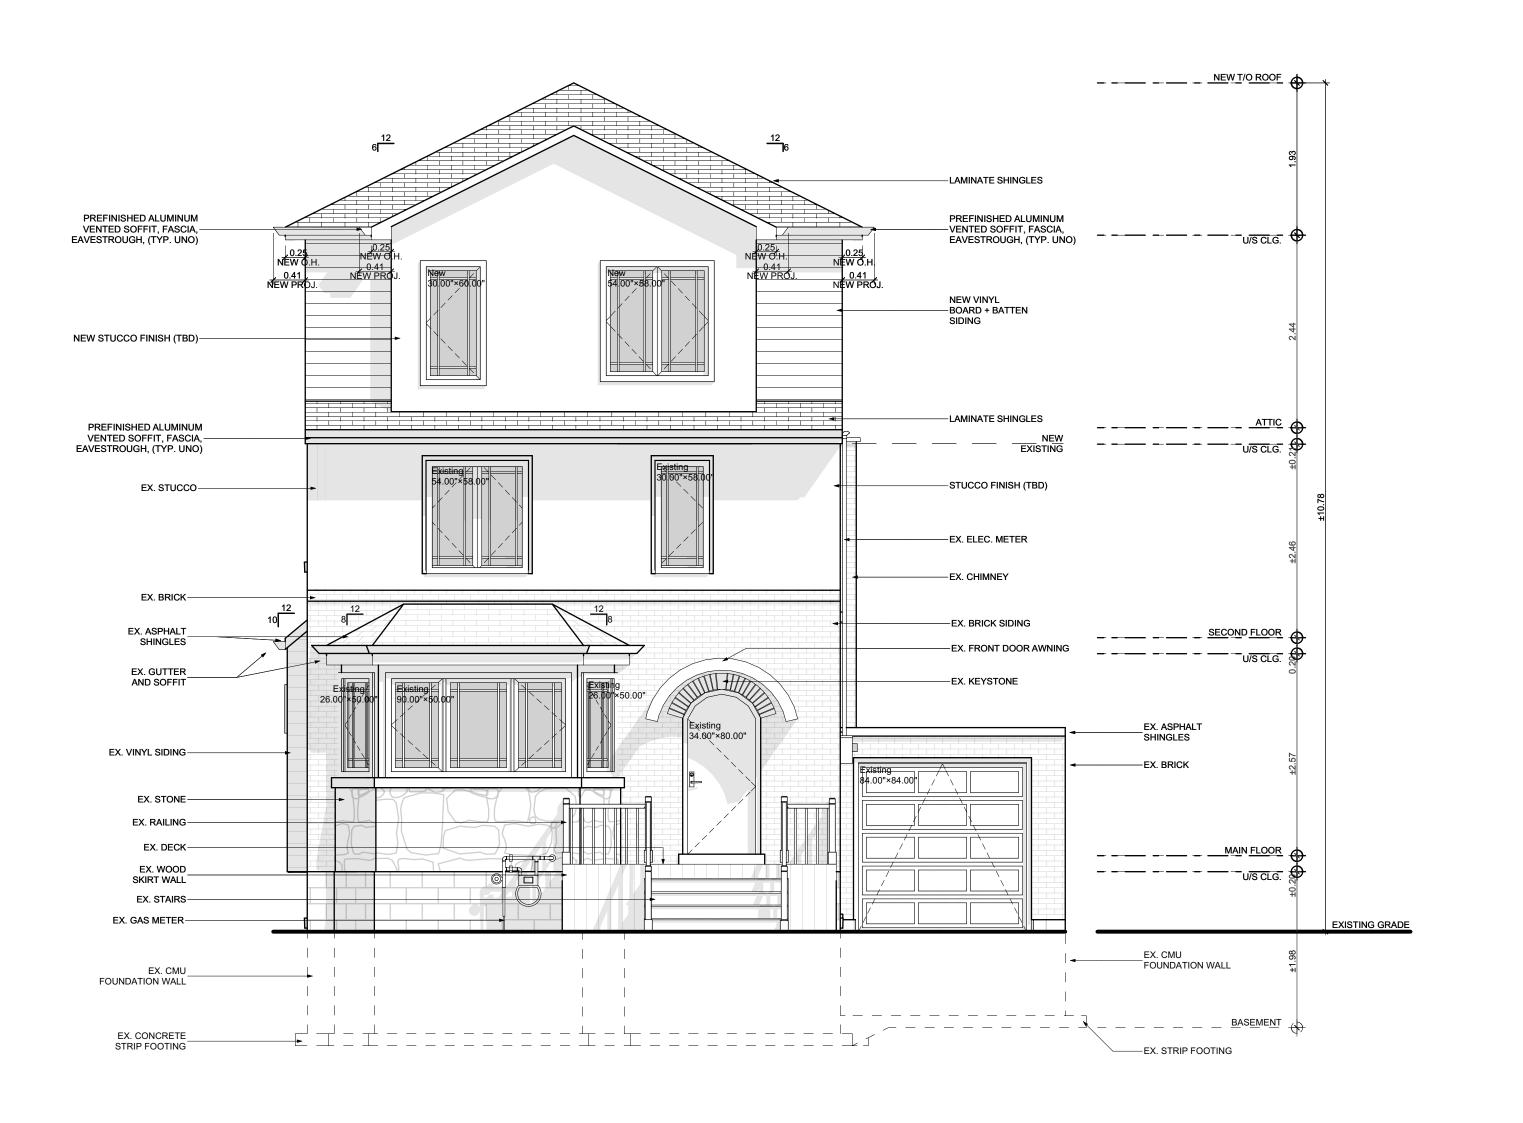
KOFMAN

PROJECT ADDRESS: 93 Cline Avenue N Hamilton ON L8S 3Z5

DATE: 2022-07-29 DRAWING NO: SCALE: AS NOTED A2.04 PROJECT NO:

1 EXISTING RIGHT ELEVATION

SCALE: 1/4" = 1'-0"





2022.07.04

2022.07.29

| | DRAWING: PROPOSED FROM | ۱٦ |
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| | ELEVATION | |
| | PROJECT: | |

2 ISSUED FOR MINOR VARIANCE

NO. REVISION


1 DESIGN 1.2

KOFMAN

PROJECT ADDRESS: 93 Cline Avenue N Hamilton ON L8S 3Z5

DATE: 2022-07-29

DRAWING NO: SCALE: AS NOTED A2.05 PROJECT NO:

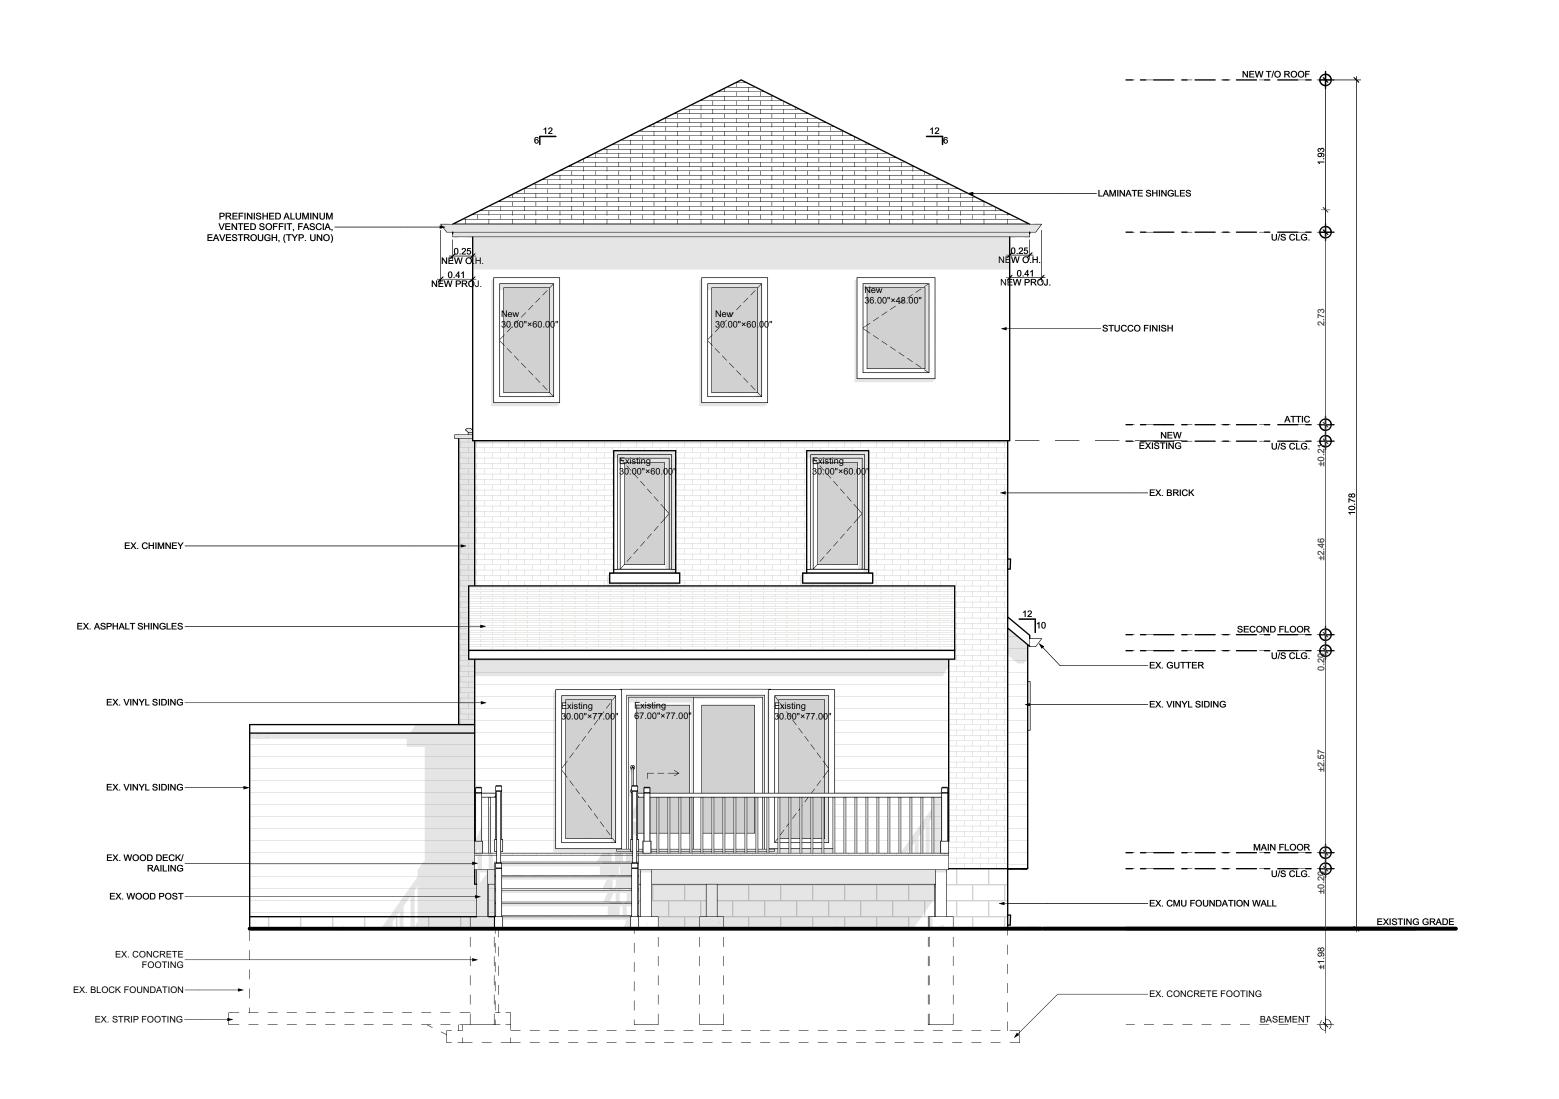




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| 1 | DESIGN 1.2 | 2022.07.04 |
| 2 | ISSUED FOR MINOR VARIANCE | 2022.07.29 |
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| | DRAWING: PROPOSED RE ELEVATION | AR |

PROJECT ADDRESS: 93 Cline Avenue N Hamilton ON L8S 3Z5

KOFMAN

DATE: 2022-07-29 DRAWING NO: SCALE: AS NOTED A2.06

PROJECT NO:

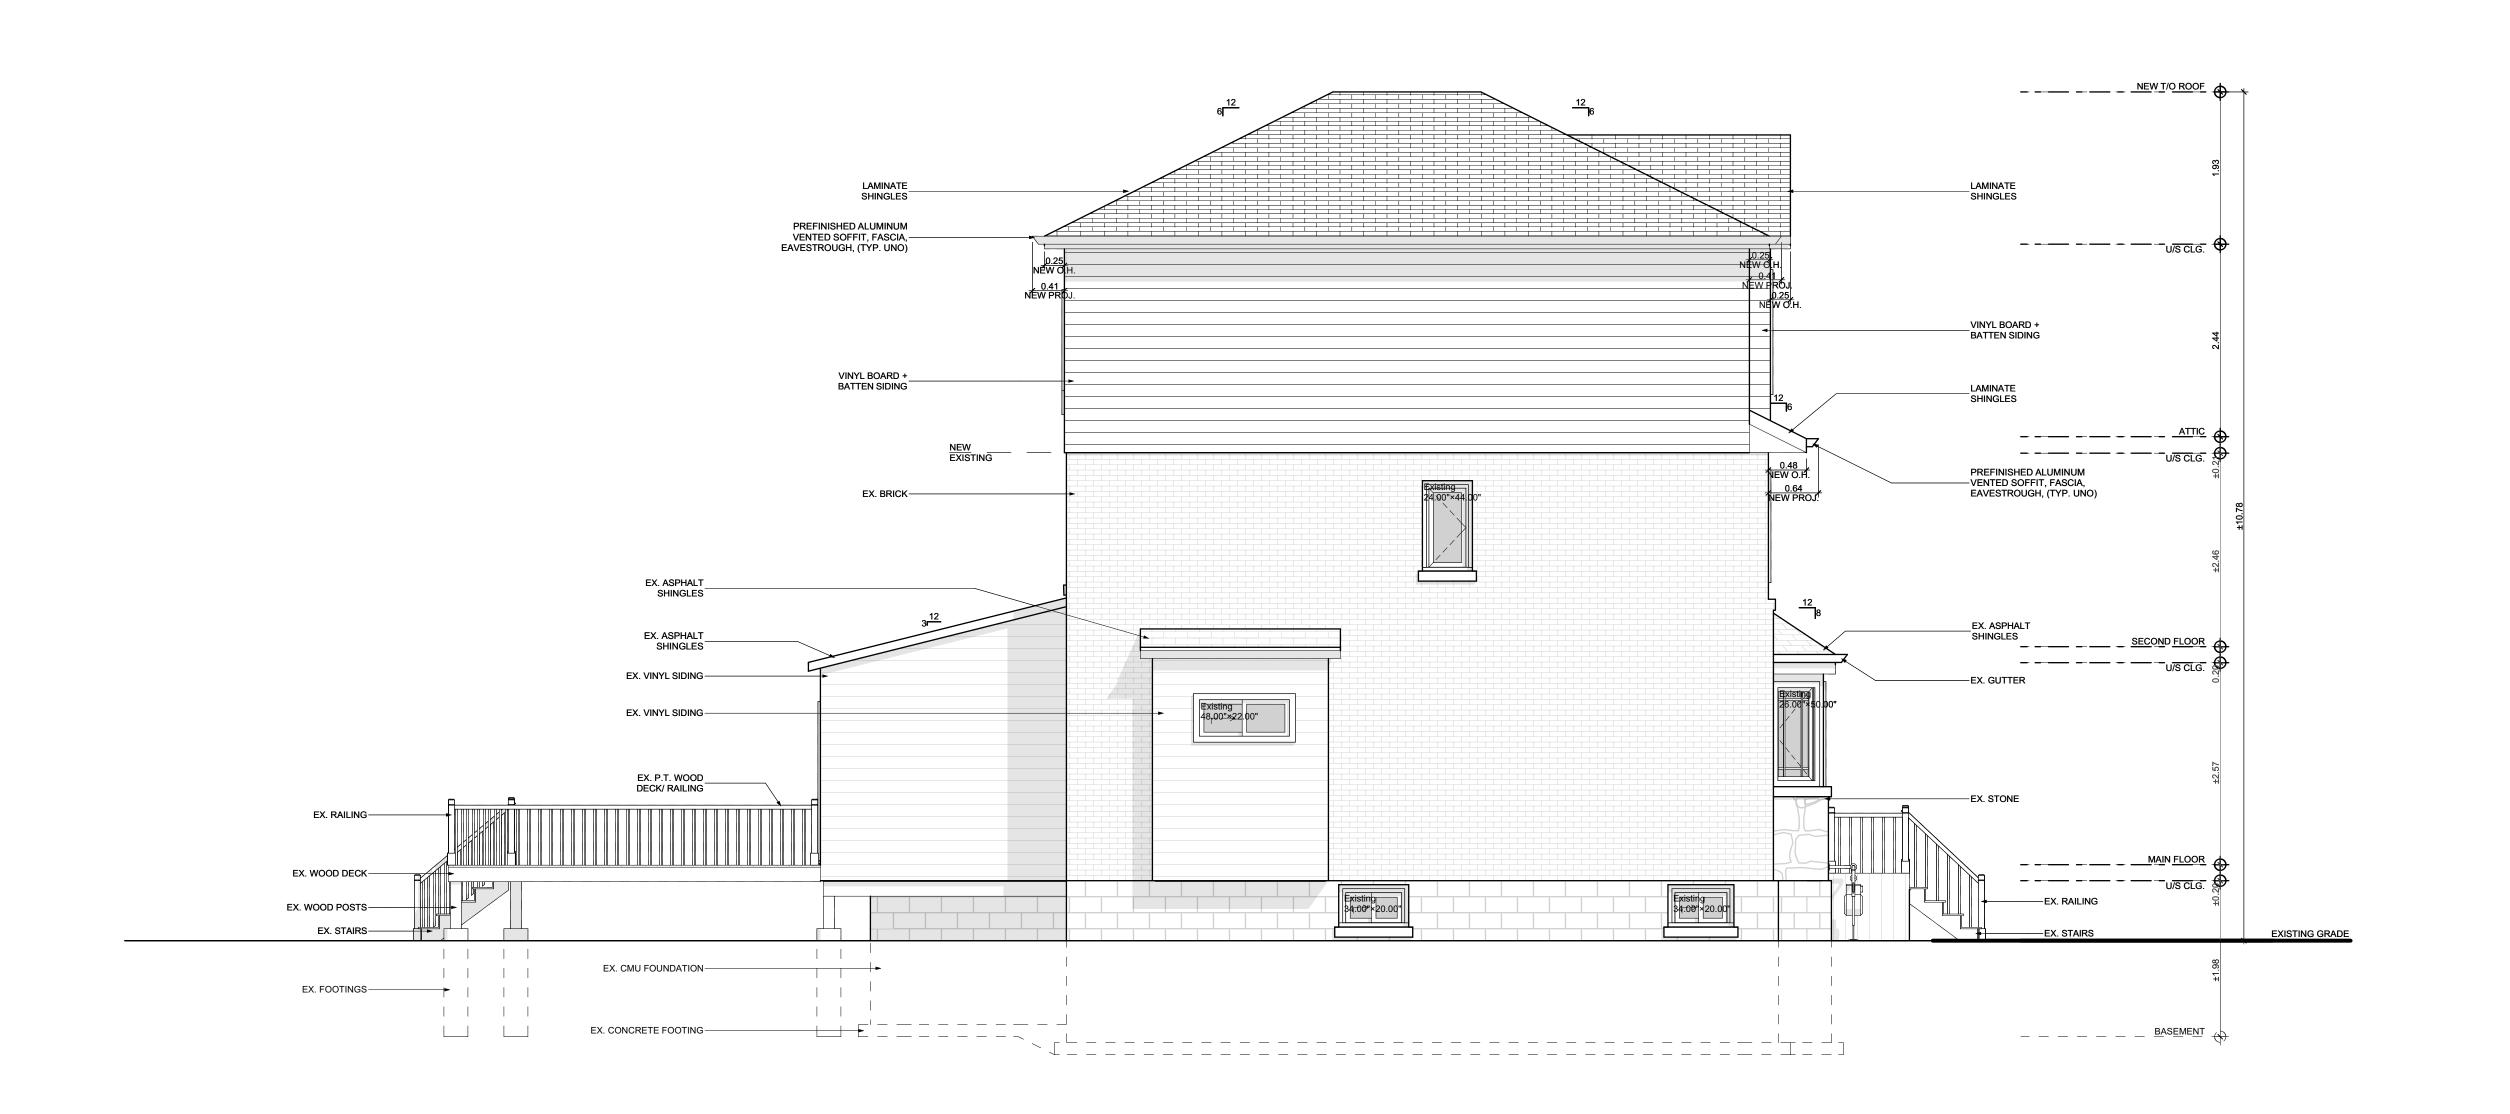



2022.07.04

2022.07.29

| DRAWING: PROPOSED LEFT ELEVATION |
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2 ISSUED FOR MINOR VARIANCE

NO. REVISION

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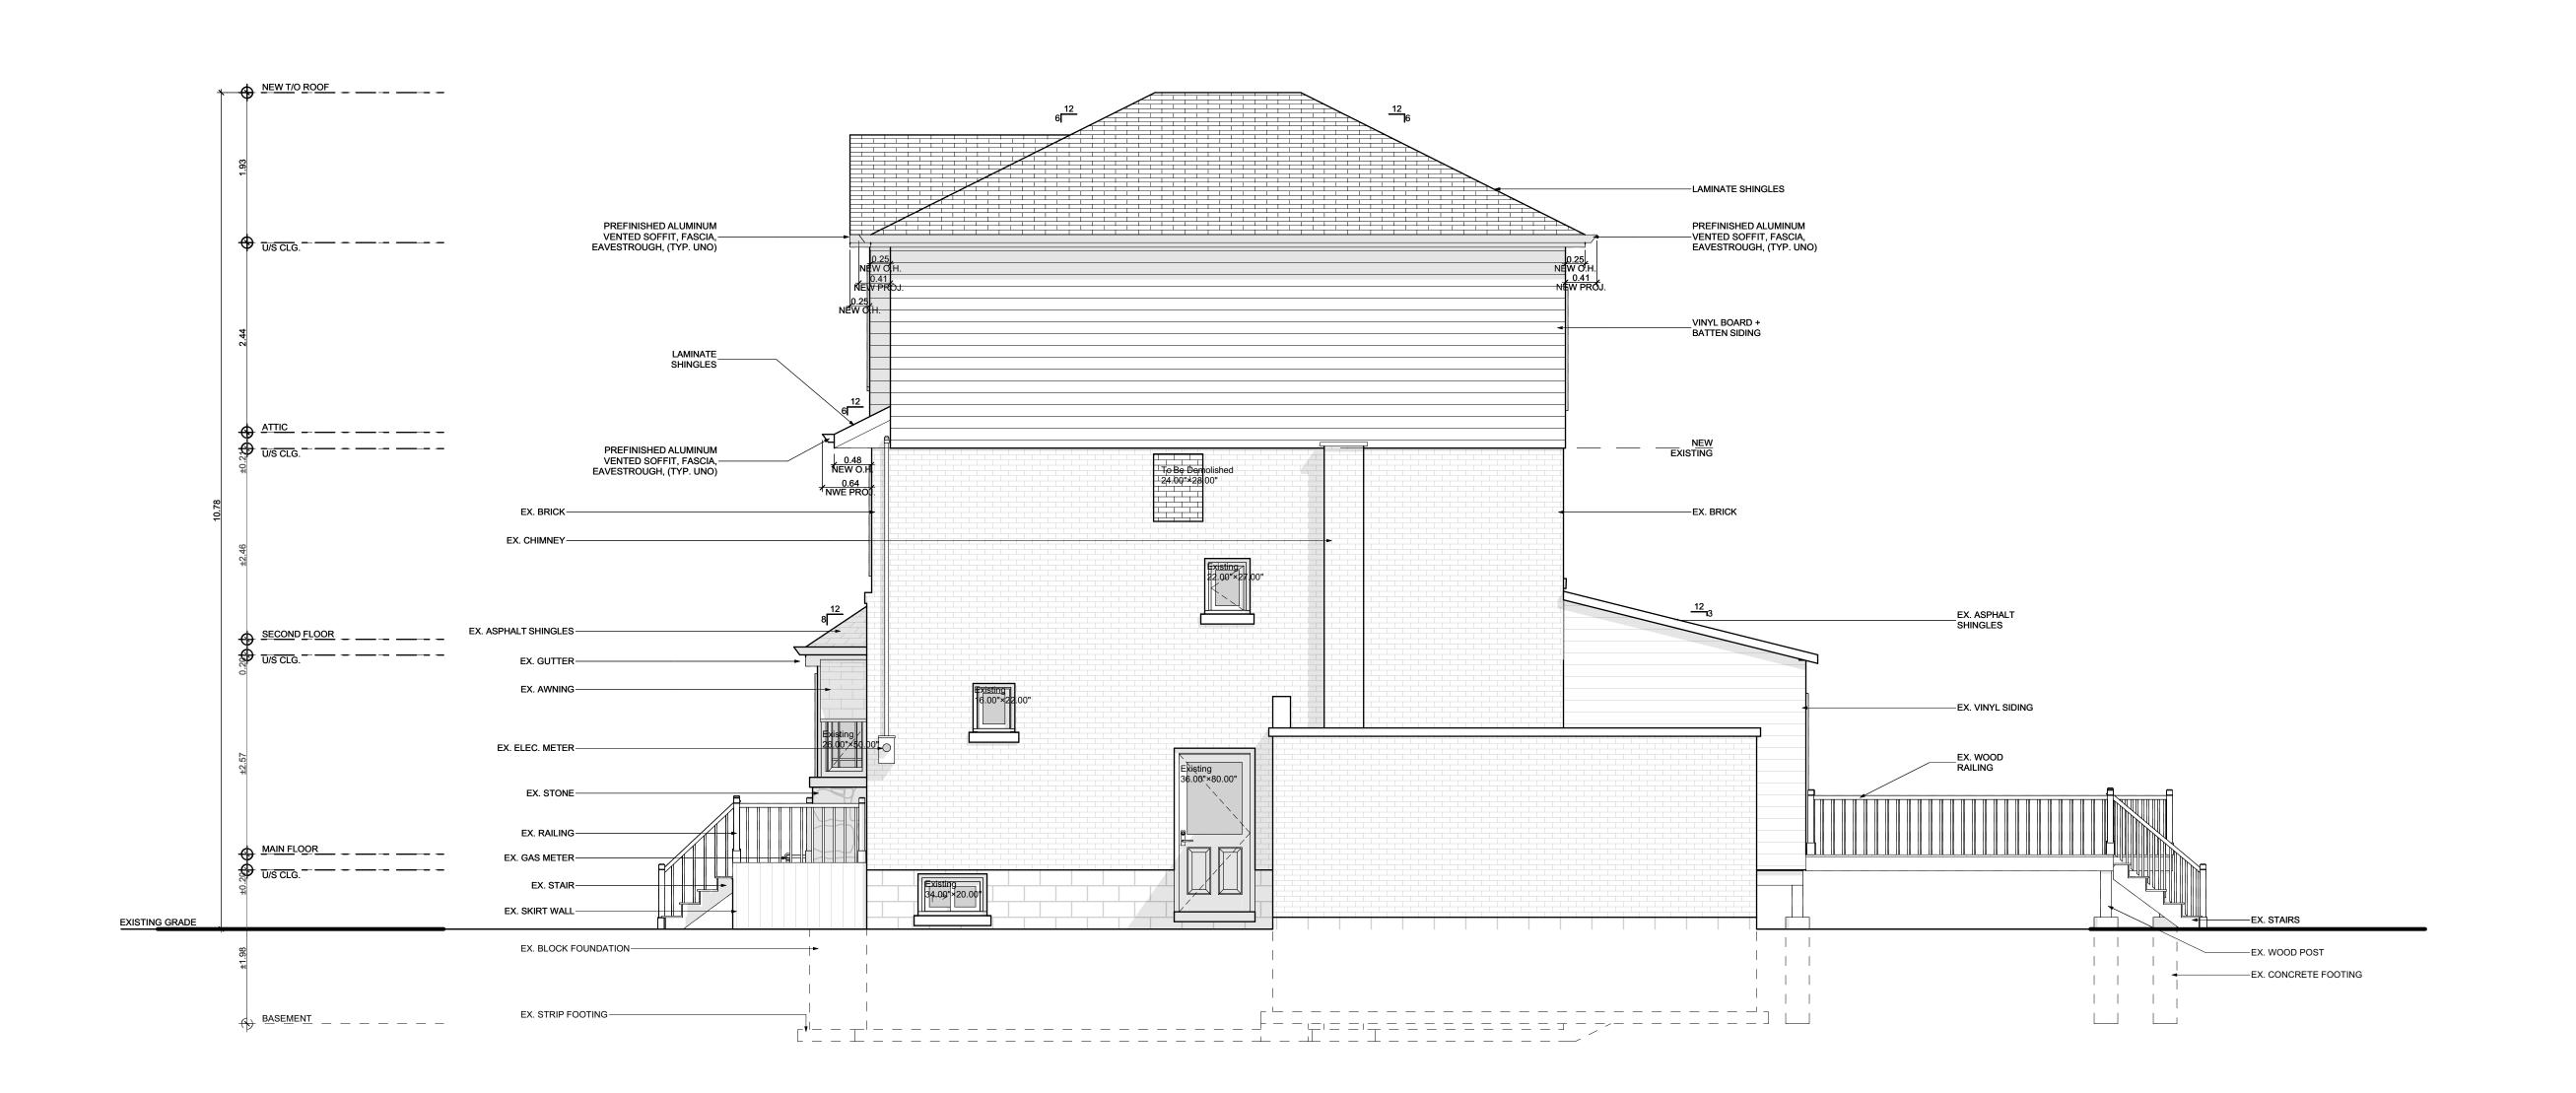
PROJECT:

KOFMAN

PROJECT ADDRESS: 93 Cline Avenue N Hamilton ON L8S 3Z5

DATE: 2022-07-29

DRAWING NO: SCALE: AS NOTED A2.07 PROJECT NO:





2022.07.04

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| | PROPOSED RIG ELEVATION PROJECT: | НТ |
| | PROPOSED RIG ELEVATION | НТ |

NO. REVISION

1 DESIGN 1.2

PROJECT ADDRESS: 93 Cline Avenue N Hamilton ON L8S 3Z5

DATE: 2022-07-29 DRAWING NO: SCALE: AS NOTED A2.08 PROJECT NO:



Committee of Adjustment

City Hall, 5th Floor, 71 Main St. W., Hamilton, ON L8P4Y5

Phone: (905) 546-2424 ext. 4221

Email: cofa@hamilton.ca

APPLICATION FOR A MINOR VARIANCE

| FOR OFFICE USE ONLY. | | |
|--------------------------|----------------------------------|--|
| APPLICATION NO. | DATE APPLICATION RECEIVED | |
| PAID | DATE APPLICATION DEEMED COMPLETE | |
| SECRETARY'S SIGNATURE | | |

The Planning Act

Application for Minor Variance or for Permission

The undersigned hereby applies to the Committee of Adjustment for the City of Hamilton under Section 45 of the *Planning Act*, R.S.O. 1990, Chapter P.13 for relief, as described in this application, from the Zoning By-law.

| 1, 2 | NAME | | |
|-------------------------|--|--|--|
| Registered Owners(s) | LEONARD KOFMAN AND SONJA O'NEIL (OWNERS) | | |
| Applicant(s)* | LOUIE SAYEGH (TEAM SHANE) | | |
| Agent or Solicitor | LOUIE SAYEGH (TEAM SHANE) | | |

Note: Unless otherwise requested all communications will be sent to the agent, if any.

| ^ | Names and addresses of | £ L | - | 41 | |
|-----|------------------------|------------------|--------------------|----------------|-------------|
| 2 | Names and addresses of | IT ANV MARKAGAAA | nolders of chardes | or other onci | Imprancac |
| .) | Diames and addresses t | n anv monuauees | HOUSE S OF CHAIGES | OI OILEL ELICA | HILLIAN CES |
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BMO Bank of Montreal 100 King St W, Toronto ON M5X 1A3

Additional sheets can be submitted if there is not sufficient room to answer the following questions. Additional sheets must be clearly labelled

| 4. | Nature and extent of relief applied for: | | | | | | |
|--|---|--|--|--|--|--|--|
| | • To allow a GFA of 81.39% instead of 45% as we are only increasing 8.75% from the existing non-conforming GFA of 72.66%. •To allow a max. number of stories of 3 instead of the required 2.5 stories. • To allow for the front (southerly) side setback to be 3.80 instead of the required 6.0 with its 0.43m roof projection •To allow for the left (westerly) side setback to be 0.43m instead of the required 1.2m and its 0.43m roof projection •Relief of front porch setback 1.16m instead of the min. required 1.50m • Allow maintaining 1 parking spot instead of the required 3 parking spots •Add any other required variances as per the site plan submitted with this application. | | | | | | |
| | ☐ Second Dwelling Unit ☐ Reconstruction of Existing Dwelling | | | | | | |
| 5. | Why it is not possible to comply with the provisions of the By-law? | | | | | | |
| | The existing single family dwelling cannot comply with the current zoning by-law regulations due to the existing non-confirming condition. | | | | | | |
| 6. | Legal description and Address of subject lands (registered plan number and lot number or other legal description and where applicable, street and street number): | | | | | | |
| 93 CLINE AVE N PT LOTS 826 & 827 PLAN 652, AS IN VM223462 PIN #174630169 | | | | | | | |
| 7. | PREVIOUS USE OF PROPERTY | | | | | | |
| | Residential Industrial Commercial | | | | | | |
| | Agricultural Vacant | | | | | | |
| | Other N/A | | | | | | |
| 8.1 | If Industrial or Commercial, specify use N/A | | | | | | |
| 8.2 | Has the grading of the subject land been changed by adding earth or other material, i.e. has filling occurred? | | | | | | |
| | Yes ☐ No ■ Unknown ☐ | | | | | | |
| 8.3 | Has a gas station been located on the subject land or adjacent lands at any time? Yes No Unknown | | | | | | |
| 8.4 | Has there been petroleum or other fuel stored on the subject land or adjacent lands? Yes □ No ■ Unknown □ | | | | | | |
| 8.5 | Are there or have there ever been underground storage tanks or buried waste on the subject land or adjacent lands? | | | | | | |
| 0.0 | Yes No Unknown Unknown | | | | | | |
| 8.6 | Have the lands or adjacent lands ever been used as an agricultural operation where cyanide products may have been used as pesticides and/or sewage sludge was applied to the lands? | | | | | | |
| | Yes No Unknown | | | | | | |
| 8.7 | Have the lands or adjacent lands ever been used as a weapon firing range? Yes ☐ No ■ Unknown ☐ | | | | | | |
| 8.8 | Is the nearest boundary line of the application within 500 metres (1,640 feet) of the fill area of an operational/non-operational landfill or dump? | | | | | | |
| | Yes ☐ No ■ Unknown ☐ | | | | | | |
| 8.9 | If there are existing or previously existing buildings, are there any building materials remaining on site which are potentially hazardous to public health (eg. asbestos, PCB's)? | | | | | | |
| | Yes ☐ No ■ Unknown ☐ | | | | | | |

| 8.10 | Is there any reason uses on the site or a | djacent sites? | ct land may ha | ive been | contamina | ated by fo | mer |
|------|---|---------------------|----------------|-----------|-------------|------------|-------------|
| 8.11 | What information did you use to determine the answers to 8.1 to 8.10 above? Previous uses of the subjected property. | | | | | | |
| 8.12 | If previous use of property is industrial or commercial or if YES to any of 8.2 to 8.10, a previous use inventory showing all former uses of the subject land, or if appropriate, the land adjacent to the subject land, is needed. | | | | | | |
| | Is the previous use i | inventory attached? | Yes | | No 🗌 | N/A |) |
| 9. | I acknowledge that the City of Hamilton is not responsible for the identification and remediation of contamination on the property which is the subject of this Applicatio reason of its approval to this Application. | | | | | | on – by |
| | Date Date | Z ; | Signature P | Neill | | Len | Kelmai |
| 10. | Dimensions of lands affected: | | | | | | |
| | Frontage | 10.058 meters | | | | | |
| | - | 30.480 meters | | | | | _ |
| | Depth | 306.57 meters | | | | | _ |
| | Area | To be confirmed by | y the city | | | | |
| | Width of street | - De commineu i | by the city. | | | | |
| 115 | Particulars of all buildings and structures on or proposed for the subject lands: (Specify ground floor area, gross floor area, number of stories, width, length, height, etc.) | | | | | | |
| | Existing:_ | | | | | | |
| | See site plan. | | | | | | |
| | Proposed | | | | | | |
| | See site plan. | | | | | | |
| 12. | Location of all build distance from side, Existing: See site plan. | | | d for the | subject lar | nds; (Spe | ecify |
| | · | ÷ | | | | | |
| | Proposed: | | | | | | |
| | See site plan. | | | | | | |

| 13. | Date 2014 | of acquisition of s | ubject lands: | | | | |
|-----|---|---|--|------------------------|--|-------------------------|---|
| 14. | | Date of construction of all buildings and structures on subject lands: 1928 | | | | | |
| 15. | | Existing uses of the subject property (single family, duplex, retail, factory etc.): Single Family Dwelling | | | | | |
| 16. | | Existing uses of abutting properties (single family, duplex, retail, factory etc.): Single Family Dwelling | | | | | |
| 17. | • | Length of time the existing uses of the subject property have continued: Since being built | | | | | |
| 18. | | cipal services ava _r YES | ilable: (check the | | riate space or space Connected YES | es) | |
| | | ary Sewer <u>YES</u> n Sewers <u>YES</u> | | <u> </u> | Connected YES | | |
| 19. | Prese | ent Official Plan/Se | econdary Plan pro | ovisions | applying to the land | 1: | |
| | N/A | | | | | | |
| | | | | | | | |
| 20. | Prese | ent Restricted Are | a By-law (Zoning | By-law) | provisions applying | to the land: | |
| | Bylaw | v #6593, Zone C | | | | | |
| | | | | | | | |
| 21. | | - | | ef in res _l | pect of the subject p | property? (Zoning By- | |
| | law A | mendment or Min | _ ′ | | | | |
| | | | ∐ Yes | | No | | |
| | | , please provide tl | ne file number: | | | | |
| | N/A | | | | | | |
| | 21.1 | | e two-year annive — | | nt has been received the by-law being pa | | |
| | | N/A | ☐ Yes | | No | | |
| | 21.2 | Planner that the | application for Mi | inor Vari | il, or Director of Plai ance is allowed mu eing "received" for p | st be included. Failure | 9 |
| 22. | | subject property lanning Act? | the subject of a cu | urrent ap | pplication for conser | nt under Section 53 of | Ī |
| | | | ☐ Yes | | No | | |
| 23. | 3. Additional Information (please include separate sheet if needed) | | | | | | |
| | N/A | | (F | <u></u> | , | | |
| | | | | | | | |
| 0.1 | <u></u> | | | 641. | | | |
| 24. | of the buildi | subject lands and structure | d of all abutting la s on the subject a | nds and nd abutt | | | |