

COMMITTEE OF ADJUSTMENT

City Hall, 5th floor, 71 Main Street West, Hamilton, ON L8P 4Y5
Telephone (905) 546-2424, ext. 4221, 3935

E-mail: cofa@hamilton.ca

NOTICE OF PUBLIC HEARING Minor Variance

You are receiving this notice because you are either:

- Assessed owner of a property located within 60 metres of the subject property
- Applicant/agent on file, or
- Person likely to be interested in this application

APPLICATION	HM/A-23:192	SUBJECT	25 BURLINGTON STREET W,
NO.:		PROPERTY:	HAMILTON
ZONE:	"D" (Urban Protected	ZONING BY-	Zoning By-law former City of
	Residential – One- and Two-	LAW:	Hamilton 6593, as Amended
	Family Dwellings)		

APPLICANTS: Owner: DAVID LIBURDI, FEBBO LIBURDI, & NATHAN DE HAAN

Agent: MICHAEL PONGETTI

The following variances are requested:

Zero (0) onsite parking spaces shall be provided instead of 2 parking spaces for each Class A dwelling unit, for the first 8 habitable rooms in the dwelling unit plus 0.5 parking space for each additional habitable room as well as, and no additional parking space shall be required for either a Secondary Dwelling Unit or a Secondary Dwelling Unit - Detached, provided the required parking spaces which existed on May 12, 2021 for the existing dwelling shall continue to be provided and maintained required.

PURPOSE & EFFECT: To facilitate the establishment of a Secondary Dwelling unit- Detached;

Notes:

1. It is noted that the provided plans show no parking within the existing driveway, should this variance be approved the 1.0m unobstructed path from the street line to the entrance of the Secondary Dwelling unit- Detached will be required to be provided at all times.

This Notice must be posted by the owner of any land which contains seven or more residential units so that it is visible to all residents.

This application will be heard by the Committee as shown below:

HM/A-23:192

DATE:	Thursday, August 24, 2023	
TIME:	9:25 a.m.	
PLACE:	Via video link or call in (see attached sheet for details)	
	2 nd floor City Hall, room 222 (see attached sheet for	
	details), 71 Main St. W., Hamilton	
	To be streamed (viewing only) at	
	www.hamilton.ca/committeeofadjustment	

For more information on this matter, including access to drawings illustrating this request and other information submitted:

- Visit www.hamilton.ca/committeeofadjustment
- Visit Committee of Adjustment staff at 5th floor City Hall, 71 Main St. W., Hamilton
- Call 905-546-CITY (2489) or 905-546-2424 extension 4221, 4130, or 3935

PUBLIC INPUT

Written: If you would like to submit written comments to the Committee of Adjustment you may do so via email or hardcopy. Please see attached page for complete instructions, <u>including deadlines</u> for submitting to be seen by the Committee.

Orally: If you would like to speak to this item at the hearing you may do so via video link, calling in, or attending in person. Please see attached page for complete instructions, including deadlines for registering to participate virtually and instructions for check in to participate in person.

FURTHER NOTIFICATION

If you wish to be notified of future Public Hearings, if applicable, regarding HM/A-23:192, you must submit a written request to cofa@hamilton.ca or by mailing the Committee of Adjustment, City of Hamilton, 71 Main Street West, 5th Floor, Hamilton, Ontario, L8P 4Y5.

If you wish to be provided a Notice of Decision, you must attend the Public Hearing and file a written request with the Secretary-Treasurer by emailing cofa@hamilton.ca or by mailing the Committee of Adjustment, City of Hamilton, 71 Main Street West, 5th Floor, Hamilton, Ontario, L8P 4Y5.

HM/A-23:192



Subject Lands

DATED: August 8, 2023

Jamila Sheffield, Secretary-Treasurer Committee of Adjustment Information respecting this application is being collected under the authority of the Planning Act, R.S.O., 1990, c. P. 13. All comments and opinions submitted to the City of Hamilton on this matter, including the name, address, and contact information of persons submitting comments and/or opinions, will become part of the public record and will be made available to the Applicant and the general public, and may include posting electronic versions.



COMMITTEE OF ADJUSTMENT

City Hall, 5th floor, 71 Main Street West, Hamilton, ON L8P 4Y5 Telephone (905) 546-2424, ext. 4221, 3935

E-mail: cofa@hamilton.ca

PARTICIPATION PROCEDURES

Written Submissions

Members of the public who would like to participate in a Committee of Adjustment meeting are able to provide comments in writing or via email in advance of the meeting. Comments can be submitted by emailing cofa@hamilton.ca or by mailing the Committee of Adjustment, City of Hamilton, 71 Main Street West, 5th Floor, Hamilton, Ontario, L8P 4Y5. **Comments must be received by noon two days before the Hearing.**

Comment packages are available two days prior to the Hearing and are available on our website: www.hamilton.ca/committeeofadjustment

Oral Submissions

Members of the public are also able to provide oral comments regarding Committee of Adjustment Hearing items by participating Virtually through Webex via computer or phone or by attending the Hearing In-person. Participation Virtually requires pre-registration in advance. Please contact staff for instructions if you wish to make a presentation containing visual materials.

1. Virtual Oral Submissions

Interested members of the public, agents, and owners <u>must register by noon the day</u> <u>before the hearing</u> to participate Virtually.

To register to participate Virtually by Webex either via computer or phone, please contact Committee of Adjustment staff by email cofa@hamilton.ca. The following information is required to register: Committee of Adjustment file number, hearing date, name and mailing address of each person wishing to speak, if participation will be by phone or video, and if applicable the phone number they will be using to call in.

A separate registration for each person wishing to speak is required. Upon registering for a meeting, members of the public will be emailed a link for the Webex meeting the Wednesday afternoon before the hearing. The link must not be shared with others as it is unique to the registrant.

2. In person Oral Submissions

Interested members of the public, agents, and owners who wish to participate in person must sign in at City Hall room 222 (2nd floor) no less than 10 minutes before the time of the Public Hearing as noted on the Notice of Public Hearing.

We hope this is of assistance and if you need clarification or have any questions, please email cofa@hamilton.ca or by phone at 905-546-2424 ext. 4221.

Please note: Webex (video) participation requires either a compatible computer or smartphone and an application (app/program) must be downloaded by the interested party in order to participate. It is the interested party's responsibility to ensure that their device is compatible and operating correctly prior to the Hearing.

GENERAL NOTES

- ALL CONSTRUCTION AND MATERIALS TO BE IN ACCORDANCE WITH THE LATEST VERSION. OF THE ONTARIO BUILDING CODE (O.B.C.) INCLUDING THE LATEST STANDARDS REFERENCED WITHIN.
- 2. DRAWINGS ARE NOT TO BE SCALED AT ANY TIME.
- ALL DRAWINGS ARE PROPERTY OF THE ENGINEER AND SHALL NOT BE REPRODUCED IN WHOLE OR IN PART WITHOUT WRITTEN CONSENT.
- CONTRACTOR TO CHECK AND VERIFY ALL DIMENSIONS PRIOR TO COMMENCING ANY WORK AND REPORT ANY DISCREPANCIES TO THE ENGINEER. FAILURE TO DO SO WILL CAUSE FORFEIT TO ANY CLAIM.
- 5. IF ANY ERRORS OR OMISSIONS ARE FOUND ON THESE DRAWINGS, THEY SHALL BE REPORTED TO THE DESIGNER PRIOR TO CONSTRUCTION, DRAWINGS MUST BE REVIEWED.

DESIGN LOADS

1.	GROUND SNOW (Ss) / RAIN (Sr):	1.3 kPa / 0.4 kPa			
2.	MAXIMUM ROOF SNOW (S):	1.44 kPa			
3.	ROOF DEAD LOAD (D):	1.0 kPa			
4.	WIND LOAD (q50):	0.43 kPa			
5.	FLOOR LIVE LOAD (L):	1.9 kPa			
6.	FLOOR DEAD LOAD (D):	1.0 kPa			
7.	ATTIC LOAD (NO ACCESS/NO STORAGE)	0.5 kPa			

LUMBER NOTES

- ALL SAWN LUMBER TO BE S.P.F. No. 2 GRADE OR BETTER AND CONFORM TO CSA-0141
- ALL ENGINEERED BUILT UP BEAMS ARE TO BE LVL'S (GRADE 2.0x10E4 PSI) UNLESS OTHERWISE
- NOTED. REPLACEMENT WITH A HIGHER GRADE IS NOT ALWAYS A SUITABLE EQUIVALENT. CONTACT ENGINEER FOR EQUIVALENT.
- PROVIDE SOLID BLOCKING BETWEEN JOISTS BELOW ALL LOAD BEARING WALLS/COLUMNS WHICH ARE PERPENDICULAR TO THE JOISTS.
- WOOD IS NOT TO BEAR DIRECTLY ON CONCRETE/MASONRY, PROVIDE PRESSURE TREATED. POLY OR SILL GASKET BETWEEN CONCRETE/MASONRY AND WOOD SILL PLATE.
- ALL JOISTS SHOULD HAVE A MINIMUM OF 40 mm (1-1/2") OF BEARING WITH JOIST HANGARS.
- ALL BUILT UP BEAMS TO PROVIDE 2 ROWS OF SDS SCREWS ON E/S \(\frac{1}{4}\)" x 3-1/2" LG. \(\text{@12}\)" O.C. w/ MINIMUM 3-1/2" OF BEARING.

FOUNDATION NOTES

- ALL FOOTINGS TO BEAR ON NATIVE UNDISTURBED SOIL HAVING A SAFE BEARING CAPACITY OF 3000 P.S.F.
- PROVIDE 4'-0" MINIMUM OF FROST COVER FOR ALL EXTERIOR FOOTINGS.
- ALL REINFORCING STEEL TO BE 400W AND SHALL CONFORM TO CSA-G30.18-M92.
- CONCRETE TO BE MIN. 32 MPa COMPRESSIVE STRENGTH @ 28 DAYS, 5-8% AIR ENTRAINMENT.
- END BEARING ALL WOOD & STEEL BEAMS SHALL HAVE EVEN & LEVEL BEARING & SHALL NOT HAVE LESS THAN 3-1/2" OF BEARING AT END OF SUPPORTS AS PER O.B.C. 9.23.8.1.
- 6. ALL FLOOR JOISTS SHALL HAVE NO LESS THAN 1-1/2"(38mm) IN LENGTH FOR END BEARING EXCEPT WHEN SUPPORTED ON RIBBON BOARDS AS PER O.B.C. 9.23.9.1(1).

STRUCTURAL STEEL NOTES

- STRUCTURAL STEEL DESIGN MUST CONFORM TO CSA S16
- STRUCTURAL STEEL W SECTIONS AND COLUMNS SHALL CONFORM TO ASTM A992 U.O.N.
- STRUCTURAL STEEL CHANNELS, HSS, ANGLES, MUST CONFORM TO CSA G40,21, GRADE 350W U.O.N
- ALL WELDING TO CONFORM TO C.W.B. APPROVED PROCEDURES, ALL WELDING TO BE CARRIED OUT BY WELDERS CERTIFIED BY THE C.W.B., EMPLOYED BY A FIRM CERTIFIED IN DIVISION 1 OR 2
- ALL STRUCTURAL STEEL SHALL RECEIVE A MINIMUM OF ONE COAT OF SHOP PRIMER
- 6. DO NOT SPLICE OR CUT OPENING IN STRUCT. STEEL WITHOUT THE ENGINEERS APPROVAL

CONCRETE & REINFORCING NOTES

- ALL CONCRETE WORK SHALL CONFORM TO THE LATEST REQUIREMENTS OF CSA A23.1, A23.2 & 23.3.
- 2. REINFORCING SHALL CONFORM TO CSA G30.18, GRADE 400W, FY=400MPa
- WELDED WIRE MESH AND WELDED WIRE FABRIC SHALL CONFORM TO CSA G30.5. FY=450MPa & HAVE A MINIMUM LAP OF 150mm (6") AT JOINTS U.O.N.
- 4. ALL REINFORCING LAP SPLICES SHALL CONFORM TO THE LATEST CSA STANDARD A23.3 & ALL BAR SPLICES TO BE CLASS 'B' TENSION U.O.N.
- CRACK CONTROL SHOULD BE PLACED ALONG THE CENTRE OF THE LENGTH AND WIDTH OF
- AREA AND PLACED NO MORE THAN 14'-0" O/C. PROVIDE JOINT FILLER IN CONTROL JOINTS
- ALL CONCRETE COVER SHALL CONFORM TO CSA A23.1 AND THE FOLLOWING BELOW U.O.N. A. CONCRETE CAST AGAINST EARTH: 75mm
 - B. EXTERIOR BEAMS, SLABS, COLUMNS, PIERS AND WALLS: 40mm
 - C. INTERIOR SLABS: 25mm

25 BURLINGTON ST. W **GARAGE CONVERSION**

EXISTING CEILING:



- min. R60 INSULATION TO BE ADDED
- EXISTING 2"x6" CEILING JOISTS
- CONT. SUPER 6 MIL. AIR/VAP BARRIER
- 1" GYPSUM BOARD.

INTERIOR WALL TYPE LEGEND - WALL 'A'



- ½" GYPSUM BOARD - 2"x4" S.P.F. NO. 2 GRADE OR
- BETTER STUDS @ 16" O.C. (U.O.N.)
- ½" GYPSUM BOARD

- 1" GYPSUM BOARD.

EXTERIOR WALL TYPE LEGEND - WALL 'B'



- 6 MIL. CONT. VAPOUR BARRIER
- 2"x4" S.P.F. No. 2 GRADE OR BETTER STUDS @ 16" O.C. (U.O.N.)
- min. R20 SPRAY FOAM CLOSED CELL INSULATION
- 1" AIRGAP FOR SEPARATION (STUDS/BLOCKWALL)
- EXISTING CONCRETE BLOCK WALL

EXTERIOR WALL TYPE LEGEND - WALL 'C'




- 1" GYPSUM BOARD. - 6 MIL. CONT. AIR/VAPOUR BARRIER SEALED
- 2"x6" S.P.F. NO. 2 GRADE OR BETTER STUDS @ 16" O.C. (U.O.N.)
- min. R20 INSULATION
- 1" SPRUCE PLYWOOD SHEATHING c/w AIR/WATER BARRIER AS PER OBC
- BUILDING PAPER
- VINYL SIDING FINISH

EXTERIOR WALL TYPE LEGEND - WALL 'D'



- 1" GYPSUM BOARD. 6 MIL. CONT. VAPOUR BARRIER
- 2"x4" S.P.F. No. 2 GRADE OR BETTER STUDS @ 16" O.C. (U.O.N.) - min. R20 SPRAY FOAM CLOSED CELL INSULATION
- 1" AIRGAP FOR SEPARATION (STUDS/BLOCKWALL) EXISTING CONCRETE BLOCK WALL
- BRICK FACADE

INTERIOR FLOOR MAKEUP/EXISTING FOUNDATION

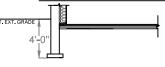

- 1" VINYL FLOORING
- 1" PLYWOOD SUBFLOOR
- min, R10 SLAB INSULATION
- 6mil VAPOUR BARRIER
- EXIST. BLOCK WALL FOUNDATION ON CONC. STRIP FOOTING
 - **GENERAL NOTES** SCALE: NTS



	DEVI	CLONG
#:	DATE:	DESC.
		T

REVISIONS

DECCINC.

DESIGN ENGINEER CONSULT CONSTRUCT

SITE:

25 BURLINGTON ST. W HAMILTON, ONTARIO


PROJECT:


A.D.U. **GARAGE CONVERSION**

DWG:

A0.01 **GENERAL NOTES**

DATE:	DRAWN BY:	DWG #:
JULY 1, 2023	MT	
PROJECT #:	CHKD BY:	1 / 10
102	MP	

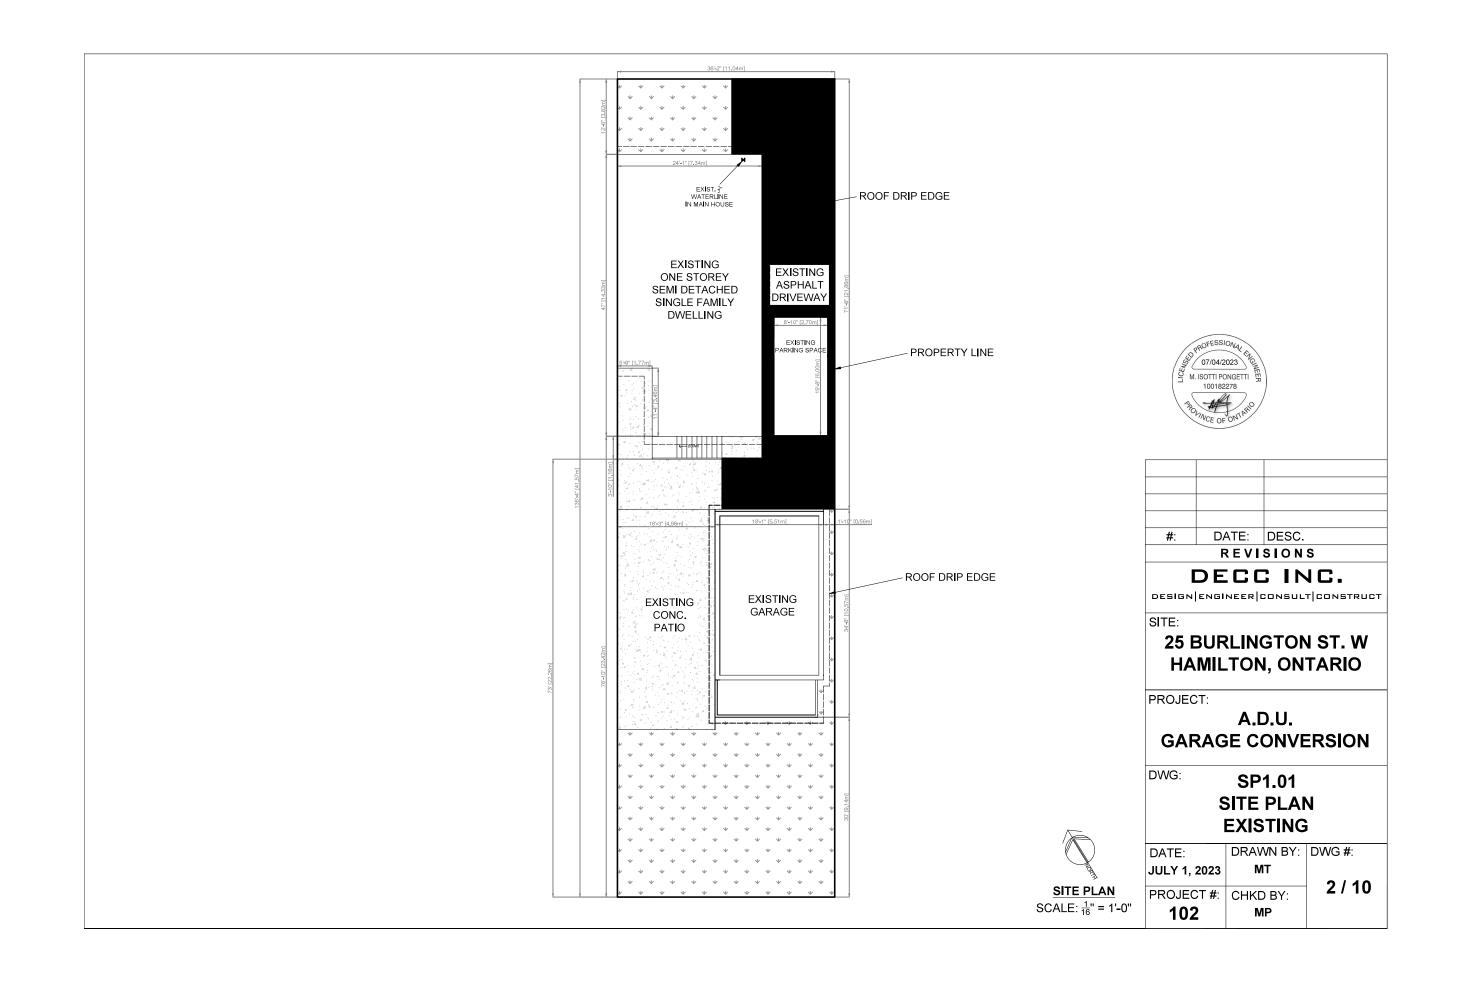

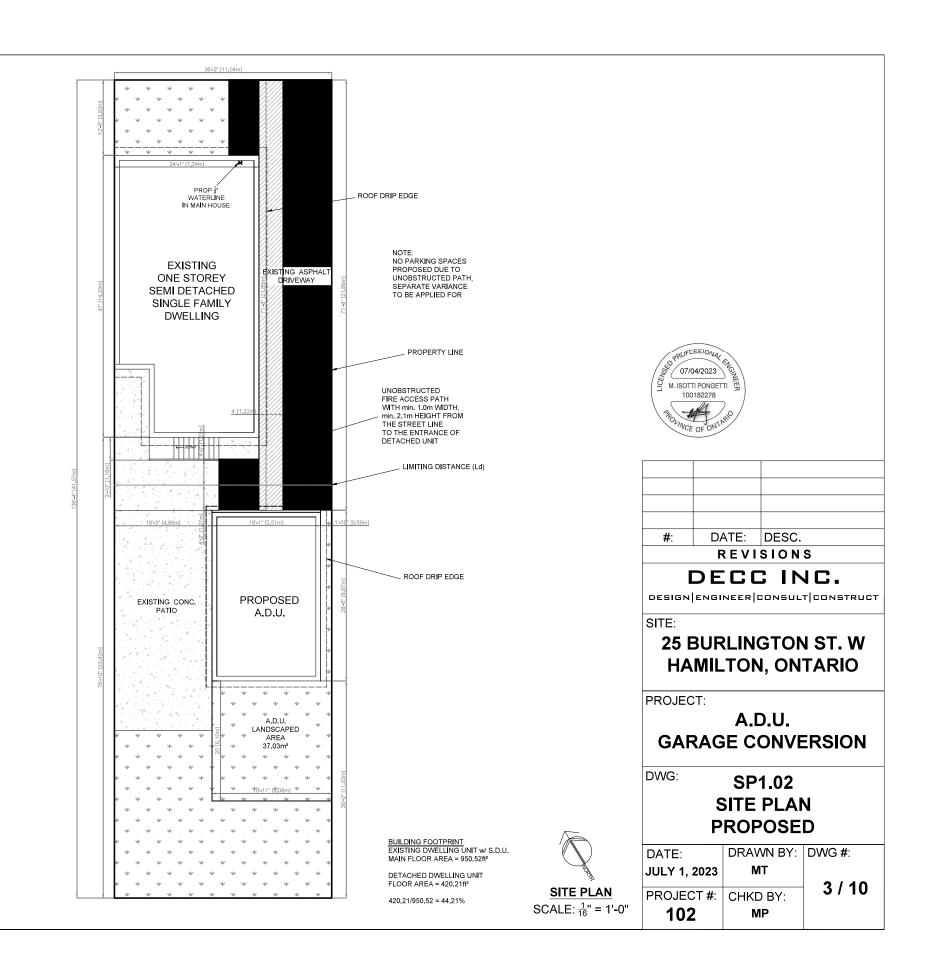

SPATIAL SEPARATION ANALYSIS

NORTH SIDE OF PROPOSED BUILDING
- LIMITING DISTANCE (Ld) = 4"-2" = 1.27m²
- AREA OF BUILDING FACE = 208,35ñ² = 19,36m²
- TABLE 9.10.14.4. USING INTERPOLATION
- ALLOWABLE PERCENTAGE OF UNPROT. OPENING

- ALLOWABLE PERCENT AGE OF UNPROT. OPE - 8.47% - AREA OF ALLOWABLE UNPROT. OPENINGS - 19.36m* x 0.0847 = 1.64m* - BUILDING UNPROTECTED OPENING AREA D1 = 17.338* = 1.61m* W3 = NM (GLASS BLOCK) TOTAL =1.61m² < 1.84m²

- THEREFORE PROPOSED BUILDING OPENINGS CONFORM TO TABLE 9.10.14.4.

WEST SIDE OF PROPOSED BUILDING
- LIMITING DISTANCE (Ld) = 16'-3" = 4.96m²
- AREA OF BUILDING FACE = 212.58ft² = 19.75m²
- TABLE 9.10,14.4
- ALLOWABLE PERCENTAGE OF UNPROT. OPENINGS

= 53% - AREA OF ALLOWABLE UNPROT. OPEN**I**NGS

- AREA OF ALLOWABLE UNPROT, OPENINGS = 19,75m² v, 0,53 = 10,47m² - BUILDING UNPROTECTED OPENING AREA W1 = 6.81m² = 0.63m² W4 = 8,0m² = 0,74m² TOTAL =1,37m² < 10,47m²

- THEREFORE PROPOSED BUILDING OPENINGS CONFORM TO TABLE 9.10.14.4.

NOT REQUÍRED, NO PROPOSED OPENÍNGS

SOUTH SIDE OF PROPOSED BUILDING
- LIMITING DISTANCE (Ld) = 36'-2" = 11.03m² - LIMITING DISTANCE (Ld) = 36°2" = 11.03m²
- AREA OF BUILDING FACE = 195.47t² = 18.16m²
- TABLE 9.10.14.4.
- ALLOWABLE PERCENTAGE OF UNPROT. OPENING
- AREA OF ALLOWABLE UNPROT. OPENINGS
= 18.16m² × 1.00 = 18.16m²
- BUILDING UNPROTECTED OPENING AREA
W2 = 6.81t² = 0.63m²


TOTAL =18.16m² < 0.63m²

- THEREFORE PROPOSED BUILDING OPENINGS CONFORM TO TABLE 9.10.14.4.

EXISTING FLOOR PLAN DIMENSIONS/CONFIGURATION AREA APPROXIMATE

GARAGE AREA: +/- 452.36 ft²

WINDOW/DOOR SCHEDULE			
NO.	WIDTH	HEIGHT	
D1	143"	90"	
D2	33"	81"	
D3	30"	78"	
W1	35"	28"	
W2	35"	28"	

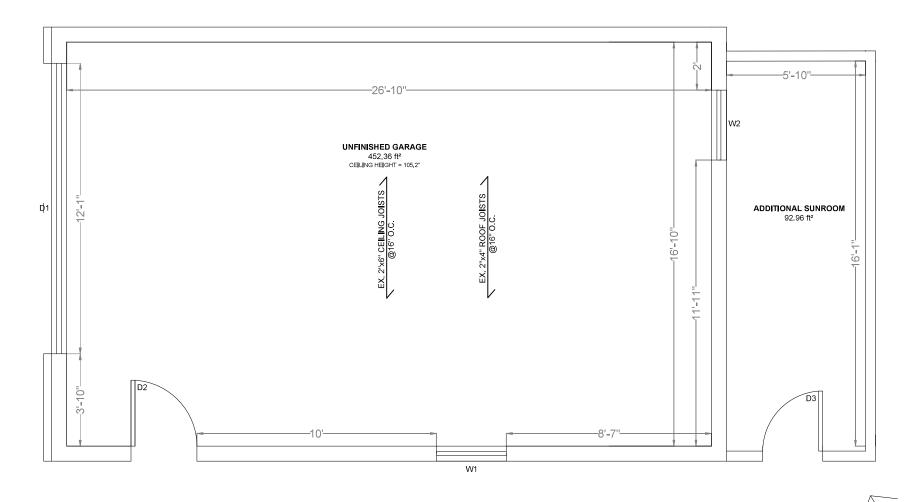



#:	DATE:	DESC.	
REVISIONS			

DECC INC.

DESIGN ENGINEER CONSULT CONSTRUCT

SITE:

25 BURLINGTON ST. W HAMILTON, ONT.

PROJECT:

A.D.U. **GARAGE CONVERSION**

DWG:


A1.01 **FLOOR PLAN EXISTING**

	DATE:	DRAWN BY:	DWG #:
	JULY 1, 2023	МТ	
FLOOR PLAN	PROJECT #:	CHKD BY:	4 / 10
SCALE: ¹ / ₄ " = 1'-0"	102	MP	

EXISTING FLOOR PLAN DIMENSIONS/CONFIGURATION AREA APPROXIMATE

GARAGE AREA: +/- 452.36 ft²

WINDOW/DOOR SCHEDULE				
NO.	WIDTH	HEIGHT		
D1////	143"///	90"///		
D2////	33"///	81"///		
D3////	30"///	78"///		
W1	35"	28"		
W2	35"	28"		

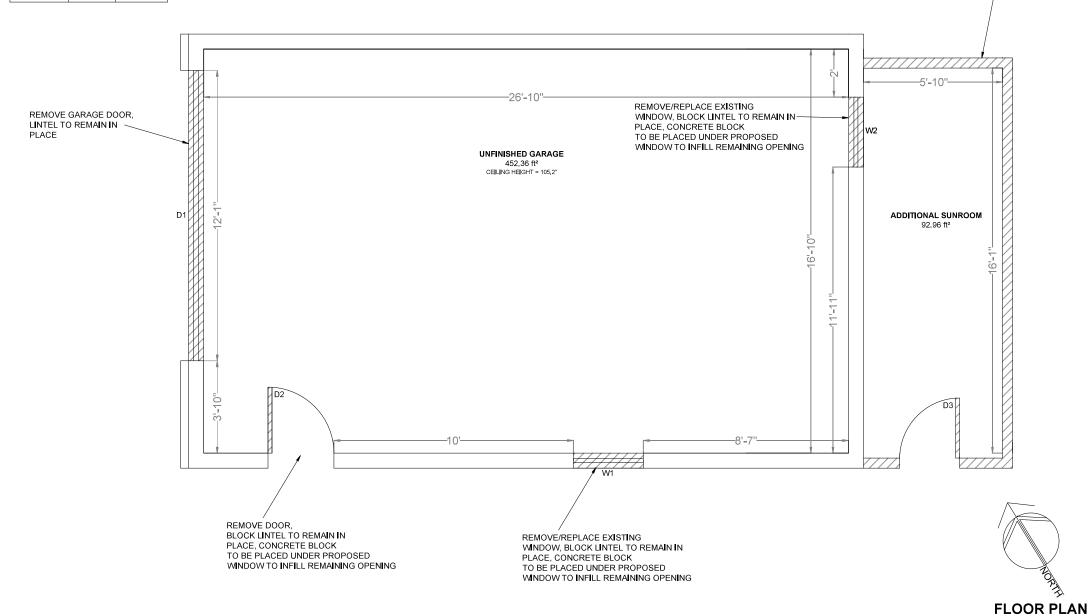



EXISTING SUNROOM ADDITION TO BE REMOVED

#:	DATE:	DESC.	
REVISIONS			

DECC INC.

DESIGN ENGINEER CONSULT CONSTRUCT

SITE:

25 BURLINGTON ST. W HAMILTON, ONT.

PROJECT:

A.D.U.
GARAGE CONVERSION

DWG:

A1.02 FLOOR PLAN REMOVALS

	DATE:	DRAWN BY:	DWG #:
	JULY 1, 2023	MT	
FLOOR PLAN	PROJECT #:	CHKD BY:	5 / 10
SCALE: ½" = 1'-0"	102	MP	

EXISTING FLOOR PLAN DIMENSIONS/CONFIGURATION AREA APPROXIMATE

> FLOOR AREA: +/- 420.14 ft²


LEGEND

© CARBON MONOXIDE ALARMS REQUIRED ADJACENT TO BEDROOMS ON EACH LEVEL AND COMPLY w/ O.B.C 9.33.4

SA SMOKE ALARM

ALL SMOKE DETECTORS TO BE INTER-CONNECTED AND COMPLY W/ O.B.C. 9.10.19

WINDOW/DOOR SCHEDULE			
NO.	WIDTH	HEIGHT	
D1- GLZD	32"	78"	
D2	24"	78"	
D3	24"	78"	
D4 - DBL	24"	78"	
D5	26"	78"	
D6	30"	78"	
D7	26"	78"	
W1	35"	28"	
W2	35"	28"	
W3	48"	36"	
W4	32"	36"	

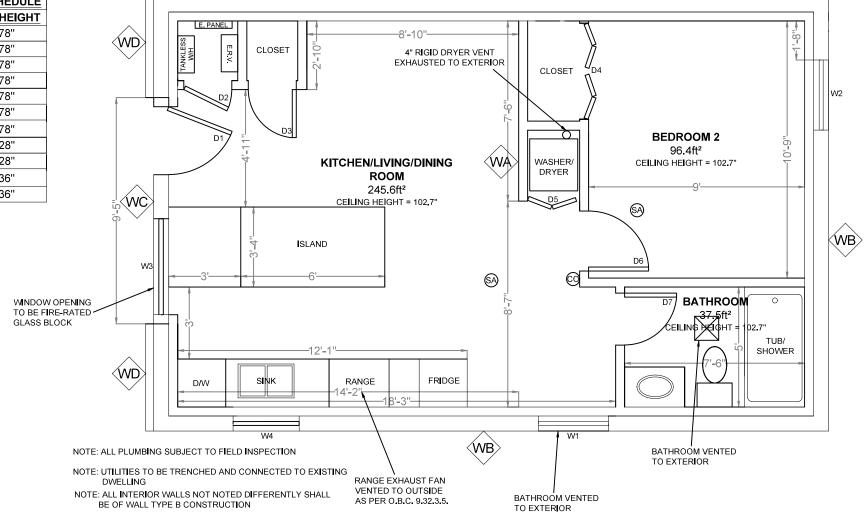

(WB)

NATURAL LIGHT - GLASS AREA REQUIREMENTS (O.B.C. 9.7.2.3.)						
ROOM	AREA OF WIN. PROVIDED					
LIVING/KITCHEN/ DINING ROOM	245.6ft²	10% = 24.56ft²	W1 - 32"x24" = 5.33ft ² W3 - 44"x32" = 9.78ft ² W4 - 26"x 32" = 6.22ft ² D1 - 20"x66" = 9.17ft ² TOTAL = 30.5ft ²			
BEDROOM	96.4ft²	5% = 4.82ft²	W2 - 32"x24" = 5.33ft ²			



#:	DATE:	DESC.	
REVISIONS			

DECC INC.

DESIGN ENGINEER CONSULT CONSTRUCT

SITE:

25 BURLINGTON ST. W HAMILTON, ONT.


PROJECT:


A.D.U. **GARAGE CONVERSION**

DWG:

A1.03 **FLOOR PLAN PROPOSED**

	DATE:	DRAWN BY:	DWG #:
TO TO THE TOTAL PROPERTY OF THE TOTAL PROPER	JULY 1, 2023	MT	
FLOOR PLAN	PROJECT #:	CHKD BY:	6 / 10
SCALE: 1/4" = 1'-0"	102	MP	

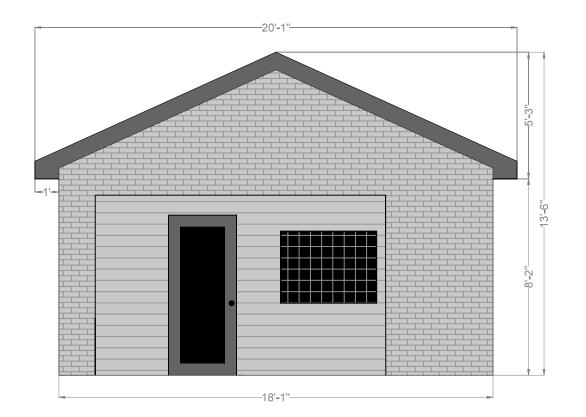

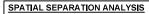

NORTH SIDE OF PROPOSED BUILDING

- LIMITING DISTANCE (Ld) = 44.2"= 1.27m²

- AREA OF BUILDING FACE = 208,35ft² = 19,36m²

- TABLE 9.10.14.4. USING INTERPOLATION

- ALLOWABLE PERCENTAGE OF UNPROT. OPENINGS

= 8.47% = AREA OF ALLOWABLE UNPROT. OPENINGS

- AREA OF ALLOWABLE UNPROT. OPENINGS = 19.36m² x 0.0847 = 1.64m² - BUILDING UNPROTECTED OPENING AREA D1 = 17.33ft² = 1.61m² W3 = N/A (GLASS BLOCK) TOTAL =1.61m² < 1.64m²

- THEREFORE PROPOSED BUILDING OPENINGS CONFORM TO TABLE 9.10.14.4.



#:	DATE:	DESC.		
REVISIONS				

DECC INC.

DESIGN|ENGINEER|CONSULT|CONSTRUCT

SITE:

25 BURLINGTON ST. W HAMILTON, ONT.

PROJECT:


A.D.U. **GARAGE CONVERSION**

DWG:

A2.01 **NORTH ELEVATION PLAN PROPOSED**

DATE:	DRAWN BY:	DWG #:
JULY 1, 2023	MT	
PROJECT #:	CHKD BA:	7 / 10
TROSLOT#.	CIRD DI.	
102	MP	

FLOOR PLAN SCALE: \frac{1}{4}" = 1'-0"

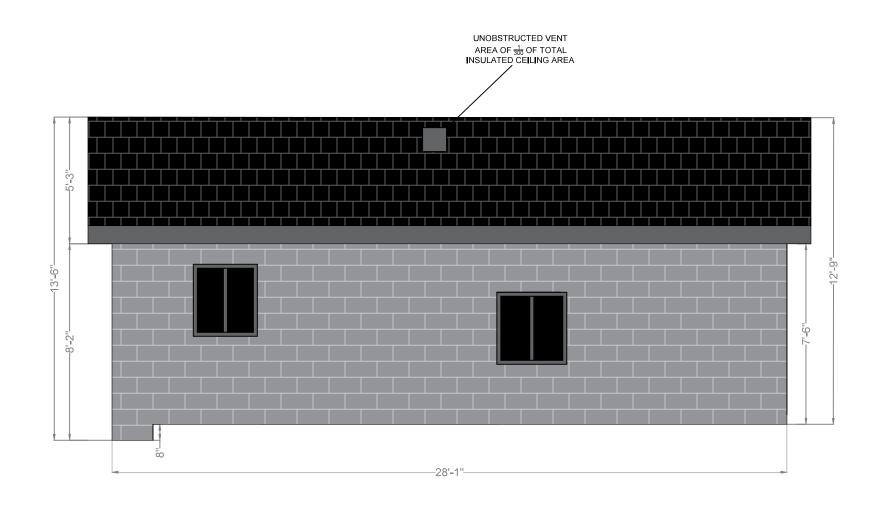

SPATIAL SEPARATION ANALYSIS

WEST SIDE OF PROPOSED BUILDING
- LIMITING DISTANCE (Ld) = 16'-3"= 4.96m²
- AREA OF BUILDING FACE = 212.58ft² = 19.75m²
- TABLE 9.10.14.4.

ALLOWABLE PERCENTAGE OF UNPROT. OPENINGS

- AREA OF ALLOWABLE UNPROT. OPE - 53% - AREA OF ALLOWABLE UNPROT. OPENINGS = 19,75m² x 0.53= 10.47m² - BUILDING UNPROTECTED OPENING AREA W1 = 6,81f² = 0,63m² W4 = 0.08² = 0.71 ° 2

W4 = 8.0ft² = 0.74m² TOTAL =1.37m² < 10.47m²

- THEREFORE PROPOSED BUILDING OPENINGS CONFORM TO TABLE 9.10.14.4.



#:	DATE:	DESC.	
REVISIONS			

DECC INC.

DESIGN ENGINEER CONSULT CONSTRUCT

SITE:

25 BURLINGTON ST. W HAMILTON, ONT.

PROJECT:


A.D.U. **GARAGE CONVERSION**

A2.02

WEST ELEVATION PLAN PROPOSED

DRAWN BY:	DWG #:
MT	
	8 / 10
CHKD BY:	0,10
MP	
	MT CHKD BY:

FLOOR PLAN SCALE: \frac{1}{4}" = 1'-0"

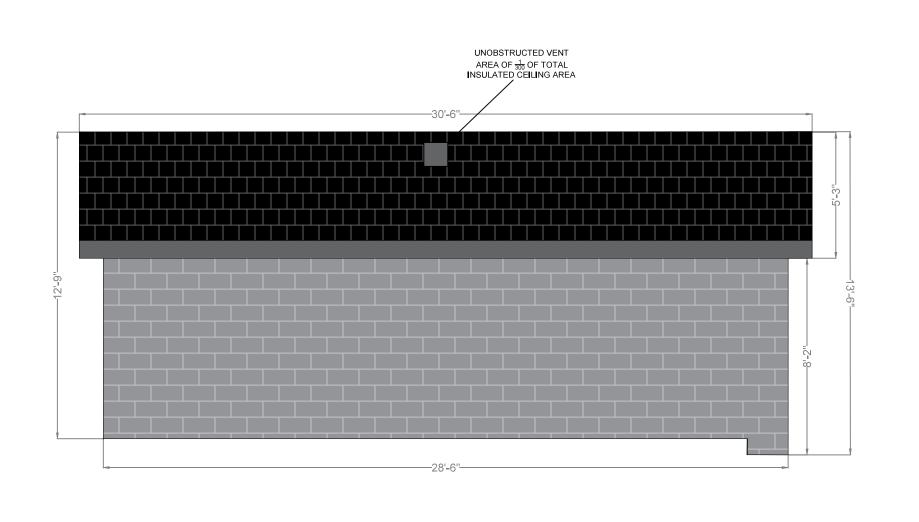



#: DATE: DESC.	REVISIONS				
	#:	DATE:	DESC.		

DECC INC.

DESIGN|ENGINEER|CONSULT|CONSTRUCT

SITE:

25 BURLINGTON ST. W HAMILTON, ONT.

PROJECT:

A.D.U. **GARAGE CONVERSION**

DWG:

SCALE: \frac{1}{4}" = 1'-0"

A2.03


EAST ELEVATION PLAN PROPOSED

	DATE:	DRAWN BY:	DWG #:
	JULY 1, 2023	MT	
			9 / 10
ELEVATION PLAN	PROJECT #:	CHKD BY:	9/10
SCALE: ¹ / ₄ " = 1'-0"	102	MP	

SPATIAL SEPARATION ANALYSIS

EAST SIDE OF PROPOSED BUILDING

NOT REQUIRED, NO PROPOSED OPENINGS

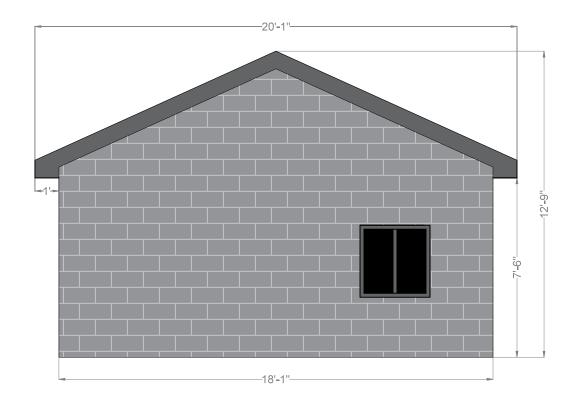

SPATIAL SEPARATION ANALYSIS

- SOUTH SIDE OF PROPOSED BUILDING
 LIMITING DISTANCE (Ld) = 36'-2" = 11.03m²
 AREA OF BUILDING FACE = 195.47ft² = 18.16m²
- TABLE 9.10.14.4.
- TABLE 9.10.14.4.
 ALLOWABLE PERCENTAGE OF UNPROT. OPENINGS
 = 100%
 AREA OF ALLOWABLE UNPROT. OPENINGS
 = 18.16m² x 1.00 = 18.16m²
 BUILDING UNPROTECTED OPENING AREA
 W2 = 6.81ft ² = 0.63m²
 TOTAL =18.16m² < 0.63m²

- THEREFORE PROPOSED BUILDING OPENINGS CONFORM TO TABLE 9.10.14.4.



7	# :	DATE:	DESC.		
	REVISIONS				

DECC INC.

DESIGN ENGINEER CONSULT CONSTRUCT

SITE:

25 BURLINGTON ST. W HAMILTON, ONT.

PROJECT:

A.D.U. **GARAGE CONVERSION**

A2.04

SOUTH ELEVATION PLAN **PROPOSED**

DATE:	DRAWN BY:	DWG #:
JULY 1, 2023	MT	
		10 / 10
PROJECT #:	CHKD BY:	10710
102	MP	
102		

FLOOR PLAN SCALE: \frac{1}{4}" = 1'-0"



Committee of Adjustment City Hall, 5th Floor,

71 Main St. W., Hamilton, ON L8P4Y5

Phone: (905) 546-2424 ext. 4221

Email: cofa@hamilton.ca

APPLICATION FOR A MINOR VARIANCE/PERMISSION

UNDER SECTION 45 OF THE PLANNING ACT

1. APPLICANT INFORMATION

	NAME	MI AII IN	G ADDRESS	T	
Registered Owners(s)	NAME	MAILIN	G ADDRESS		
Applicant(s)					
Agent or Solicitor					
1.2 All correspondence	ce should be sent to	☐ Purchas ☑ Applicar	-	☐ Owner ☑ Agent/Sol	icitor
1.3 Sign should be se	ent to	☐ Purchas ☑ Applicar		☐ Owner ☑ AgentSolid	citor
I.4 Request for digital If YES, provide el	ıl copy of sign mail address where sig	☑ Yes* gn is to be se	□ No		
1.5 All correspondence	ce may be sent by ema	ail	✓ Yes*	□No	
(if applicable). Or	ail must be included fo nly one email address s s not guarantee all cor	submitted wil	I result in the v	oiding of this s	

2. LOCATION OF SUBJECT LAND

2.1 Complete the applicable sections:

Municipal Address	25 BURLINGTON ST	. WEST		
Assessment Roll Number				
Former Municipality	HAMILTON			
Lot		Concession		
Registered Plan Number		Lot(s)		
Reference Plan Number (s)		Part(s)		
2.2 Are there any easements or restrictive covenants affecting the subject land? ☐ Yes ☑ No If YES, describe the easement or covenant and its effect:				
3. PURPOSE OF THE APPI	LICATION			
Additional sheets can be submitted if there is not sufficient room to answer the following questions. Additional sheets must be clearly labelled				
All dimensions in the application form are to be provided in metric units (millimetres, metres, hectares, etc.)				
3.1 Nature and extent of reli	ef applied for:			
TO PERMIT NO PARKING SPACES FOR THE DWELLINGS IN ORDER TO MEET THE UNOBSTRUCTED FIRE ACCESS PATH REQUIRED FOR AN A.D.U.				
Second Dwelling Uni	t Reconstr	ruction of Existing Dwellin	g	
3.2 Why it is not possible to	comply with the provisi	ons of the By-law?		
DRIVEWAY WIDTH WILL FIRE ACCESS PATH	. NOT ALLOW PARKIN	IG SPACES AND THE U	NOBSTRUCTED	
3.3 Is this an application 45(2) of the Planning Act. ☐ Yes	☑ No		
If yes, please provide an	explanation:			
4. DESCRIPTION OF SUBJ	ECT LAND AND SER	VICING INFORMATION		
4.1 Dimensions of Subject L	ands:			

Lot Frontage	Lot Depth	Lot Area	Width of Street
11.04m	41.57m	458.91m2	

	buildings and structur ice from side, rear and		r the subject lands:	
Existing:				
Type of Structure	Front Yard Setback	Rear Yard Setback	Side Yard Setbacks	Date of Construction
SINGLE FAMILY DWELLING	1.677m	23.42m	3.69m/0m	02/08/1970
REAR STEPS	14.33m	22.26m	1.77m/3.69m	02/08/1970
GARAGE	21.86m	9.24m	4.96m/0.56m	03/01/1990
Proposed:		<u> </u>		
Type of Structure	Front Yard Setback	Rear Yard Setback	Side Yard Setbacks	Date of Construction
A.D.U.	21.86m	11.14m	4.96m/0.56m	03/01/1990
sheets if neces Existing: Type of Structure	Ground Floor Area	Gross Floor Area	Number of Storeys	Height
SINGLE FAMILY DWELLING	99.06m2	198.12m2	1	7.9 m
GARAGE	57.11m2	57.11m2	1	4.12m
Proposed:				
Type of Structure	Ground Floor Area	Gross Floor Area	Number of Storeys	Height
A.D.U.	47.25m2	47.25m2	1	4.12m
☑ publicly ow ☐ privately ov 4.5 Type of storm	supply: (check appropined and operated pipersed and operated in drainage: (check approped and operated stope	ped water system adividual well propriate boxes)	☐ lake or other ☐ other means ☐ ditches ☐ other means	s (specify)

4.6	Type of sewage disposal proposed: (check appropriate box)
	□ publicly owned and operated sanitary sewage □ system privately owned and operated individual □ sential system other magns (specify)
4.7	 ☐ septic system other means (specify) ☐ Type of access: (check appropriate box) ☐ provincial highway ☐ municipal road, seasonally maintained ☐ municipal road, maintained all year
4.8	Proposed use(s) of the subject property (single detached dwelling duplex, retail, factory etc.):
	SEMI DETACHED SINGLE FAMILY DWELLING w/ DETACHED ADDITIONAL DWELLING UNIT
4.9	Existing uses of abutting properties (single detached dwelling duplex, retail, factory etc.):
	SINGLE FAMILY DWELLINGS
7	HISTORY OF THE SUBJECT LAND
7.1	Date of acquisition of subject lands:
7.2	Previous use(s) of the subject property: (single detached dwelling duplex, retail, factory etc) SEMI DETACHED SINGLE FAMILY DWELLING
7.3	Existing use(s) of the subject property: (single detached dwelling duplex, retail, factory etc) SEMI DETACHED SINGLE FAMILY DWELLING
7.4	Length of time the existing uses of the subject property have continued: PROPERTIES EXISTANCE
7.5	What is the existing official plan designation of the subject land?
	Rural Hamilton Official Plan designation (if applicable):
	Rural Settlement Area:
	Urban Hamilton Official Plan designation (if applicable)
	Please provide an explanation of how the application conforms with the Official Plan.
7.6	What is the existing zoning of the subject land?
7.8	Has the owner previously applied for relief in respect of the subject property? (Zoning By-lawAmendment or Minor Variance) ☐ Yes
	If yes, please provide the file number:

7.9	Is the subject property the subject Planning Act?	t of a current appl ☐ Yes	ication for consent under Section 53 of the ☑ No
	If yes, please provide the file num	nber:	. The state of the
7.10	If a site-specific Zoning By-law Ar two-year anniversary of the by-law		en received for the subject property, has the priced?
		☐ Yes	□No
7.11		allowed must be ir	ctor of Planning and Chief Planner that the ncluded. Failure to do so may result in an
8	ADDITIONAL INFORMATION		
8.1	Number of Dwelling Units Existing	g: <u>1</u>	_
8.2	Number of Dwelling Units Propos	ed: <u>2</u>	_
8.3	Additional Information (please inc	lude separate she	eet if needed):

11 COMPLETE APPLICATION REQUIREMENTS All Applications 11.1 ✓ Application Fee ✓ Site Sketch ✓ Complete Application form ✓ Signatures Sheet 11.4 Other Information Deemed Necessary Cover Letter/Planning Justification Report Authorization from Council or Director of Planning and Chief Planner to submit application for Minor Variance ☐ Minimum Distance Separation Formulae (data sheet available upon request) ☐ Hydrogeological Assessment Septic Assessment Archeological Assessment Noise Study ☐ Parking Study