



City Hall, 5th floor, 71 Main Street West, Hamilton, ON L8P 4Y5
Telephone (905) 546-2424, ext. 4221

E-mail: cofa@hamilton.ca

NOTICE OF PUBLIC HEARING Minor Variance

You are receiving this notice because you are either:

- Assessed owner of a property located within 60 metres of the subject property
- Applicant/agent on file, or
- Person likely to be interested in this application

APPLICATION	HM/A-24:27	SUBJECT	2 ERIC BURKE COURT,
NO.:		PROPERTY:	HAMILTON
ZONE:	R1 (Low Density Residential)	ZONING BY-	Zoning By-law City of Hamilton 05-
		LAW:	200, as Amended

APPLICANTS: Owner: RANDY AND AMANDA VIEIRA

Applicant: QUI NGUYEN

The following variances are requested:

1. To permit a maximum required yard encroachment of 1.8 metres for the proposed rear yard covered porch instead of the required maximum yard encroachment of 1.5 metres for a porch.

PURPOSE & EFFECT: To facilitate the construction of a rear yard covered porch.

Notes:

This Notice must be posted by the owner of any land which contains seven or more residential units so that it is visible to all residents.

This application will be heard by the Committee as shown below:

DATE:	Tuesday, March 26th, 2024	
TIME:	10:35 a.m.	
PLACE:	City Hall Council Chambers (71 Main St. W., Hamilton)	

For more information on this matter, including access to drawings illustrating this request and other information submitted:

- Visit www.hamilton.ca/committeeofadjustment
- Visit Committee of Adjustment staff at 5th floor City Hall, 71 Main St. W., Hamilton

PUBLIC INPUT

Written: If you would like to submit written comments to the Committee of Adjustment you may do so via email or hardcopy. Comments can be submitted by emailing cofa@hamilton.ca or by mailing the

Committee of Adjustment, City of Hamilton, 71 Main Street West, 5th Floor, Hamilton, Ontario, L8P 4Y5. Written comments must be received no later than noon March 22, 2024.

Comments are available the Friday prior to the Hearing and are available on our website: www.hamilton.ca/committeeofadjustment

Orally: If you would like to speak to this item at the hearing you may do so by attending in person. Interested members of the public, agents, and owners who wish to participate in person may attend Council Chambers on the date and time listed on the Notice of Public Hearing. Please note, you will be required to provide your name and address for the record. It is advised that you arrive no less than 10 minutes before the time of the Public Hearing as noted on the Notice of Public Hearing. We hope this is of assistance and if you need clarification or have any questions, please email cofa@hamilton.ca

FURTHER NOTIFICATION

If you wish to be notified of future Public Hearings, if applicable, you must submit a written request to cofa@hamilton.ca or by mailing the Committee of Adjustment, City of Hamilton, 71 Main Street West, 5th Floor, Hamilton, Ontario, L8P 4Y5.

If you wish to be provided a Notice of Decision, you must attend the Public Hearing and file a written request with the Secretary-Treasurer by emailing cofa@hamilton.ca or by mailing the Committee of Adjustment, City of Hamilton, 71 Main Street West, 5th Floor, Hamilton, Ontario, L8P 4Y5..



Subject Lands

DATED: March 12, 2024

Jamila Sheffield, Secretary-Treasurer Committee of Adjustment Information respecting this application is being collected under the authority of the Planning Act, R.S.O., 1990, c. P. 13. All comments and opinions submitted to the City of Hamilton on this matter, including the name, address, and contact information of persons submitting comments and/or opinions, will become part of the public record and will be made available to the Applicant and the general public, and may include posting electronic versions.



COMMITTEE OF ADJUSTMENT

City Hall, 5th floor, 71 Main Street West, Hamilton, ON L8P 4Y5

Telephone (905) 546-2424, ext. 4221

E-mail: cofa@hamilton.ca

IN-PERSON PARTICIPATION PROCEDURES

Written Submissions

Members of the public who would like to participate in a Committee of Adjustment meeting are able to provide comments in writing advance of the meeting. Comments can be submitted by emailing cofa@hamilton.ca or by mailing the Committee of Adjustment, City of Hamilton, 71 Main Street West, 5th Floor, Hamilton, Ontario, L8P 4Y5. Comments must be received by noon on the date listed on the Notice of Public Hearing.

Comments are available the Friday prior to the Hearing and are available on our website: www.hamilton.ca/committeeofadjustment

Oral Submissions

Members of the public are also able to provide oral comments regarding Committee of Adjustment Hearing items by participating in person at the Hearing.

In person Oral Submissions

Interested members of the public, agents, and owners who wish to participate in person may attend Council Chambers on the date and time listed on the Notice of Public Hearing. Please note, you will be required to provide your name and address for the record. It is advised that you arrive **no less than 10 minutes** before the time of the Public Hearing as noted on the Notice of Public Hearing.

We hope this is of assistance and if you need clarification or have any questions, please email cofa@hamilton.ca or by phone at 905-546-2424 ext. 4221.

DESIGN LOADING:

ROOF LOAD: HAMILTON (ABOVE ESCARPMENT-EAST OF JOHN C. MUNRO INT'L AIRPORT)

TYP. ROOF DEAD LOAD

= 20psf


Ss Sr e = 31psf = 9psf = 28psf

EXISTING FLOOR PLAN DIMENSIONS/ CONFIGURATION IS APPROXIMATE

SITE IS CLASSIFIED AS 'R1' ZONE AS PER CITY OF HAMILTON ZONING BY LAW NO. 05-200

ALL SITE PLAN DIMENSIONS/INFORMATION BASED ON SITE REVIEW

EXISTING FRAMING SHOWN IS ASSUMED BASED ON SITE REVIEW.
CONTRACTOR TO EXPOSE EXISTING STRUCTURE AND REPORT ANY
DISCREPANCIES TO THE ENGINEER.

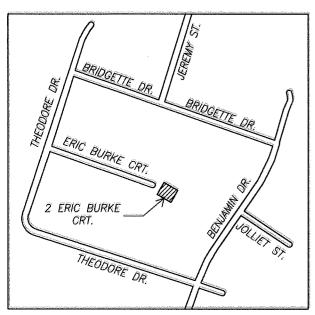






THE CITY OF HAMILTON ZONING BY-LAW 05-200: SECTION 15 RESIDENTIAL ZONES(R1): SECTION 4. GENERAL PROVISIONS, 4.8.1 BUILDINGS ACCESSORY TO RESIDENTIAL USES

ZONE REGULATION				
	PERMITTED USES UNDER ZONING BY-LAW	EXISTING	PROPOSED	
ZONING DESIGNATION	SINGLE DETACHED DWELLING	Ŕŧ	Ř1	
MAX LOT COVERAGE	57%	23.8%	29.3%	
MIN LOT AREA	360 m²	634.8m²	634.8m²	
MIN FRONT YARD	6 m	6.18m	6.18m °	
MIN REAR YARD SETBACK	7.5 m	10.76m	6m	
MIN INTERIOR SIDE SETBACK	1.2 m	1.26m	7.97m	
EXISTING BUILDING	N/A	151.8m²	186.13m²	

THE CITY OF HAMILTON ZONING BY-LAW 05-200: SECTION 4. GENERAL PROVISIONS, 4.6 PERMITTED YARD ENCROACHMENTS

ZONING BY-LAW 05-200; 4.6 PERMITTED YARD ENCROACHMENTS: A PORCH, DECK OR CANOPY MAY ENCROACH INTO ANY REQUIRED YARD TO A MAXIMUM OF 1.5 METERS, OR TO A MAXIMUM OF HALF THE DISTANCE OF THE REQUIRED YARD, WHICHEVER IS THE LESSER;

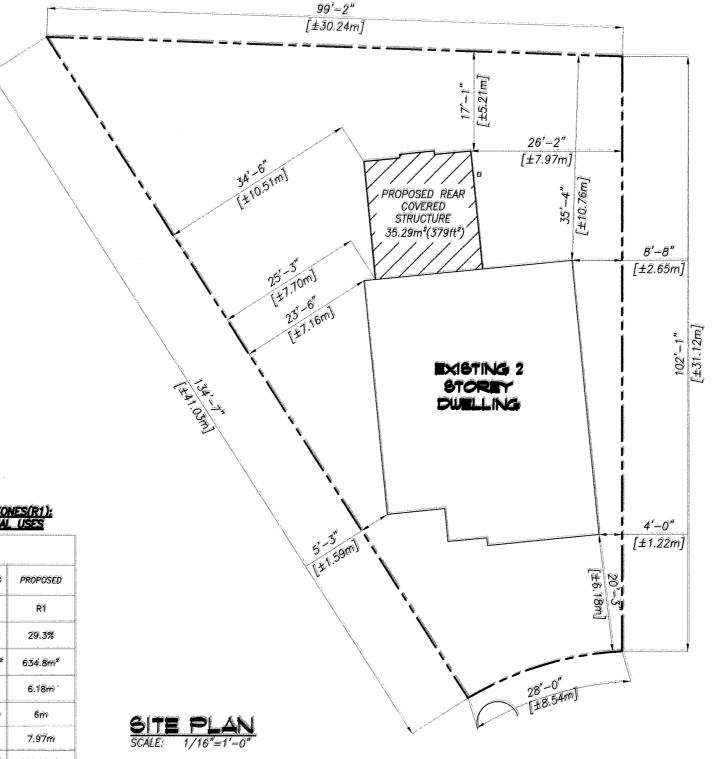





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REAR COVERED PORCH

2 ERIC BURKE CRT.

HAMILTON

ONTARIO

GENERAL NOTES

DATE	DRAWN BY	DRAWING No.
JANUARY 2024		
PROJECT No.	CHECKED BY	13P1.U1
23165	J.P.	

GENERAL NOTES

- 1. CHECK ALL DIMENSIONS ON THESE DRAWINGS WITH ALL OTHER DRAWINGS, INCLUDING BUT NOT LIMITED TO DRAWINGS PREPARED ARCHITECTURAL, MECHANICAL OR ELECTRICAL CONSULTANTS. REPORT ANY INCONSISTENCIES TO THE ENGINEER PRIOR TO COMMENCING WITH THE WORK. DO NOT SCALE THE DRAWINGS.
- THE DESIGN LIVE LOADS ARE INDICATED ON THE DRAWINGS. CONSTRUCTION LOADS SHALL NOT EXCEED THE DESIGN LOADS.
- 3. THE COMPLETED STRUCTURE IS SHOWN ON THE DRAWINGS. THE CONTRACTOR SHALL PROVIDE ALL TEMPORARY BRACING, SHORING AND ANY OTHER TEMPORARY OR PERMANENT MEASURES AS REQUIRED DURING CONSTRUCTION. THE CONTRACTOR SHALL PROVIDE ALL TEMPORARY SUPPORT OF EXISTING OR ADJACENT STRUCTURES AS REQUIRED. ALL BRACING AND SHORING IS THE RESPONSIBILITY OF THE CONTRACTOR.
- CONSTRUCTION FEATURES NOT FULLY SHOWN ARE COMPARABLE TO SIMILAR CONDITION DETAILS.
- REFER TO OTHER CONSULTANTS DRAWINGS FOR DETAILS OF OPENINGS, PITS, CHAMFERS, DEPRESSIONS NOT INDICATED ON THE STRUCTURAL DRAWINGS.
- ALL CONSTRUCTION SHALL BE IN CONFORMANCE WITH THE LATEST ONTARIO BUILDING CODE, LATEST APPLICABLE REGULATIONS AND GOOD CONSTRUCTION PRACTICES.
- 7. THE STRUCTURAL DRAWINGS SHALL BE READ IN CONJUNCTION WITH ALL OTHER CONTRACT DRAWINGS AND SPECIFICATIONS.
- 8. CLARIFY ANY QUERIES WITH THE ENGINEER REGARDING THE INTERPRETATION OF THE DRAWINGS, PRIOR TO THE COMMENCEMENT OF ANY WORK.

TIMBER FRAMING

- 1. ALL DESIGN AND CONSTRUCTION SHALL BE CARRIED OUT IN CONFORMANCE WITH CSA STANDARD 086.
- 2. SAWN LUMBER SHALL BE SPRUCE/PINE/FIR GRADE NUMBER 1 AND GRADE NUMBER 2 IN THE RATIO OF 67% (MINIMUM) AND 33% (MAXIMUM) RESPECTIVELY.
- PROVIDE STEEL JOIST HANGERS AS SHOWN ON THE PLAN.
 FASTENING SHALL BE CARRIED OUT IN ACCORDANCE WITH THE
 MANUFACTURER'S SPECIFICATIONS. EACH HANGER SHALL BE
 CAPABLE OF SUPPORTING 80016s.
- 4. LAMINATED VENEER LUMBER (LVL) SHALL BE MANUFACTURED WITH SOUTHERN YELLOW PINE OR DOUGLAS FIR VENEERS PROVIDING A MINIMUM FLEXURAL STRESS RESISTANCE (FB) OF 2600 PSI (BASED ON 12" DEEP SECTION). THE MODULUS OF ELASTICITY SHALL BE 2.0X10° PSI MINIMUM. FASTENING OF MULTIPLE PLY BEAMS SHALL BE IN ACCORDANCE WITH THE MANUFACTURERS SPECIFICATIONS.
- 5. ALL HEAVY TIMBER SHALL BE GRADE EASTERN WHITE PINE No.2
- 6. PROVIDE MOISTURE BARRIER AROUND ALL WOOD MEMBERS IN DIRECT CONTACT WITH CONCRETE OR BLOCK. CONTINUOUS MOISTURE BARRIER IS REQUIRED AT POINTS OF CONTACT.
- 7. PROVIDE 6"x6" SUPPORT POST UNDER EACH END OF ALL TIMBER BEAMS UNLESS OTHERWISE NOTED
- 8. ALL TIMBER EXPOSED TO EXTERIOR SHALL BE PRESSURE TREATED

CONCRETE NOTES

- ALL STRUCTURAL CONCRETE ELEMENTS HAVE BEEN DESIGNED IN ACCORDANCE WITH CSA STANDARD CAN/CSA A23.3. ALL CONCRETE CONSTRUCTION SHALL BE IN ACCORDANCE WITH CSA STANDARD CAN/CSA A23.1.
- 2. MINIMUM CONCRETE STRENGTH AT 28 DAYS SHALL BE:
 - SLAB ON GRADE
- 32 MPA TYPE C2 - 25 MPA TYPE C1
- FOOTINGS
- = 25 MPA TYPE
- FOUNDATION WALL
- I WALL = 25 MPA TYPE F2

SLUMP SHALL BE 3" ± 1". AGGREGATE SHALL BE 3/4" MAXIMUM.

- 3. THE DEFORMED REINFORCING STEEL SHALL CONFORM TO CSA STANDARD G30.18M-09 GRADE 300R FOR STIRRUPS AND TIES AND GRADE 400R FOR ALL OTHER REINFORCING. UNLESS OTHERWISE NOTED THE REINFORCING LAP LENGTH SHALL BE 'CLASS B' IN SPLICES. ALL REINFORCING HOOKS AND BENDS SHALL BE IN ACCORDANCE WITH A23.1.
- 4. THE REINFORCING COVER FOR CONCRETE SHALL BE:


 3" FOR CONCRETE AGAINST EARTH
 - 1½" FOR FORMED CONCRETE EXPOSED TO EARTH OR WEATHER WHERE THE REINFORCING BAR IS 15M OR SMALLER
 - 2" FOR FORMED CONCRETE EXPOSED TO EARTH OR WEATHER WHERE THE REINFORCING BAR IS 20M OR LARGER
- FOOTINGS SHALL BEAR ON NATIVE UNDISTURBED SOIL WITH A MINIMUM BEARING RESISTANCE OF:
 - 2000 psf (SLS)
 - 3000 psf (ULS).

THE CONTRACTOR SHALL VERIFY THE CAPACITY PRIOR TO PLACEMENT OF CONCRETE.

- 7. THE FOOTING DESIGN IS BASED ON INFORMATION AVAILABLE AT THE TIME OF DESIGN. THE FOOTING DESIGN MAY BE ALTERED DURING CONSTRUCTION, IF THE SITE CONDITIONS WARRANT, BUT ONLY WITH THE EXPRESS PERMISSION OF THE ENGINEER.
- SLAB—ON—GRADE GRADE CONSTRUCTION SHALL BE CAPABLE OF SUPPORTING 500 lbs/ft² WITHOUT RELATIVE SETTLEMENT.
- PROVIDE DOWELS TO WALLS AND COLUMNS TO SHUT THE REINFORCING IN THE WALL OR COLUMN ABOVE.
- ALL ADHESIVE ANCHORS SHALL BE INSTALLED IN ACCORDANCE WITH THE HILTI HIT—HY200 (OR APPROVED EQUAL) PROCEDURES.

MASONRY NOTES

- 1. ALL STRUCTURAL ELEMENTS HAVE BEEN DESIGNED IN ACCORDANCE WITH CSA STANDARD \$304.1. ALL MASONRY CONSTRUCTION SHALL BE IN ACCORDANCE WITH CSA STANDARD A371. ALL MASONRY CONNECTORS, REINFORCING AND TYING SHALL BE IN ACCORDANCE WITH CSA A370. ALL MORTAR AND GROUT SHALL BE IN ACCORDANCE WITH A179.
- ALL CONCRETE BLOCKS SHALL BE NORMAL WEIGHT TYPE H/15/A/M UNLESS OTHERWISE NOTED. MORTAR SHALL BE TYPE S FOR LOADBEARING AND TYPE N FOR NON-LOADBEARING.
- VERTICAL CONTROL JOINTS SHALL BE PROVIDED AT A MAXIMUM SPACING OF 20"-0". REFER TO ARCHITECTURAL DRAWING FOR DETAILS AND LOCATIONS.
- 4. TRIM ALL OPENINGS WITH 2-15M BARS.
- 5. GROUT SHALL CONSIST OF ON ONE PART PORTLAND CEMENT, THREE PARTS SAND (MAXIMUM AGGREGATE SIZE SHALL BE 3/8") WITH WATER TO PROVIDE A MINIMUM 10MPA COMPRESSIVE STRENGTH AT 28 DAYS. SLUMP SHALL BE 8" TO 10".
- ALL CELLS CONTAINING REINFORCING SHALL BE GROUTED SOLID. TWO BLOCK COURSES BELOW BEARING PLATES SHALL BE GROUTED SOLID.
- 7. THE MASONRY SHALL BE CONSTRUCTED EVENLY WITH MAXIMUM LIFTS OF 1200 PER DAY. DO NOT TOOTH AND BOND OR STACK BOND MASONRY. RAKE BACK ENDS OF UNFINISHED WALLS.
- 8. ALL MORTAR JOINTS SHALL BE TOOLED (CONCAVE). A MINIMUM BED JOINT OF '4" IS REQUIRED FOR THE STARTING COURSE TO A MAXIMUM OF '4". THE BED JOINTS SHALL BE '%".
- 9. PROVIDE VERTICAL AND HORIZONTAL REINFORCING AS FOLLOWS UNLESS NOTED OTHERWISE ON THE DRAWINGS.
 - 6" CONCRETE BLOCK = 10M VERTICAL AT 24" O.C. & HEAVY DUTY TRUSS TYPE HORIZONTAL REINFORCING EVERY SECOND COURSE.
 - 8" CONCRETE BLOCK 15M VERTICAL AT 32" O.C. & HEAVY DUTY TRUSS TYPE HORIZONTAL REINFORCING EVERY SECOND COURSE.
 - 10" CONCRETE BLOCK 20M VERTICAL AT 24" O.C. & HEAVY DUTY TRUSS TYPE HORIZONTAL REINFORCING EVERY COURSE.
 - 12" CONCRETE BLOCK 20M VERTICAL AT 24" O.C. & HEAVY DUTY TRUSS TYPE HORIZONTAL REINFORCING EVERY COURSE.
- 10. THE HORIZONTAL REINFORCING AT EXTERIOR WALLS SHALL BE GALVANIZED. DO NOT EXTEND HORIZONTAL REINFORCING THROUGH CONTROL JOINTS UNLESS OTHERWISE NOTED.
- PROVIDE A STEEL LINTEL OVER ALL OPENINGS OR RECESSES INCLUDING OPENINGS FOR MECHANICAL AND ELECTRICAL COMPONENTS. ALL EXTERIOR LINTELS TO BE HOT DIP GALVANIZED.
- 12. BUILD THE MASONRY SOLID AROUND ALL BEAM, LINTEL AND JOIST POCKETS. INSTALL BEARING PLATES AT THE SPECIFIED ELEVATION AND GROUT THE PLATE INTO THE WALL A MINIMUM OF 16".
- 13. PROVIDE TEMPORARY BRACING AS REQUIRED TO SUPPORT THE MASONRY WALLS IN CONSTRUCTION. PROTECT THE MASONRY WALLS FROM THE ELEMENTS AT ALL TIMES EXCEPT DURING CONSTRUCTION PROGRESS.

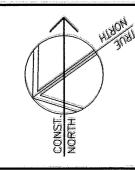



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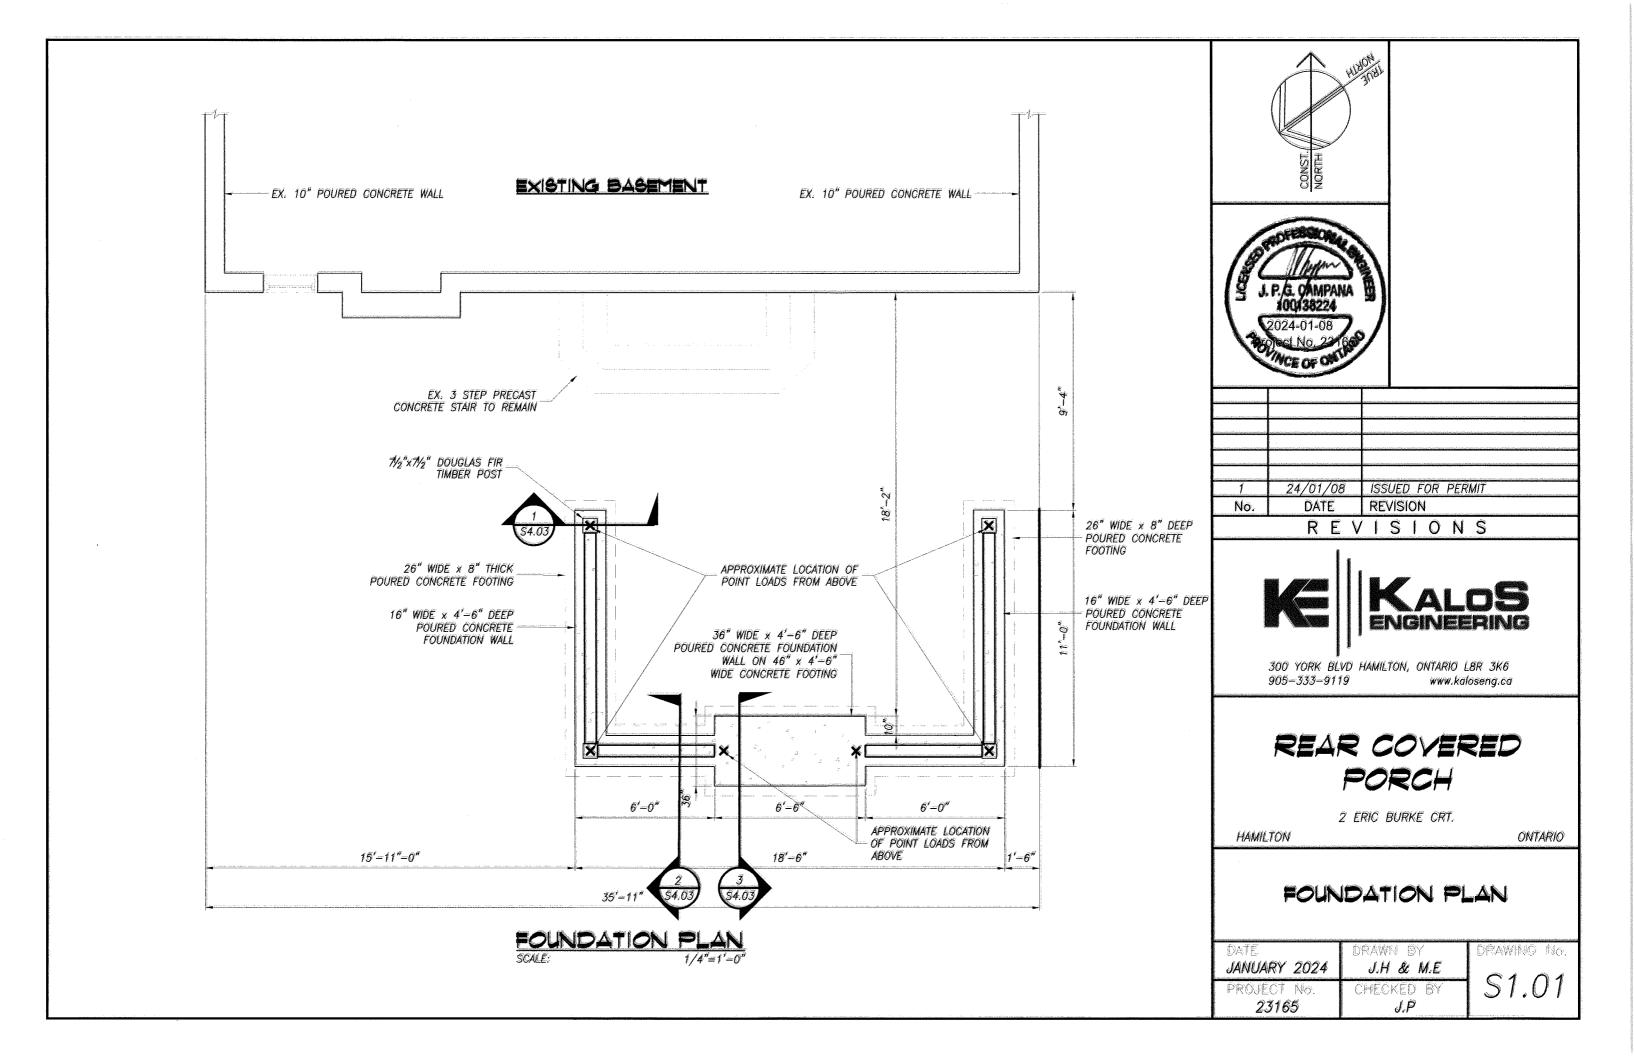
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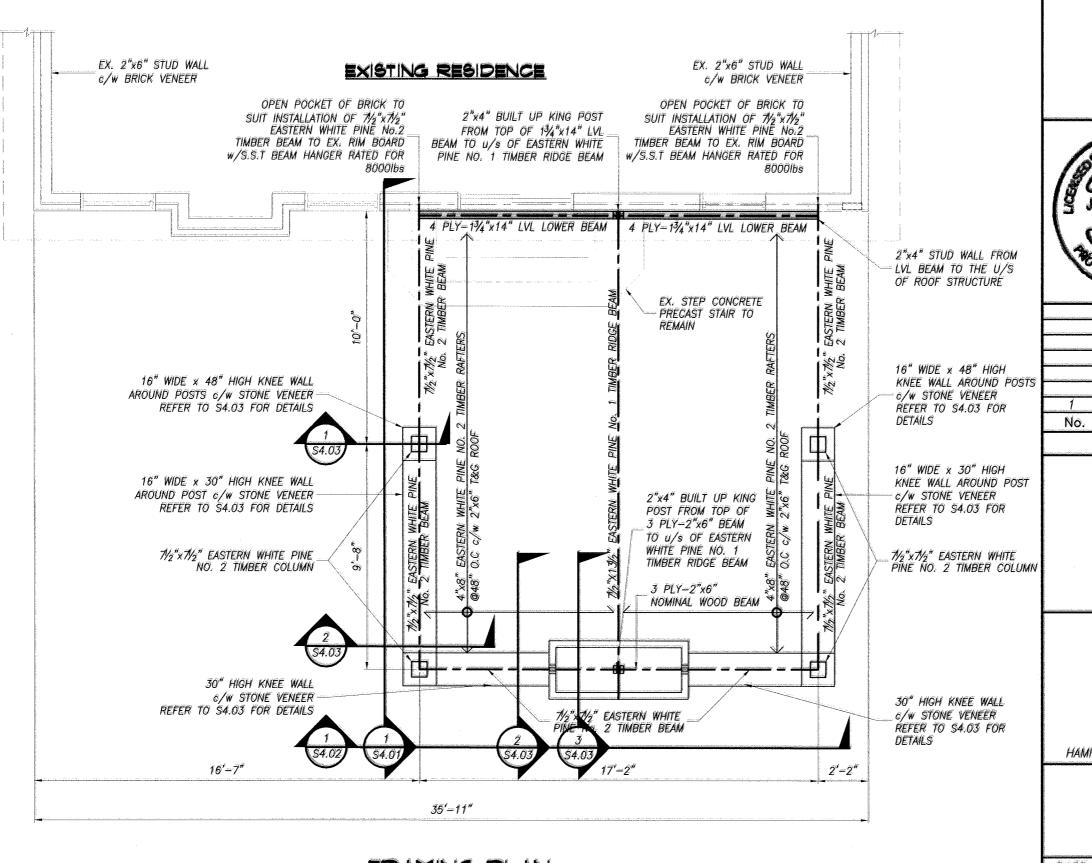
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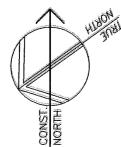
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GENERAL NOTES

DATE	DRAWN BY	DRAWING No.
JANUARY 2024	J.H. & M.E.	CD 01
PROJECT No. 23165	CHECKED BY J.P.	37.01









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No. DATE REVISION

REVISIONS



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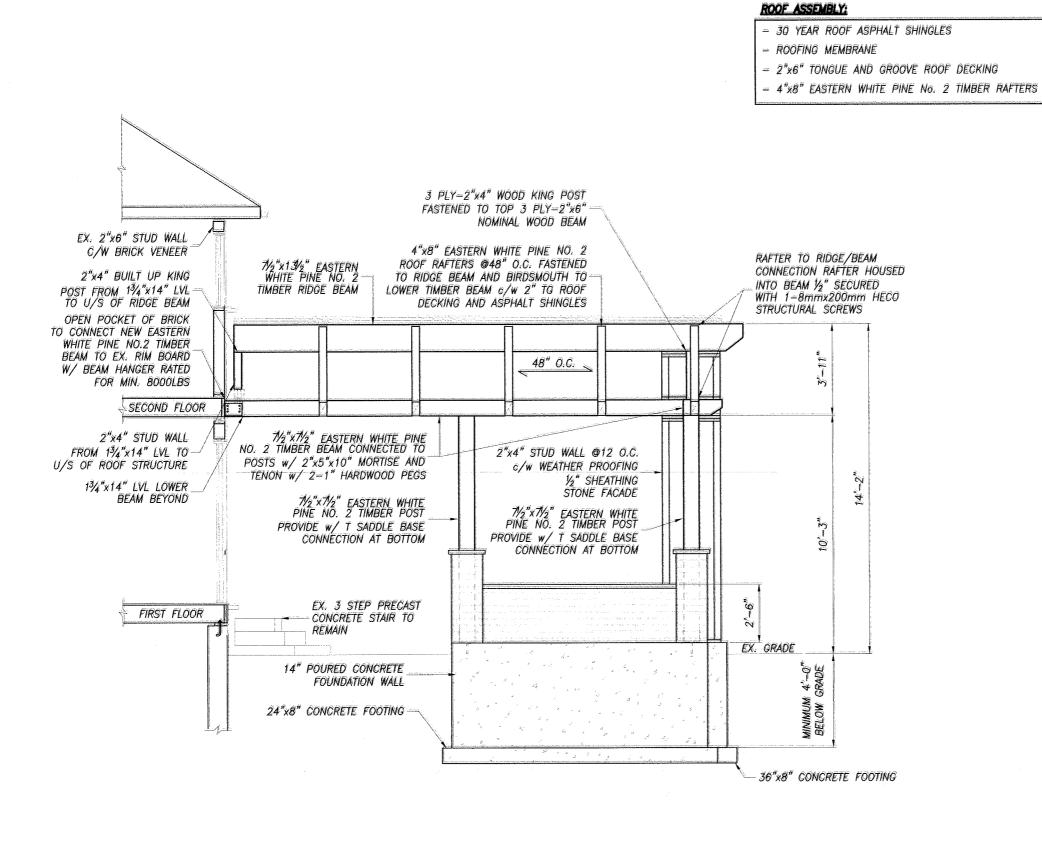
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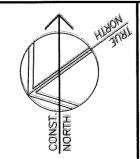
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FRAMING PLAN

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23165	J.P	







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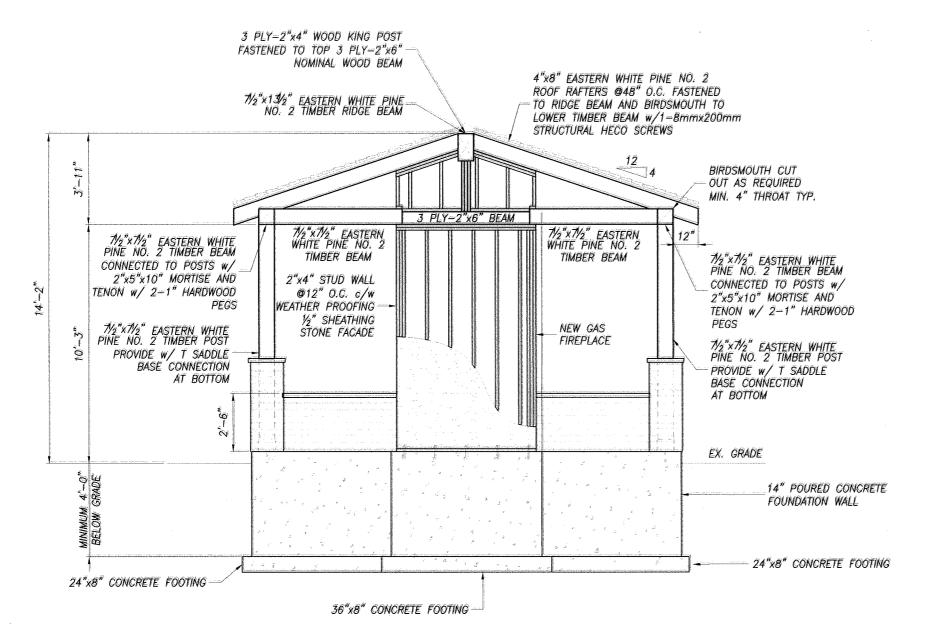
SECTION VIEW

DRAWING No. DRAWN BY JANUARY 2024 J.H. & M.E. PROJECT No.


CHECKED BY 23165 J.P

ROOF ASSEMBLY

- 30 YEAR ROOF ASPHALT SHINGLES
- ROOFING MEMBRANE
- = 2"x6" TONGUE AND GROOVE ROOF DECKING
- 4"x8" EASTERN WHITE PINE No. 2 TIMBER RAFTERS





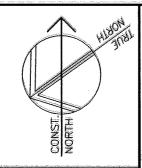



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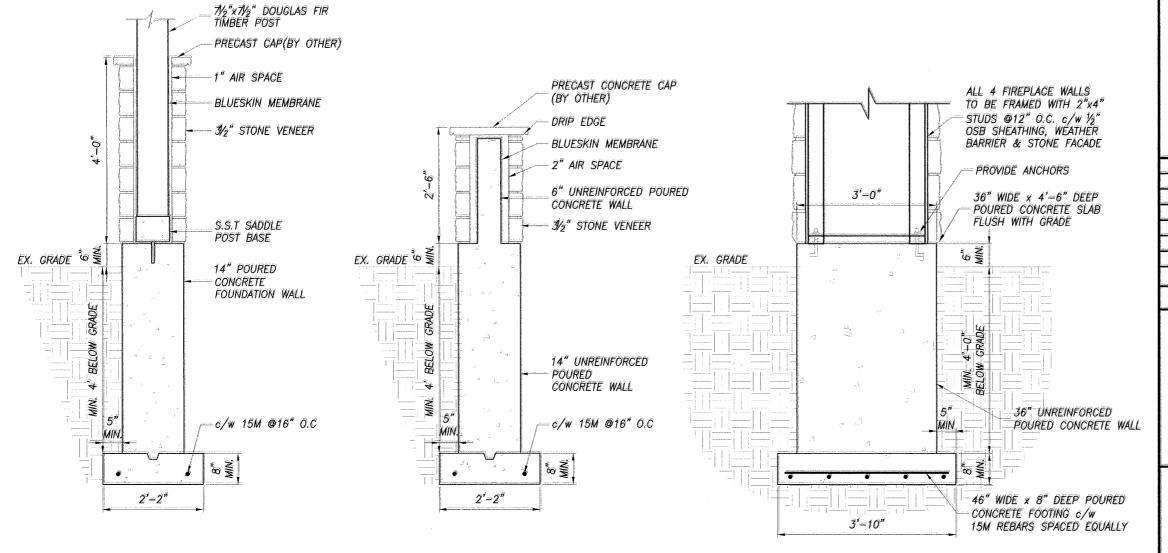
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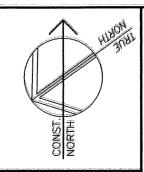
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SECTION VIEW

DATE	DRAWN BY	DRAWING No.
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SECTION SCALE: 1"=1'-0"





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SECTION VIEWS

DATE DRAWN BY DRAWING No.

JANUARY 2024 J.H. & M.E.

PROJECT No. CHECKED BY \$4.03

23165 J.P



Committee of Adjustment City Hall, 5th Floor,

71 Main St. W., Hamilton, ON L8P4Y5

Phone: (905) 546-2424 ext. 4221

Email: cofa@hamilton.ca

APPLICATION FOR A MINOR VARIANCE/PERMISSION

UNDER SECTION 45 OF THE PLANNING ACT

1. **APPLICANT INFORMATION**

APPLICANT II	NFORMATION			
	NAME	MAILIN	G ADDRESS	
Registered Owners(s)	Randy Vieira Amanda Vicira			
Applicant(s)	Qui Nguyen			
Agent or Solicitor				
2 Primary contact		☑ Applicar	nt	☐ Owner ☐ Agent/Solicitor
3 Sign should be s	ent to	☐ Applicar	nt.	✓ Owner☐ AgentSolicitor
4 Request for digit	al copy of sign	☑ Yes*	□ No	
If YES, provide e	email address where sig	n is to be se	nt <u>quin@kalos</u>	seng.ca
5 All corresponder	ice may be sent by ema	iil	☑ Yes*	□ No
(if applicable). O	nail must be included fo nly one email address s es not guarantee all corr	submitted wil	l result in the v	
6 Payment type		✓ In perso □ Cheque		☐ Credit over phone*
			*Must prov	vide number above

2. LOCATION OF SUBJECT LAND

2.1 Complete the applicable sections:

Municipal Address	2 Eric Burke Ct, Hamilton, ON L9A5J9			
Assessment Roll Number				
Former Municipality	Hamilton			
Lot		Concession		
Registered Plan Number		Lot(s)		
Reference Plan Number (s)		Part(s)		

2.2	Are there any	y easements	or restrictive	covenants	affecting	the subject	land?
-----	---------------	-------------	----------------	-----------	-----------	-------------	-------

☐ Yes ☑ No

If YES, describe the easement or covenant and its effect:

PURPOSE OF THE APPLICATION

Additional sheets can be submitted if there is not sufficient room to answer the following questions. Additional sheets must be clearly labelled

All dimensions in the application form are to be provided in metric units (millimetres, metres, hectares, etc.)

3.1 Nature and extent of relief applied for:

New rear covered porch exceeds the minimum rear yard setback of 6m based on section 4.6 (d). Proposed structure exceed the minmum rear setback by 0.79m Proposed Rear Yard Setback = 5.21m

...

☐ Second Dwelling Unit ☐ Reconstruction of Existing Dwelling

3.2 Why it is not possible to comply with the provisions of the By-law?

The rear covered porch exceeds the minimum rear yard setback

3.3 Is this an application 45(2) of the Planning Act.

☐ Yes

✓ No

If yes, please provide an explanation:

4. DESCRIPTION OF SUBJECT LAND AND SERVICING INFORMATION

4.1 Dimensions of Subject Lands:

Lot Frontage	Lot Depth	Lot Area	Width of Street
8.54m	41.03m	634.8m^2	N/A

Existing:				
Type of Structure	Front Yard Setback	Rear Yard Setback	Side Yard Setbacks	Date of Construction
2 Storey-Detached Dwell.	6.18m	10.76m	1.22m	
The state of the s				
2man a a a di		<u> </u>		
Proposed: Type of Structure	Front Yard Setback	Rear Yard Setback	Side Yard Setbacks	Date of Construction
Rear Covered Porch	21.92m	5.21m	7.70m	301101114101101
	L			
sheets if neces	all buildings and struct	tures on or proposed	for the subject lands (a	attach additiona
sheets if neces Existing:	ssary):			
sheets if neces Existing: Type of Structure	all buildings and struct ssary): Ground Floor Area 151.8m2	Gross Floor Area Approx. 456m2	for the subject lands (a	attach additiona Height 7.62
sheets if neces Existing: Type of Structure	ssary): Ground Floor Area	Gross Floor Area	Number of Storeys	Height
sheets if neces Existing: Type of Structure	ssary): Ground Floor Area	Gross Floor Area	Number of Storeys	Height
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sheets if neces Existing: Type of Structure 2 Storey-Detached Dwell. Proposed:	Ground Floor Area 151.8m2	Gross Floor Area Approx. 456m2	Number of Storeys	Height
sheets if neces Existing: Type of Structure 2 Storey-Detached Dwell. Proposed: Type of Structure	Ground Floor Area 151.8m2 Ground Floor Area	Gross Floor Area Approx. 456m2 Gross Floor Area	Number of Storeys	Height
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sheets if neces Existing: Type of Structure 2 Storey-Detached Dwell. Proposed: Type of Structure	Ground Floor Area 151.8m2 Ground Floor Area	Gross Floor Area Approx. 456m2 Gross Floor Area	Number of Storeys 2 Number of Storeys	Height 7.62 Height
sheets if neces Existing: Type of Structure 2 Storey-Detached Dwell. Proposed: Type of Structure	Ground Floor Area 151.8m2 Ground Floor Area	Gross Floor Area Approx. 456m2 Gross Floor Area	Number of Storeys 2 Number of Storeys	Height 7.62 Height
sheets if neces Existing: Type of Structure 2 Storey-Detached Dwell. Proposed: Type of Structure Rear Covered Porch	Ground Floor Area 151.8m2 Ground Floor Area 35.29m^2	Gross Floor Area Approx. 456m2 Gross Floor Area 35.29m^2	Number of Storeys 2 Number of Storeys	Height 7.62 Height
sheets if neces Existing: Type of Structure 2 Storey-Detached Dwell. Proposed: Type of Structure Rear Covered Porch	Ground Floor Area 151.8m2 Ground Floor Area 35.29m^2 supply: (check approp	Gross Floor Area Approx. 456m2 Gross Floor Area 35.29m^2 priate box)	Number of Storeys 2 Number of Storeys 1	Height 7.62 Height 4.32m
sheets if neces Existing: Type of Structure 2 Storey-Detached Dwell. Proposed: Type of Structure Rear Covered Porch 4 Type of water s publicly own	Ground Floor Area 151.8m2 Ground Floor Area 35.29m^2	Gross Floor Area Approx. 456m2 Gross Floor Area 35.29m^2 priate box) bed water system	Number of Storeys 2 Number of Storeys 1	Height 7.62 Height 4.32m
sheets if neces Existing: Type of Structure 2 Storey-Detached Dwell. Proposed: Type of Structure Rear Covered Porch 4 Type of water s publicly own	Ground Floor Area 151.8m2 Ground Floor Area 35.29m^2 supply: (check approphed and operated pipers)	Gross Floor Area Approx. 456m2 Gross Floor Area 35.29m^2 priate box) bed water system	Number of Storeys 2 Number of Storeys 1	Height 7.62 Height 4.32m
sheets if neces Existing: Type of Structure 2 Storey-Detached Dwell. Proposed: Type of Structure Rear Covered Porch 4 Type of water s publicly ow privately ow	Ground Floor Area 151.8m2 Ground Floor Area 35.29m^2 supply: (check approphed and operated piper and operated in a content of the content o	Gross Floor Area Approx. 456m2 Gross Floor Area 35.29m^2 priate box) bed water system dividual well	Number of Storeys 2 Number of Storeys 1	Height 7.62 Height 4.32m water body
sheets if neces Existing: Type of Structure 2 Storey-Detached Dwell. Proposed: Type of Structure Rear Covered Porch 4 Type of water s publicly ow privately ow 5 Type of storm	Ground Floor Area 151.8m2 Ground Floor Area 35.29m^2 supply: (check approphed and operated pipers)	Gross Floor Area Approx. 456m2 Gross Floor Area 35.29m^2 priate box) bed water system dividual well propriate boxes)	Number of Storeys 2 Number of Storeys 1	Height 7.62 Height 4.32m

4.6	Type of sewage disposal proposed: (check appropriate box)
	 ✓ publicly owned and operated sanitary sewage ☐ system privately owned and operated individual ☐ septic system other means (specify)
4.7	Type of access: (check appropriate box) ☐ provincial highway ☐ municipal road, seasonally maintained ☐ municipal road, maintained all year ☐ Cul de Sac
4.8	Proposed use(s) of the subject property (single detached dwelling duplex, retail, factory etc.): Single Family Detached Dwelling
4.9	Existing uses of abutting properties (single detached dwelling duplex, retail, factory etc.): Single Family Detached Dwelling
7	HISTORY OF THE SUBJECT LAND
7.1	Date of acquisition of subject lands:
7.2	Previous use(s) of the subject property: (single detached dwelling duplex, retail, factory etc) Single Family Detached Dwelling
7.3	Existing use(s) of the subject property: (single detached dwelling duplex, retail, factory etc) Single Family Detached Dwelling
7.4	Length of time the existing uses of the subject property have continued:
7.5	What is the existing official plan designation of the subject land?
	Rural Hamilton Official Plan designation (if applicable):
	Rural Settlement Area:
	Urban Hamilton Official Plan designation (if applicable) Neishbor hoods
	Please provide an explanation of how the application conforms with the Official Plan.
7.6	What is the existing zoning of the subject land? Residential "R1" Zone
7.8	Has the owner previously applied for relief in respect of the subject property? (Zoning By-lawAmendment or Minor Variance) ☐ Yes ☑ No
	If yes, please provide the file number: Residential "R1" Zone

7.9	Is the subject property the subject	t of a current	application for consent u	nder Section 53 of the
	Planning Act?	☐ Yes	☑ No	
	If yes, please provide the file num	nber:		
8	ADDITIONAL INFORMATION			
8.1	Number of Dwelling Units Existing	g: <u>1</u>	M	
8.2	Number of Dwelling Units Propos	ed: 1		
8.3	Additional Information (please inc	lude separat	e sheet if needed):	

COMPLETE APPLICATION REQUIREMENTS 11.1 All Applications ✓ Application Fee ✓ Site Sketch ✓ Complete Application form ✓ Signatures Sheet Other Information Deemed Necessary 11.4 Cover Letter/Planning Justification Report Authorization from Council or Director of Planning and Chief Planner to submit application for Minor Variance Minimum Distance Separation Formulae (data sheet available upon request) Hydrogeological Assessment ☐ Septic Assessment Archeological Assessment Noise Study Parking Study