COMMITTEE OF ADJUSTMENT



City Hall, 5th floor, 71 Main Street West, Hamilton, ON L8P 4Y5 Telephone (905) 546-2424, ext. 4221, 3935 Fax (905) 546-4202

E-mail: cofa@hamilton.ca

NOTICE OF PUBLIC HEARING Minor Variance

You are receiving this notice because you are either:

- Assessed owner of a property located within 60 metres of the subject property
- Applicant/agent on file, or
- Person likely to be interested in this application

APPLICATION NO.: HM/A-21:166

APPLICANTS: Owner Vlad Andriuca

SUBJECT PROPERTY: Municipal address 28 Burris St., Hamilton

ZONING BY-LAW: Zoning By-law 6593, as Amended 77-8 and 83-48

ZONING: "D/S-497a" (Urban Protected Residential - One and Two

Family Dwellings etc.) district

PROPOSAL: To permit the conversion of the existing building currently occupied

by a Residential Care Facility to a two (2) family dwelling,

notwithstanding,

- 1. A minimum lot width of 11.8 metres and a minimum lot area of 273 square metres shall be provided instead of the minimum required lot width of 18.0 metres and minimum required lot area of 540.0 square metres;
- 2. No front yard landscaping shall be provided instead of providing a minimum of 50% of the gross area of the front yard as landscaped area;
- 3. No on-site manoeuvring space shall be provided for the parking space adjacent to the Avalon Place street line instead of providing a minimum manoeuvring space width of 6.0 metres required to be abutting upon and accessory to each required parking space;
- 4. The parking space adjacent to the southerly lot line shall be permitted to be obstructed by the parking space adjacent to the Avalon Place street line whereas the Zoning By-law requires each and every parking space to be unobstructed and freely and readily accessible without moving any other vehicle on the lot;
- 5. The required manoeuvring space for the parking space adjacent to the southerly lot line shall be permitted to be obstructed by the parking space adjacent to the Avalon Place street line whereas the Zoning By-law requires all manoeuvring spaces to be maintained free and clear of obstructions.

NOTF:

- 1. The submitted site plan does not accurately reflect actual site conditions as setbacks are shown to be provided to the limits of the sidewalks and not the actual property lines.
- 2. The parking space shown to be provided at the front of the existing building is not considered a parking space for zoning purposes as it is located entirely off-site and as such has not been reviewed for zoning compliance.

HM/A-21: 166 Page 2

- 3. The variances have been written for the use of a two (2) family dwelling only. The submitted floor plans do not clearly identify the limits of the individual dwelling units and are shown to provide laundry facilities on each floor level. Additionally, the submitted cross-section drawings indicate that four (4) kitchens are to be provided. Further approvals will be required should the intent be to establish any use other than a two (2) family dwelling provided in accordance with the defined terms within the Zoning By-law.
- 4. The requested variance for relief from the minimum required parking space size is not required as the minimum required parking space size of 2.7 metres in width by 6.0 metres in length is shown to be provided.
- 5. A further variance will be required if the minimum required access driveway width of 2.8 metres is not provided.
- 6. A further variance will be required should gravel or similar surface or other suitable paving not be provided for the parking spaces and access driveway.

This application will be heard by the Committee as shown below:

DATE: Thursday, June 3rd, 2021

TIME: 1:40 p.m.

PLACE: Via video link or call in (see attached sheet for details)

To be streamed at

www.hamilton.ca/committeeofadjustment

for viewing purposes only

PUBLIC INPUT

Written: If you would like to submit written comments to the Committee of Adjustment you may do so via email or hardcopy. Please see attached page for complete instructions, including deadlines for submitting to be seen by the Committee.

Orally: If you would like to speak to this item at the hearing you may do so via video link or by calling in. Please see attached page for complete instructions, including deadlines for registering to participate.

MORE INFORMATION


For more information on this matter, including access to drawings illustrating this request:

- Visit www.hamilton.ca/committeeofadjustment
- Call 905-546-CITY (2489) or 905-546-2424 extension 4221, 4130, or 3935
- Email Committee of Adjustment staff at cofa@hamilton.ca

DATED: May 18th, 2021.

Jamila Sheffield, Secretary-Treasurer Committee of Adjustment

Information respecting this application is being collected under the authority of the Planning Act, R.S.O., 1990, c. P. 13. All comments and opinions submitted to the City of Hamilton on this matter, including the name, address, and contact information of persons submitting comments and/or opinions, will become part of the public record and will be made available to the Applicant and the general public.

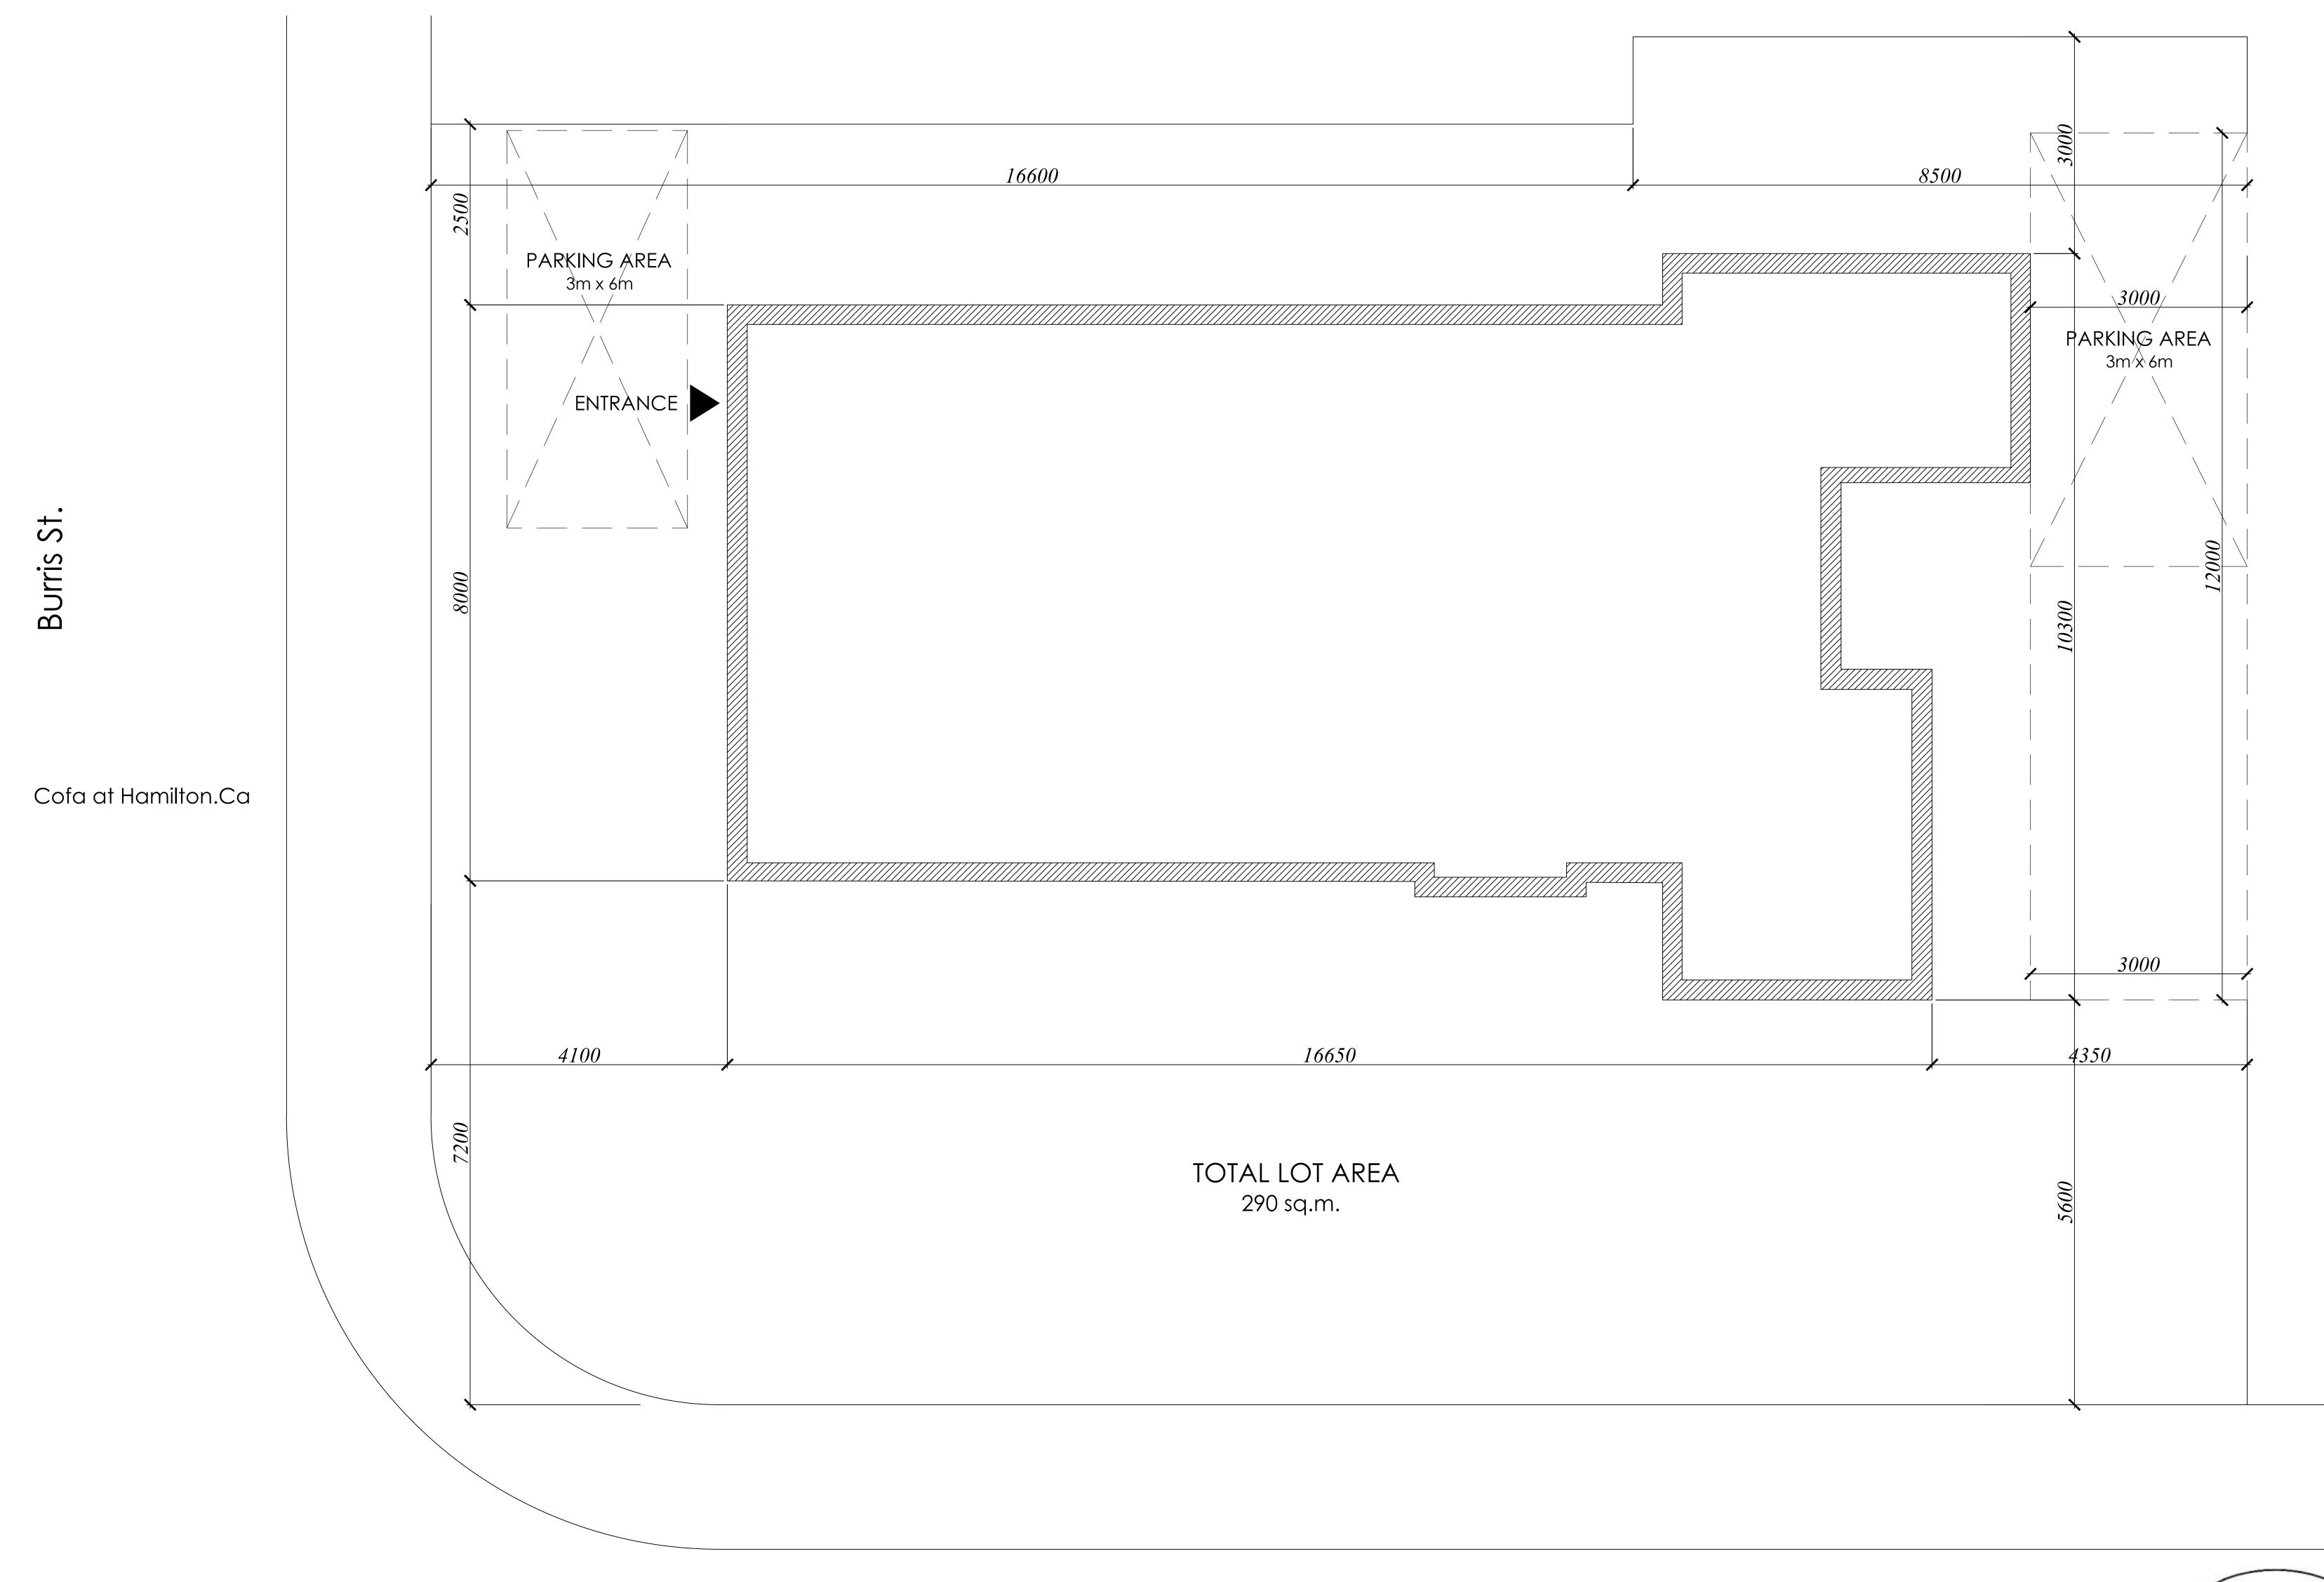

PROPOSED SITE PLAN

SCALE: 1:60



GENERAL NOTES:

-ALL EXISTING & PROPOSED WORK MUST BE VERIFY ON SITE PROIR TO ANY CONSTRUCTION.

-DO NOT SCALE DRAWINGS.

-CONTRACTORS AND OWNERS ARE RESPONSIBLE FOR ANY MODIFICATIONS TO THIS PLAN DO TO FIELD CONSTRUCTION CONDITIONS AND CONSTRUCTION METHODS.

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CONSTRUCTION SPECIFICATIONS AND

-ALL CONSTRUCTION MUST BE ADHERE TO ONTARIO BUILDING CODE REQUIREMENTS AND ANY AUTHORITIES HAVING JURISDICTION.

-CONTRACTORS TO REVIEW APPROVED PERMIT DRAWINGS FOR ADDITIONAL NOTES AND RELATED DOCUMENTS.

-ALL PRODUCTS & COLOUR SELECTIONS ARE THE RESPONSIBILITY OF THE CLIENT AND/OR CONTRACTOR UNLESS STATED OTHERWISE IN THESE PLANS.

-ANY MATERIALS SUBSTITUTIONS MUST BE OF EQUAL OR GREATER PERFORMANCE.

DATE: DESCRIPTION:

DRAWN BY:

DATE:

Mar 15. 2021

<u>SCALE:</u>

1:100

28 Burris St., Hamilton, ON, L8M, 2J3


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PROJECT:

PROPOSED SITE PLAN

SHEET NUMBER:

A0.01



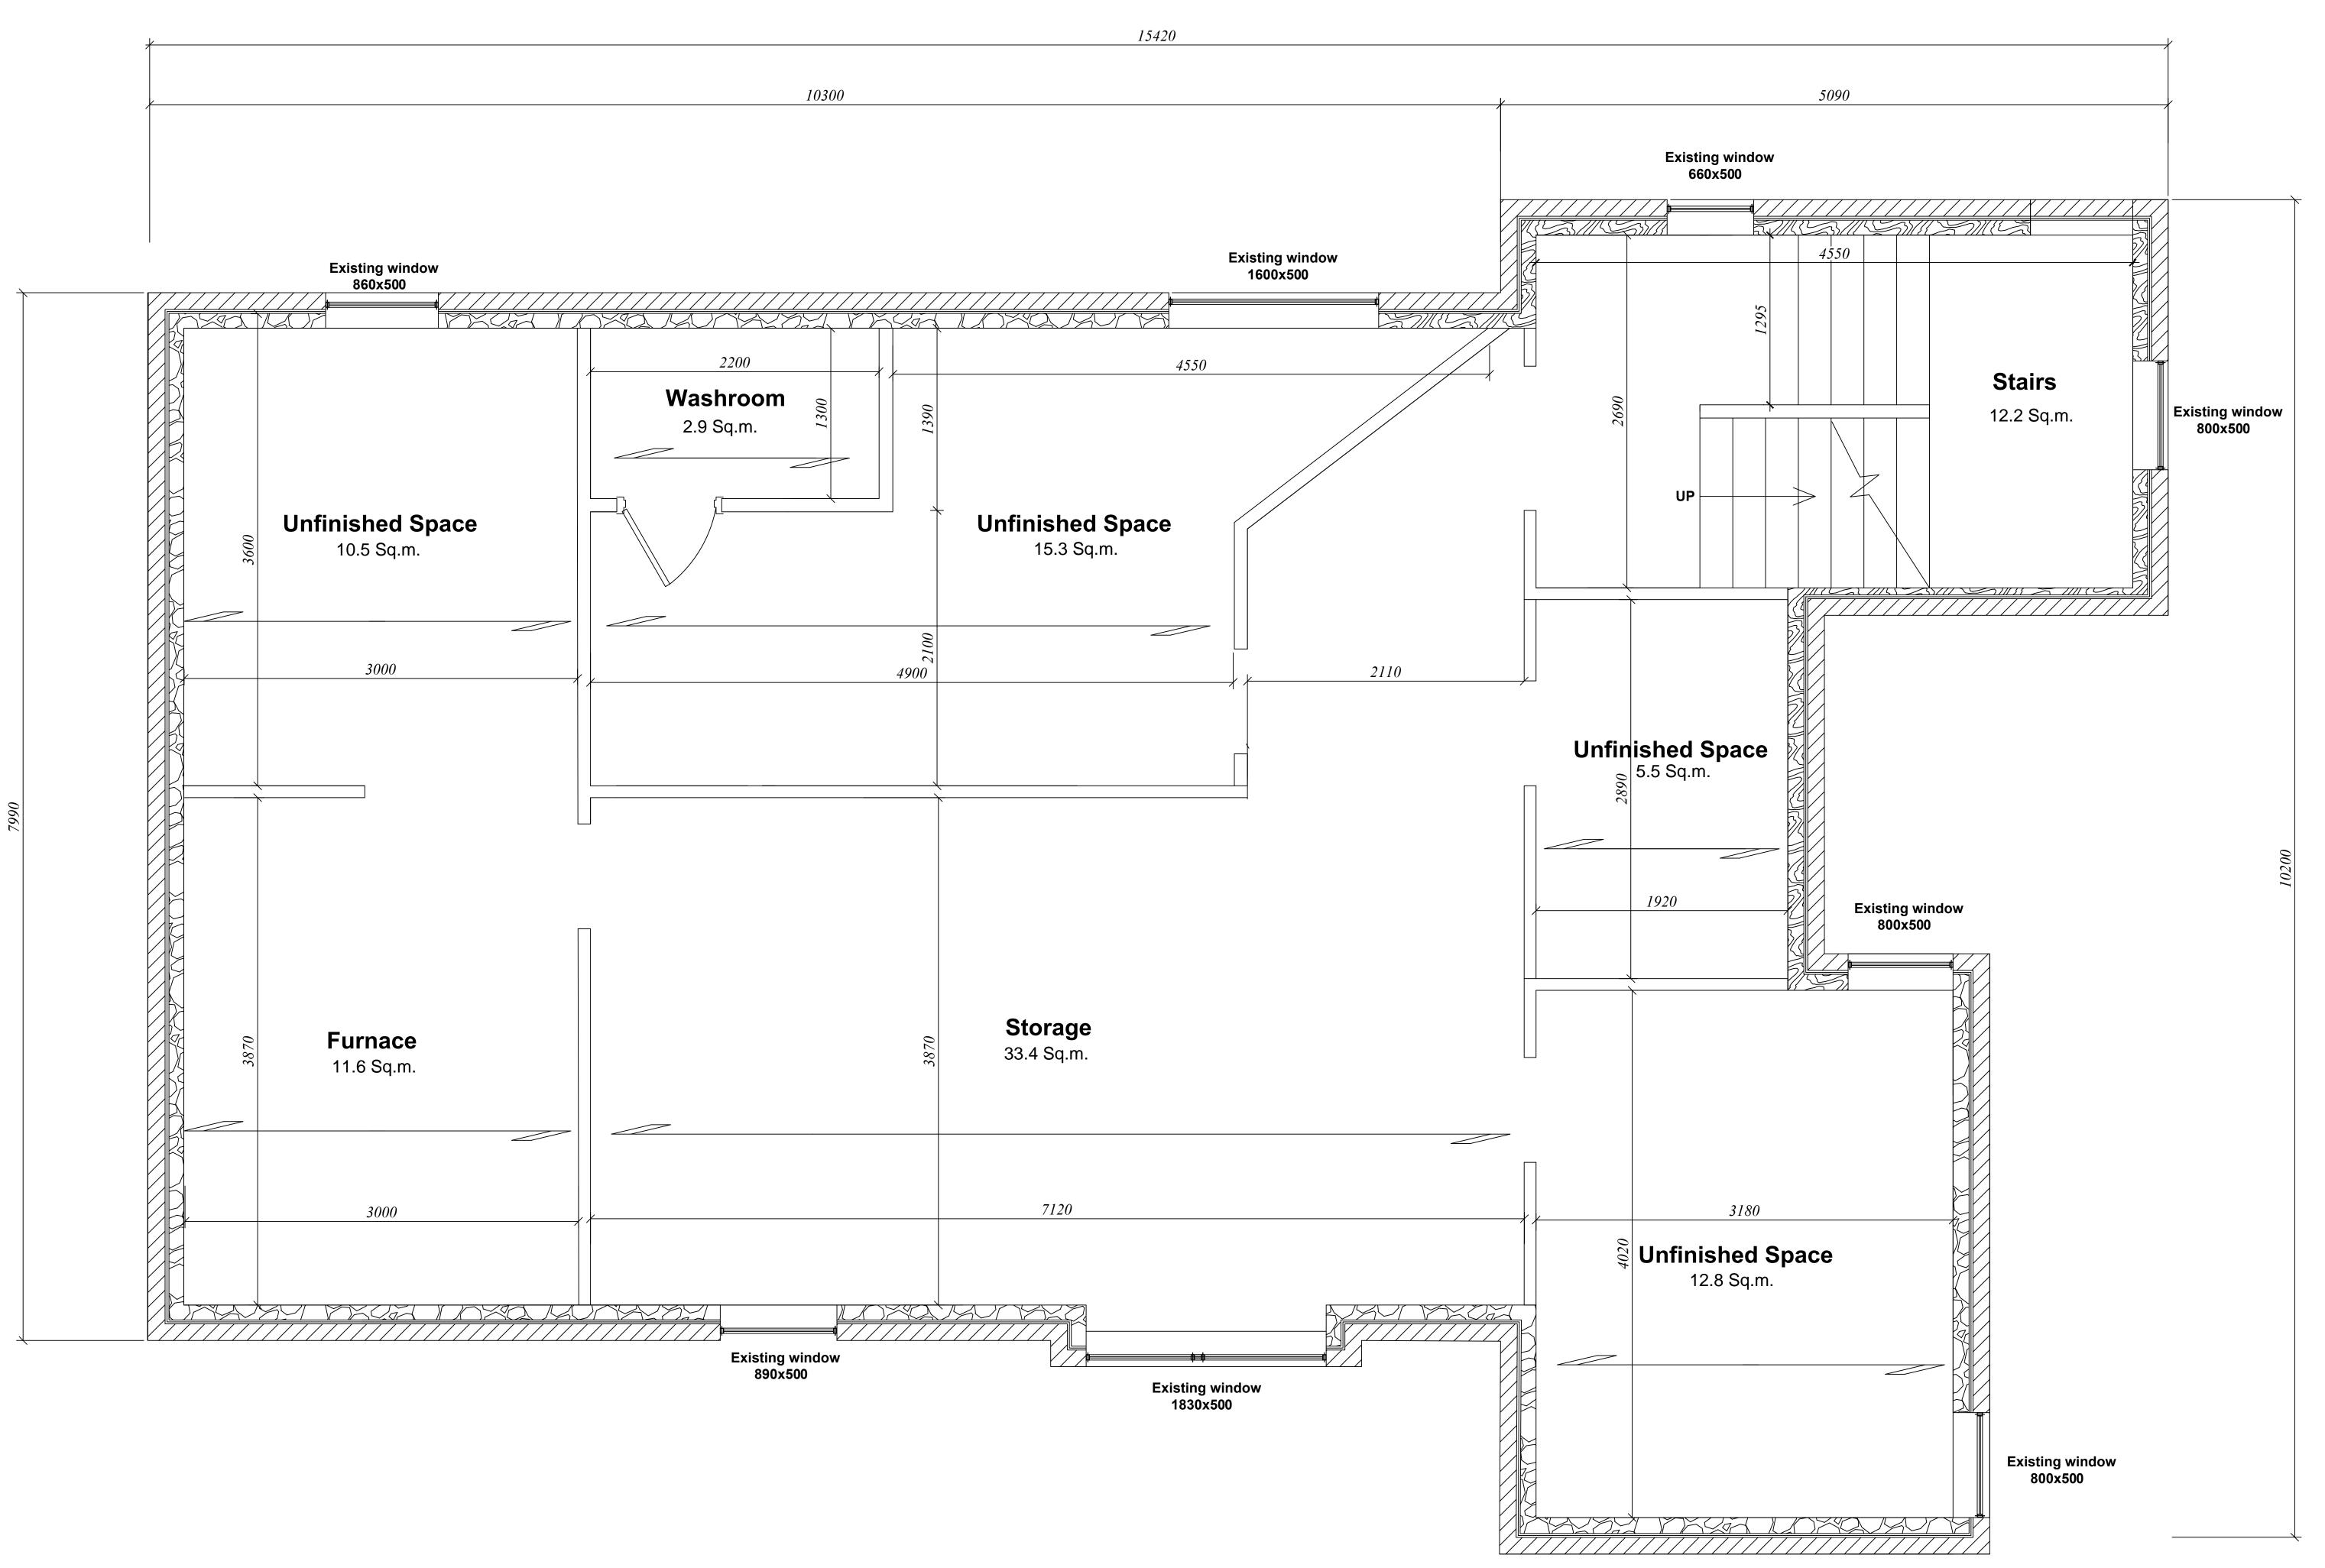

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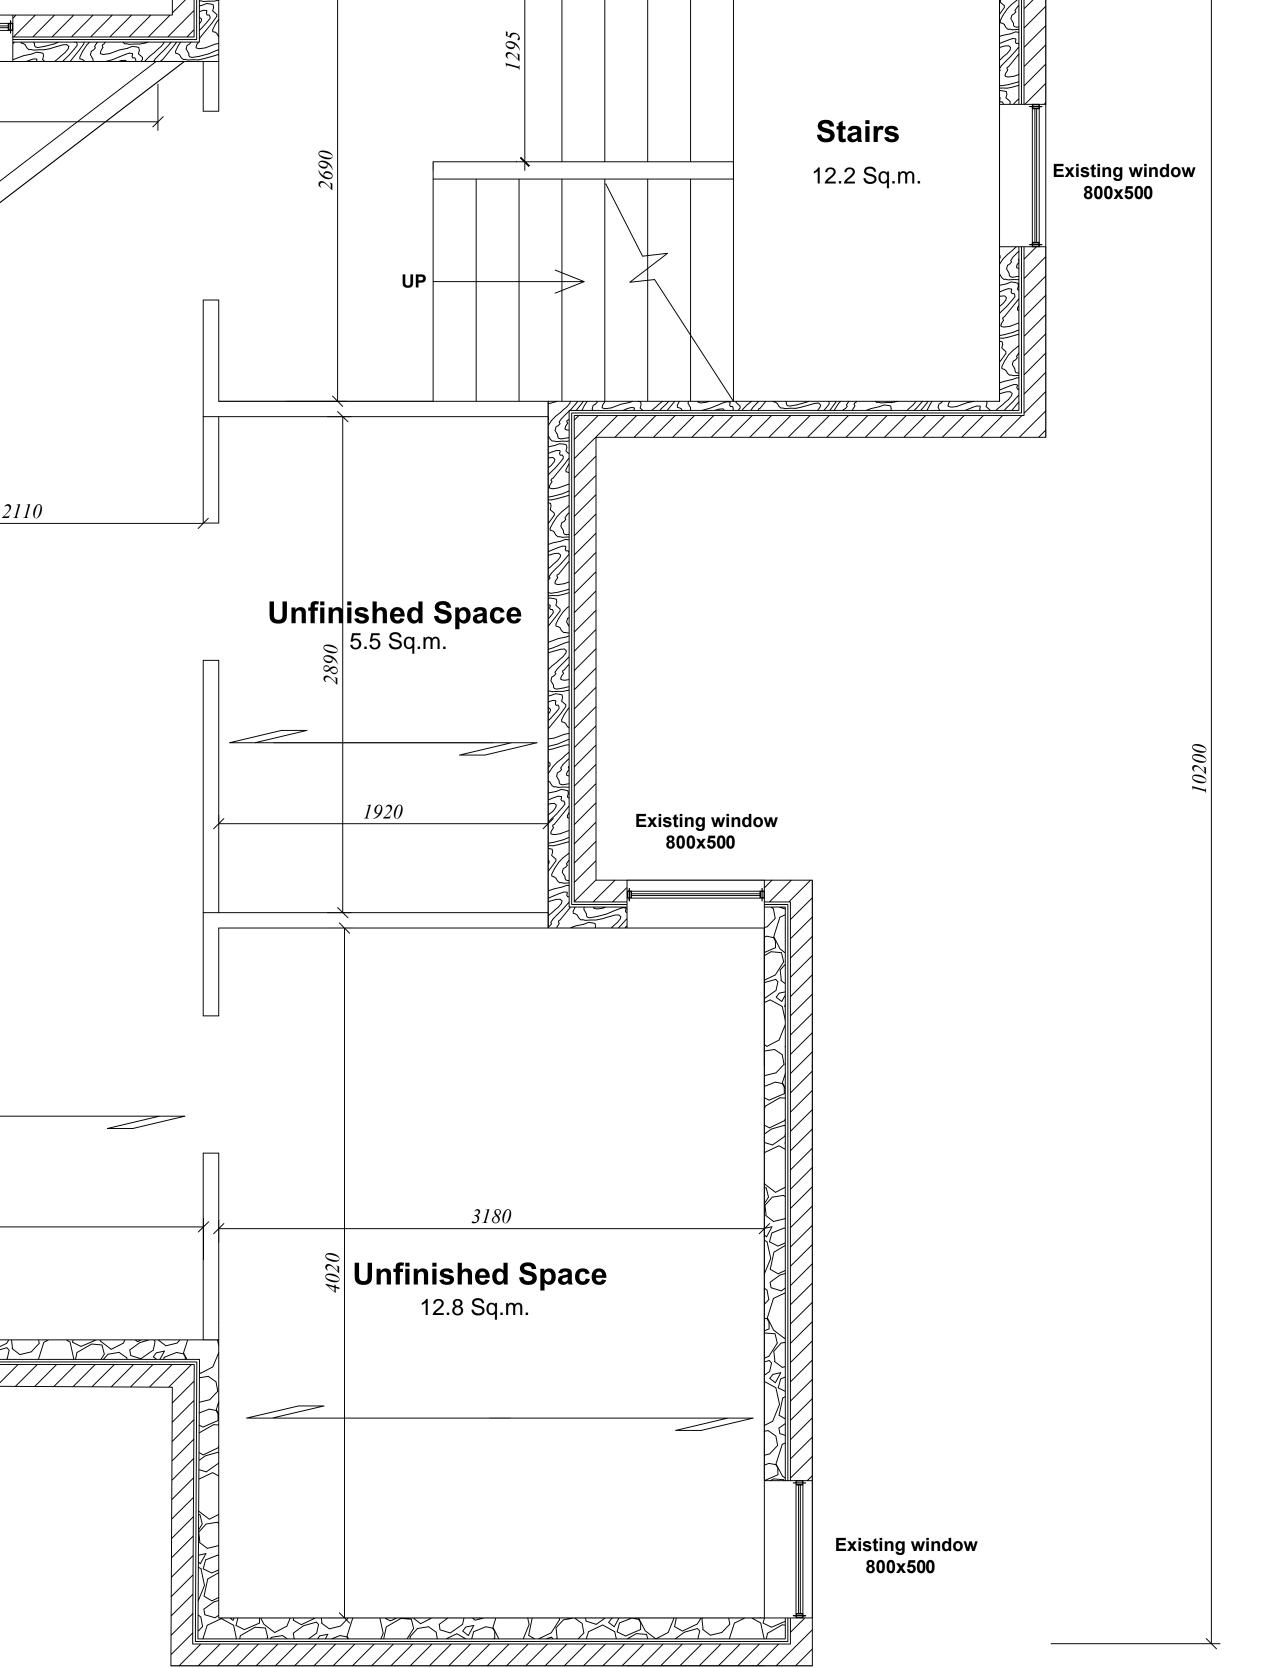
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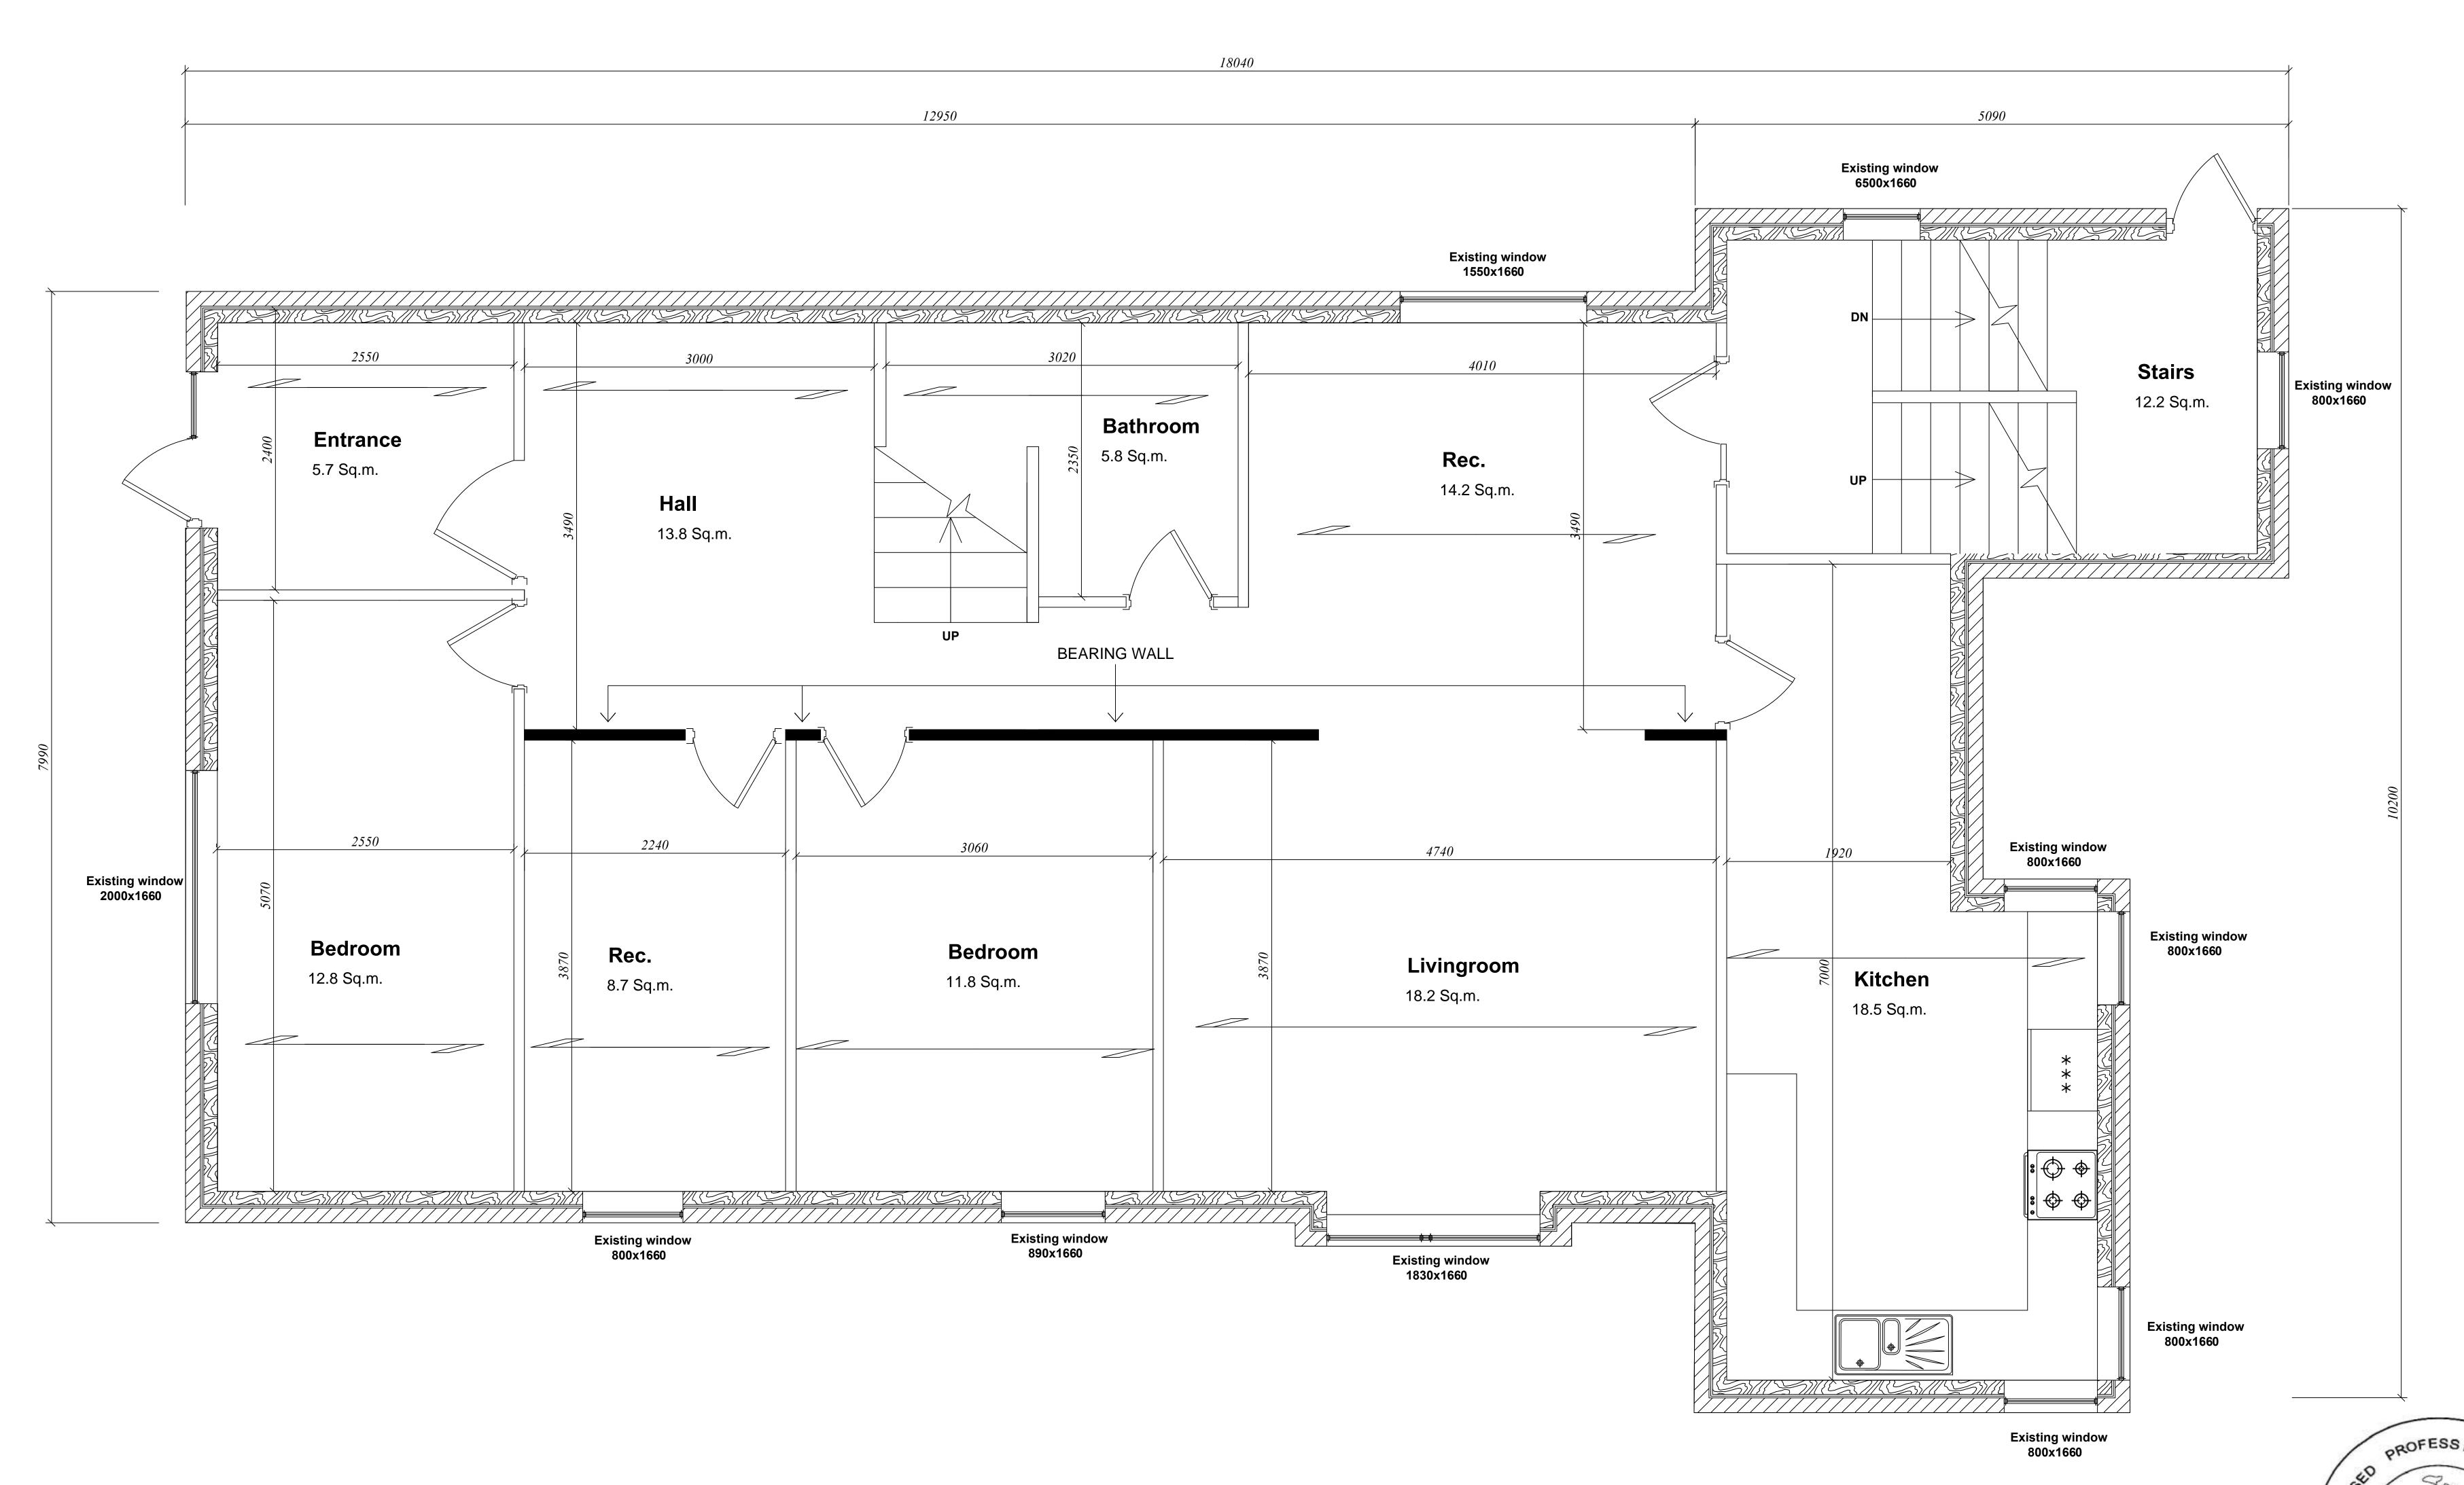
SHEET TITLE :

V.HORDITSA 100514516

EXISTING BASEMENT

SHEET NUMBER:





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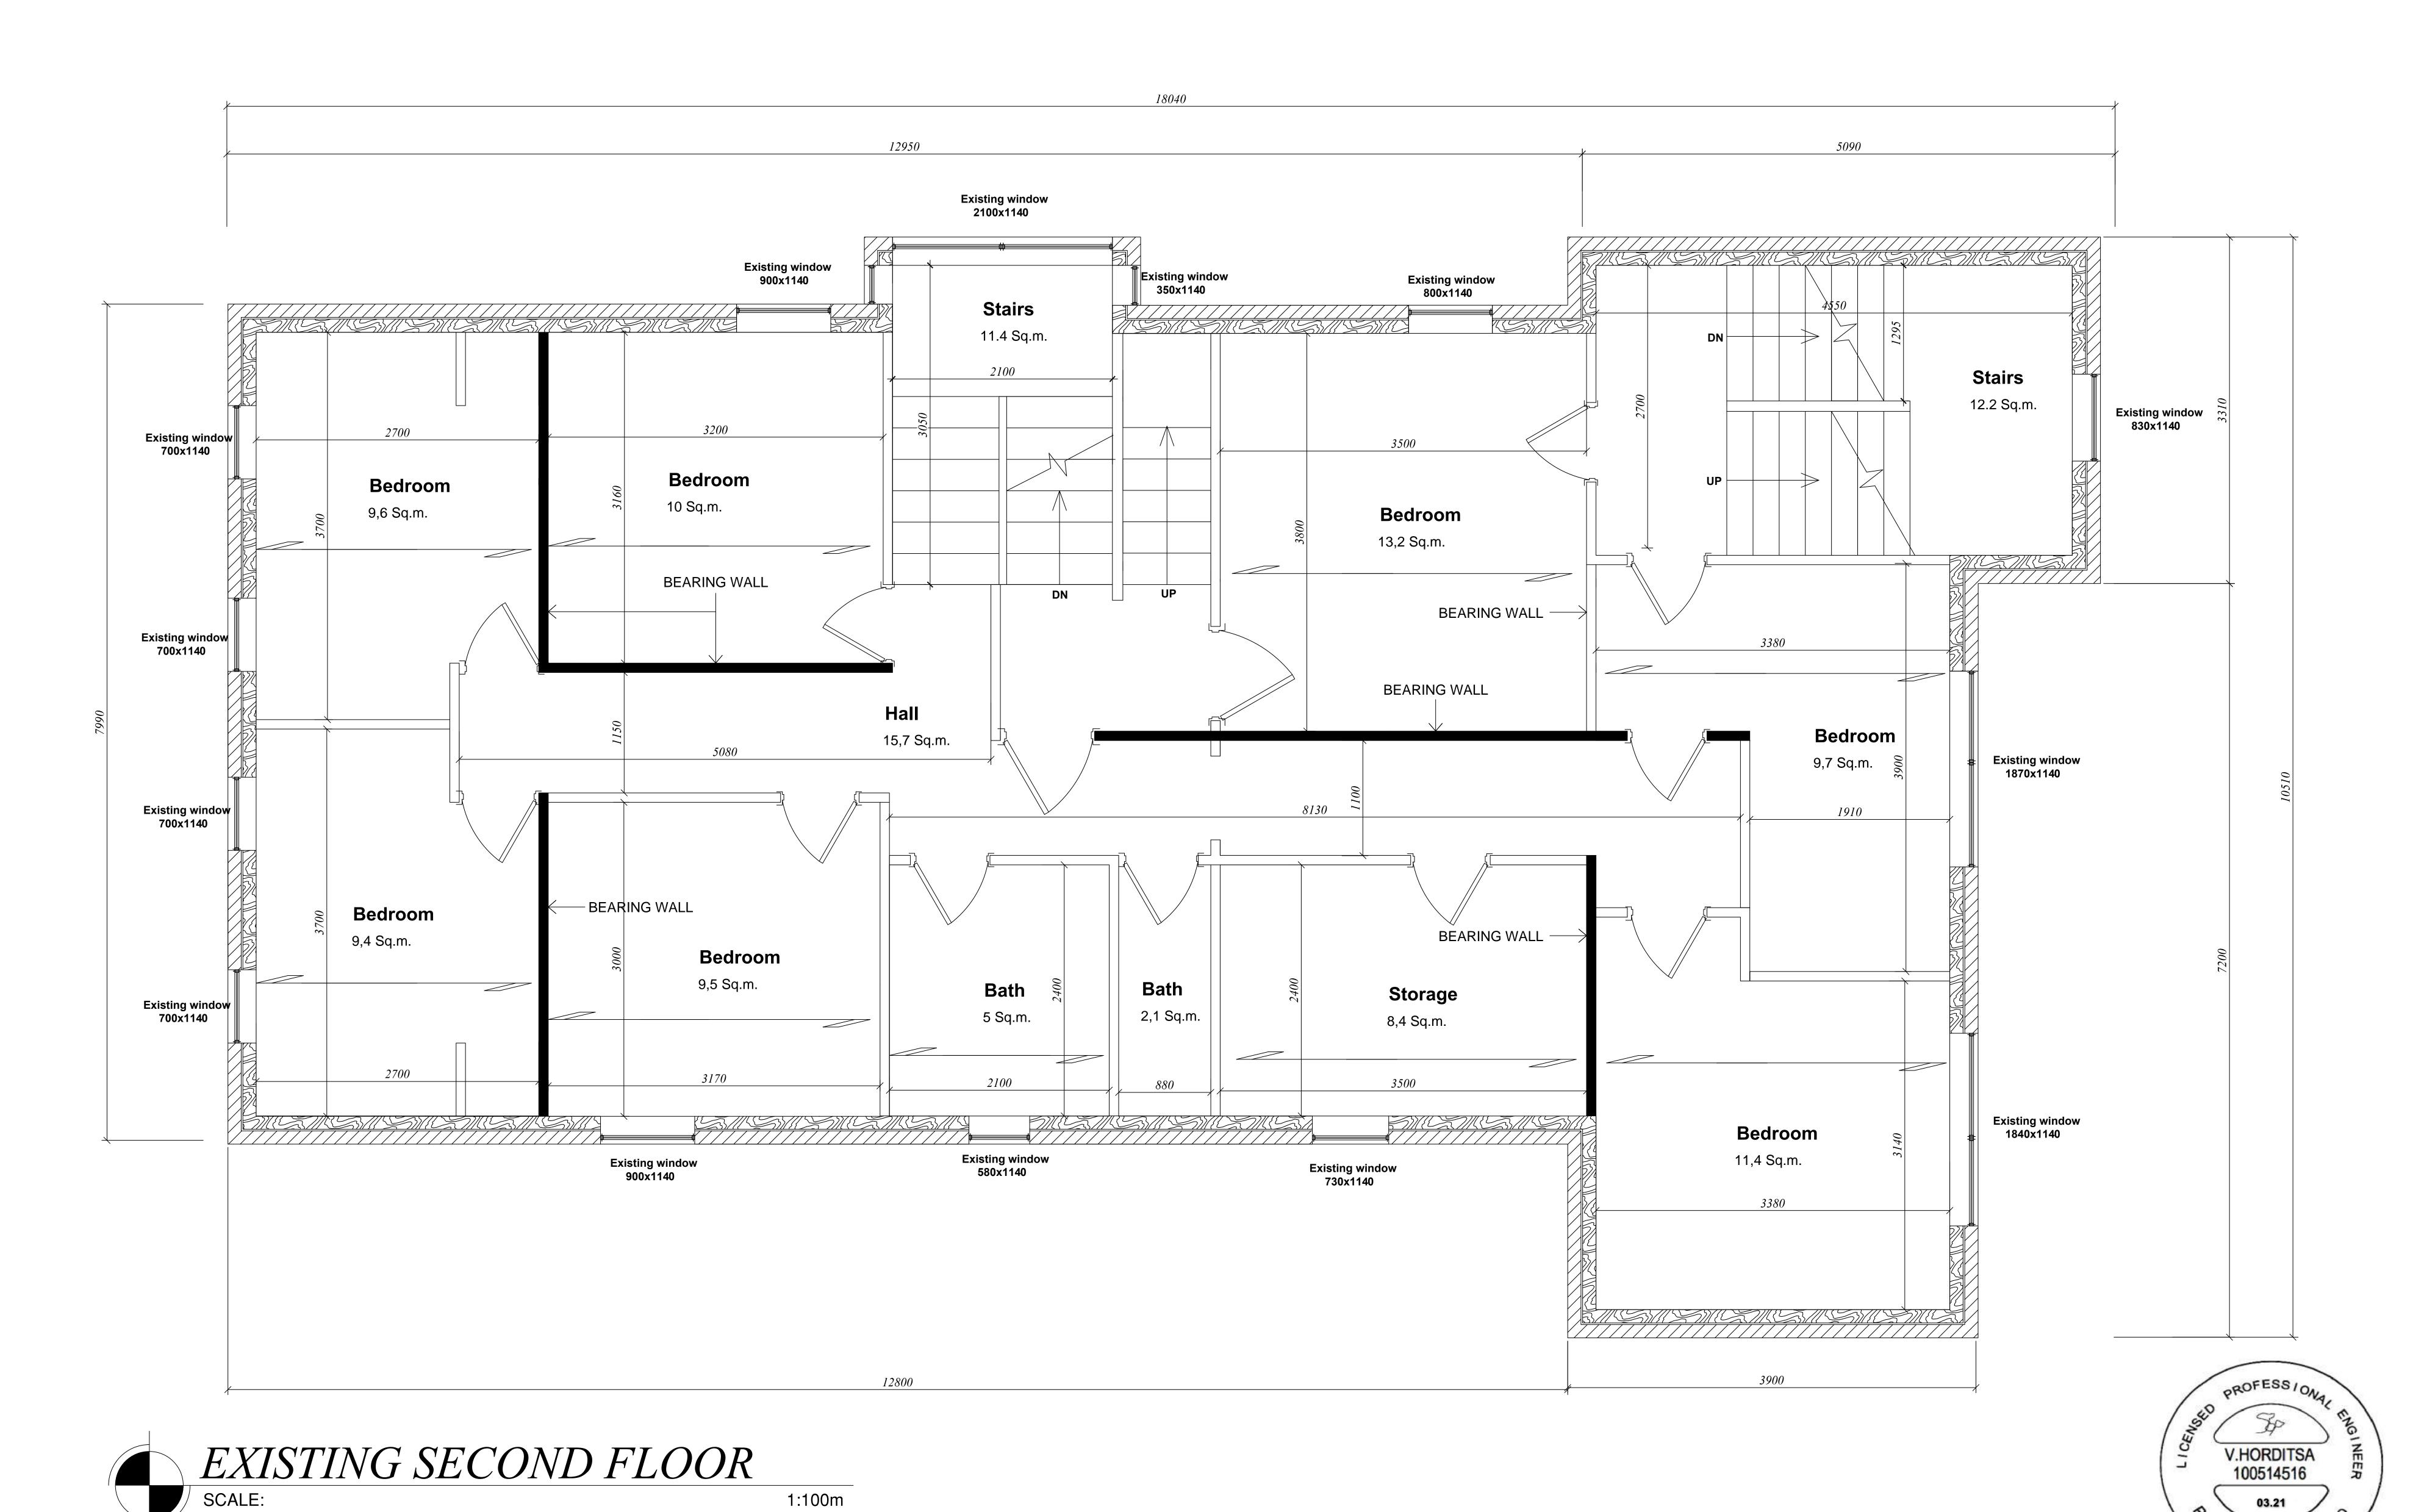
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DRAWN BY: V.H.

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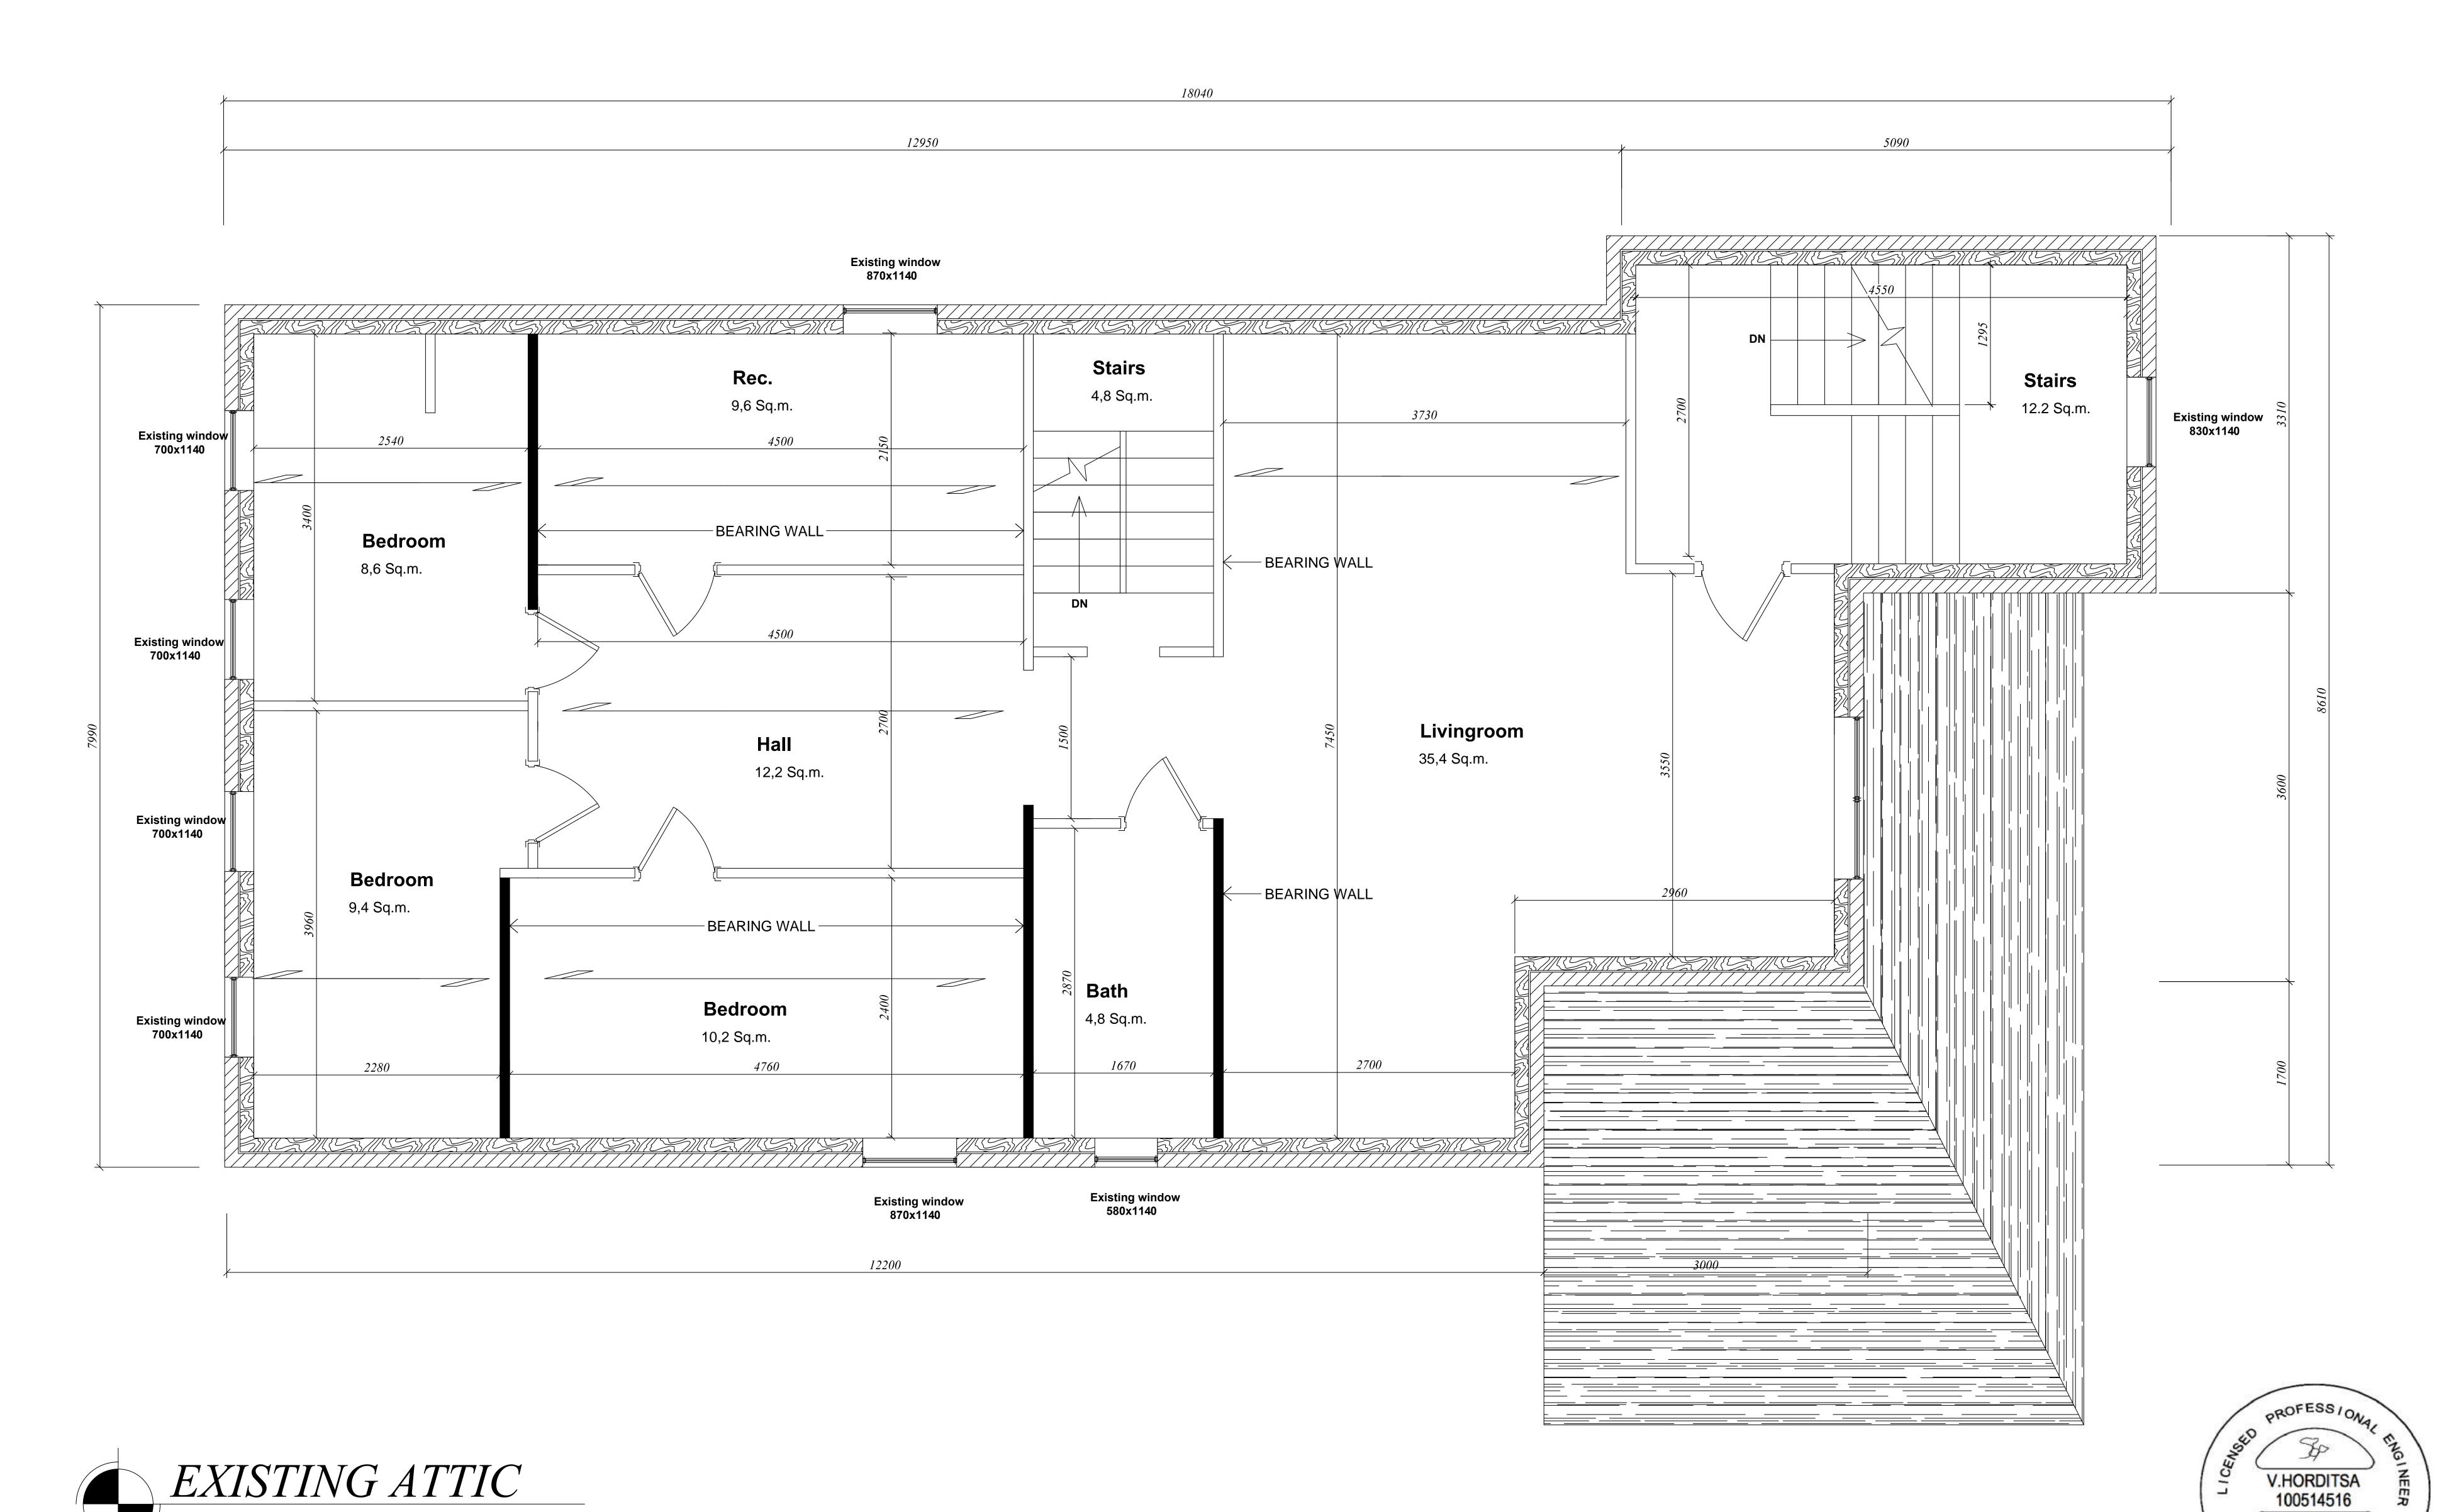
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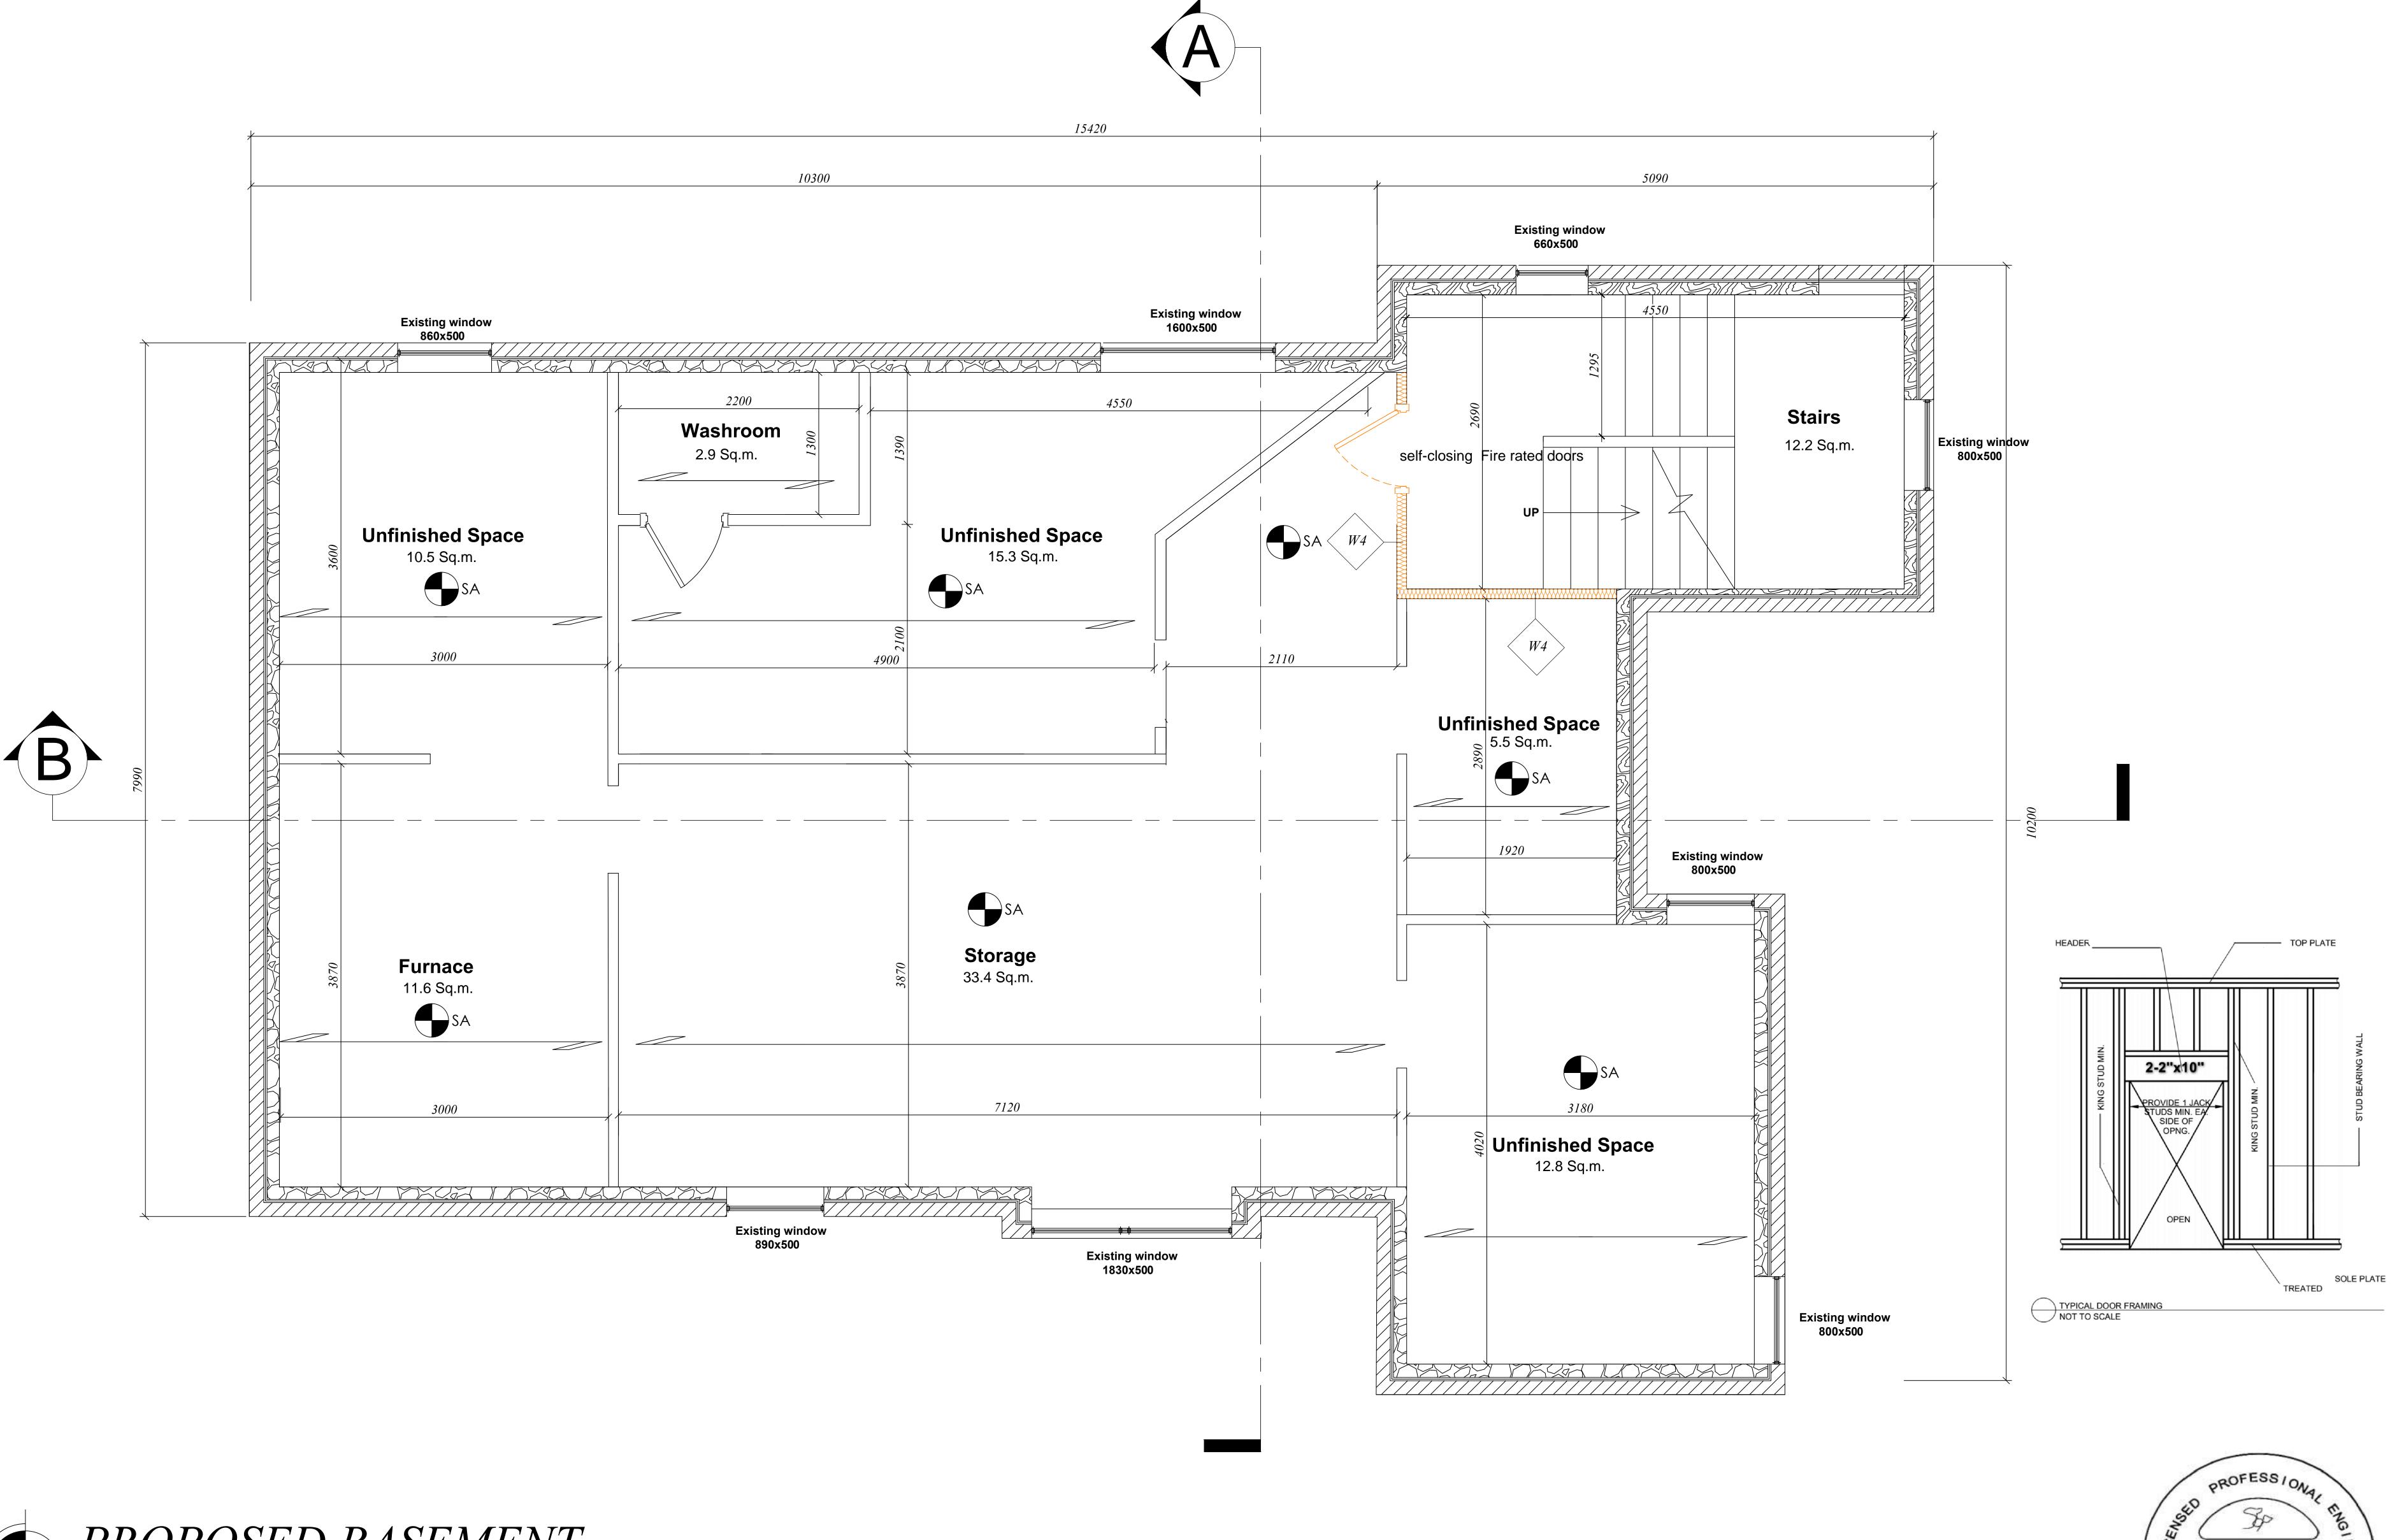
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28 Burris St., Hamilton, ON, L8M, 2J3

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PROPOSED BASEMENT

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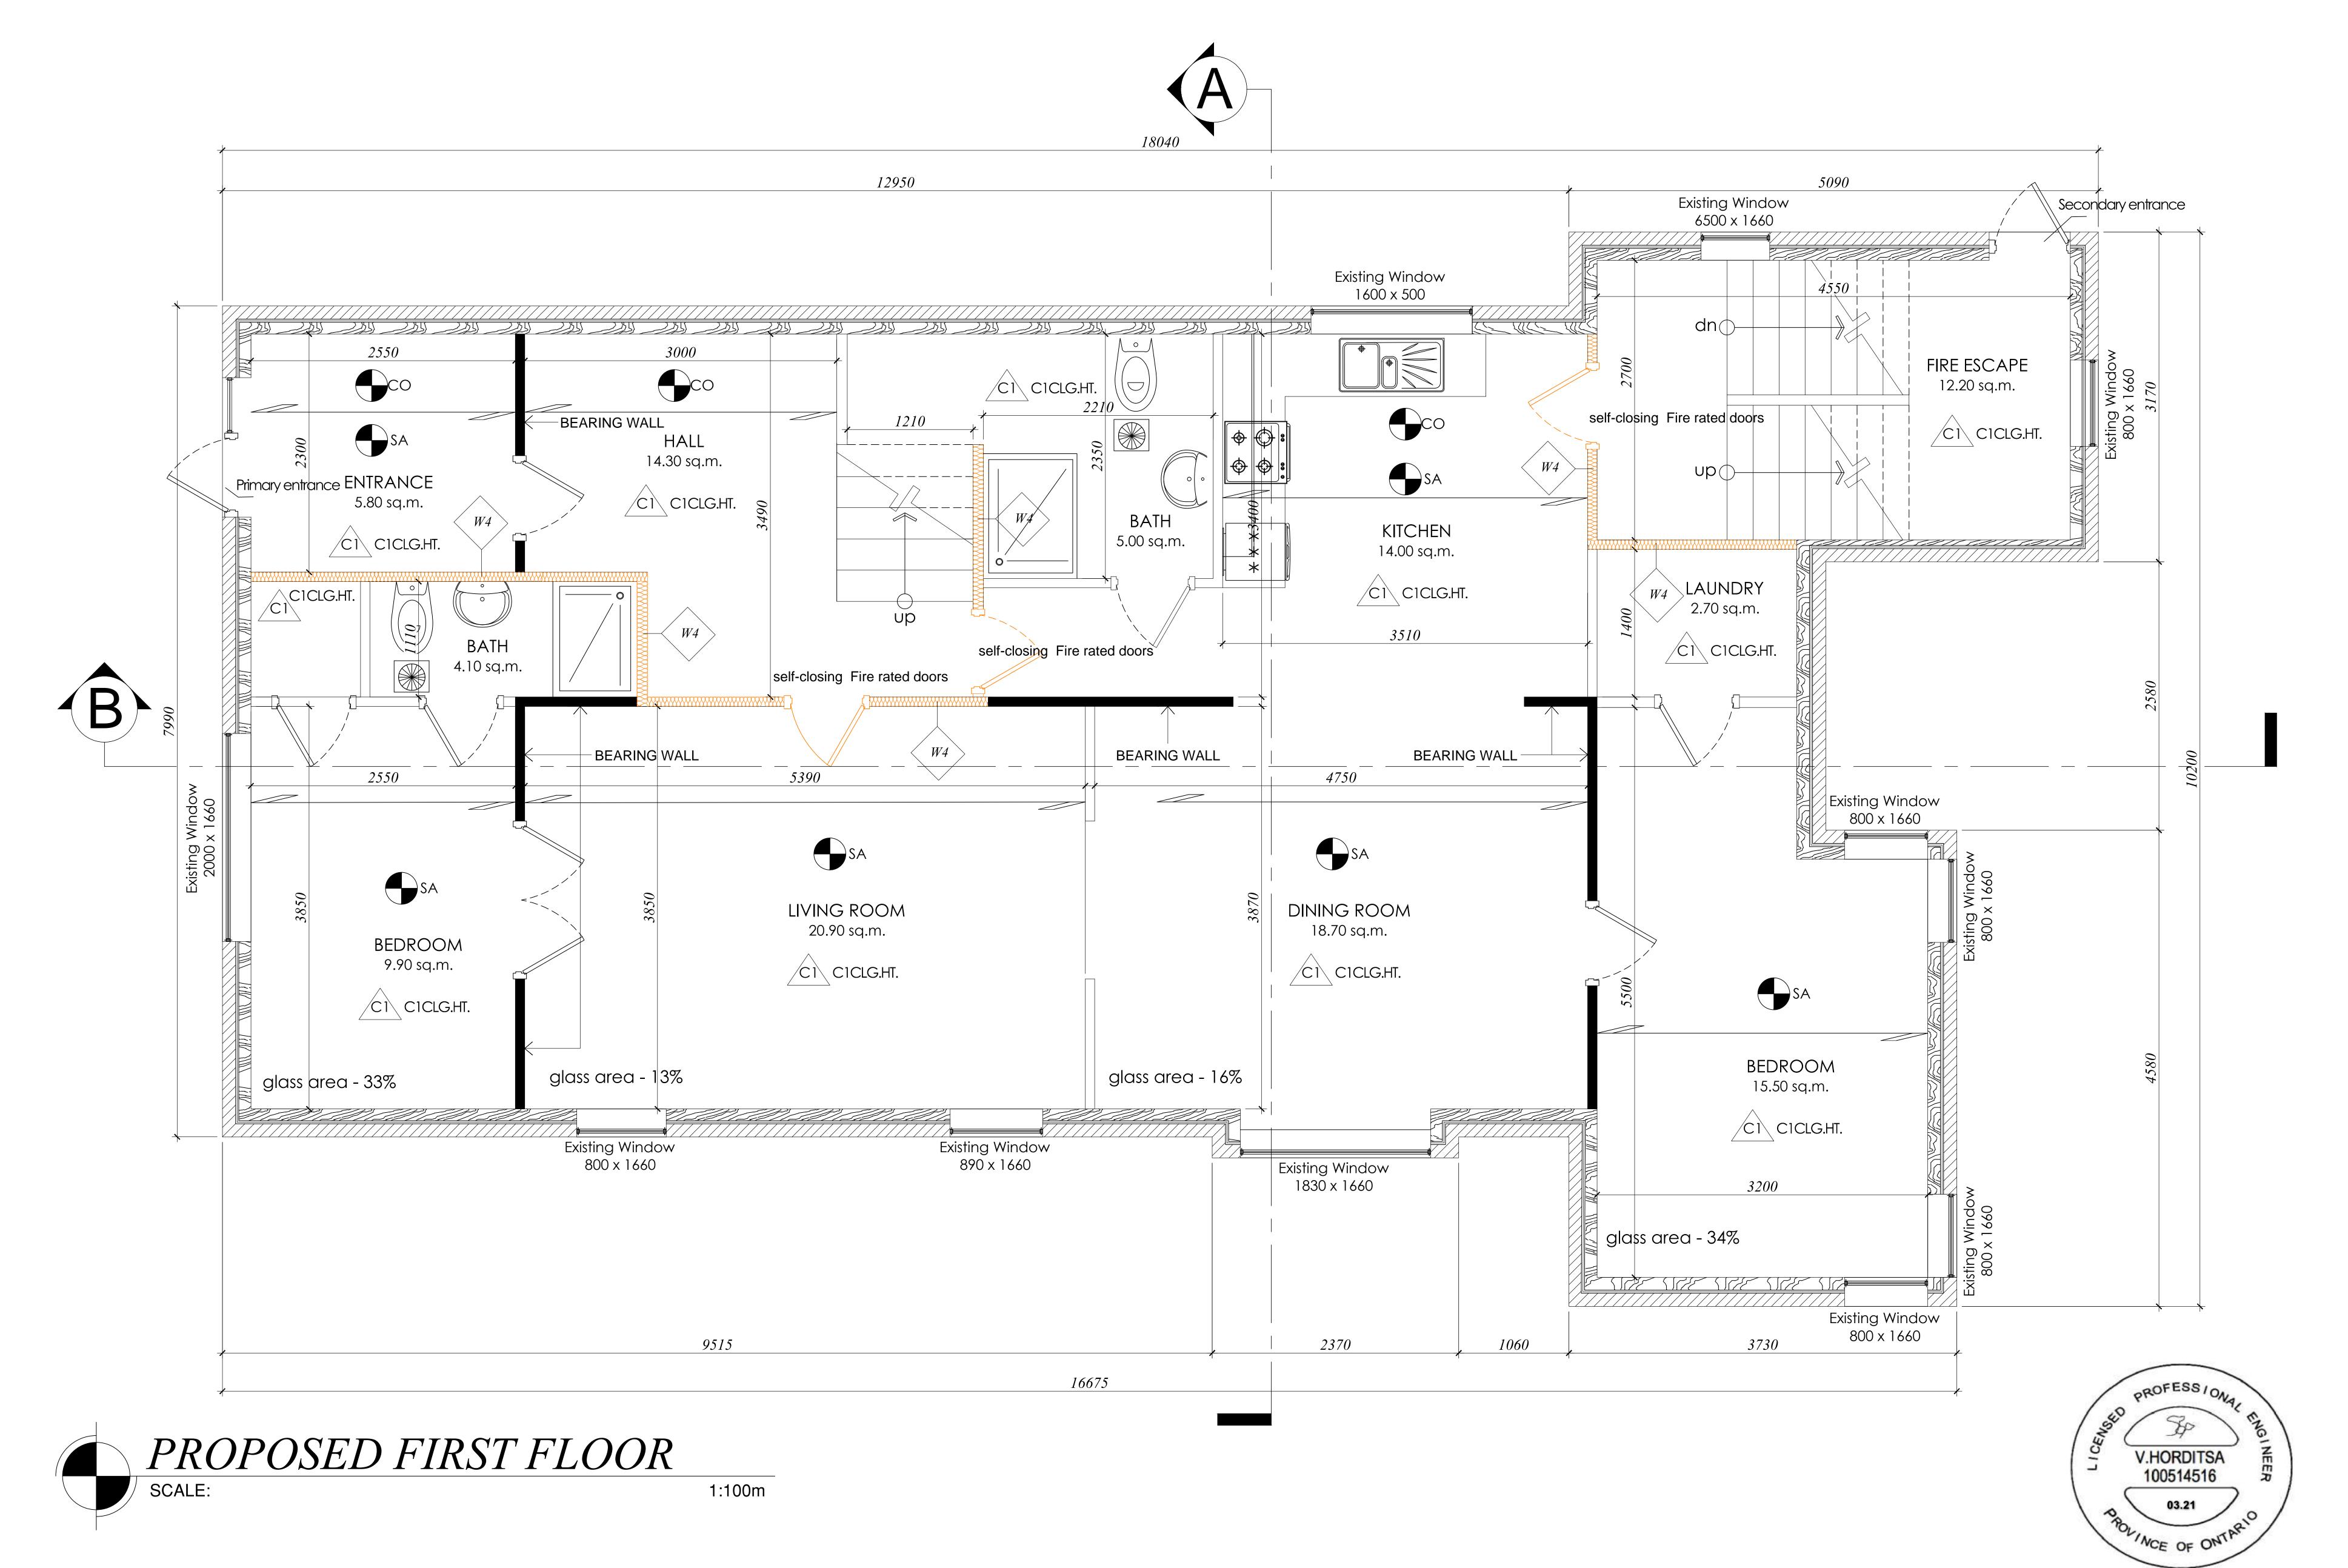
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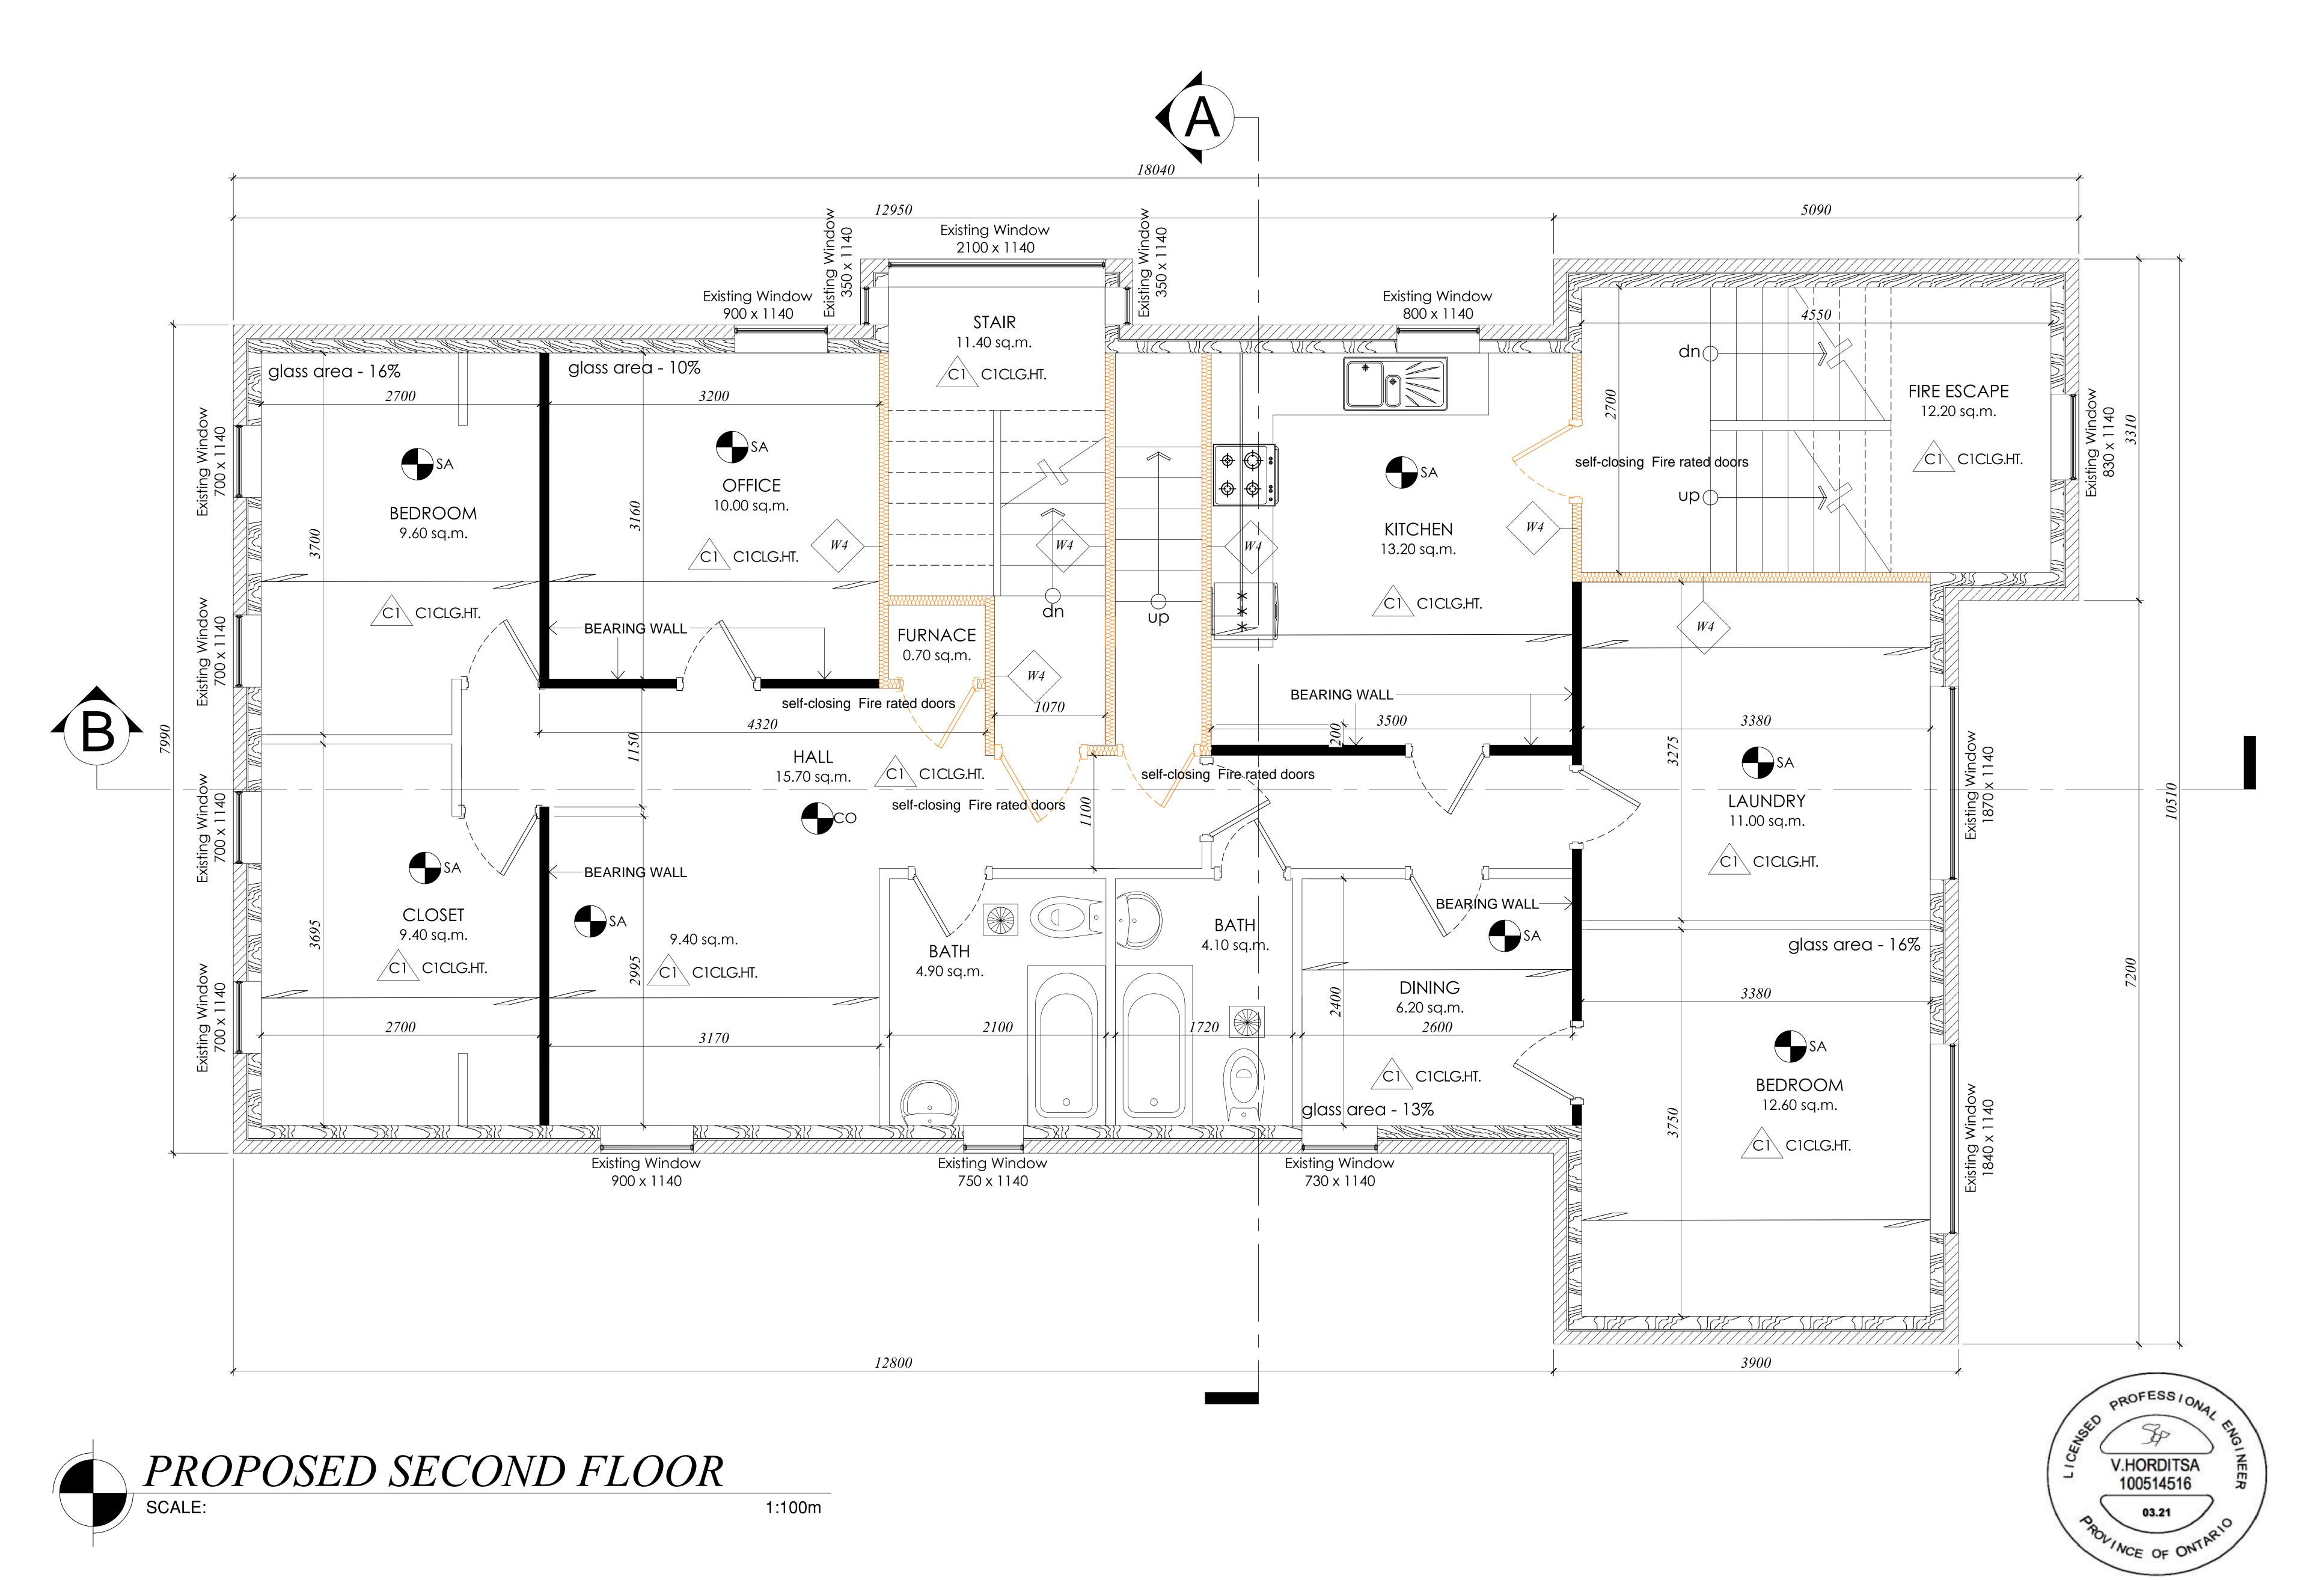
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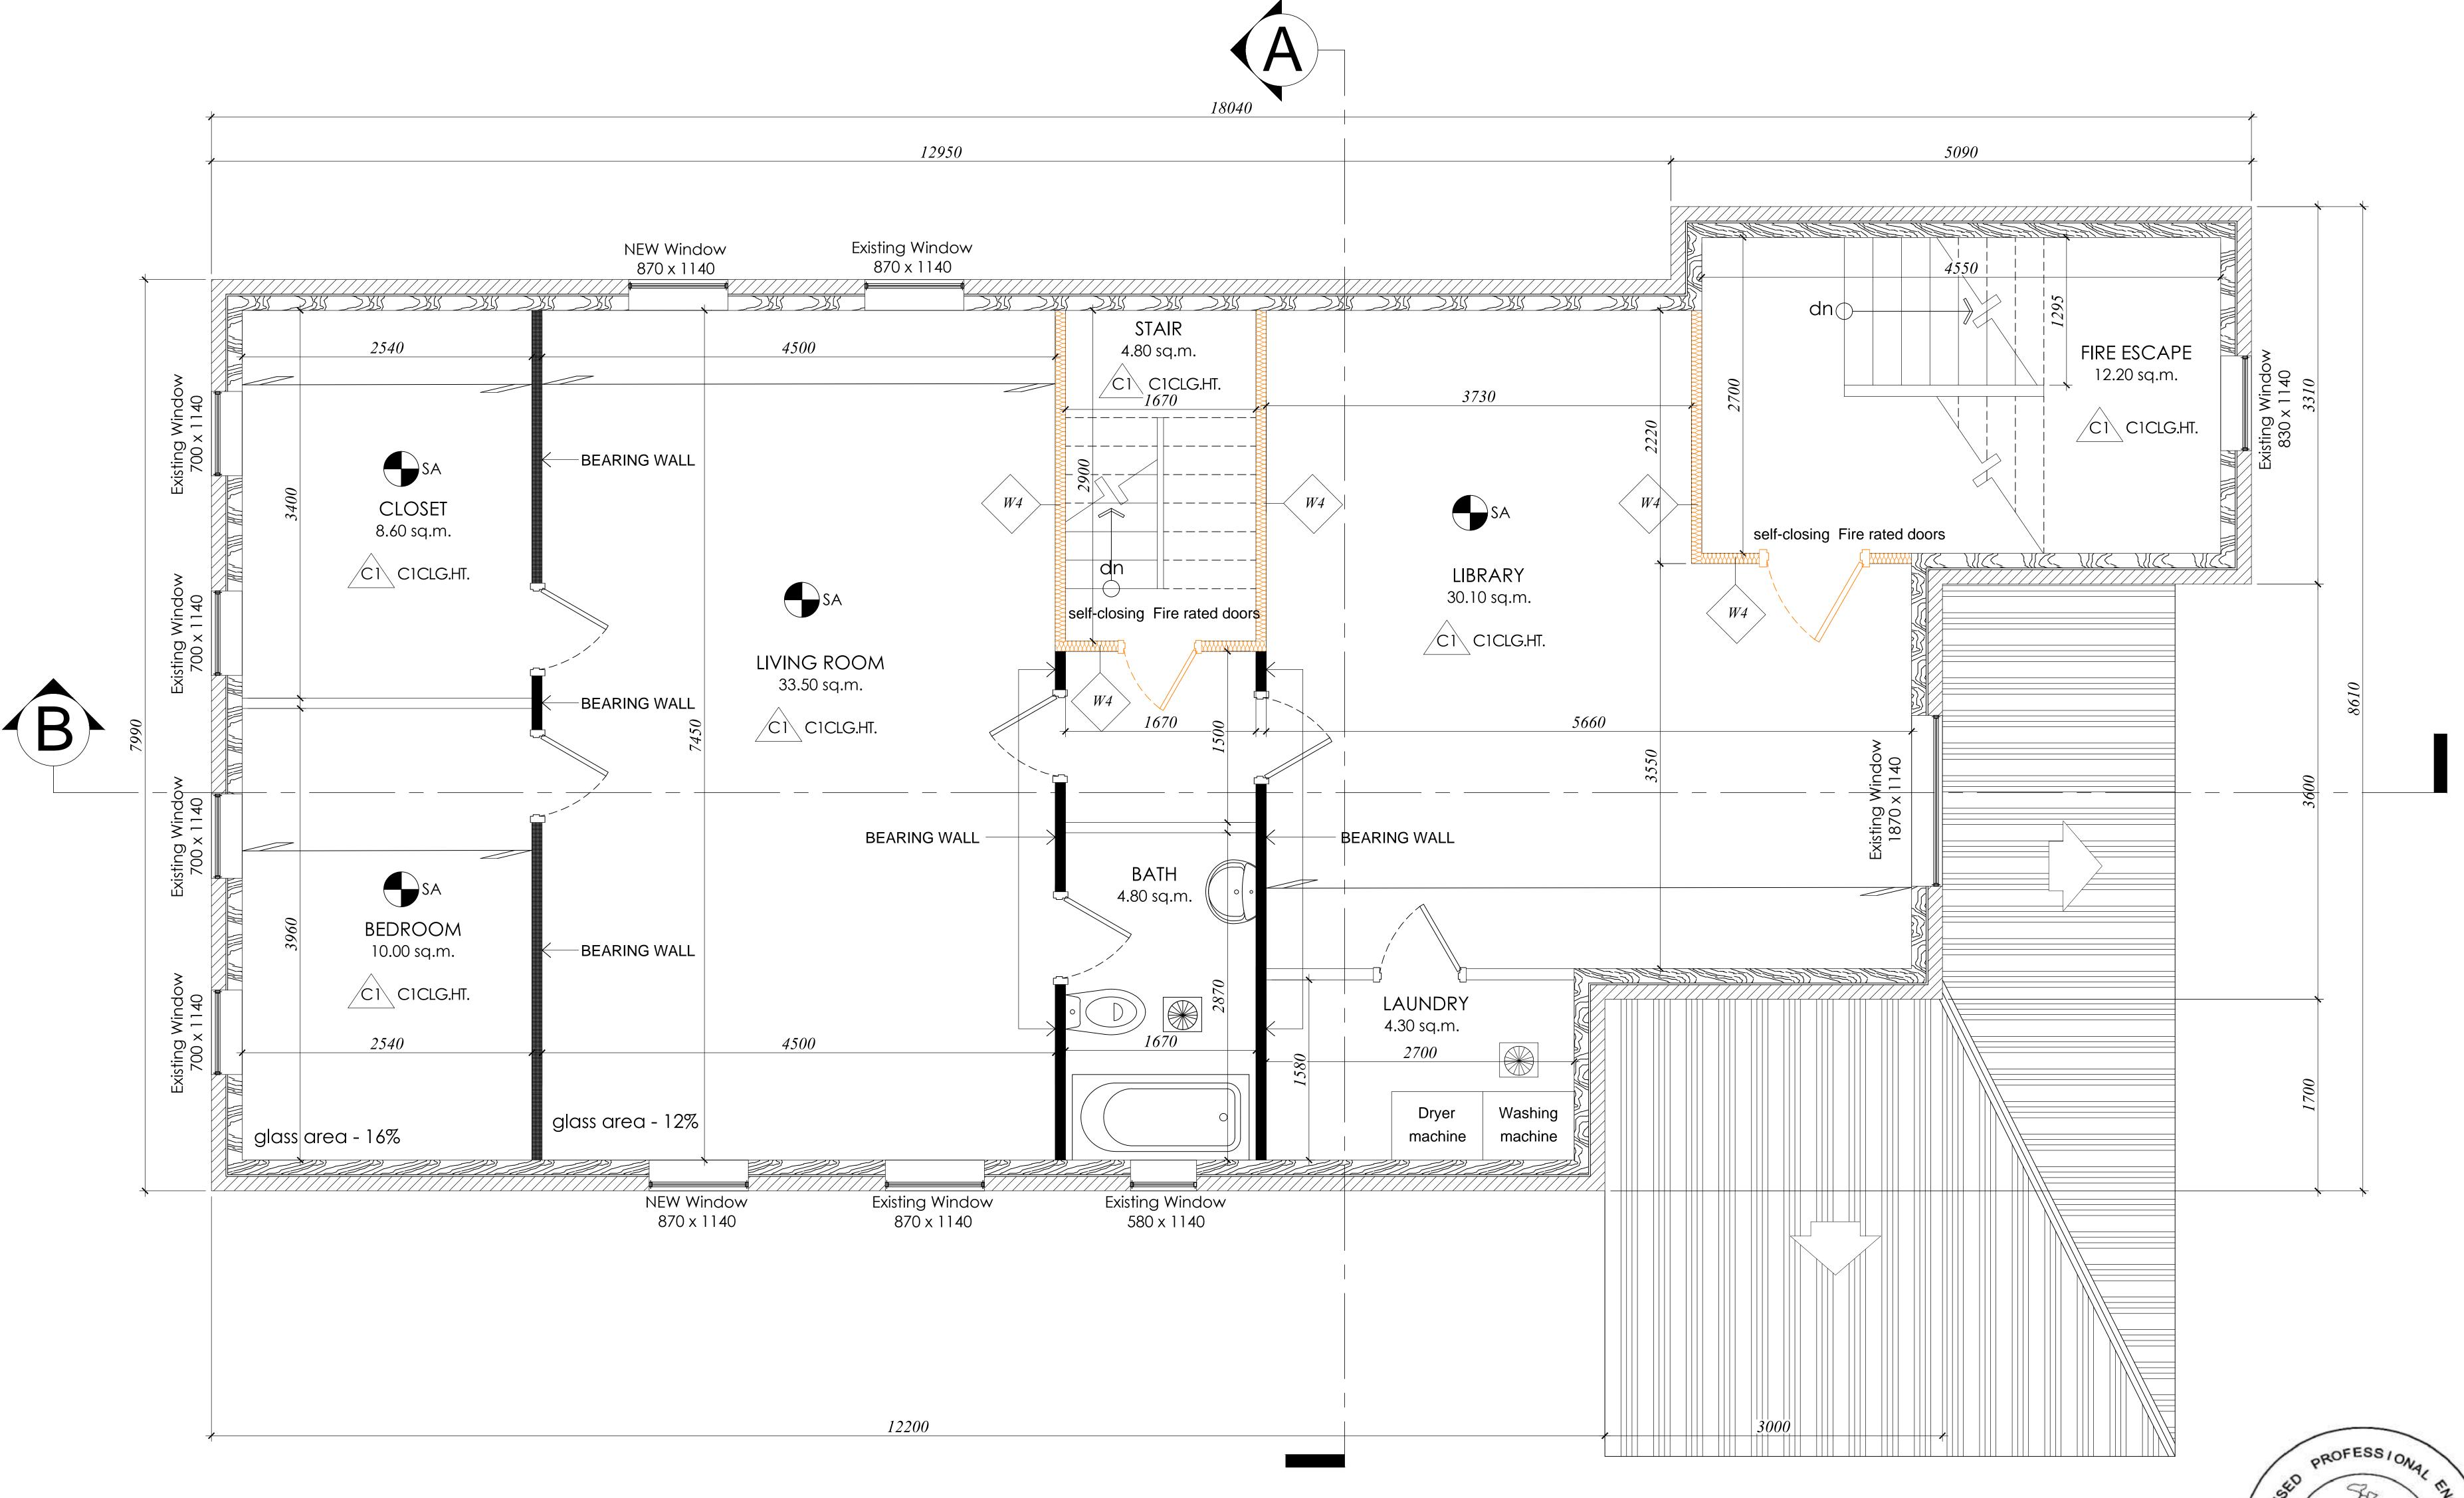
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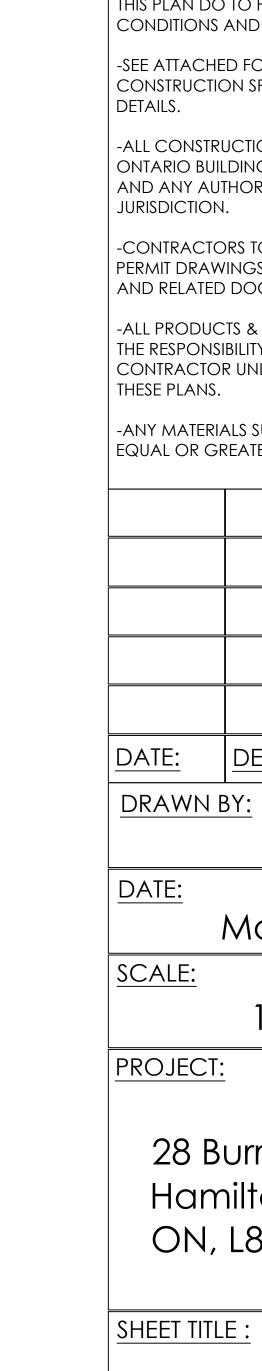
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28 Burris St., Hamilton, ON, L8M, 2J3

PROPOSED ATTIC

SHEET NUMBER:

V.HORDITSA 100514516



PRONT ELEVATION
SCALE: 1:150m

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Mar 15. 2021

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28 Burris St., Hamilton, ON, L8M, 2J3

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SHEET NUMBER :

V.HORDITSA 100514516



2 LEFT-SIDE ELEVATION
SCALE: 1:150m

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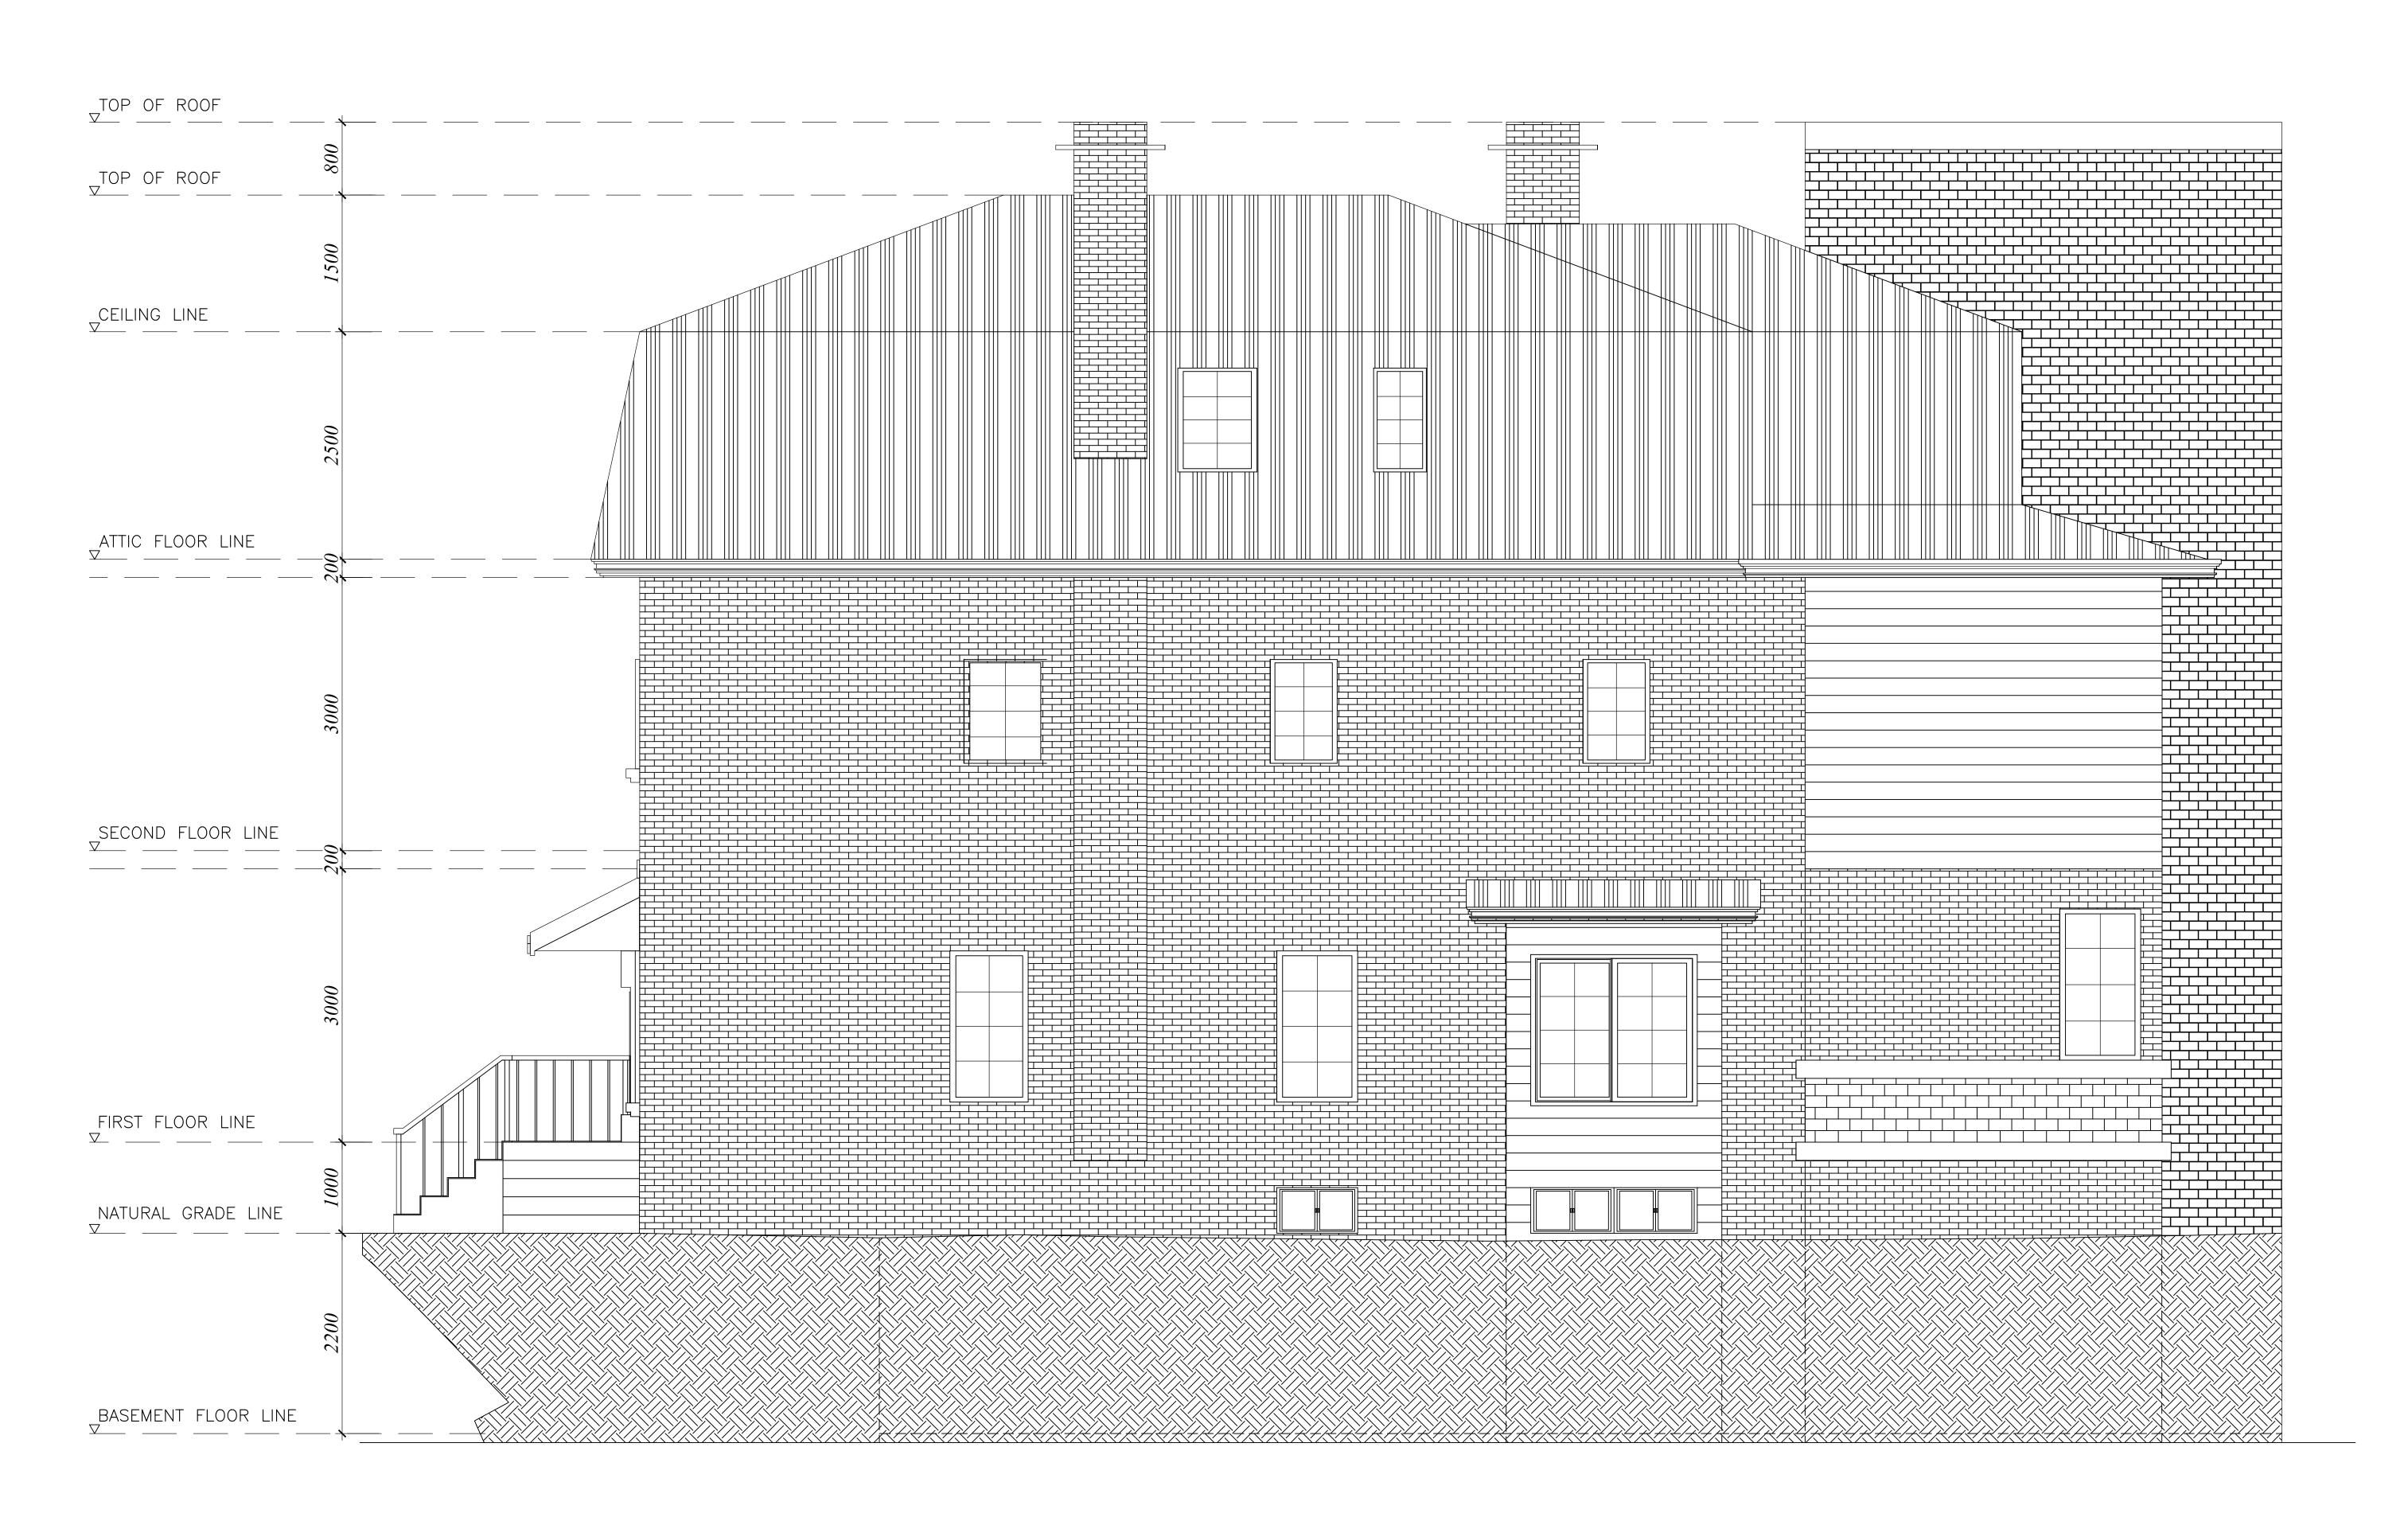
Hamilton, ON, L8M, 2J3

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LEFT-SIDE ELEVATION

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2 RIGHT-SIDE ELEVATION
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Mar 15. 2021

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28 Burris St., Hamilton, ON, L8M, 2J3

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RIGHT-SIDE ELEVATION

SHEET NUMBER:





2 REAR ELEVATION
SCALE: 1:150m

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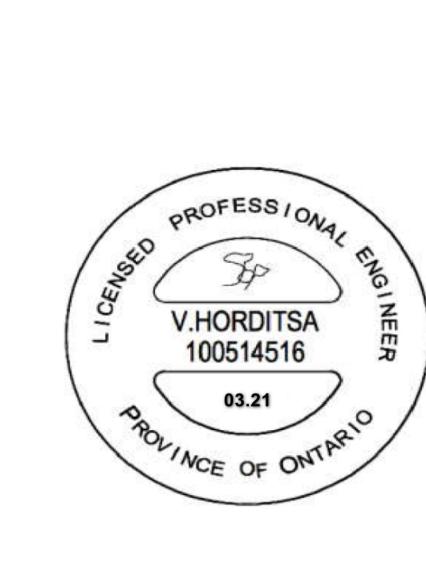
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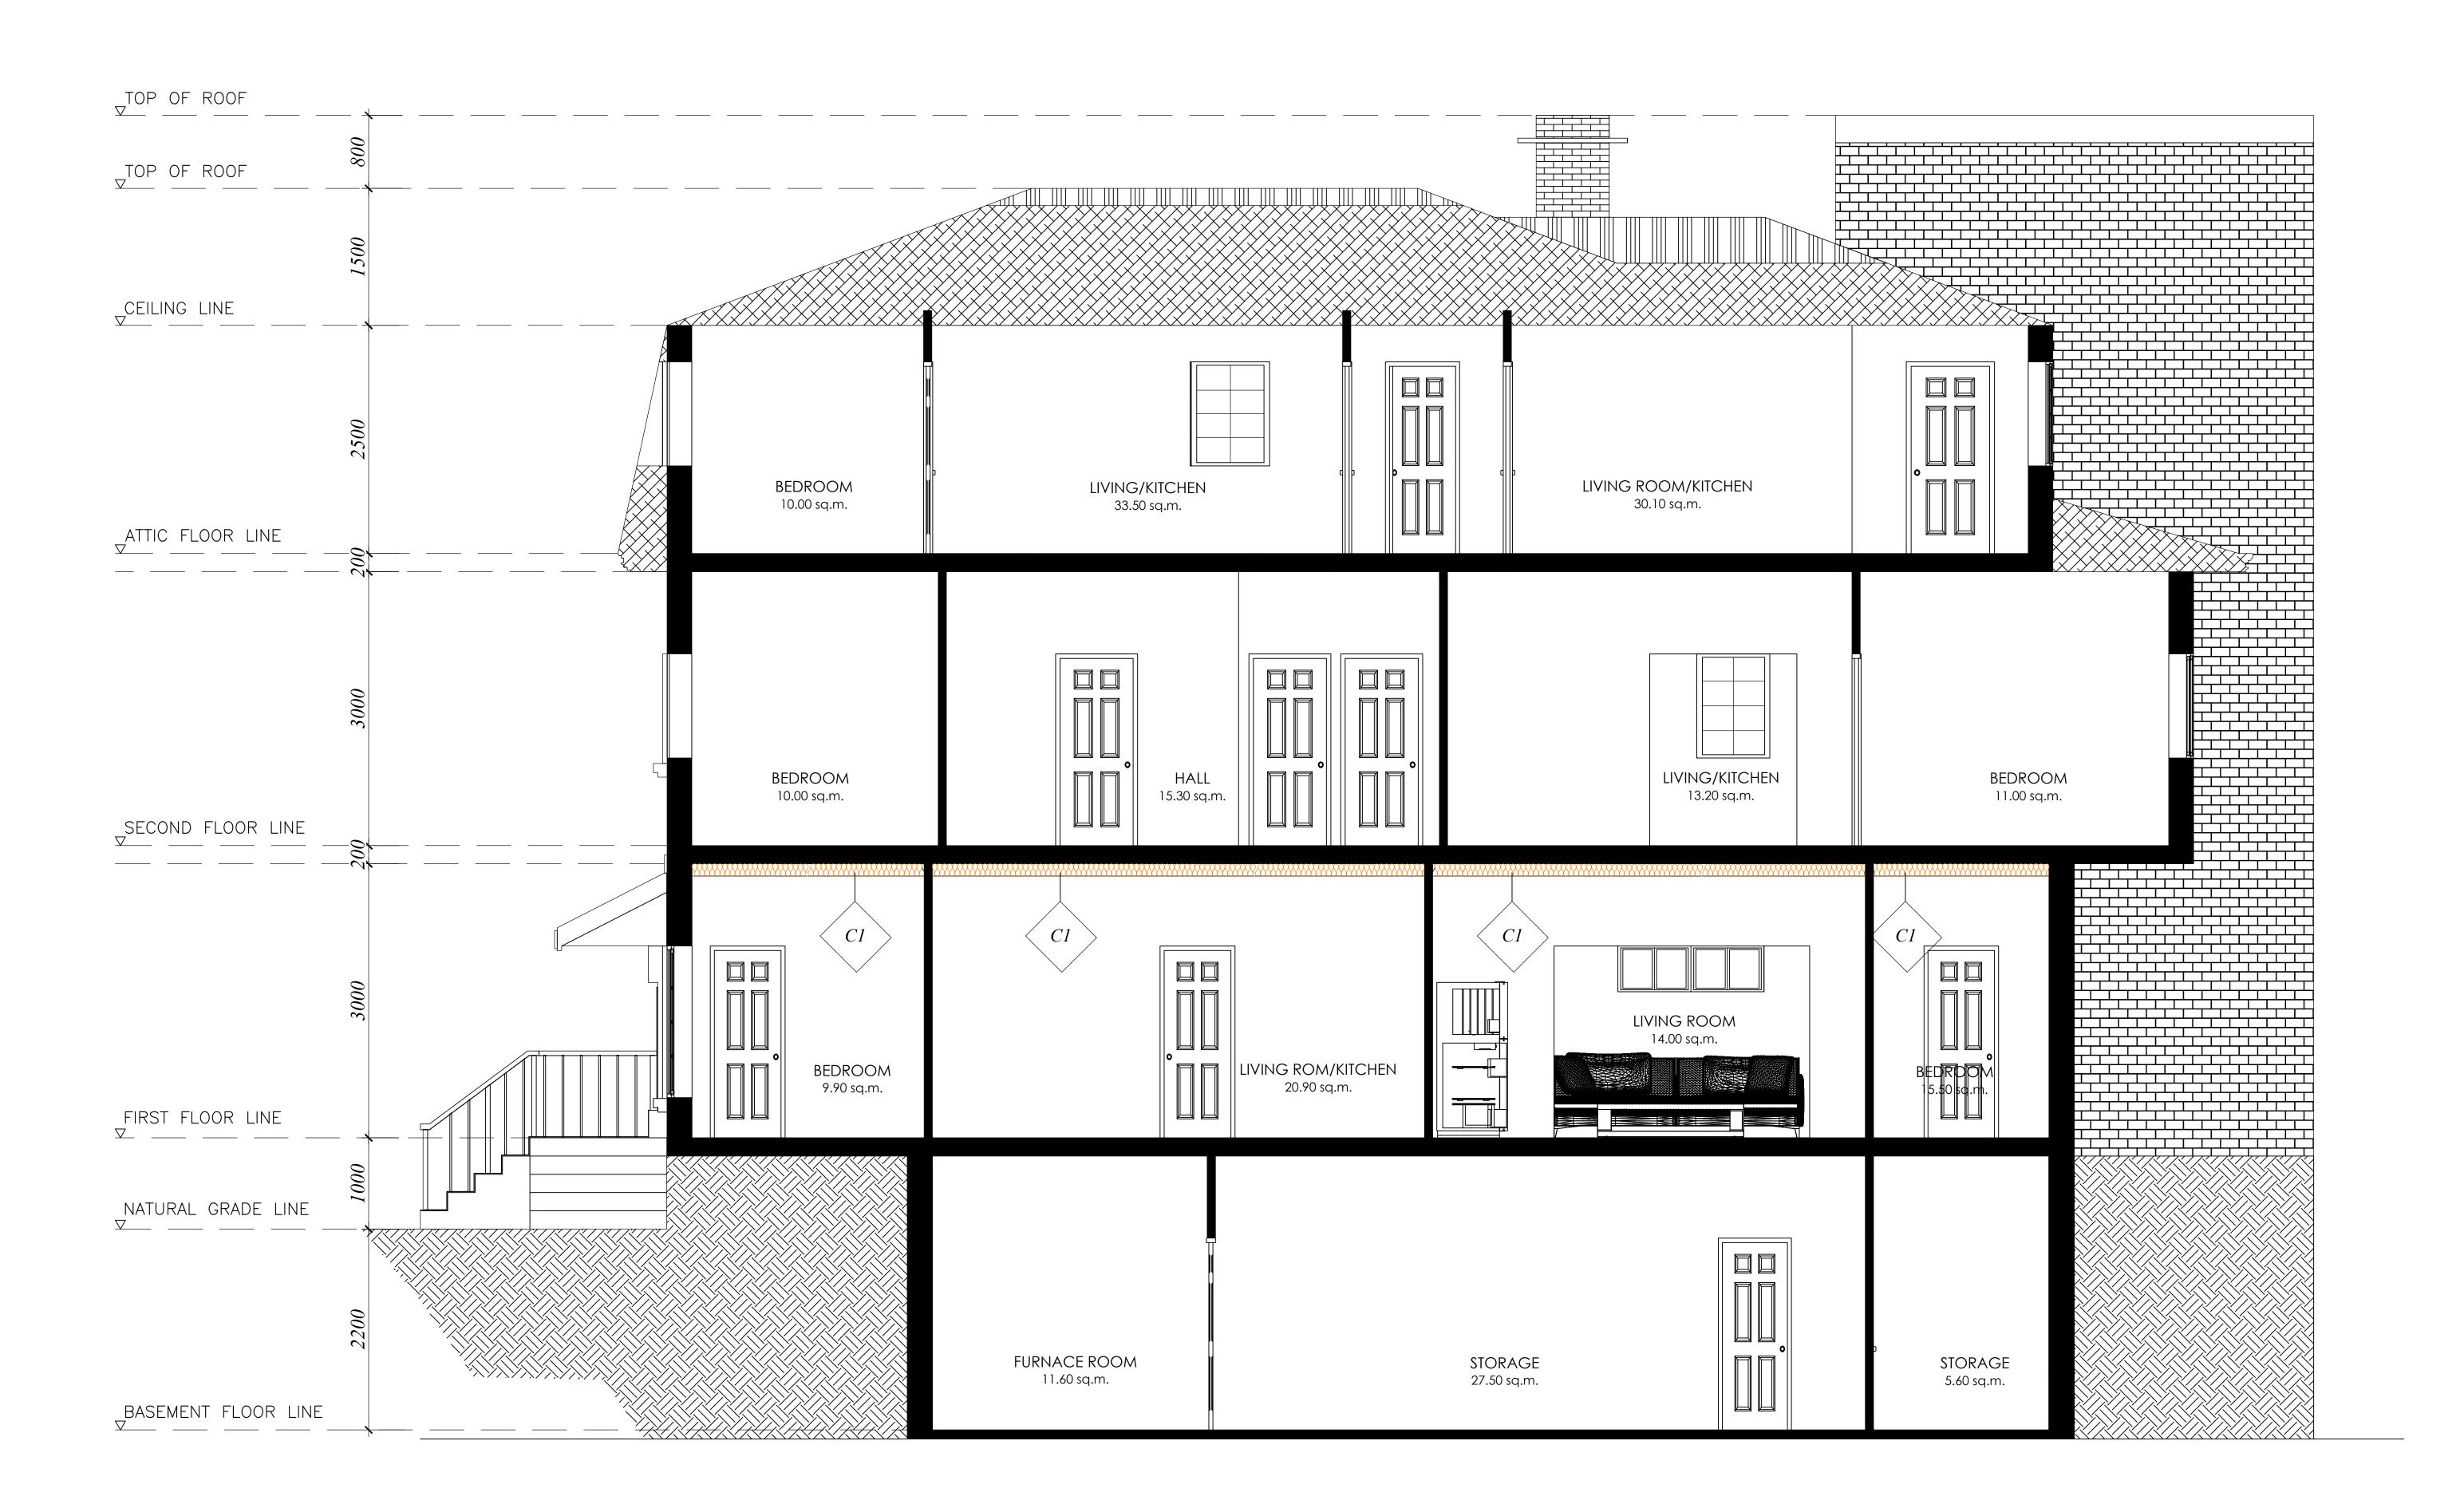
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2 LONGITUDINAL SECTION THRU-B
SCALE:
1:150m



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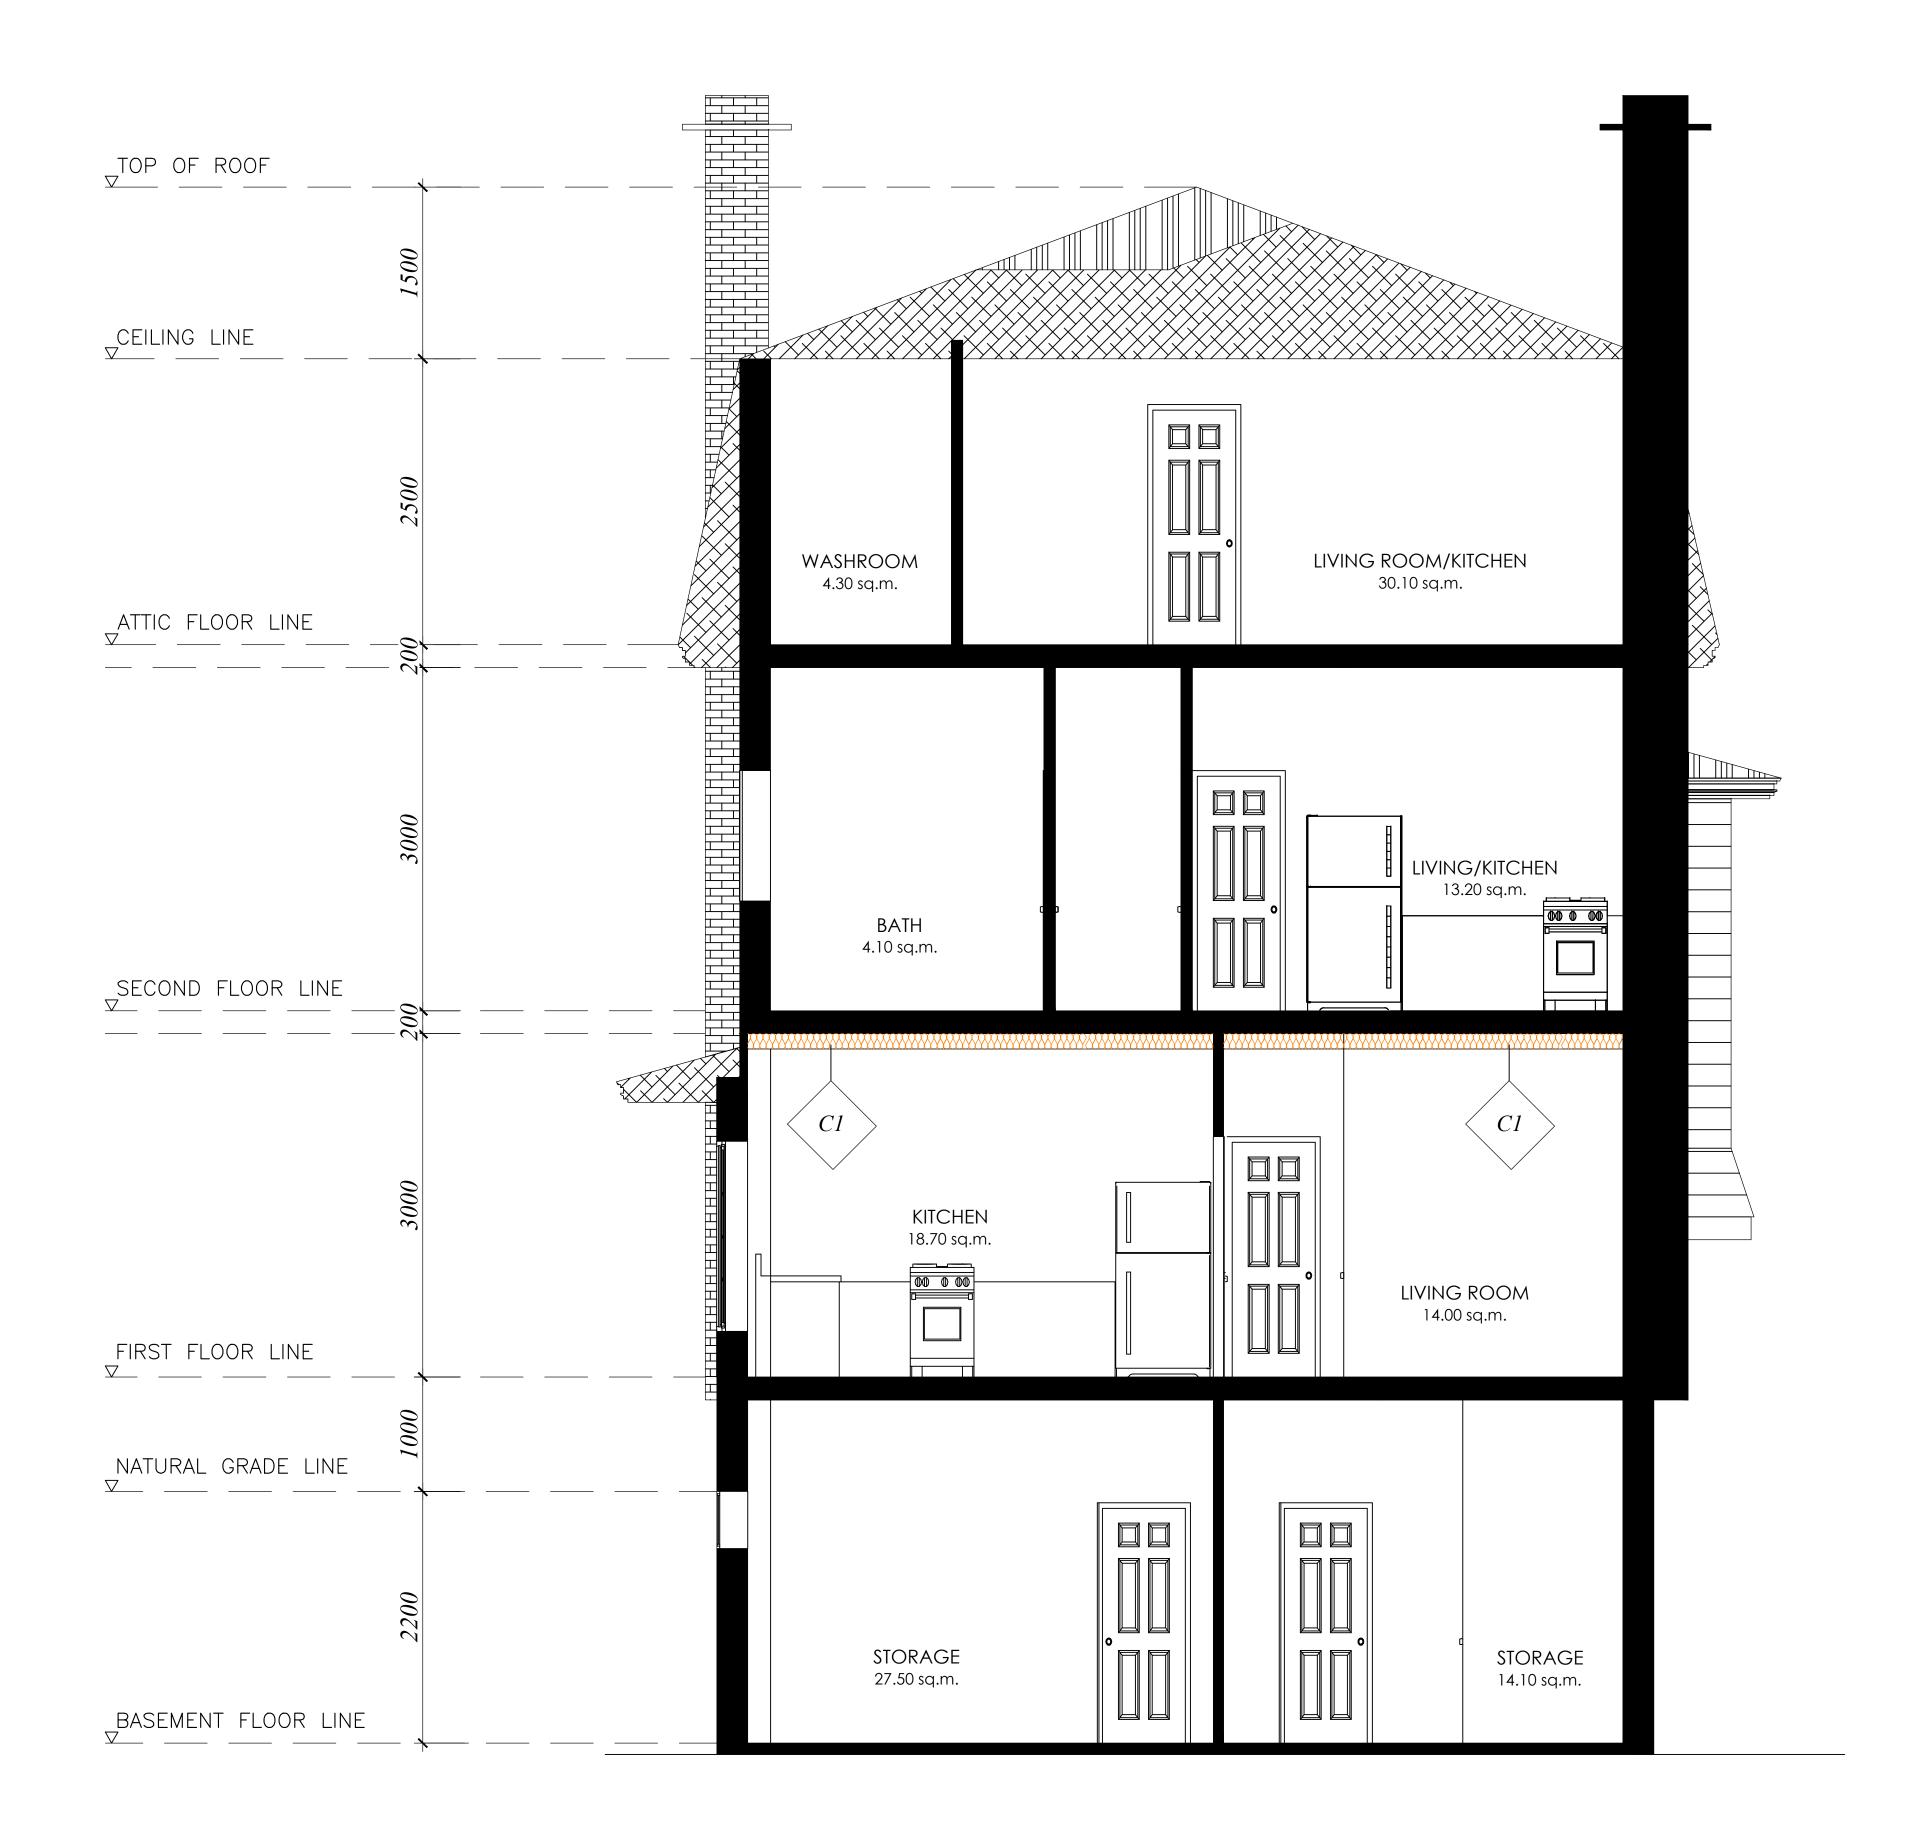
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LONGITUDINAL SECTION THRU-B

SHEET NUMBER:

A3.01



CROSS SECTION THRU-A

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PROJECT:

28 Burris St.,

Hamilton, ON, L8M, 2J3

SHEET TITLE :

CROSS SECTION THRU-A

SHEET NUMBER :

A3.02



MATERIAL SUPPLIES

- DO NOT SCALE DRAWINGS
- REFER TO CONSTRUCTION NOTES FOR ALL SPECIFICATIONS
- OWNERS & CONTRACTORS RESPONSIBLE FOR ALL MEANS & METHODS OF CONSTRUCTION INCLUDING ANY RELATEDD SAFETY PRECAUTIONS
- ALL DIMENSOINS & AS-BUILT INFORMATION TO BEVERIFIED BY CONTRACTORS CONTRACTORS
- ARE RESPOSIBLE FOR ANY MODIFICATIONS TO THE PLAN • CONTRACTORS TO CARRY LIABILITY INSURANCE FOR PERFORMING THE WORK • CONTRACTORS RESPONSIBLE TO ENSURE PROPER SAFETY PRECAUTIONS ARE IN PLACE THROUGHOUT CONSTRUCTION FOR ALL ITEMS RELATED TO ALL CONSTRUCTION METHODS INCLUDING

CODE AND REGULATIONS AND INSPECTIONS

- ALL CONSTRUCTION TO ADHERE TO ONTARIO BUILDING CODE REQUIREMENTS AS WELL AS
- OTHER CODES & AUTHORITIES HAVING JURISDICTION • ADDITIONAL DESIGN & CALCULATIONS TO BE PROVIDED BY OTHER QUALIFIED DESIGNERS
- SUCH AS STRUCTURAL, HVAC, TRUSS, GRADING, SURVEY, ETC... • CONTRACTORS TO ENSURE THAT ALL INSPECTIONS ARE CARRIED OUT AS REQUIRED BY LOCAL BUILDING CODE AUTHORITIES, GENERAL REVIEW COMMITMENTS, AND THIRDPARTY DESIGN *SPECIFICATIONS*

- ENSURE ALL EXCAVATION AVOIDS DAMAGE TO ANY RELATED PROPERTIES, EXISTING STRUCTURES, UTILITIES, ROADS OR SURROUNDING FEATURES.
- CONTRACTOR TO CONFIRM ALL UTILITIES LOCATIONS BEFORE EXCAVATION.
- EXISTING GRADES AND DRAINAGE LOCATIONS TO BE MAINTAINED UNLESS NOTED OTHERWISE STATED OTHERWISE.

PRECATIONS DURING DEMOLITION AND CONSTRUCTION:

- EXISTING STRUCTURE(S) TO BE PROTECTED DURING CONSTRUCTION FROM ANY WEATHER ISSUES, SECURITY OR RELATED DAMAGES.
- VERIFY/REINFORCE EXISTING SUPPORT SYSTEMS, INCLUDING FOUDATIONS THOUGHOUT **CONSTRUCTION**

PREFABRICATED ITEMS AND ORDERING OF MATERIALS:

- ALL PREFABRICATED ITEMS TO BE SITE VERIFIED PRIOR TO CONSTRUCTION
- SHOP DRAWINGS FOR PREFRABICATION ITEMS TO BE SUPPLIED BY OTHERS.
- REFER TO RELEVANT DOCUMENTS FOR DIMENSIONS AND INSTALLATION REQUIREMENTS

UTILITIES, SERVICES, AND EASEMENTS.

• CONTACT ALL LOCAL AUTHORITIES HAVING JURISDICTION TO GAS, ELECTRICAL, WATER, SANITARY, EASEMENTS, AND OTHER RELATED ITEMS WHERE APPLICABLE

STRUCTURAL (INCL. BEAMS & POSTS):

- REFER TO PLANS FOR ALL BEAMS AND POST SIZES
- ALL MEMBERS SHALL BE FRAMES, ANCHORED, FASTENED, TIED AND BRACED TO PROVIDE THE NECESSARY STRENGTH AND RIGIDITY
- ALL STRUCTURAL LOADS TO BE CONTINUOUS & VERTICAL WITH SOLID BEARING THROUGH THE **FOUNDATION**
- MIN 3 1/2" SOLID BEARING FOR ALL WOOD BEAMS 2-PLY OR LESS
- MIN 5 1/2" SOLID BEARING FOR STEEL & WOOD BEAMS 3-PLY OR GREATER
- ALL STRUCTURAL POSTS TO BE SAME WIDTH AS MEMBER THEY SUPPORT • PROVIDE SOLID CONCRETE FOR 2 COURSES FOR ALL BEAMS AND POST BEARING ON MASONRY
- ALL LAMINATED VENEER LUMBER (LVL) BEAMS, GIRDER TRUSSES, AND METAL HANGER CONNECTIONS SUPPORTING ROOF FRAMNG TO BE SESIGNED AND CERTIFIED BY TRUSS

TREE PROTECTION.

MANUFACTURER.

• NO CONSTRUCTION ACTIVITY IS PERMITTED WITH IN TREE PROTECTION ZONES WITHOUT APPROVAL FROM LOCAL FORESTRY DEPARTMENT.

INSPECTION

: • CONTRACTORS ARE RESPONSIBLE TO ARRANGE FOR REQUIRED INSPECTIONS BY LOCAL BUILDING AUTHORITIES AND/OR STRUCTURAL ENGINEER WHERE APPLICABLE FOR GENERAL REVIEW COMMITMENT

OTHER DESIGN DRAWINGS:

• OTHER DESIGN DRAWINGS REQUIRED FOR PERMIT RELATED APPROVALS TO BE PREPARE PRIOR TO ANY WORK. THESE MAY INCLUDE, BUT ARE NOT LIMITED TO HVAC DESIGN, ENGINEER ROOF DESIGN, SOILS REPORTS, ETC...

WOOD DECK

- 1"x4"P.T. WOOD DECKING ON DECK JOISTS
- PRESSURE TREATED DECK JOISTS AND BEAMS AS PER PLAN
- P.T. POST ANCHORED TO METAL SHOE WITH ½"BOLTS ON CONCRETE PIER
- REFER TO SB-3 OF OBC FOR ALL TYP. SPECIFICATIONS REGARDING RAILINGS, GUARDS AND CONNECTION DETAIL

(2) FRAMING AND STRUCTURAL NOTES

FLOORS:

- FLOOR JOISTS TO HAVE MIN 1 1/2" BEARING
- APPROVED STEEL HANGERS WHERE FLUSH MOUTING
- DOUBLE JOISTS OR BLOCKING UNDER PARALLEL NON-LOADBEARING WALLS
- NOTE ABOUT CONCRETE TOPPONG
- UNHEATED BELOW
- PROVIDE SILL PLATES (MIN 2"x4") ANCHORED TO ALL MASONRY AND FOUDATION WALLS WITH APPROVED SILL GASKET

\underline{WALLS} :

- WALL JOISTS TO HAVE MIN 1 1/2" BEARING
- APPROVED STEEL HANGERS WHERE FLUSH MOUTING
- DOUBLE JOISTS OR BLOCKING UNDER PARALLEL NON-LOADBEARING WALLS
- NOTE ABOUT CONCRETE TOPPONG
- UNHEATED BELOW

PARTITIONS:

- BLOCKING MID HEIGHT FOR ALL UNFINISHED WALLS
- PROVIDE BLOCKING BELOW @48" O.C. (BETWEEN PARALLEL JOISTS UNDER NONLOADBEARING WALLS)
- LUMBER IN CONTACT WITH CONCRETE SHALL BE SEPARATED FROM THE CONCRETE WITH 2MIL POLY, NO 50(45LBS) ROLL ROOFING PAPER, OR OTHER DAMPROOFING MATERIALS, EXCEPT WHERE THE WOOD MEMBER IS MORE THAN 6" ABOVE GROUND

BEAMS/POSTS

- REFER TO PLANS FOR ALL BEAMS AND POSTS SIZES NOTES:
- MIN 3 1/2" SOLID BEARING FOR ALL WOOD BEAM 2-PLY OR LESS
- MIN 5 1/2" SOLID BEARING FOR STEEL BEAM AMD WOOD BEAM 3-PLY OR GREATER • ALL STRUCTURAL POSTS TO BE THE SAME WIDTH AS MEMBER THER SUPPORT
- PROVIDE SOLID CONCRETE FOR TOP 2 COURSES FOR ALL BEAMS AND POSTS BEARING ON MASONRY WALLS
- ALL BEAMS AND POSTS TO HAVE SOLID BEARING WITH LOADS CONTINUOUS THROUGH
- FIELD WELD FOR ALL STEEL BEAM-BEAM CONNECTION. WELDING OR BOLTED CONNECTIONS ACCEPTABLE FOR STEEL POST-BEAM CONNECTIONS.
- ENGINEER APPROVED JOITS HANGERS AND FASTENERS WHERE REQUIRED FOR JOIST AND
- ALL LAMINATED VENEER LUMBER (LVL) BEAMS, GIRDER TRUSSES, AND DESIGNED & CERTIFIED
- BY BY TRUSS MANUFACTURER. • ENSURE QUALITY OF EXISTING MASONRY WALLS IS ADEQUATE FOR ALL LOADS WHERE REQUIRED

MASONRY WALLS:

- PROVIDE SOLID MASONRY FILLED TOP COURSE WITH CONTINUOUS 2"x4" SILL PLATE UNDER ALL FRAMING MEMBER
- REPAIR AND/OR PARGE AS NEEDED FOR ALL EXISTING MASONRY WALLS
- FOR REDUCED FOUDATION WALL THICKNESS TO ALLOW BRICK VENEER (WHILE MARINATING LATERAL SUPPORT)
- MASONRY OVER OPENINGS SHALL BE SUPPORTED WITH SHOP PRIMED STEEL LINTELS (MIN 6" BEARING)



FLOOR ASSEMBLY (FRAMED)

FLOOR ASSEMBLY:

- FINISHED FLOORING
- ¾"PLYWOOD FLOORING
- FLOOR JOISTS, TRIMMERS, HEADERS, AND BEAMS AS PER PLAN
- CROSS BRIDGING @ 6'-11"O.C. FROM OTHER BRIDGING OR END SUPPORTS
- ½"TAPED DRYWALL OR 1"X3"STRAPPING

FLOOR EXPOSED TO EXTERIOR

- 6MIL CONTINUOUS POLY
- MIN R31 BATT OR FOAM INSULATION
- R5ci (VAPOUR PERMEABLE) RIGID FOAM INSULATION • EXTERIOR GRADE PLYWOOD OR ALUMINUM SOFFIT

SILL PLATES

- 2"x4"FASTENED TO TOP OF WALL ANCHOR BOLTS
- FOAM GASKET OR 6MIL POLY TO SEPARATE PLATE FROM WALL • LEVEL SILL PLATE WITH NON-SHINK GROUT AS REQUIRED

• FLOOR JOISTS TO HAVE MIN 1 ½"BEARING

- VERIFY JOISTS SPECIFICATIONS WHERE CONCRETE TOPPING APPLIES APPROVED STEEL HANGER WHERE FLUSH MOUNTING
- DOUBLE JOISTS OR BLOCKING UNDER PARALLEL NON-LOADBEARING WALLS • ENSURE ALL BEAMS HAVE MIN SOLID BEARING
- **WOOD DECK**
- 1"x4"P.T. WOOD DECKING ON DECK JOISTS
- PRESSURE TREATED DECK JOISTS AND BEAMS AS PER PLAN
- P.T. POST ANCHORED TO METAL SHOE WITH ½ "BOLTS ON CONCRETE PIER NOTES:
- REFER TO SB-7 OF OBC FOR ALL TYP. SPECIFICATIONS REGARDING RAILINGS

(4) STAIR / HANDRAILS / GUARDS

- MIN HEAD ROOM: 6'-5"
- MIN WIDTH: 2'-10"
- RISER LIMITS: 4 7/8"-7 7/8"
- RUN LIMITS: 8 1/4"-14"
- TREAD LIMITS: 9 1/4"-14" • ONE SET OF WINDERS BETWEEN EACH FLOOR LEVEL (MAX 30"PER WINDER & MIN 48"BETWEEN SETS OF WINDERS
- LANDINGS REQUIRED FOR ALL DOOR SWINGS OVER STAIR
- RISE AND RUN DIMENSIONS TO BE UNIFORM FOR ALL FLIGHTS

<u>HANDRAILS</u>


- CONTINUOUS HANDRAILS FOR ALL STAIR WITH 3 OR MORE RISERS
- *MAXIMUM HEIGHT: 34"–38"*


GUARDS:

- GUARDS REQUIRED FOR ALL AREAS WITH 3 OR MORE RISERS OR ADJACENT LEVEL EXCEED 24"
- NO MEMBERS TO FACILITATE CLIMBING BETWEEN 4"& 35 1/2"
- MAX 4"SPACING BETWEEN PICKETS
- MIN INTERIOR GUARD HEIGHT TO BE 35 ½ "@ LANDINGS & STAIRS

- REFER TO OBC TABLE 9.8.8.2 FOR LOAD SPECIFICATIONS LOADS GUARDS NOTES FOR ALL EXTERIOR STAIRS:
- CONCRETE STAIRS WITH 3 OR MORE RISERS REQUIRED FOUNDATIO
- WOOD STAIR SHALL NOT BE IN DIRECT CONTACT WITH GROUND UNLESS TREATED TO PREVENT DECAY OR RESTING ON CONCRETE PAD

• REFER TO OBC SB-3 DETAILS FOR ALL SPECIFICATIONS FOR EXTERIOR GUARDS AND HANDRAILS CONNECTION

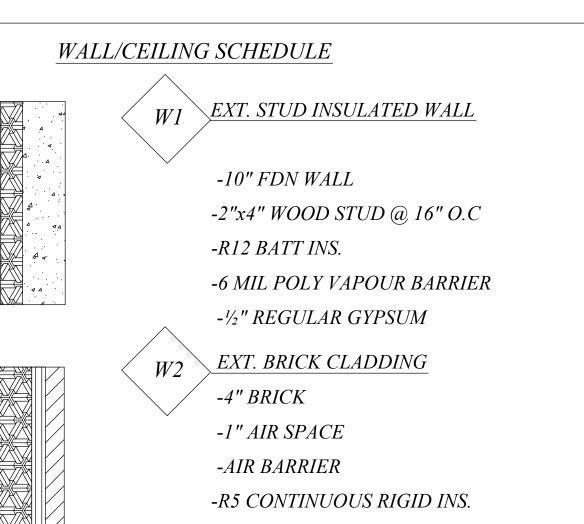

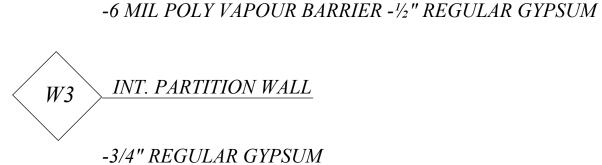



-2"x4" WOOD STUD @ 16" O.C

-1/2" REGULAR GYPSUM

INT. PARTITION WALL


-2"x4" WOOD STUD @ 16" O.C -R19 BATT INS.

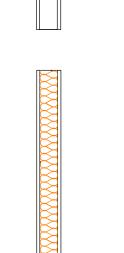


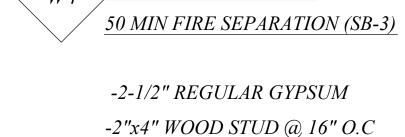


-3" SOUND INSULATION -2-1/2" REGULAR GYPSUM C1 FULL HEIGHT CEILING

50MIN FIRE SEPARATION (SB-3)

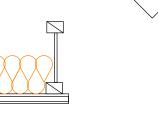

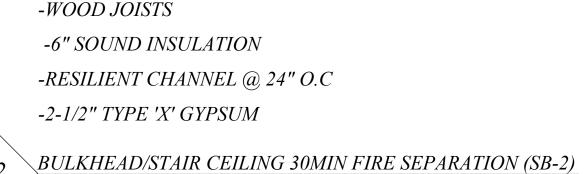

2 LAYERS OF 1/2" TYPE 'X' GYPSUM (NOTE: NO OPENING PERMITTED THIS MEMBRANE)

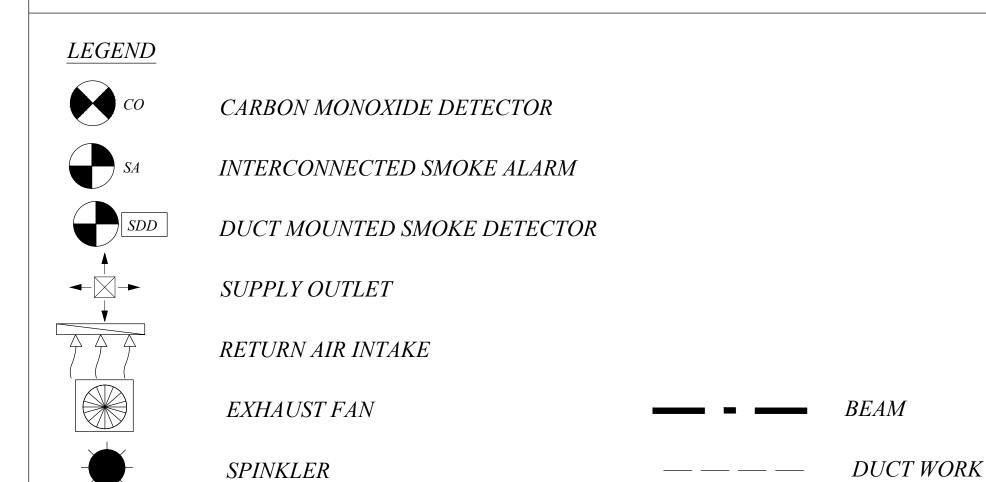

20 MIN. FIRE RATED SOLID WOOD DOOR

IMPERIALMETRICWL12 -38 x 140 2 -2" x 6" 2 -38 x 184 2 -2" x 8" WL32 -38 x 235 2 -2" x 10" 2 -38 x 286 2 -2" x 12" BUILT UP WOOD BEAMS *METRIC* IMPERIAL3 -38 x 140 3 -2" x 6" 3 -38 x 184 3 -2" x 8" 3 -38 x 235 3 -2" x 10" 3 -38 x 286 3 -2" x 12" 4 -38 x 140 4 -2" x 6" 4 -38 x 184 4 -2" x 8" 4 -38 x 235 4 -2" x 10" 4 -38 x 286 4 -2" x 12 FOOTING BELL *METRIC IMPERIAL* 18" Ø

STRUCTURAL ELEMENTS

WOOD LINTELS

FB3	610	24" Ø
WOOD POSTS		
	METRIC	IMPERIAL
P1	3 –38 x 89	3 –2 x 4
P2	4 –38 x 89	$4-2 \times 4$
P3	140 x 140	6 x 6
P4	4 –38 x 14	$4-2 \times 6$
STEEL LINTELS		
	METRIC	IMPERIAL
L1	90 x 90 x 6	3 ½"x 3 ½"x ¼"
L2	100 x 90 x 6	4"x 3 ½"x ¼"
L3	125 x 90 x 10	4 7/8"x 3 ½"x 3/8"
L4	150 x 90 x 10	5 7/8" x 3 ½" x 3/8"
L5	150 x 100 x 13	5 7/8" x 4"x ½"
L6	180 x 100 x 13	7 1/8" x 4"x ½"
CALCIII	ATIONS EOD ACTUAL CLAT	ED AREAS FOR ALL ROOMS/SPACES

LOCATION	MINIMUM UNOBSTRUCTED GLASS AREA WITH ELECTRIC LIGHTING, %	ROOM AREA m ²	GLASS AREA m ²	REAL RATIO %
	FIRST FLOOR			
BEDROOM	5,0	9,9	3,32	33,5
LIVING ROOM	10,0	20,9	2,28	10,1
DINING ROOM	10,0	18,7	1,48	7,9
BEDROOM	5,0	15,5	5,31	34,3
	SECOND FLOOR		•	
CLOSET	5,0	9,4	1,596	17,0
HALL	5,0	9,4	1,03	11,0
DINING ROOM	10,0	6,2	0,83	13,4
BEDROOM	5,0	12,6	2,098	16,7
OFFICE	5,0	10,0	1,03	10,3
BEDROOM	5,0	9,6	1,596	16,6
	ATTIC			
BEDROOM	5,0	10,0	1,596	15,96
LIBRARY	5,0	30,1	2,13	7,1
LIVING ROOM	10,0	33,5	1,98	5,9
CLOSET	5,0	8,6	1,596	16,6

ACCESS PANEL



DESIGN LOADS: IMPORTANCE FACTOR, IE: ROOF DEAD LOAD: 1.0KPa SNOW LOAD: MAX. WIND LOAD: S.FLOOR DEAD LOAD: 1.0KPA S.FLOOR LIVE LOAD: 1.9KPA EARTH QUAKE: LOCATION: HAMILTON, ONTARIO Sa(0.2): SITE CLASS: | IMPORTANCE FACTOR, IE:

GENERAL NOTES: -ALL EXISTING & PROPOSED WORK MUST BE VERIFY ON SITE PROIR TO ANY CONSTRUCTION. -DO NOT SCALE DRAWINGS. -CONTRACTORS AND OWNERS ARE RESPONSIBLE FOR ANY MODIFICATIONS TO THIS PLAN DO TO FIELD CONSTRUCTION CONDITIONS AND CONSTRUCTION METHODS -SEE ATTACHED FOR ALL GENERAL NOTES, CONSTRUCTION SPECIFICATIONS AND -ALL CONSTRUCTION MUST BE ADHERE TO ONTARIO BUILDING CODE REQUIREMENTS AND ANY AUTHORITIES HAVING JURISDICTION. -CONTRACTORS TO REVIEW APPROVED PERMIT DRAWINGS FOR ADDITIONAL NOTES AND RELATED DOCUMENTS. -ALL PRODUCTS & COLOUR SELECTIONS ARE THE RESPONSIBILITY OF THE CLIENT AND/OR CONTRACTOR UNLESS STATED OTHERWISE IN

Description DRAWN BY: Mar 15. 2021 1:100

28 Burris St.,

ON, L8M, 2J3

Hamilton,

-ANY MATERIALS SUBSTITUTIONS MUST BE OF

EQUAL OR GREATER PERFORMANCE.

SHEET TITLE :

GENERAL NOTES

Sheet Number



Committee of Adjustment City Hall, 5th Floor, 71 Main St. W., Hamilton, ON L8P4Y5

Phone: (905) 546-2424 ext. 4221

Email: cofa@hamilton.ca

APPLICATION FOR A MINOR VARIANCE

FOR OFFICE USE ONLY	Y.
APPLICATION NO	DATE APPLICATION RECEIVED
PAID	DATE APPLICATION DEEMED COMPLETE
SECRETARY'S SIGNATURE	

The Planning Act

Application for Minor Variance or for Permission

The undersigned hereby applies to the Committee of Adjustment for the City of Hamilton under Section 45 of the *Planning Act*, R.S.O. 1990, Chapter P.13 for relief, as described in this application, from the Zoning By-law.

1, 2	NAME	ADDRESS	
Registered Owners(s)	IZVOARE PROPERTIES INC.		
Applicant(s)*	Vlad Andriuca Alexandru Andriuca		
Agent or Solicitor			
			E-mail:

Note:

Unless otherwise requested all communications will be sent to the agent, if any.

3. Names and addresses of any mortgagees, holders of charges or other encumbrances:

Additional sheets can be submitted if there is not sufficient room to answer the following questions. Additional sheets must be clearly labelled

4.	Nature and extent of relief applied for: second parking spot doesn't meet city requirements
5.	Why it is not possible to comply with the provisions of the By-law? parking spot is only 2,7m not 3,0m as By-Law require even if physically the car fits in
6.	Legal description and Address of subject lands (registered plan number and lot number or other legal description and where applicable, street and street number): 28 Burris st, Hamilton, ON L8M2J3 LT 7, PL 578; PT LT 6, PL 578; PT LT 8, PL 578, AS IN VM143350; HAMILTON ARN: 251803023153920
7.	PREVIOUS USE OF PROPERTY Residential
8.1	If Industrial or Commercial, specify use
8.2	Has the grading of the subject land been changed by adding earth or other material, i.e. has filling occurred? Yes No Unknown
8.3	Has a gas station been located on the subject land or adjacent lands at any time? Yes No Unknown
8.4	Has there been petroleum or other fuel stored on the subject land or adjacent lands? Yes No Unknown O
8.5	Are there or have there ever been underground storage tanks or buried waste on the subject land or adjacent lands? Yes No Unknown Unknown
8.6	Have the lands or adjacent lands ever been used as an agricultural operation where cyanide products may have been used as pesticides and/or sewage sludge was applied to the lands?
8.7	Yes No Unknown No Unknown No Unknown No Unknown No Unknown No Unknown
8.8	Is the nearest boundary line of the application within 500 metres (1,640 feet) of the fill area of an operational/non-operational landfill or dump? Yes No Unknown
8.9	If there are existing or previously existing buildings, are there any building materials remaining on site which are potentially hazardous to public health (eg. asbestos, PCB's)? Yes No Unknown Unknown

8.10	is there any reasouses on the site of Yes	r adjacent sites?	bject land may	have been conta	aminated by former
8.11		did you use to dete ory of the property		ers to 9.1 to 9.1	0 above?
8.12	previous use invei	property is industria ntory showing all fo ne subject land, is r	rmer uses of th		ny of 9.2 to 9.10, a or if appropriate, the
	Is the previous us	e inventory attache	d? Yes	∏ No	\Box
9.	ACKNOWLEDGE	MENT CLAUSE			
	remediation of cor reason of its appro	I acknowledge that the City of Hamilton is not responsible for the identification and remediation of contamination on the property which is the subject of this Application – by reason of its approval to this Application.			
	April 15, 2021				
	Date		Signature	Property Owner	ľ
			Alexandro	u Andriuca	
			Print Nam	e of Owner	
10.	Dimensions of lan	ds affected:			
	Frontage	38.91 ft			
	Depth	73.75 ft	• •		
	Area	2,981.60 ft ²			
	Width of street				
11.	ground floor area, Existing:_	uildings and structu , gross floor area, i wide, 17m long, 3	number of stori		ject lands: (Specify h, height, etc.)
	Proposed no changes				
12.	distance from side Existing;	dings and structure , rear and front lot le, 4,0m from the f	lines)	·	ct lands; (Specify
	Proposed: no changes				

Date of acquisition of subject lands: Jun 22, 2020			
Date of construction of all buildings and structures on subject lands:			
Existing uses of the subject property:			
rooming house			
Existing uses of abutting properties:			
Length of time the existing uses of the subject property have continued: n/a			
Municipal services available: (check the appropriate space or spaces) Water × Connected			
Sanitary Sewer X Connected			
Storm Sewers X			
Present Official Plan/Secondary Plan provisions applying to the land:			
Present Restricted Area By-law (Zoning By-law) provisions applying to the land: D/ S497a			
Has the owner previously applied for relief in respect of the subject property? Yes No			
If the answer is yes, describe briefly.			
Is the subject property the subject of a current application for consent under Section 53 of the Planning Act?			
Yes • No			
Additional Information			
The applicant shall attach to each copy of this application a plan showing the dimensions of the subject lands and of all abutting lands and showing the location, size and type of all buildings and structures on the subject and abutting lands, and where required by the Committee of Adjustment such plan shall be signed by an Ontario Land Surveyor.			