COMMITTEE OF ADJUSTMENT



City Hall, 5th floor, 71 Main Street West, Hamilton, ON L8P 4Y5
Telephone (905) 546-2424, ext. 4221

E-mail: cofa@hamilton.ca

NOTICE OF PUBLIC HEARING Minor Variance

You are receiving this notice because you are either:

- Assessed owner of a property located within 60 metres of the subject property
- Applicant/agent on file, or
- Person likely to be interested in this application

APPLICATION	A-24:108	SUBJECT	31 Greenaway Avenue, Hamilton
NO.:		PROPERTY:	-
ZONE:	"H" (Community Shopping and	ZONING BY-	Zoning By-law former City of
	Commercial, Etc.)	LAW:	Hamilton 6593, as Amended

APPLICANTS: Owner: Harjot Walia

Agent: R&R Designs – Richie Khanna

The following variances are requested:

- 1. To permit a side yard setback (north) of 0.26m.
- 2. To permit a front yard setback of 0.40m.
- 3. To permit a side yard setback (south) of 3.03m.
- 4. To permit a rear yard setback (north) of 1.54m.
- 5. To permit a setback from the property line to the staircase #3 of 0.55m.
- 6. To permit a setback from the property line to the eave of the staircase #3 of 0.23m.
- 7. To permit a front yard setback for staircase #1 of 0.57m.
- 8. To permit setback of 1.96m for staircase #2 to the property line.
- 9. To permit setback of 0.43m for staircase #3 to the property line.
- 10. To permit setback of 0.36m for the concrete pad of staircase #3 to the property line.
- 11. To permit setback of 0.38m for the under-grade caisson footing of staircase #3 to the property line.
- 12. To permit the eaves to encroach 0.1 metres into the side yards.

A-24:108

PURPOSE & EFFECT: To facilitate the expansion of the top half-storey with the addition of dormers

for the existing single detached dwelling.

Notes:

i. Variances written exactly as requested by applicant.

Please note that these lands may be:

- Regulated by a Conservation Authority;
- Located within or adjacent to an Environmentally Sensitive Area (ESA);
- Designated under the Ontario Heritage Act;
- Listed in the City of Hamilton's Inventory of Buildings of Architectural and/or Historical Interest; and/or,
- Included in the City of Hamilton's Register of Property of Cultural Heritage Value or Interest.

Staff cannot confirm this information at this time and the applicant should make the appropriate inquiries in order to determine what other regulations may be applicable to the subject property."

This Notice must be posted by the owner of any land which contains seven or more residential units so that it is visible to all residents.

This application will be heard by the Committee as shown below:

DATE:	Tuesday, June 11, 2024
TIME:	1:35 p.m.
PLACE:	Via video link or call in (see attached sheet for details)
	City Hall Council Chambers (71 Main St. W., Hamilton)
	To be streamed (viewing only) at
	www.hamilton.ca/committeeofadjustment

For more information on this matter, including access to drawings illustrating this request and other information submitted:

- Visit www.hamilton.ca/committeeofadjustment
- Visit Committee of Adjustment staff at 5th floor City Hall, 71 Main St. W., Hamilton
- Call 905-546-CITY (2489) or 905-546-2424 extension 4221

PUBLIC INPUT

Written: If you would like to submit written comments to the Committee of Adjustment you may do so via email or hardcopy. Please see attached page for complete instructions, written comments must be received no later than noon June 7, 2024

Orally: If you would like to speak to this item at the hearing you may do so via video link, calling in, or attending in person. Please see attached page for complete instructions, registration to participate virtually must be received no later than noon June 10, 2024

FURTHER NOTIFICATION

If you wish to be notified of future Public Hearings, if applicable, regarding A-24:108, you must submit a written request to cofa@hamilton.ca or by mailing the Committee of Adjustment, City of Hamilton, 71 Main Street West, 5th Floor, Hamilton, Ontario, L8P 4Y5.

If you wish to be provided a Notice of Decision, you must attend the Public Hearing and file a written request with the Secretary-Treasurer by emailing cofa@hamilton.ca or by mailing the Committee of Adjustment, City of Hamilton, 71 Main Street West, 5th Floor, Hamilton, Ontario, L8P 4Y5.



DATED: May 23, 2024

Jamila Sheffield, Secretary-Treasurer Committee of Adjustment Information respecting this application is being collected under the authority of the Planning Act, R.S.O., 1990, c. P. 13. All comments and opinions submitted to the City of Hamilton on this matter, including the name, address, and contact information of persons submitting comments and/or opinions, will become part of the public record and will be made available to the Applicant and the general public, and may include posting electronic versions.



COMMITTEE OF ADJUSTMENT

City Hall, 5^{th} floor, 71 Main Street West, Hamilton, ON L8P 4Y5 Telephone (905) 546-2424, ext. 4221

E-mail: cofa@hamilton.ca

PARTICIPATION PROCEDURES

Written Submissions

Members of the public who would like to participate in a Committee of Adjustment meeting are able to provide comments in writing advance of the meeting. Comments can be submitted by emailing cofa@hamilton.ca or by mailing the Committee of Adjustment, City of Hamilton, 71 Main Street West, 5th Floor, Hamilton, Ontario, L8P 4Y5. Comments must be received by noon on the date listed on the Notice of Public Hearing.

Comments are available the Friday prior to the Hearing and are available on our website: www.hamilton.ca/committeeofadjustment

Oral Submissions

Members of the public are also able to provide oral comments regarding Committee of Adjustment Hearing items by participating Virtually through Webex via computer or phone or by attending the Hearing In-person. Participation Virtually requires pre-registration in advance. Please contact staff for instructions if you wish to make a presentation containing visual materials.

1. Virtual Oral Submissions

Interested members of the public, agents, and owners **must register by noon on the day listed on the Notice of Public Hearing to** participate Virtually.

To register to participate Virtually by Webex either via computer or phone, please contact Committee of Adjustment staff by email cofa@hamilton.ca. The following information is required to register: Committee of Adjustment file number, hearing date, name and mailing address of each person wishing to speak, if participation will be by phone or video, and if applicable the phone number they will be using to call in.

A separate registration for each person wishing to speak is required. Upon registering for a meeting, members of the public will be emailed a link for the Webex meeting one business day before the Hearing. Only those registered will be called upon to speak.

2. In person Oral Submissions


Interested members of the public, agents, and owners who wish to participate in person may attend Council Chambers on the date and time listed on the Notice of Public Hearing. Please note, you will be required to provide your name and address for the record. It is advised that you arrive **no less than 10 minutes** before the time of the Public Hearing as noted on the Notice of Public Hearing.

We hope this is of assistance and if you need clarification or have any questions, please email cofa@hamilton.ca or by phone at 905-977-1654.

Please note: Webex (video) participation requires either a compatible computer or smartphone and an application (app/program) must be downloaded by the interested party in order to participate. It is the interested party's responsibility to ensure that their device is compatible and operating correctly prior to the Hearing.



EXISTING BUILDING IMAGE

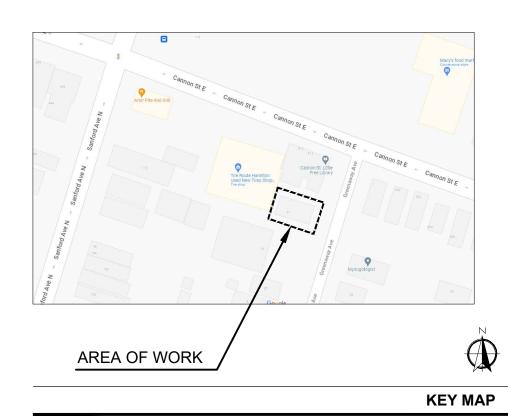





ARCHITECTURAL

STRUCTURAL

CONSULTANTS

- 1. CONTRACTOR SHALL CHECK DIMENSIONS AND REPORT DISCREPANCIES TO THE DESIGNER BEFORE PROCEEDING WITH THE WORK.
- 2. DO NOT SCALE DRAWINGS.
- 3. THE DESIGN AND DRAWINGS WERE DEVELOPED FOR A SPECIFIC PURPOSE AND MAY NOT BE ALTERED, ISSUED, OR REPRODUCED FOR ANY OTHER PURPOSE.

NOTES

- 1. CONVERSION FROM ONE-FAMILY DWELLING TO TWO-FAMILY DWELLING
- 2. INTERIOR ALTERATION
- 3. NEW EXTERIOR 3 STAIRCASES.

SCOPE OF WORK

TITLE/SITE	REVISIONS
ARCHITECTURAL	2024/03/05
A0.01 COVER PAGE	
A0.02 GENERAL NOTES	
A0.03 WALL SCHEDULE AND LEGEND	
SP.01 EXISTING SITE PLAN	
SP.02 PROPOSED SITE PLAN	
A1.01 EXISTING BASEMENT PLAN	
A1.02 EXISTING GROUND FLOOR PLAN	
A1.03 EXISTING SECOND FLOOR PLAN	
A2.01 PROPOSED BASEMENT PLAN	
A2.02 PROPOSED GROUND FLOOR PLAN	
A2.03 PROPOSED SECOND FLOOR PLAN	
A3.01 REAR STAIR ELEVATION	
STRUCTURAL	
S0.01 STRUCTURAL NOTES	•
S1.01 DETAILS	
	SHEET INDEX



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2	2024-02-07	ISSUED FOR REV	ISION	A.A.
1	2023-10-31	ISSUED FOR PERI	MIT	A.A.
NO.	DATE	DESCRI	PTION	BY
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BEVIEWED BY R K		1		

GENERAL NOTES:

- 1. CONTRACTOR TO VERIFY ALL DESIGN DRAWINGS AS THEY APPLY FOR EACH TRADE AS APPLICABLE TO THE PROJECT.
- 2. INSPECT INTERIOR AND EXTERIOR WALLS. REPLACE 13. CONTRACTOR TO VERIFY ALL EXISTING GRADES ANY DAMAGED SUBSTRATE WALLS ETC. INSPECT WINDOWS & WALLS BELOW WINDOWS FOR **EVIDENCE OF MOISTURE DAMAGE & IMPROPERLY** INSTALLED FLASHING. VERIFY WITH OWNER.
- 3. ALL BEAMS WITH POINT LOADS TO BE SIZED BY PROFESSIONAL ENGINEER.
- 4. PROVIDE ENGINEERED LINTELS FOR ALL OPENINGS 15. FOR INTERIOR FINISHES, VERIFY WITH OWNER. SUPPORTING TRUSSES SPANNING MORE THAN 4
- 5. ALL LEVEL BEAMS @ HEADERS TO BE PRE-ENGINEERED BY LVL SUPPLER.
- 6. ANY PORTION OF CONCRETE WALL THAT IS LATERALLY UNSUPPORTED FOR 48" OR MORE IN LENGTH, MUST BE ENGINEERED.
- 7. ENERGY REQUIREMENTS AS PER SB-12 OF THE O.B.C.
- 8. MILLWORK SUB-CONTRACTOR OR GENERAL CONTRACTOR SHALL VERIFY ON SITE ALL DIMENSIONS THAT ARE NECESSARY FOR THE CONSTRUCTION & INSTALLATION OF FURNITURE. MILLWORK AND EQUIPMENT.
- 9. ALL SUB FLOORS SCREWED & GLUED TO FLOOR JOISTS.
- 10. ALL PERIMETER WALLS TO BE STRIPED FROM THE INSIDE, CLEANED, ALL MOLD TO BE REMOVED AND 4. ALL SMOKE ALARMS TO BE INTERCONNECTED AS DAMAGED AREAS TO BE REPAIRED AND PREPARED TO RECEIVE NEW FINISH. (UNLESS NOTED OTHERWISE).
- 11. ALL SWITCHES AND OUTLETS TO BE INSTALLED AS PER PART 9.34.2 OF THE O.B.C.

- 12. PLUMBING NOTE: PRESSURE BALANCED OR THERMOSTATICALLY CONTROLLED MIXING VALVES FOR SHOWER UNITS. PRESSURE BALANCED OR THERMOSTATICALLY CONTROLLED MIXING VALVES 2. FOR ALL FAUCETS OR WATER HEATER SOURCE. AND ALL FINISHED GRADES ON SITE.
- 14. ALL DIMENSIONS ARE TO INTERIOR WALL FACE. ONLY NEW INTERIOR PARTITION DIMENSIONS SHOWN ON PROPOSED DRAWING. EXTERIOR WALL WASHROOMS: AND EXITING INTERIOR WALL DIMENSIONS SHALL BE
- 16. IF THERE IS NO SPECIFIED, EXISTING ITEMS TO REMAIN, REPAIR IF IT IS REQUIRED.

FIRE PROTECTION:

VERIFIED ON SITE.

- INTERCONNECTED CARBON MONOXIDE DETECTOR SHALL BE INSTALLED IN THE BASEMENT IN A RETURN DUCT THAT WILL SHUT OFF THE FURNACE FAN IN THE EVENT OF A FIRE. CARBON MONOXIDE DETECTORS REQUIRED FOR ALL FUEL APPLIANCES (O.B.C. 9.33.4.2).
- 2. INSTALL SMOKE ALARMS IN EACH SLEEPING.ROOM ON EVERY FLOOR AS PER 9.10.19.3.(1) (B).
- 3. SMOKE ALARMS SHALL BE WIRED SO THAT WHEN THE ALARM SOUNDS. ALL ALARMS SOUND. SMOKE ALARMS SHOULD CONFORM TO SECTION 9.10.19.6. (SILENCING).
- PER 9.10.19.5. ALL SMOKE ALARMS TO HAVE VISUAL SIGNAL DEVICE IN ADDITION TO AN AUDIBLE SIGNAL DEVICE.

FIRE SEPARATION NOTES:

- 1. EXISTING FIRE SEPARATIONS TO BE MAINTAINED.
- DAMAGED AREAS SHALL BE CORRECTED BY THE G.C. ANY PENETRATIONS SHALL BE SEALED TO ENSURE NO COMPROMISE OF FIRE RATINGS.
- 3. EVERY DOOR IN A FIRE SEPARATION SHALL HAVE A SELF-CLOSING DEVICE AS PER 9.10.12.10. (1).

- 1. WATERPROOF WALLBOARD REQUIRED AS TILE BASE AROUND TUBS AND SHOWERS.
- 2. USE MOISTURE RESISTANT DRYWALL IN WET AREAS.

STAIRS:

1. ALL HANDRAILS AND GUARDS TO BE INSTALLED AS PER SB-1 OF THE O.B.C.



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3	2024-02-27	ISSUED FOR REVISION	B.P
2	2024-02-07	ISSUED FOR REVISION	A.A
1	2023-10-31	ISSUED FOR PERMIT	A.A
NO.	DATE	DESCRIPTION	BY
	REVISIONS		
PROJECT ADDRESS		31 GREENAWAY AVE,	

PROJECT ADDRESS	31 GREENAWAY AVE, HAMILTON, ON L8L 6C3.	
SCALE	AS NOTED	
DATE	2023-08-15	
PAGE TITLE	GENERAL NO	TES
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EXT	ERIOR WALL	ASSEMBLY	
WALL TAG	PLAN LEGEND	WALL CONSTRUCTION	WALL ASSEMBLY DESCRIPTION
W1			EXISTING EXTERIOR WALL EXISTING FRR NOT LESS THAN 45MIN (SB-3, TABLE 1, W1b)
W ₂		M	FOUNDATION WALL INSTALL INTERIOR INSULATION AS REQUIRED, SEE PROPOSED BASEMENT FLOOR PLAN FOR LOCATIONS. (R-20ci MINIMUM) - EXISTING FOUNDATION WALL - WATERPROOFING MEMBRANE EXTEND 6" ABOVE GRADE LINE - NEW 2" RIGID INSULATION (ROCKWOOL R10ci) - NEW 2"X4 WOOD STUD @16 O/C W/ BATT INSULATION (R-12) - NEW ONE LAYER REGULAR 1/2" GYPSUM WALL BOARD - NEW FINISH (VERIFY WITH OWNER)
	RIOR PARTI		
WALL TAG	PLAN LEGEND	WALL CONSTRUCTION	WALL ASSEMBLY DESCRIPTION
P1		X	EXISTING INTERIOR PARTITION WALL - TO REMAIN - NEW INTERIOR FINISH - NEW 1/2" (12.7MM) REGULAR GWB - 2X4 WOOD STUD @ 16" O.C NEW 1/2" (12.7MM) REGULAR GWB - NEW INTERIOR FINISH PROVIDE FOR DWELLING UNIT INSIDE INTERIOR WALLS
P2		M.	NEW INTERIOR FIRE SEPARATION WALL INTERIOR FINISH 5/8" (15.9MM) TYPE X GWB NEW OR EXISTING 2"X4" STUD @ 16" O.C. W/ NEW BATT INSULATION RESILIENT METAL CHANNELS 2 LAYERS 5/8" (15.9MM) TYPE X GWB INTERIOR FINISH PROVIDE FOR MECHANICAL ROOM. FRR NOT LESS THAN 1HR (SB-3, TABLE 1, W4a) SOUND TRANSMISSION (STC) 51
P3			FIRE SEPARATION TO THE EXISTING WALL INTERIOR FINISH 5/8" (15.9MM) TYPE X GWB EXISTING 2"X4" STUD @ 16" O.C. W/ BATT INSULATION RESILIENT METAL CHANNELS 2 LAYERS 5/8" (15.9MM) TYPE X GWB INTERIOR FINISH PROVIDE FOR MECHANICAL ROOM. FRR NOT LESS THAN 1HR (SB-3, TABLE 1, W4a) SOUND TRANSMISSION (STC) 51
P4	7/////		NEW INTERIOR PARTITION WALL - INTERIOR FINISH - 1/2" (12.7MM) REGULAR GWB - 2X4 WOOD STUD @ 16" O.C. - 1/2" (12.7MM) REGULAR GWB - INTERIOR FINISH PROVIDE FOR DWELLING INTERIOR PARTITIONS.
P5			EXISTING INTERIOR PARTITION WALL - TO DEMOLISH - INTERIOR FINISH - 1/2" (12.7MM) REGULAR GWB - 2X4 WOOD STUD @ 16" O.C 1/2" (12.7MM) REGULAR GWB - INTERIOR FINISH

FLO	FLOOR & ROOF ASSEMBLY			
FLOOR TAG	FLOOR CONSTRUCTION	FLOOR ASSEMBLY DESCRIPTION		
FC1	- 1	EXISTING GROUND FLOOR ASSEMBLY - EXISTING FLOOR FINISH - EXISTING WOOD FLOOR ASSEMBLY TO REMAIN 1/2"(15.5MM) PLYWOOD SUBFLOOR WOOD JOIST @16" O.C EXISTING 1 LAYER 1/2" REGULAR GWB - EXISTING CEILING FINISH		
FC2		FLOOR ASSEMBLY - FIRE RATED PROVIDE FOR BASEMENT MECHANICAL ROOM (CEILING) AND SECOND FLOOR (FLOORING) - EXISTING FLOOR FINISH - EXISTING WOOD FLOOR ASSEMBLY TO REMAIN 1/2"(15.5MM) PLYWOOD SUBFLOOR WOOD JOIST @16" O.C EXISTING ABSORPTIVE MATERIAL IN CAVITY - RESILIENT METAL CHANNEL PERPENDICULAR TO JOIST @16" O/C - 2 LAYERS 5/8" (15.9MM) TYPE X GWB - CEILING FINISH FRR NOT LESS THAN 1HR (SB-3, TABLE 2, F9c) SOUND TRANSMISSION (STC) 52		
ROOF TAG	ROOF CONSTRUCTION	ROOF ASSEMBLY DESCRIPTION		
RC1	2MM	EXISTING ROOF ASSEMBLY - EXISTING ROOF FINISH TO REMAIN - EXISTING ROOF MEMBRANE TO REMAIN - EXISTING ROOF STRUCTURAL ASSEMBLY TO REMAIN - EXISTING ROOF CEILING JOIST W/INSULATION TO REMAIN - EXISTING 1 LAYER 1/2" REGULAR GWB - EXISTING CEILING FINISH FRR NOT LESS THAN 45MIN (SB-3, TABLE 2, R1)		




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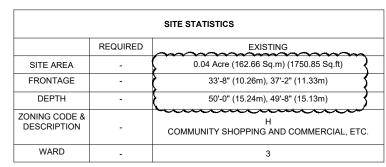


3	2024-03-05	ISSUED FOR M.V.	B.P.	
2	2024-02-07	ISSUED FOR REVISION	A.A.	
1	2023-10-31	ISSUED FOR PERMIT	A.A.	
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PROJECT ADDRESS		31 GREENAWAY AVE, HAMILTON, ON L8L 6C3.		
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DATE 2023-08-15 WALL SCHEDULE & LEGEND PAGE TITLE DRAWING NO. PROJECT NO. RR13-2023 A0.03

DRAWN BY A.A REVIEWED BY R.K



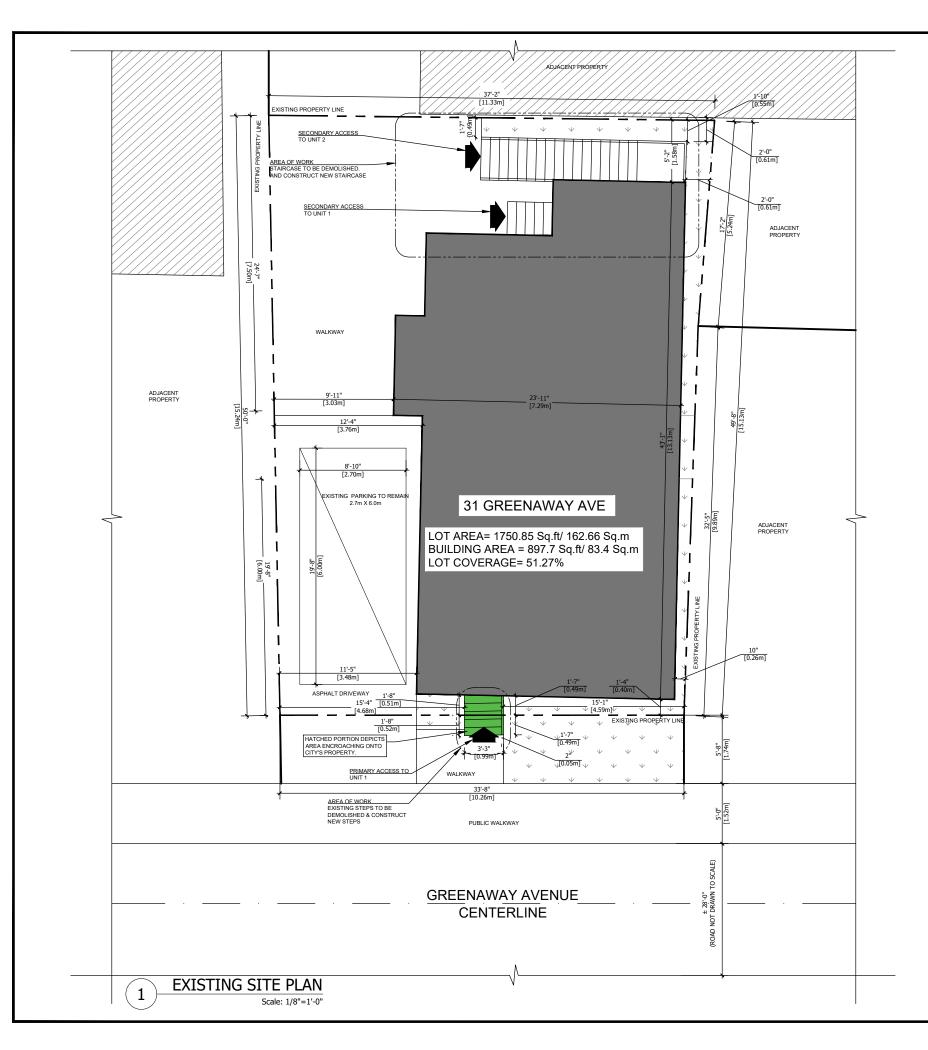

BUILDING STATISTICS		
	REQUIRED	EXISTING
FRONT SETBACK	6.0 m	± 1'-4" (0.40 m)
REAR SETBACK	7.5 m	± 5'-2" (1.58 m)
WEST SIDE SETBACK	-	± 9'-11" (3.03 m)
EAST SIDE SETBACK	-	± 0'-10" (0.26 m)
BUILDING WIDTH	-	± 23'-11" (7.29 m)
BUILDING DEPTH	-	± 43'-1" (13.13 m)
BUILDING HEIGHT	MAX. 55'-9" (17.0 m)	EXISTING TO REMAIN
# OF STOREY	-	EXISTING TO REMAIN
LANDSCAPING	N/A	EXISTING TO REMAIN




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LIST OF VARIANCES:

EXISTING BUILDING FOOTPRINT IS TO REMAIN. SETBACKS ARE EXISTING FROM THE TIME BUILDING WAS BUILT. WE REQUEST VARIANCE FOR EXISTING SETBACKS.

- 1. 0.26m EX. SETBACK ON THE NORTH SIDEYARD.
- 2. 0.40m EX. SETBACK ON THE FRONT.
- 3. 3.03m EX. SETBACK ON THE SOUTH SIDEYARD.
- 4. 1.54m EX. SETBACK ON THE REAR.
- 5. 0.55m SETBACK FROM THE PROPERTY LINE TO THE EX. LANDING OF STAIRCASE-1. (REQ. SETBACK 0.58 m FROM THE REAR LOT LINE)
- 6. 0.23m SETBACK FROM THE PROPERTY LINE TO THE EAVE OF THE STAIRCASE-1 LANDING.

PROPOSED NEW THREE STAIRCASE WITH CONCRETE PAD AT WE REQUEST VARIANCE FOR PROPOSED SETBACKS.

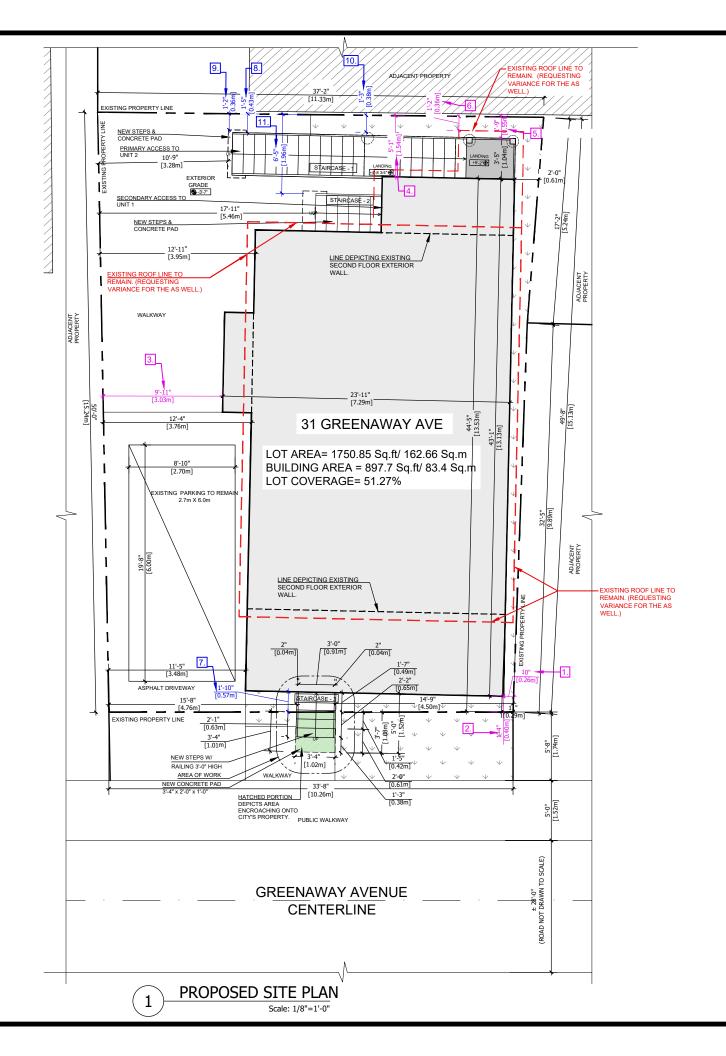- 7. 0.57m SETBACK FOR THE NEW STAIRCASE FROM THE PROPERTY LINE TO THE BUILDING.
- 8. 0.43m SETBACK FROM THE PROPERTY LINE TO THE STAIR-1.
- 9. 0.36m SETBACK FROM THE PROPERTY LINE TO STAIR-1 CONCRETE PAD.
- 10. 0.38m SETBACK FROM THE PROPERTY LINE TO STAIR-1 UNDER GRADE CASSION FOOTING.
- 11. 1.96m SETBACK FROM THE PROPERTY LINE TO THE STAIR-2.

EXISTING ROOF IS TO REMAIN. REQUEST VARIANCE FOR EXISTING ROOF ENCROACHING INTO SIDE, FRONT & REAR YARDS. SINCE THE BUILDING WAS BUILT IN 1992.

SITE STATISTICS			
	REQUIRED	EXISTING	
SITE AREA	-	0.04 Acre (162.66 Sq.m) (1750.85 Sq.ft)	
FRONTAGE	=	33'-8" (10.26m), 37'-2" (11.33m)	
DEPTH	-	50'-0" (15.24m), 49'-8" (15.13m)	
ZONING CODE & DESCRIPTION	-	H COMMUNITY SHOPPING AND COMMERCIAL, ETC.	
WARD	-	3	

BUILDING STATISTICS			
	REQUIRED	EXISTING	
FRONT SETBACK	6.0 m	± 1'-4" (0.40 m)	
REAR SETBACK	7.5 m	± 5'-1" (1.54 m)	
WEST SIDE SETBACK	-	± 9'-11" (3.03 m)	
EAST SIDE SETBACK	-	± 0'-10" (0.26 m)	
BUILDING WIDTH	-	± 23'-11" (7.29 m)	
BUILDING DEPTH	-	± 43'-1" (13.13 m)	
BUILDING HEIGHT	MAX. 55'-9" (17.0 m)	EXISTING TO REMAIN	
# OF STOREY	-	EXISTING TO REMAIN	
LANDSCAPING	N/A	EXISTING TO REMAIN	



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1	2023-10-31	ISSUED FOR PERMIT	A.A.	
NO.	DATE	DESCRIPTION BY		
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PROJECT 31 GREENAWAY AVE, ADDRESS HAMILTON, ON L8L 6C3.				

 PROJECT ADDRESS
 31 GREENAWAY AVE, HAMILTON, ON L8L 6C3.


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 DATE 2023-08-15

 PAGE TITLE PROPOSED SITE PLAN

PROJECT NO. DRAWING NO. RR13-2023

DRAWN BY B.P SP.02

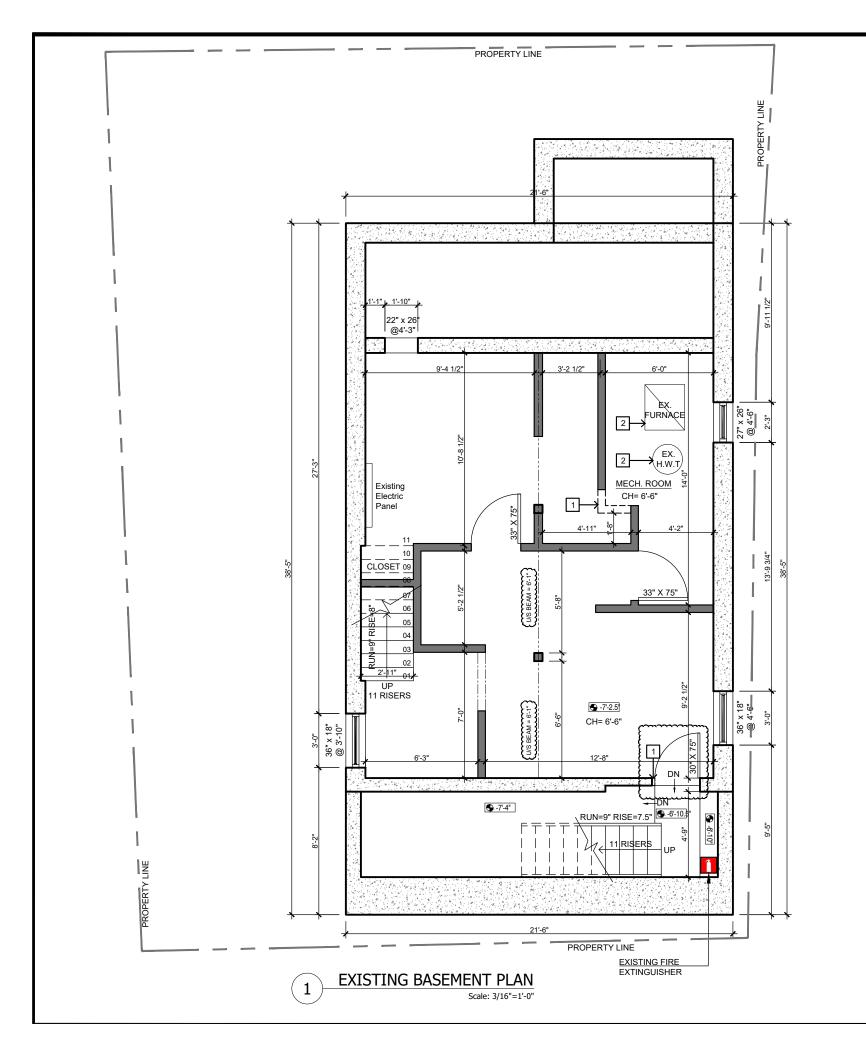

DEMOLITION KEY NOTES:

- 1. DEMOLISH EXISTING INTERIOR WALL
- MECHANICAL EQUIPMENT TO REMAIN AS IT IS.(IF NOT MENTIONED, EXITING TO REMAIN AS IS.)

NOTE:

PATCH REPAIR AND MAKE GOOD THE AREA AFFECTED BY SCOPE OF WORK. REFER TO PROPOSED FLOOR PLAN FOR SCOPE OF WORK.







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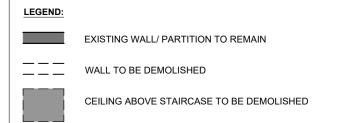


DEMOLITION KEY NOTES:

- 1. DEMOLISH EXISTING INTERIOR WALL
- DEMOLISH EXISTING STAIRCASE FROM GROUND FLOOR TO SECOND FLOOR.
- 3. REMOVE THE EXISTING INTERIOR DOOR.
- 4. SLOPED CEILING ABOVE STAIRCASE AND FLAT CEILING ABOVE LANDING TO BE DEMOLISHED.

NOTE:

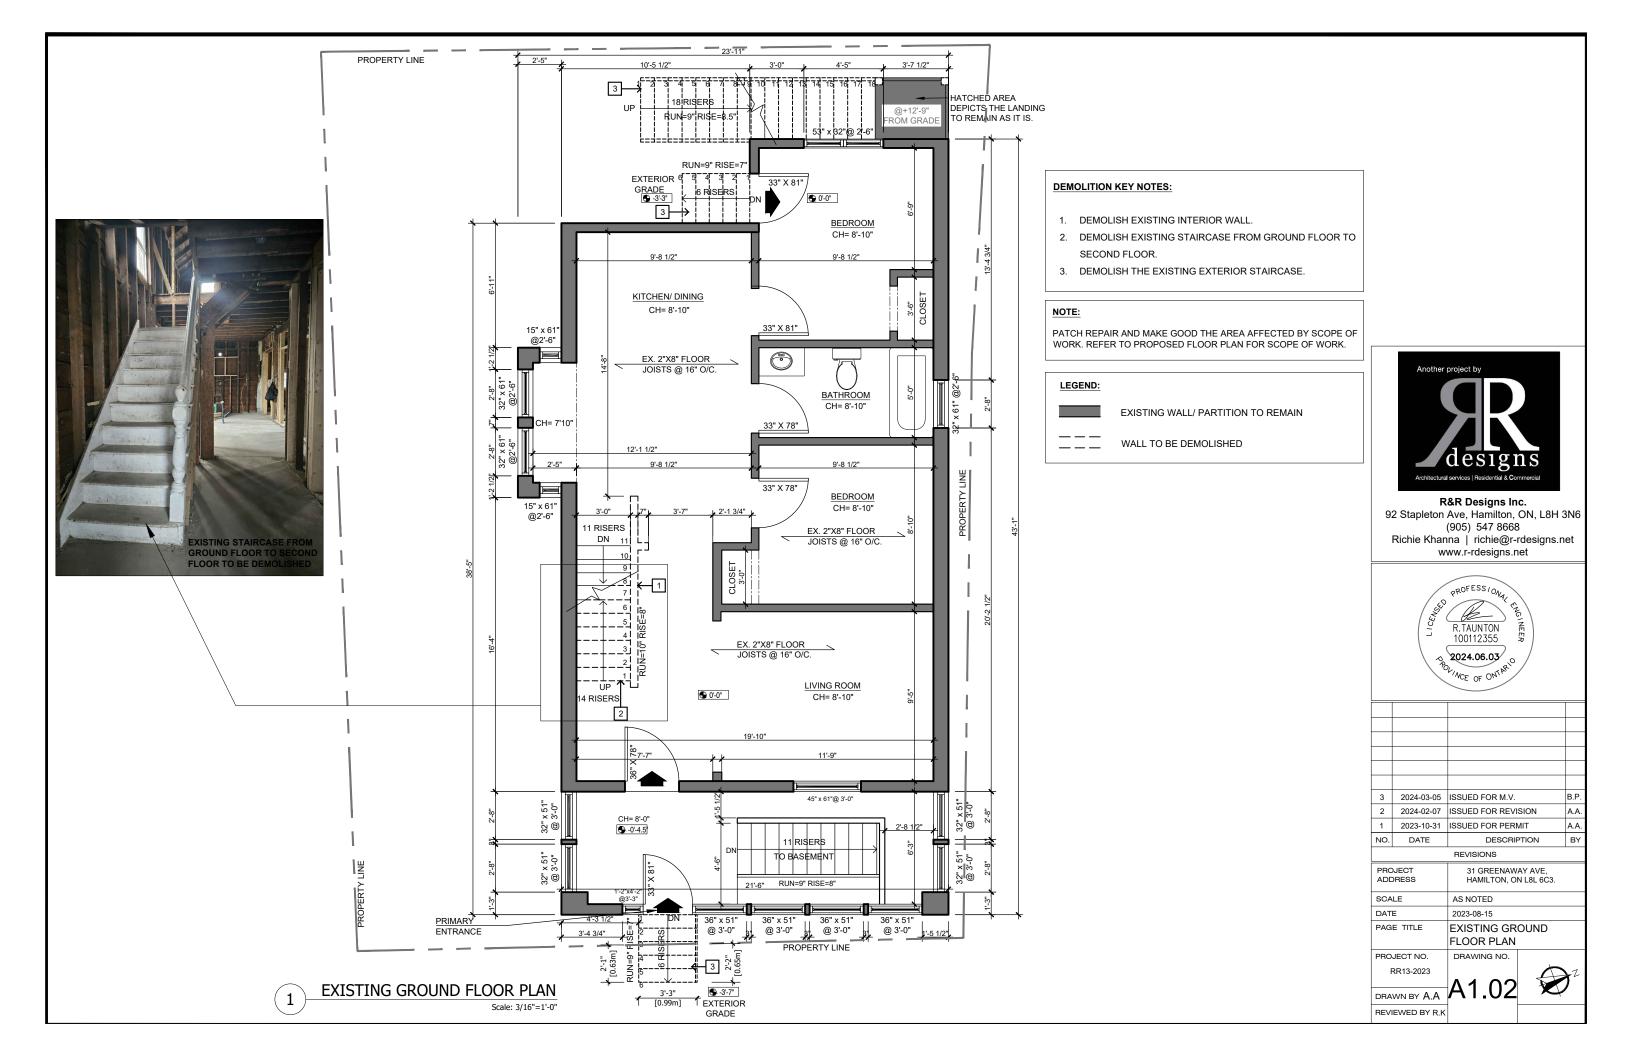PATCH REPAIR AND MAKE GOOD THE AREA AFFECTED BY SCOPE OF WORK. REFER TO PROPOSED FLOOR PLAN FOR SCOPE OF WORK.

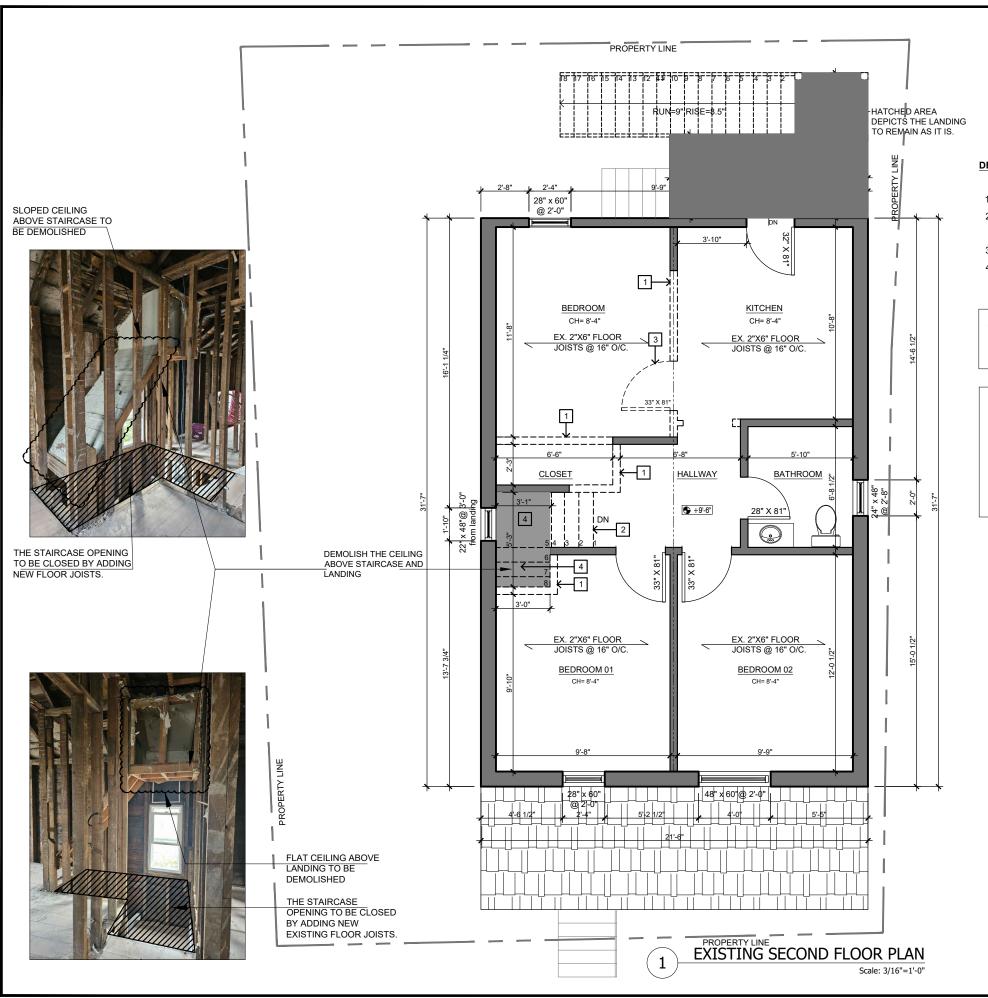




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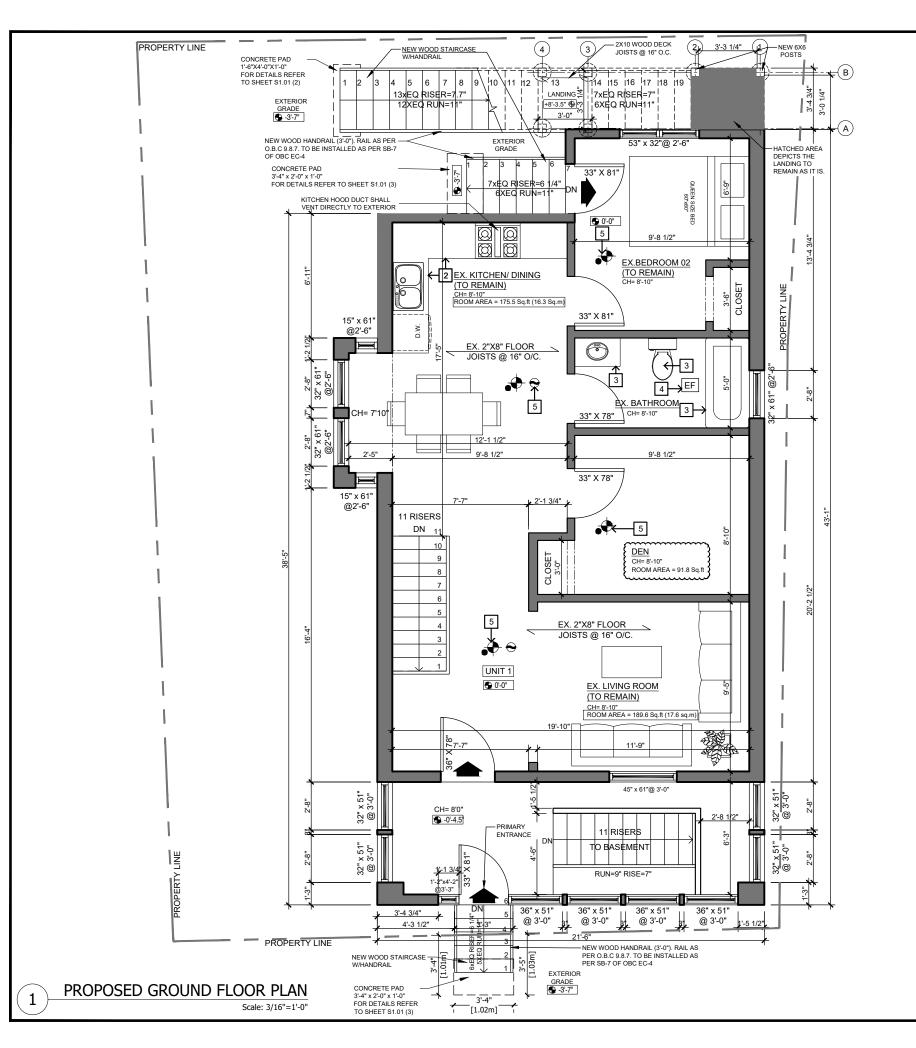
92 Stapleton Ave, Hamilton, ON, L8H 3N6 (905) 547 8668 Richie Khanna | richie@r-rdesigns.net

chie Khanna | richie@r-rdesigns.ne www.r-rdesigns.net



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2	2024-02-07	ISSUED FOR REVI	SION	A.A.
1	2023-10-31	ISSUED FOR PERI	MIT	A.A.
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CONSTRUCTION KEY NOTES:

- 1. N/A
- INSTALL NEW KITCHEN CABINET AND SINK. KITCHEN HOOD EXHAUST SHALL VENT DIRECTLY TO EXTERIOR.
- 3. INSTALL NEW BATHROOM FIXTURES.
- 4. INSTALL NEW EXHAUST FAN TO BATHROOM. IT SHALL VENT DIRECTLY TO EXTERIOR.
- 5. INSTALL INTERCONNECTED CO/ SMOKE ALARMS/ DETECTORS.
- 6. INSTALL NEW FLOOR FINISHES THROUGHOUT
- 7. INSTALL NEW TRIMS & BASEBOARDS
- 8. INSTALL NEW ELECTRICAL LIGHT FIXTURES IF NEEDED.

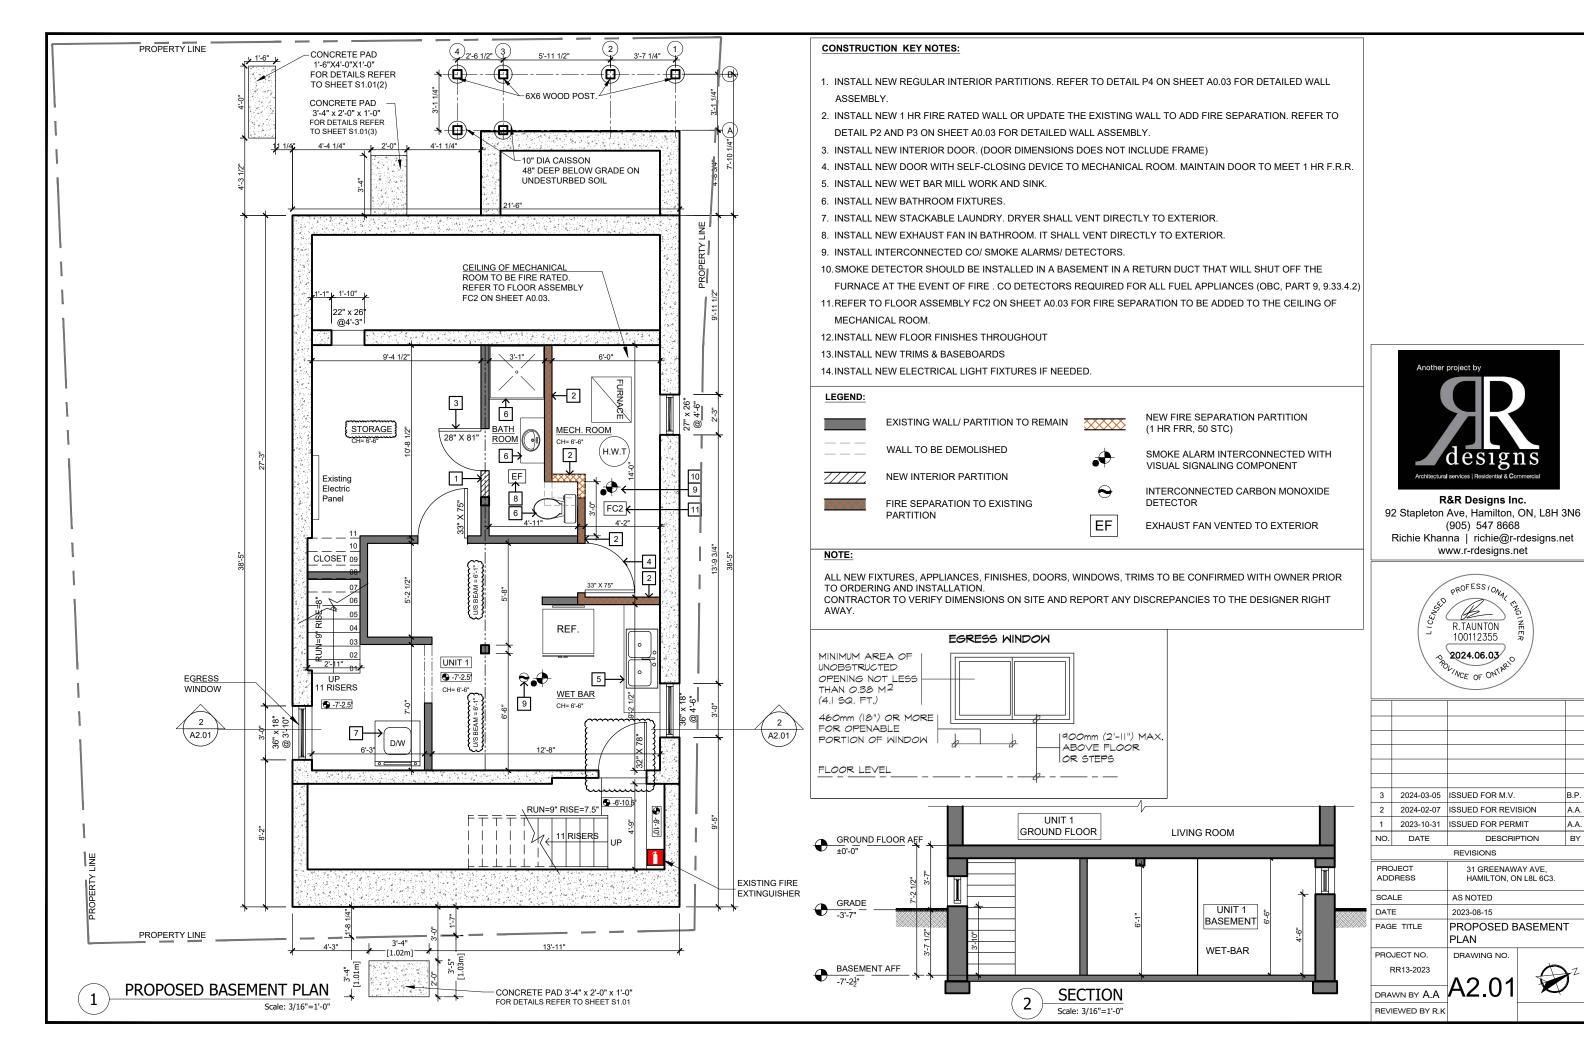NOTE:

ALL NEW FIXTURES, APPLIANCES, FINISHES, DOORS, WINDOWS, TRIMS TO BE CONFIRMED WITH OWNER PRIOR TO ORDERING AND INSTALLATION.

CONTRACTOR TO VERIFY DIMENSIONS ON SITE AND REPORT ANY DISCREPANCIES TO THE DESIGNER RIGHT AWAY.





EXISTING WALL/ PARTITION TO REMAIN



NEW INTERIOR PARTITION



SMOKE ALARM INTERCONNECTED WITH VISUAL SIGNALING COMPONENT



INTERCONNECTED CARBON MONOXIDE DETECTOR



EXHAUST FAN VENTED TO EXTERIOR



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PROJECT ADDRESS		31 GREENAWAY AVE, HAMILTON, ON L8L 6C3.		
SCA	LE	AS NOTED		
DATE		2023-08-15		

PROPOSED GROUND

FLOOR PLAN


PROJECT NO.

RR13-2023

DRAWN BY A.A

REVIEWED BY R.K

PAGE TITLE

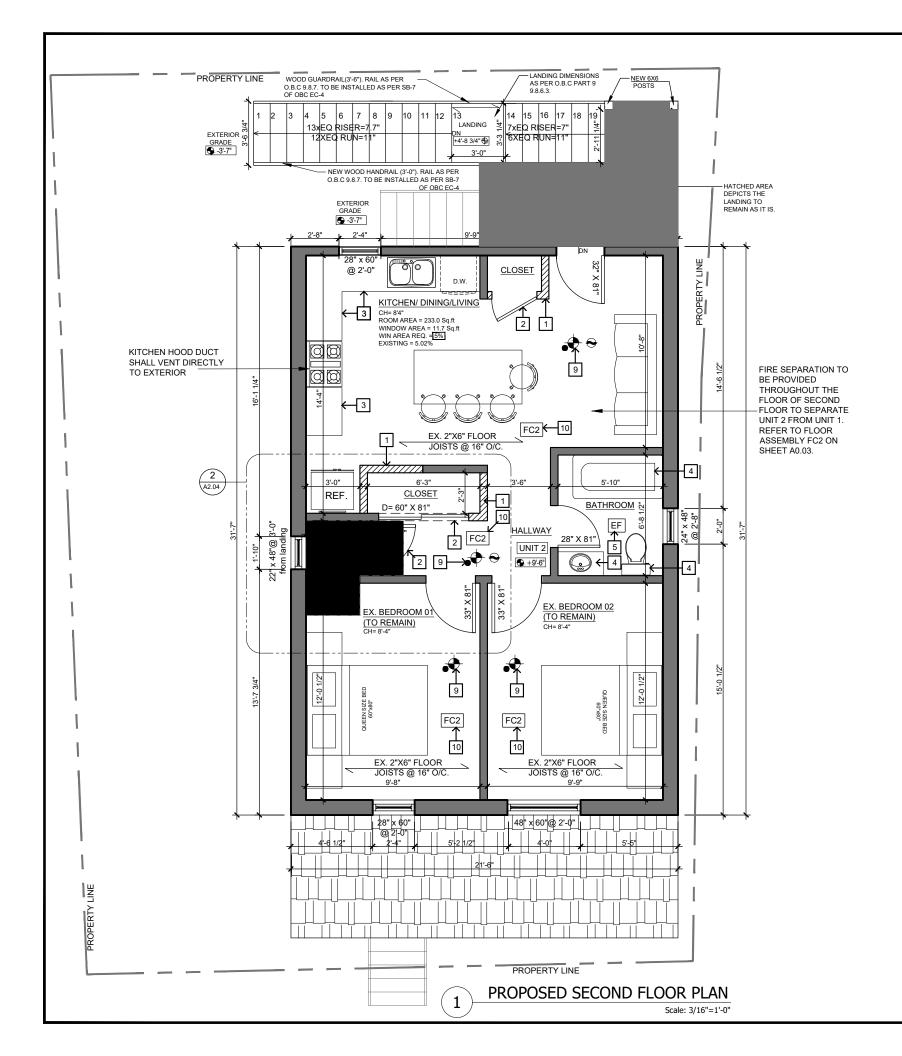


CONSTRUCTION KEY NOTES:


- INSTALL NEW REGULAR INTERIOR PARTITIONS. REFER TO DETAIL P4 ON SHEET A0.03 FOR DETAILED WALL ASSEMBLY.
- 2. INSTALL NEW INTERIOR DOOR. (DOOR DIMENSIONS DOES NOT INCLUDE FRAME)
- 3. INSTALL NEW KITCHEN CABINET AND SINK. KITCHEN HOOD EXHAUST SHALL VENT DIRECTLY TO EXTERIOR.
- 4. INSTALL NEW BATHROOM FIXTURES.
- 5. INSTALL NEW EXHAUST FAN TO BATHROOM. IT SHALL VENT DIRECTLY TO EXTERIOR.
- 8. INSTALL NEW STACKABLE LAUNDRY. DRYER SHALL VENT DIRECTLY TO EXTERIOR.
- 9. INSTALL INTERCONNECTED CO/ SMOKE ALARMS/ DETECTORS.
- 10.REFER TO FLOOR ASSEMBLY FC2 ON SHEET A0.03 FOR FIRE SEPARATION TO BE PROVIDED THROUGHOUT THE FLOOR OF SECOND FLOOR TO SEPARATE UNIT 2 FROM UNIT1.
- 11. NEW FLOOR TO BE ADDED ON SECOND FLOOR BY ADDING NEW 2"x6" FLOOR JOISTS. (REFER TO SHEET A2.04 FOR FLOOR JOISTS FRAMING PLAN)
- 12.INSTALL NEW FLOOR FINISHES THROUGHOUT
- 13. INSTALL NEW TRIMS & BASEBOARDS
- 14.INSTALL NEW ELECTRICAL LIGHT FIXTURES IF NEEDED.

NOTE:

ALL NEW FIXTURES, APPLIANCES, FINISHES, DOORS, WINDOWS, TRIMS TO BE CONFIRMED WITH OWNER PRIOR TO ORDERING AND INSTALLATION.

CONTRACTOR TO VERIFY DIMENSIONS ON SITE AND REPORT ANY DISCREPANCIES TO THE DESIGNER RIGHT AWAY.

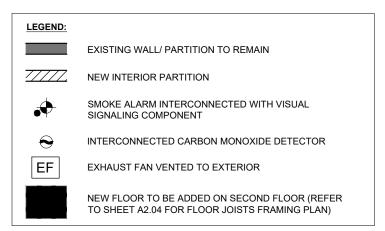

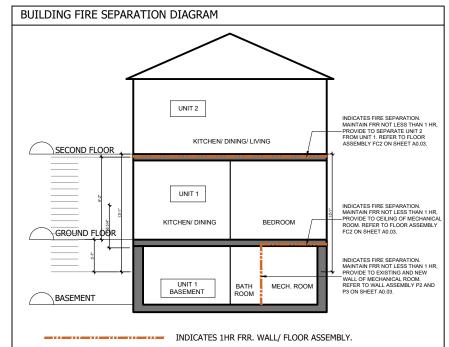



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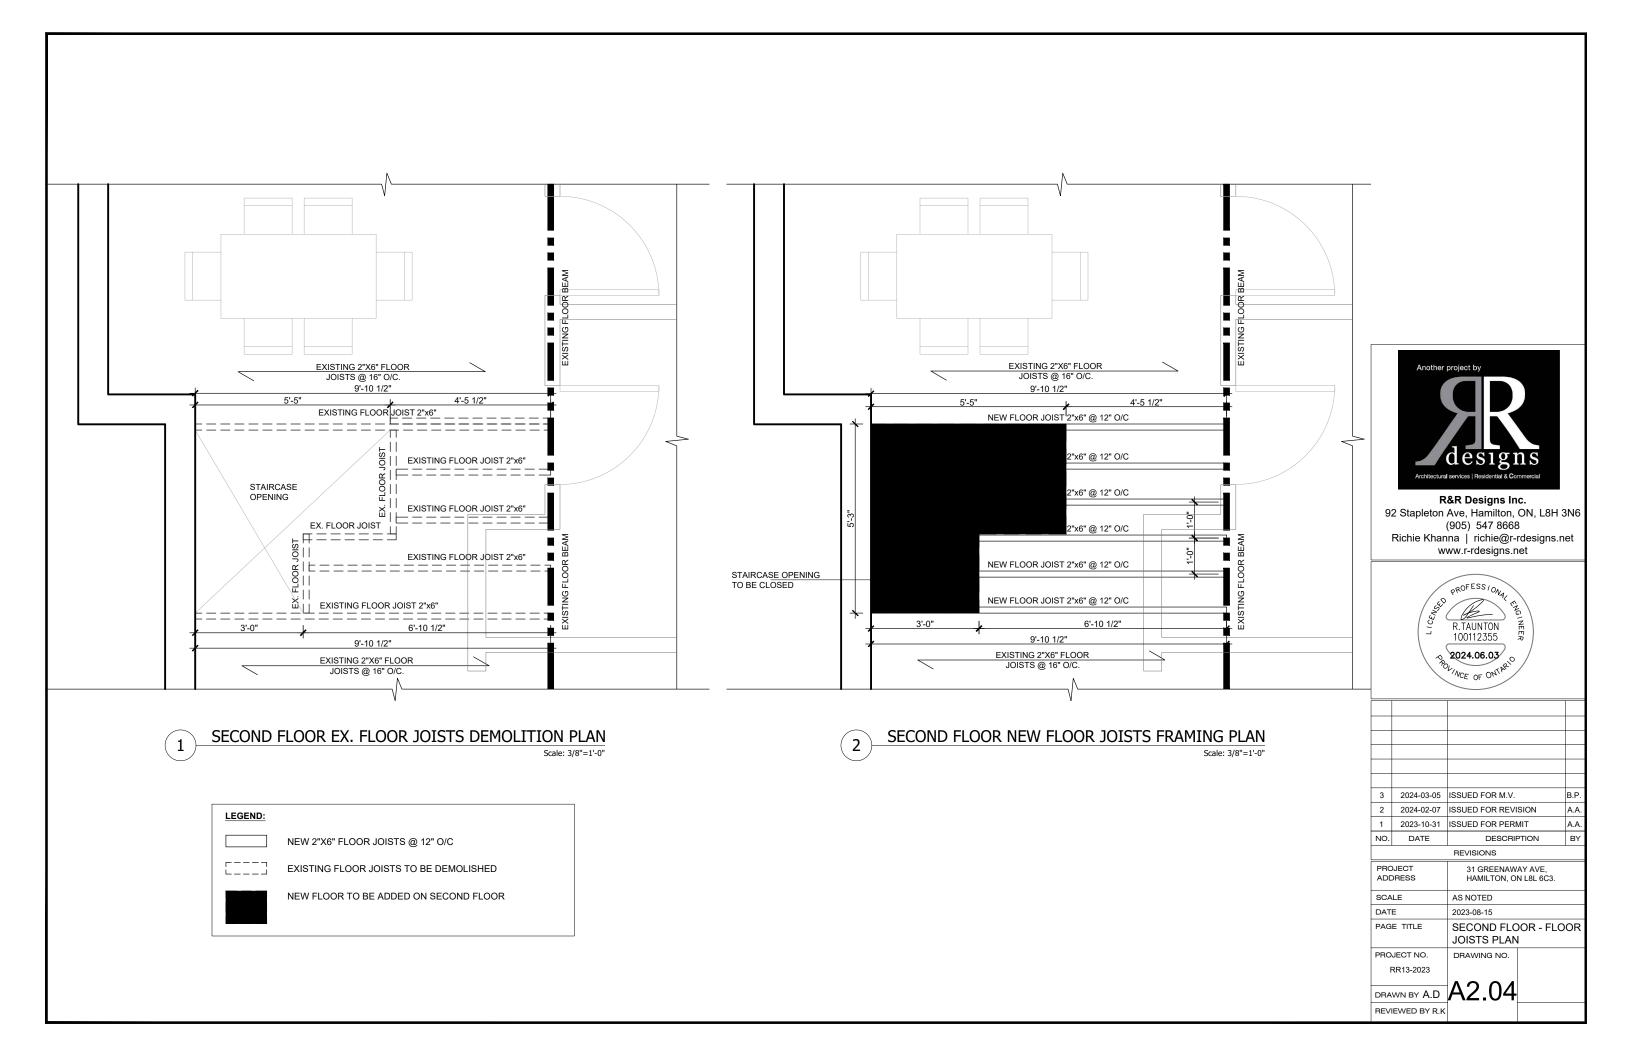



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PROJECT 31 GREENAWAY AVE, ADDRESS HAMILTON, ON L8L 6C3.			

DRAWN BY A.A
REVIEWED BY R.K

RR13-2023





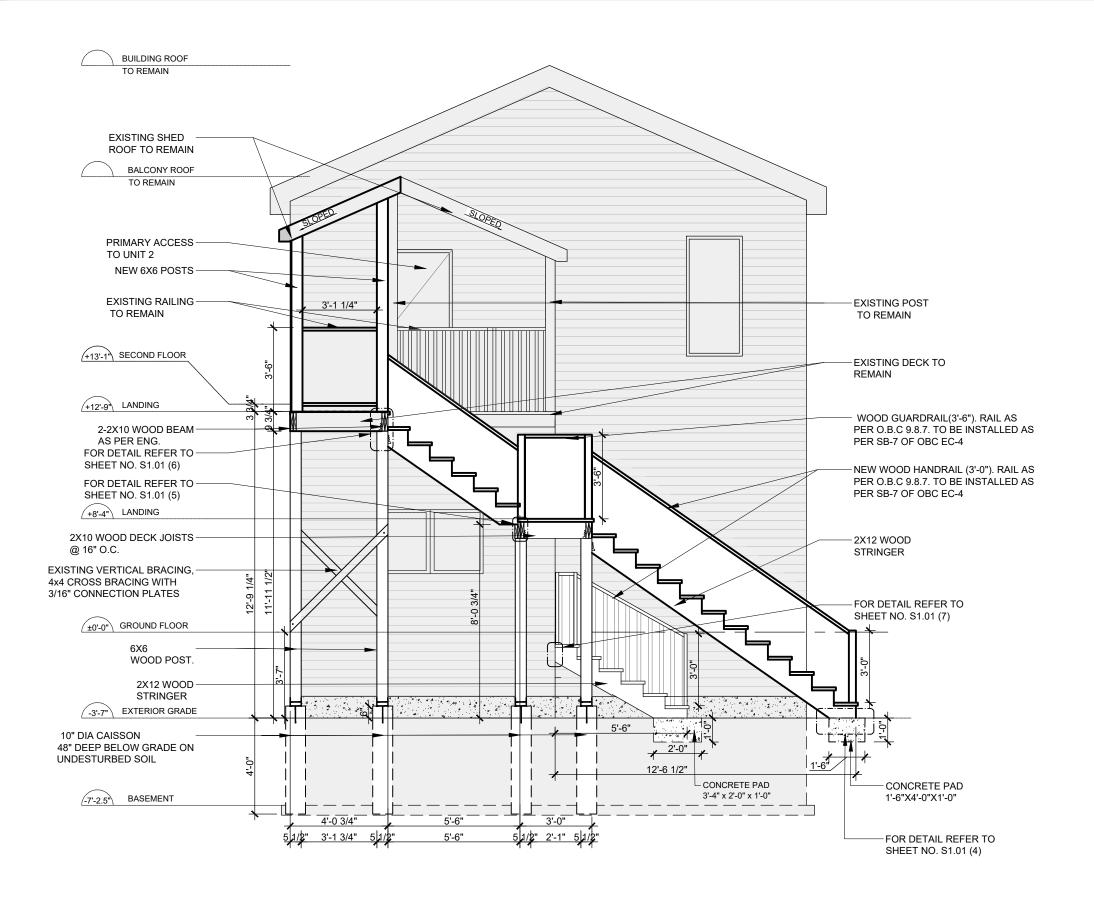



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PRC	JECT	31 GREENAWAY AVE,	

 ADDRESS
 HAMILTON, ON L8L 6C3.

 SCALE
 AS NOTED

 DATE
 2023-08-15

 PAGE TITLE
 REAR STAIR ELEVATION

PROJECT NO. RR13-2023 DRAWING NO.

DRAWN BY A.D. A3.01
REVIEWED BY R.K

REAR STAIR ELEVATION

1

Scale: 3/8"=1'-0"

GENERAL STRUCTURAL NOTES:

- ONTARIO BUILDING CODE, LATEST EDITION, SHALL BE THE BASIS FOR CONSTRUCTION AND DESIGN WORK ON THIS PROJECT.
- 2. THE CONTRACTOR SHALL FIELD CHECK AND VERIFY ALL CONDITIONS AND MEASUREMENTS AT THE SITE.
- 3. OCCUPATIONAL HEALTH AND SAFETY REGULATIONS FOR CONSTRUCTION PROJECTS IN ONTARIO, LATEST EDITION, SHALL GOVERN DESIGN AND CONSTRUCTION WORK ON THIS PROJECT.
- CONTRACTOR SHALL CONTACT THE CONSULTANT FOR AN INSPECTION OF STEEL REINFORCEMENT PRIOR TO POURING THE CONCRETE.
- 5. COMPACTION OF GRANULAR MATERIAL SHALL BE TESTED BY PERSONNEL OF A GEOTECHNICAL COMPANY AND THE RESULTS SENT TO THE CONSULTANT.

FOUNDATIONS:

- GRANULAR 'A' FILL MATERIAL FOR SLABS AND UNDISTURBED SOIL OR COMPACTED FILL MATERIAL CAPABLE OF SUSTAINING A MINIMUM ALLOWABLE BEARING CAPACITY OF 2,000 PSF.
- 2. PROVIDE 10" MINIMUM COMPACTED TOP LAYER OF GRANULAR "A" MATERIAL UNDER THE SLAB AREA.
- 3. IF SLAB OR FOUNDATION ARE PLACED ON BACKFILLED MATERIAL; COMPACT THE MATERIAL TO A MINIMUM OF 98% STANDARD PROCTOR DENSITY IN 8" THICK LAYERS (MAX).
- 4. ALL STRIP FOOTINGS SHALL BE A MINIMUM OF 16" WIDE AND 8" DEEP WITH TWO 15M LONGITUDINAL BARS. THE UNDERSIDE OF FOOTING SHALL BE A MINIMUM OF 4' BELOW GRADE (IN SOUTHERN ONTARIO).

CONCRETE:

- 1. CONCRETE WORK SHALL CONFORM TO THE REQUIREMENTS OF CSA-CAN-A23.1 AND A23.3., LATEST EDITION. (OBC 9.3.1.4.)
- 2. CONCRETE SHALL HAVE MINIMUM COMPRESSIVE STRENGTH AFTER 28 DAYS OF 4650 psi (32MPa)
- 3. REINFORCEMENT STEEL SHALL BE DEFORMED BARS CONFORMING TO CSA-G30.1 2, HAVING A MINIMUM YIELD STRENGTH OF 58psi (400MPa).
- 4. MINIMUM CONCRETE COVER FOR REINFORCING STEEL SHALL BE 1.5" U.N.O. WHEN EXPOSED TO WEATHER THE MINIMUM COVER IS 2". WHEN EXPOSED TO SOIL, THE MINIMUM COVER IS 3".
- 5. CONTRACTOR TO PROVIDE THE NECESSARY MEANS TO SUPPORT AND KEEP STEEL

- REINFORCEMENT IN HE INDICATED POSITIONS DURING WORKING OPERATIONS AND PLACING CONCRETE
- 6. CONCRETE SLABS TO HAVE A STEEL TROWEL FINISH, U.N.O.
- 7. CONCRETE SLAB SEALER SHALL BE "SIKAFLOOR S3" OR EQUIVALENT.

ANCHOR RODS:

- 1. ALL ANCHOR RODS SHALL BE G40.21M 50W WITH MINIMUM TENSILE STRENGTH 65KSI (450MPA).
- 2. ALL ANCHOR RODS OR DOWELS TO EXISTING CONCRETE SHALL BE HILTI HIT HY200 MAX ADHESIVE ANCHORS UNLESS NOTED OTHERWISE. STRENGTH OF MATERIAL AND INSTALLATION METHOD SHALL CONFORM TO MANUFACTURER'S SPECIFICATION.
- 3. ALL ADHESIVE ANCHOR RODS SHALL BE HILTI HAS-E THREADED ROD OR EQUIVALENT THREADED ROD TO BE APPROVED BY CONSULTANT.
- 4. ALL ANCHOR RODS SHALL BE COMPLETE WITH HEAVY HEXAGON NUTS PLUS PLATE WASHER. ANCHOR PLATES SHALL CONFORM TO CSA G40.21M 44W.
- 5. WELDING TO SECURE ANCHOR PLATE TO ANCHOR ROD(S) SHALL CONFORM TO CSA W47.1, W48.1 AND W59 USING LOW HYDROGEN ELECTRODES AND SHALL BE UNDERTAKEN ONLY BY WELDERS HOLDING CERTIFICATION FOR THE PROCESS, POSITION AND CLASS OF ELECTRODES INVOLVED.
- 6. ANCHOR ROD PROJECTIONS AND ANCHOR ROD THREADS SHALL BE SUFFICIENT TO SECURE BOTTOM PLATE OF WALL OR COLUMN BASE PLATE
- ANCHOR ROD PLACEMENT TOLERANCES PER CSA A23.1 CLAUSE 6.7, UNLESS OTHERWISE NOTED ON CONTRACT DRAWINGS.

WOOD:

- 1. ENGINEERING DESIGN IN WOOD SHALL COMPLY WITH CAN/CSA-086-01, INCLUDINGSUPPLEMENT CAN/CSA-086S1-05.
- 2. ALL LUMBER SHALL BE SPRUCE-PINE-FIR NO.1.
- 3. MAX. MOISTURE CONTENT SHALL BE 19% AT TIME OF INSTALLATION.
- 4. JOISTS TO HAVE MIN. 38MM BEARING.
- 5. FASTENERS SHOULD PENETRATE MIN. 50% OF THE LAST MEMBER OR NOT LESS THAN 89MM LONG, WHICH EVER IS GREATER.
- 6. NAILS ARE TO CONFORM TO CSA B111/P.9-88.
- 7. SCREWS MUST CONFORM TO ANSI/ASME N18.6-1-1981 FOR WOOD SCREWS (INCH SERIES)
- 8. 5/8" DIA. BY 10" LONG WITH 6" EMBEDMENT BOTTOM

SILL GALVANIZED ANCHORS WITH NUTS AND WASHERS AT MAX. 6' ON CENTER AND AT CORNERS AND WALL ENDS.


STRUCTURAL STEEL:

- 1. STRUCTURAL STEEL SHALL BE FABRICATED AND ERECTED IN ACCORDANCE WITH THE CAN/CSA STANDARD S16-09 "LIMIT STATES DESIGN OF STEEL STRUCTURES".
- 2. STEEL SHALL CONFORM TO CAN/CSA STANDARD G40.20 "GENERAL REQUIREMENTS FOR ROLLED OR WELDED STRUCTURAL QUALITY STEEL" AND TO CAN/CSA STANDARD G40.21 "STRUCTURAL QUALITY STEELS" TO THE FOLLOWING GRADES:
- HOT ROLLED SHAPES 44W (300MPA), EXCEPT TO WIDE FLANGE SHAPES WHICH WILL CONFORM TO G20.21M - 50W (350MPA)
- PLATES NOT GREATER THAN 1 ½" (38MM) THICKNESS - 50W (350MPA)
- COLD FORMED STEEL ASTM A 653/A 653M GRADE 50W (350MPA)
- HSS (CLASS H) 50W (350MPA) IF 6" (152MM) OR GREATER
- HSS (CLASS C) 50W (350MPA) IF LESS THAN 6" (152MM)
- ANCHOR BOLTS 50W (350MPA)
- 3. ALL METAL-ARC WELDING SHALL BE IN ACCORDANCE WITH CSA STANDARD W59 LATEST REVISION "WELDED STEEL CONSTRUCTION (METAL ARC WELDING)" & SHALL BE UNDERTAKEN ONLY BY WELDERS HOLDING A VALID CERTIFICATION (QUALIFIED TO CSA W47.1) FOR THE PROCESS POSITION AND CLASS OF ELECTRODES INVOLVED.
- 4. ALL ELECTRODES SHALL BE LOW HYDROGEN E70XX CONFORMING TO CSA W48.
- 5. ALL WELDS SHALL BE CONTINUOUS UNLESS NOTED OTHERWISE.
- MINIMUM SIZE OF FILLET WELDS TO BE 1/4" (6MM)
 OR AS REQUIRED BY MATERIAL THICKNESS OR
 PARTS JOINED, UNLESS NOTED OTHERWISE.
- 7. ALL BOLTED FASTENERS SHALL BE ASTM A325 STRUCTURAL BOLTS COMPLETE WITH HARDENED WASHERS AND HEAVY HEX NUTS UNLESS NOTED OTHERWISE.
- 8. HSS ENDS SHALL BE CLOSED WITH 3/16" (5MM) THICK CAP PLATE UNLESS NOTED OTHERWISE. PLATE TO BE SEAL WELDED TO HSS.




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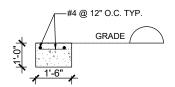


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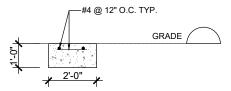
TYP. CASSION & POST CONNECTION

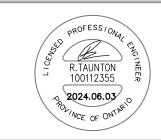Scale: 3/4"=1'-0"

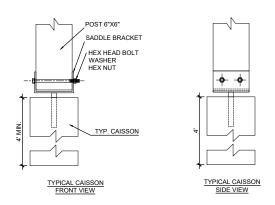


2 CONCRETE PAD DETAIL (1)

Scale: 1/4"=1'-0"




3 CONCRETE PAD DETAIL (2)
Scale: 1/4"=1"-0"


4

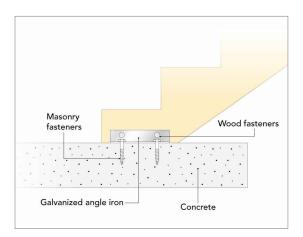


CONCRETE PAD & STAIR CONNECTION

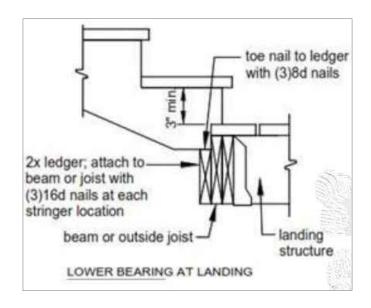

5 STAIR TO LANDING CONNECTION

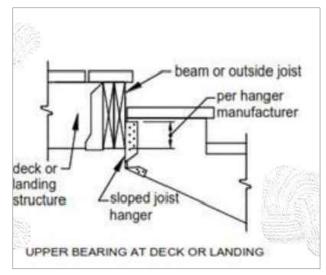

6 LANDING TO STAIR CONNECTION
Scale: N/A

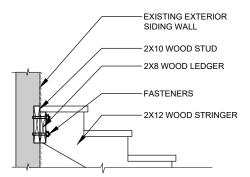


7 EXISTING WALL CONNECTION TO NEW STAIR

Scale: 1/2"=1'-0"



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Committee of Adjustment City Hall, 5th Floor,

71 Main St. W., Hamilton, ON L8P4Y5

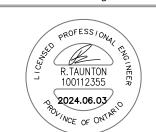Phone: (905) 546-2424 ext. 4221

Email: cofa@hamilton.ca

APPLICATION FOR A MINOR VARIANCE/PERMISSION

UNDER SECTION 45 OF THE PLANNING ACT

 APPLICANT INFORMATION

Phone:
Phone:
Phone:
E-mail:
☐ Owner ☐ Agent/Solicitor
☑ Owner☐ AgentSolicitor
□ No
] No
d owner(s) AND the Applicant/Agent result in the voiding of this service.
☑ Credit over phone*
r

2. LOCATION OF SUBJECT LAND

2.1 Complete the applicable sections:

Municipal Address	31 Greenaway A	venue	and a second
Assessment Roll Number	2518030233502800000		
Former Municipality	Hamilton		9
Lot		Concession	
Registered Plan Number	17199-0065	Lot(s)	
Reference Plan Number (s)		Part(s)	

2.2	Are there any easements or restrictive covenants affecting the subject land?
	☐ Yes ☑ No If YES, describe the easement or covenant and its effect:
3.	PURPOSE OF THE APPLICATION
	ditional sheets can be submitted if there is not sufficient room to answer the following estions. Additional sheets must be clearly labelled
All d	dimensions in the application form are to be provided in metric units (millimetres, metres, hectares,
3.1	Nature and extent of relief applied for: PLEASE SEE ATTACHED - PURPOSE OF THE APPLICATION LETTER (ATTACHED AT THE END OF THS DOCUMENT)

3.2	Why it is not possible to comply with the provisions of the By-law?
	PLEASE SEE ATTACHED - PURPOSE OF THE APPLICATION LETTER (ATTACHED
	AT THE END OF THS DOCUMENT)

AT THE END OF THE BOOOMERT)

☑ Second Dwelling Unit

Is this an application 45(2) of the Planning Act.

Yes

No

☐ Reconstruction of Existing Dwelling

If yes, please provide an explanation:

4. DESCRIPTION OF SUBJECT LAND AND SERVICING INFORMATION

4.1 Dimensions of Subject Lands:

3.3

Lot Frontage	Lot Depth	Lot Area	Width of Street	
(11.33 m(West) & 10.26 m(East)	(15.13 m(North) & 15.24 (South)	162.66 m²	28'-0" / 8.53m	

4.2 Location of all buildings and structures on or proposed for the subject lands: (Specify distance from side, rear and front lot lines) Existing: Date of Front Yard Side Yard Type of Structure Rear Yard Setback Setback Setbacks Construction 0.40m 1.54m 3.03m, 0.26m Existing-Single family dwelling 1992- AS PER SOME DOCUMENTS OBTAINED 0.0m14.67m 4.68m, 4.59m Front staircase 1 (primary access to unit-1) FROM RECORD SEARCH 11.71m 6.03m, 3.94m HOWEVER THE EXISTING Rear staircase 2 (primary staircase to unit 2) 2.12m STRUCTURE MIGHT BE Rear staircase 3 (secondary access to unit 1) 13.53m 5.39m, 0.61m 0.49m OLDER. Proposed: Front Yard Side Yard Date of Type of Structure Rear Yard Setback Construction Setback Setbacks Proposed-Two family dwelling 0.40m 1.54m 3.03m, 0.26m Front staircase 1 (primary access to unit-1) 0.0m 14.67m 4.76m, 4.50m APPROX IN SUMMER 2024, CONSTRUCTION WILL Rear staircase 2 (primary access to unit 2) 11.71m 1.96m 5.46m, 3.94m COMMENCE ONCE THE CLIENT RECEIVES THE CIT Rear staircase 3 (secondary access to unit-1) 13.53 m 0.43m 3.38m, 0.61m PERMIT FOR STAIRCASES 4.3. Particulars of all buildings and structures on or proposed for the subject lands (attach additional sheets if necessary): Existing: Type of Structure Ground Floor Area **Gross Floor Area** Number of Storevs Height Single family dwelling ~83.39m² ~146,47m² existing to remain Proposed: Type of Structure **Ground Floor Area** Gross Floor Area Number of Storeys Height Two family dwelling ~83,39m² ~146.47m² 2 existing to remain 4.4 Type of water supply: (check appropriate box) publicly owned and operated piped water system ☐ lake or other water body privately owned and operated individual well ☐ other means (specify) 4.5 Type of storm drainage: (check appropriate boxes) publicly owned and operated storm sewers ☐ ditches

☐ swales

other means (specify)

4.6	Type of sewage disposal proposed: (check appropriate box)
	□ publicly owned and operated sanitary sewage □ system privately owned and operated individual □ septic system other means (specify)
4.7	Type of access: (check appropriate box) ☐ provincial highway ☐ municipal road, seasonally maintained ☐ municipal road, maintained all year ☐ municipal road, maintained all year
4.8	Proposed use(s) of the subject property (single detached dwelling duplex, retail, factory etc.): Residential- 2 storeys, Two family dwelling
4.9	Existing uses of abutting properties (single detached dwelling duplex, retail, factory etc.): Residential- 2 storeys, single family dwelling
7	HISTORY OF THE SUBJECT LAND
7.1	Date of acquisition of subject lands: 1992 - As per some documents obtained from Record Search however the building might be older
7.2	Previous use(s) of the subject property: (single detached dwelling duplex, retail, factory etc) Single detached
7.3	Existing use(s) of the subject property: (single detached dwelling duplex, retail, factory etc) Residential- 2 storeys, Single family dwelling
7.4	Length of time the existing uses of the subject property have continued: 1992 - As per some documents obtained from Record Search however the building might be older
7.5	What is the existing official plan designation of the subject land?
	Rural Hamilton Official Plan designation (if applicable):
	Rural Settlement Area: N/A
	Urban Hamilton Official Plan designation (if applicable) URBAN HAMILTON OFFICIAL PLAN - SCHEDULE E
	Please provide an explanation of how the application conforms with the Official Plan. 6593 Former Hamilton- Zone H- Community Shopping & Commercial, Etc.
7.6	What is the existing zoning of the subject land?
7.8	Has the owner previously applied for relief in respect of the subject property? (Zoning By-lawAmendment or Minor Variance) ☐ Yes ☐ No
	If yes, please provide the file number:

	☐ Yes	☑ No	
If yes, please provide t	ne file number:		
ADDITIONAL INFORM	MATION		
W 2 6 W 3800 3700 0700	nits Existing: 1		
Number of Dwelling Ur			
Number of Dwelling Ur Number of Dwelling Ur	nits Proposed: 2		

COMPLETE APPLICATION REQUIREMENTS 11.1 All Applications Application Fee Site Sketch ✓ Signatures Sheet 11.4 Other Information Deemed Necessary Cover Letter/Planning Justification Report Authorization from Council or Director of Planning and Chief Planner to submit application for Minor Variance Minimum Distance Separation Formulae (data sheet available upon request) Hydrogeological Assessment ☐ Septic Assessment Archeological Assessment Noise Study ☐ Parking Study