#### **COMMITTEE OF ADJUSTMENT**



City Hall, 5<sup>th</sup> floor, 71 Main Street West, Hamilton, ON L8P 4Y5
Telephone (905) 546-2424, ext. 4221

E-mail: cofa@hamilton.ca

# NOTICE OF PUBLIC HEARING Minor Variance

#### You are receiving this notice because you are either:

- Assessed owner of a property located within 60 metres of the subject property
- Applicant/agent on file, or
- Person likely to be interested in this application

APPLICATION	HM/A-22:294	SUBJECT	735 Beach Boulevard, Hamilton
NO.:		PROPERTY:	
ZONE:	"C" (Urban Protected	ZONING BY-	Zoning By-law former City of
	Residential and Etc.)	LAW:	Hamilton 6593, as Amended 99-
	,		169

**APPLICANTS:** Owner: Amanda & Kevin White

Agent: Barich Grenkie Surveying Ltd. (Julianna Hribljan,)

The following variances are requested:

- 1. A rear yard setback of 3.14 metres to the principle dwelling shall be provided instead of the required rear yard setback of 7.5 metres.
- 2. A rear yard setback of 0.09 metres to the deck shall be provided instead of the required 4.5 metres.
- 3. A side yard setback of 1.43 metres shall be provided instead of the required side yard setback of 1.7 metres.

**PURPOSE & EFFECT:** To permit the construction of a ½ storey addition on the existing Single-Family

Dwelling notwithstanding that:

#### Notes:

- i. Insufficient information has been provided on the submitted site plan to determine the setback of the proposed deck in the rear yard to the rear lot line. Calculations using the submitted elevations have determined a setback from the rear lot line to the edge of the deck to be 0.09 metres where a setback of 4.5 metres is permitted as per Zoning By-Law amendment 99-169 Section 2 a). As such, a variance has been provided to address this. Be advised, should the deck be setback more than 0.09 metres to the rear lot line, additional variances may be required.
- ii. Should the variance be approved to permit a reduced side and rear yard, the eaves/ gutter as proposed shall comply with Section 18(3)(vi)(b) of Hamilton Zoning By-Law 6593.

This Notice must be posted by the owner of any land which contains seven or more residential units so that it is visible to all residents.

This application will be heard by the Committee as shown below:

DATE:	Tuesday, July 23, 2024
TIME:	1:15 p.m.
PLACE:	Via video link or call in (see attached sheet for details)
	City Hall Council Chambers (71 Main St. W., Hamilton)
	To be streamed (viewing only) at
	www.hamilton.ca/committeeofadjustment

For more information on this matter, including access to drawings illustrating this request and other information submitted:

- Visit www.hamilton.ca/committeeofadjustment
- Visit Committee of Adjustment staff at 5th floor City Hall, 71 Main St. W., Hamilton

#### **PUBLIC INPUT**

**Written:** If you would like to submit written comments to the Committee of Adjustment you may do so via email or hardcopy. Please see attached page for complete instructions, written comments must be received no later than noon July 19, 2024

**Orally:** If you would like to speak to this item at the hearing you may do so via video link, calling in, or attending in person. Please see attached page for complete instructions, registration to participate virtually must be received no later than noon July 22, 2024

#### **FURTHER NOTIFICATION**

If you wish to be notified of future Public Hearings, if applicable, regarding HM/A-22:294, you must submit a written request to <a href="mailton.ca">cofa@hamilton.ca</a> or by mailing the Committee of Adjustment, City of Hamilton, 71 Main Street West, 5th Floor, Hamilton, Ontario, L8P 4Y5.

If you wish to be provided a Notice of Decision, you must attend the Public Hearing and file a written request with the Secretary-Treasurer by emailing <a href="mailton.ca">cofa@hamilton.ca</a> or by mailing the Committee of Adjustment, City of Hamilton, 71 Main Street West, 5th Floor, Hamilton, Ontario, L8P 4Y5.



**DATED: July 4, 2024** 

Jamila Sheffield, Secretary-Treasurer Committee of Adjustment Information respecting this application is being collected under the authority of the Planning Act, R.S.O., 1990, c. P. 13. All comments and opinions submitted to the City of Hamilton on this matter, including the name, address, and contact information of persons submitting comments and/or opinions, will become part of the public record and will be made available to the Applicant and the general public, and may include posting electronic versions.



#### **COMMITTEE OF ADJUSTMENT**

City Hall,  $5^{\text{th}}$  floor, 71 Main Street West, Hamilton, ON L8P 4Y5 Telephone (905) 546-2424, ext. 4221

E-mail: cofa@hamilton.ca

#### PARTICIPATION PROCEDURES

#### Written Submissions

Members of the public who would like to participate in a Committee of Adjustment meeting are able to provide comments in writing advance of the meeting. Comments can be submitted by emailing <a href="mailton.ca">cofa@hamilton.ca</a> or by mailing the Committee of Adjustment, City of Hamilton, 71 Main Street West, 5th Floor, Hamilton, Ontario, L8P 4Y5. Comments must be received by noon on the date listed on the Notice of Public Hearing.

Comments are available the Friday prior to the Hearing and are available on our website: www.hamilton.ca/committeeofadjustment

#### **Oral Submissions**

Members of the public are also able to provide oral comments regarding Committee of Adjustment Hearing items by participating Virtually through Webex via computer or phone or by attending the Hearing In-person. Participation Virtually requires pre-registration in advance. Please contact staff for instructions if you wish to make a presentation containing visual materials.

#### 1. Virtual Oral Submissions

Interested members of the public, agents, and owners **must register by noon on the day listed on the Notice of Public Hearing to** participate Virtually.

To register to participate Virtually by Webex either via computer or phone, please contact Committee of Adjustment staff by email <a href="mailton.ca">cofa@hamilton.ca</a>. The following information is required to register: Committee of Adjustment file number, hearing date, name and mailing address of each person wishing to speak, if participation will be by phone or video, and if applicable the phone number they will be using to call in.

A separate registration for each person wishing to speak is required. Upon registering for a meeting, members of the public will be emailed a link for the Webex meeting one business day before the Hearing. Only those registered will be called upon to speak.

#### 2. In person Oral Submissions

Interested members of the public, agents, and owners who wish to participate in person may attend Council Chambers on the date and time listed on the Notice of Public Hearing. Please note, you will be required to provide your name and address for the record. It is advised that you arrive **no less than 10 minutes** before the time of the Public Hearing as noted on the Notice of Public Hearing.

We hope this is of assistance and if you need clarification or have any questions, please email cofa@hamilton.ca.

Please note: Webex (video) participation requires either a compatible computer or smartphone and an application (app/program) must be downloaded by the interested party in order to participate. It is the interested party's responsibility to ensure that their device is compatible and operating correctly prior to the Hearing.

MUNICIPAL ADDRESS
735 BEACH BLVD. HAMILTON


LEGAL DESCRIPTION

PART OF BURLINGTON BEACH,
EAST SIDE OF BEACH BOULEVARD (UNREGISTERED)
CITY OF HAMILTON

ZONING
C/S-1435

BYLAW	PROPOSED
N/A	831.41 m <sup>2</sup> (EX)
6.0 m	42.30 m
4.5 m	3.14 m*
1.7 m	1.43 m*
1.7 m	4.34 m
11.0 m	6.27 m
12.0 m	15.04 m (EX)
N/A	9.60%
	N/A 6.0 m 4.5 m 1.7 m 1.7 m 11.0 m 12.0 m

<sup>\*</sup> REQUIRES A MINOR VARIANCE WITH THE CITY OF HAMILTON

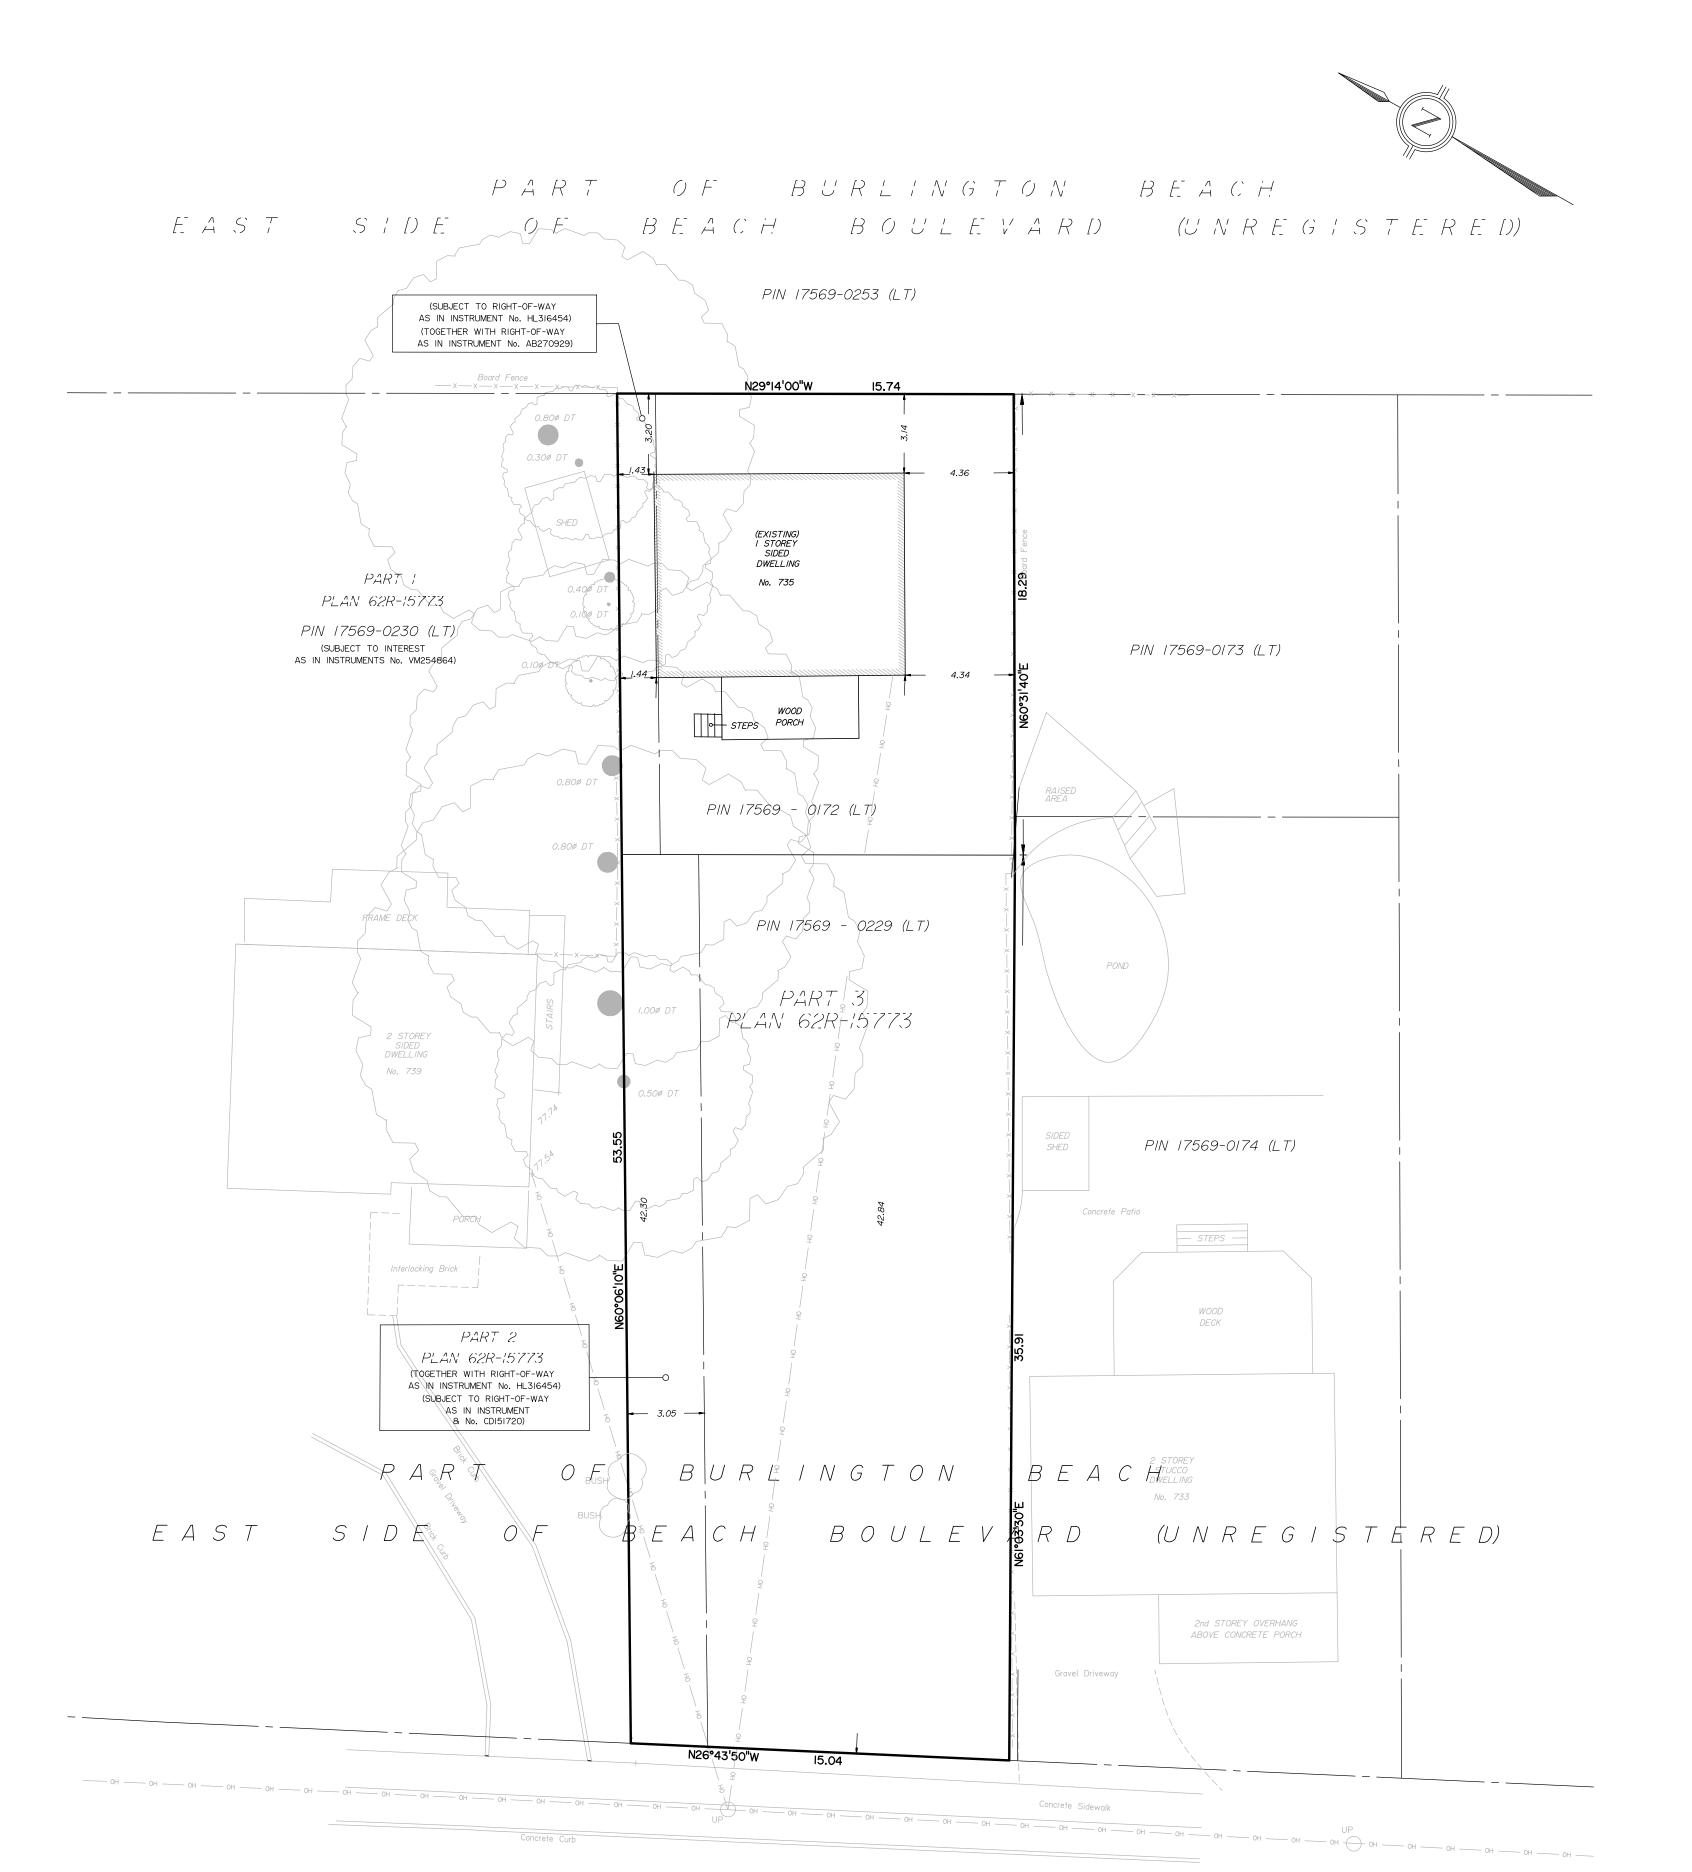

(ALSO KNOWN AS REGIONAL ROAD No. 114) B E A C H B O U L E V A R D(TRANSFERRED BY ORDER-IN-COUNCIL, OC-2180/64, EFFECTIVE JULY 9, 1964, INSTRUMENT 1469 MISC.)

PIN 17569-0223 (LT)

NOT TO SCALE ADDRESS: 735 BEACH BLVD., HAMILTON SITE PLAN FOR MINOR VARIANCE OF PART OF BURLINGTON BEACH BOULEVARD (UNREGISTERED) GEOGRAPHIC TOWNSHIP OF SALTFLEET CITY OF HAMILTON BARICH GRENKIE SURVEYING LTD. A DIVISION OF GEOMAPLE © COPYRIGHT 2022 DISTANCES AND ELEVATIONS SHOWN ON THIS PLAN ARE IN METRES AND CAN BE CONVERTED TO FEET BY DIVIDING BY 0.3048 DENOTES DECIDUOUS TREE DENOTES SUBJECT LANDS BOUNDARY
DENOTES DEED LINE — - — DENOTES LOT LINE —x——x—— DENOTES FENCE LINE N-E-S-W DENOTES NORTH-EAST-SOUTH-WEST DENOTES DOWN SPOUT WITH SPLASH PAD ELEVATION NOTE ELEVATIONS ARE REFERRED TO THE CANADIAN GEODETIC VERTICAL DATUM (CGVD-1928:1978) AND ARE DERIVED FROM CITY OF HAMILTON BENCHMARK No. 0011965U130 HAVING AN ELEVATION OF 76.487 m. 0 02/17/2022 JMH ISSUED FOR REVIEW REVISIONS NO. DATE DESIGN GRCH ⊢FEBRUARY 17, 2022 CHK'D GRCH **APPROVALS** 100086843 Barich Grenkie
Surveying Ltd.
97 HWY No. 8 (UNIT 101) - STONEY CREEK, ON DWN BY: JMH CHK BY: GRCH JOB No. 21-2819 KEVIN AND AMANDA WHITE PROJECT NAME PROPOSED GARAGE 735 BEACH BOULEVARD, HAMILTON

SITE PLAN

21-2819 SGP

PROJECT No.

21-2819


7.NPRO.FCTS\.inhs 2021\21-2819 - 735, Bench Rivd Hamilton\Fraineerinn\21-2819- 5GP HOLSF dwn

Item		0	ntario	Build	ling Code	e Data M	latrix Pa	rts 3 8	k 9		OBC rences are t ivision A or (	o Divisio		
1	Project de				С	New			☐ Part 11		Part 3		■ Part	9
	PROPOSE	ED RENOV		ange of		Addition  Alteration			11.1 to 11.4	1.1.2	2.(A) 2.7. (A)		1.1.2.(A), 1.1.2.7. ( <i>i</i>	
2	Major Occ	cupancy(s)	GRO	JP C						3.1.2	2.1.(1)		9.10.2	
3	Building A	rea (m²)	Existin	ng: 74.94	1m² New	:45.44m²	Total: 12	0.38m²		1.4.1	.2.(A)		1.4.1.2.(	A)
4	Gross Area	а	Floor	Area: 1	120.83m²					1.4.1	.2.(A)		1.4.1.2.(	A)
5	Number o	f Storeys	Abov	e Grade	e: 1.5	Below Gra	ıde: 1			3.2.	1.1 &		9.10.4. 8	ķ.
6	Number o	f Streets/Fir	e Fighte	r Access:	: 1 street					3.2.3	2.10 &		9.10.20	
7	Building C	lassification	n C - Re	esidentic	al occupanc	ies					2.2083		9.10.2	
8	Sprinkler S	ystem Prop	posed			ted compartr ted floor arec ment $\Box$ in		rating		3.2.1 3.2.1 3.2.1 INDE	1.17		9.10.8.2 INDEX	
9	Standpipe	e Required				N	/A [	l Yes	□ No	3.2.9	?		N/A	
10	Fire Alarm	Required				Пи	/A	l Yes	No	3.2.4	1		9.10.18.	
11	Water Ser	vice/Suppl	y is Adec	quate		Пи	/A	l Yes	□ No	3.2.5	5.7		N/A	
12	High Buildi	ing				■ N	/A [	l Yes	□ No	3.2.6	5.		N/A	
13		Construction		□ Comb		Non-combu		Both Both		3.2.2	2.2083		9.10.6.	
14	Mezzanine	e(s) Area m	Ŷ	N/	A					3.2.	1.1.(3)-(8)		9.10.4.1	
15	1	t load base			n²/person 3_persons	■ design of	building	□ As Not	ted	3.1.1	17		9.9.1.3.	
16	Barrier-free	e Design		] Yes	□ No(E>	(plain) 🔳 N	/A			3.8			9.5.2	
17	Hazardous	s Substance	es C	] Yes	■ No					3.3.	1.2. &		9.10.1.3	(4)
18	Require Fire Resistan			Horizont	al Assemblies FFR			d Design N cription (SC		3.2.2	2.2083 2.1.4		9.10.8 9.10.9	
	Rating		Floo	ors	N/A			N/A						
	(FRR)		Roc	of	N/A			N/A						
			Me	zzanine	N/A			N/A						
			FFR	of Supp	orting Memb	ers		ed Design scription (						
			Floo	ors	N/A			N/A						
			Roc	of	N/A			N/A						
			Me	zzanine	N/A			N/A						
19	Spatial Se	paration - (	Construc	ction of E	xterior Walls					3.2.3	3		9.10.14	1
	Wall	Area of EBF (m <sup>2</sup> )	L.D. (m)	L/H or H/L	Permitted Max. % of Openings	Proposed % of Openings	FFR (Hours)		Listed Design or		Comb. Const.	N	o. Const. lonc. adding	Non-comb Const.
	FRONT	35.1	37.7	N/A	100%	10%	N/A		N/A		YES		-	-
	REAR	56.4	4.55	N/A	28%	26.1%	N/A		N/A		YES		-	-
	LEFT	42.32	1.5	N/A	7%	0%	N/A		N/A		YES		-	-
	RIGHT	42.32	4.2	N/A	32%	19.6%	N/A		N/A		YES		-	-
	•		-		•	•	•	•		_				-

ZONING REQUIREMENTS				
	REQ'D/PERMITTED UNDER ZONING BY-LAW	EXISTING	PROPOSED	
ZONING DESIGNATION	RESIDENTIAL	DISTRICT "C"	N/A	
MIN. SIDE YARD SETBACK	0.45 M (1.48 FT)	1.5M (4.92 FT)	1.5M (4.92 FT)	
MIN. REAR YARD SETBACK	0.45 M (1.48 FT)	4.55M (14.9 FT)	1.96M (6.43 FT)	
MAX BUILDING HEIGHT	11 M(36.09 FT)	6.3M (20.58 FT)	6.3M (20.58 FT)	
MAX. REAR YARD AND SIDE YARD COMBINED COVERAGE	MAX 30% COVERAGE = (830.94m2*0.3) = 249.28m2	91.94m2 (989.63 SQ. FT)	113.31m2 (1219.7 SQ. FT)	

#### **GLAZING CALCULATIONS**

EXISTING BUILDING FACE:	145.26m²
EXISTING GLAZING:	16.6m²
% EX. GLAZING COVERAGE:	11.4%
PROPOSED BUILDING FACE:	176.14m²
PROPOSED GLAZING:	20.63m²
% PROPOSED GLAZING COVERAGE:	11.7%

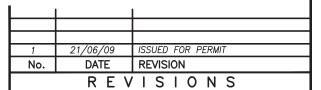



300 YORK BLVD HAMILTON, ONTARIO L8R 3K6 905-333-9119

# INTERIOR/EXTERIOR HOME RENOVATION

735 BEACH BOULEVARD

HAMILTON


ONTARIO


S0.02


# GENERAL NOTES

DATE	DRAWN BY
JUNE 2021	<b>JD</b>
PROJECT No.	CHECKED BY
<b>21127</b>	<b>J.P.C.</b>

J. P. G. OAMPANA 19 100/138224
2021-06-09
Project 2112/

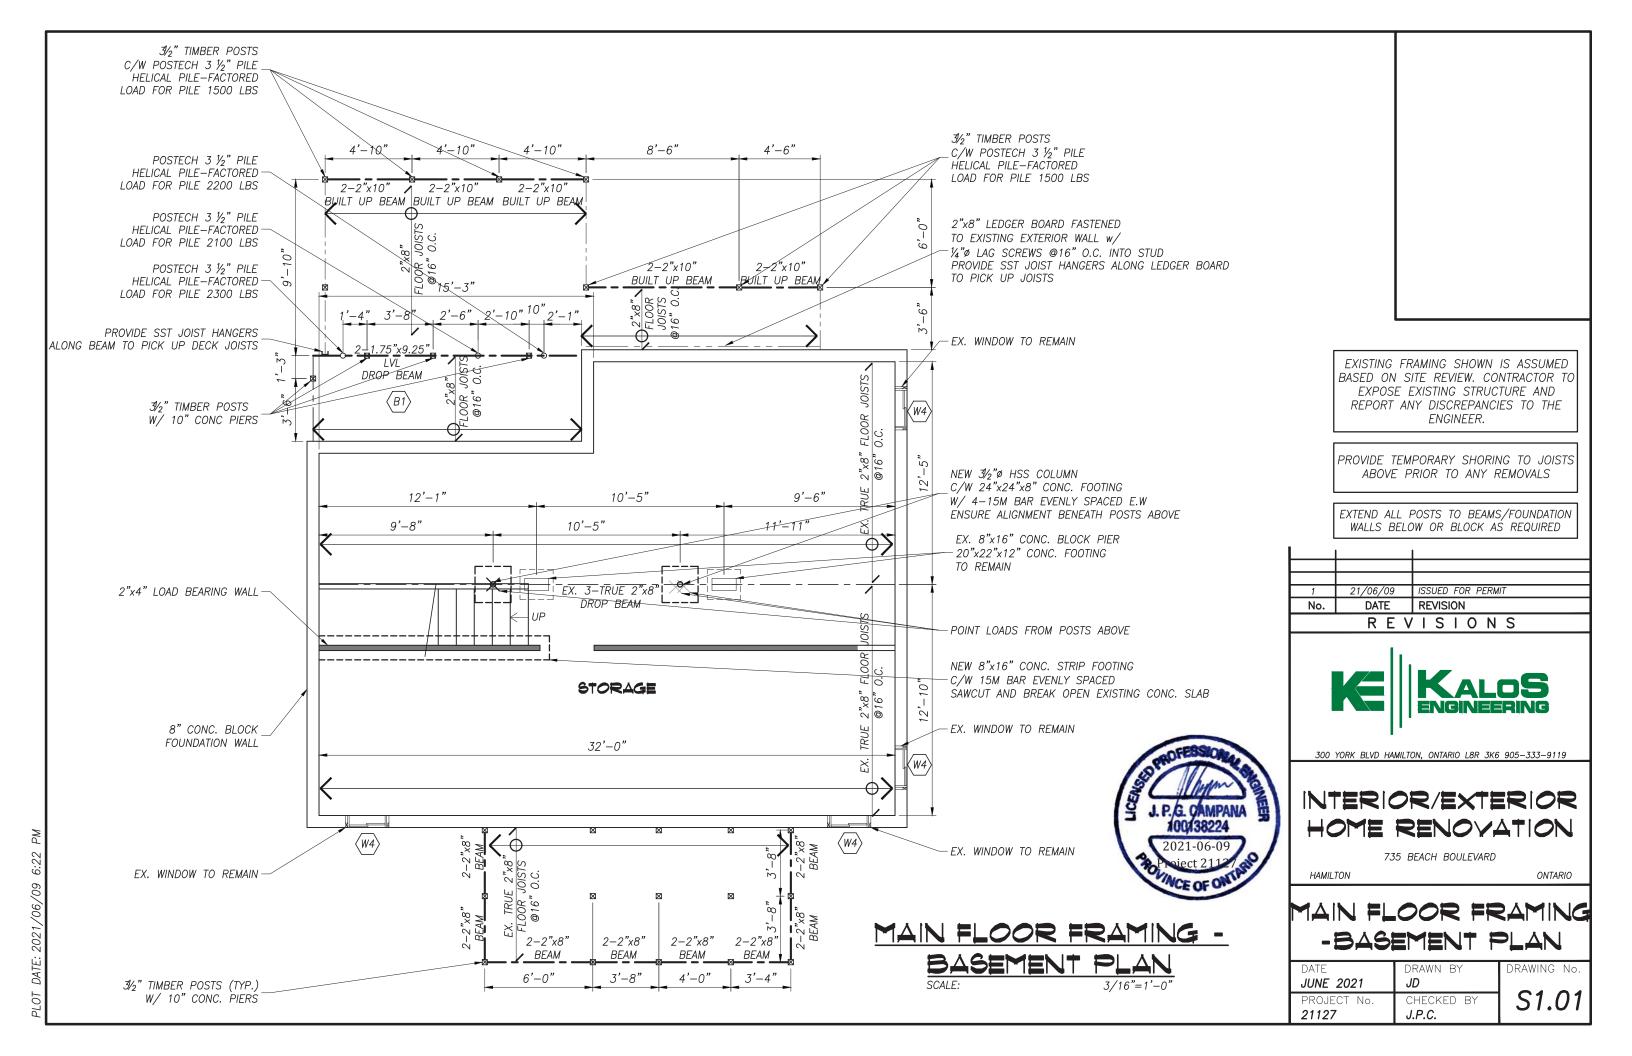

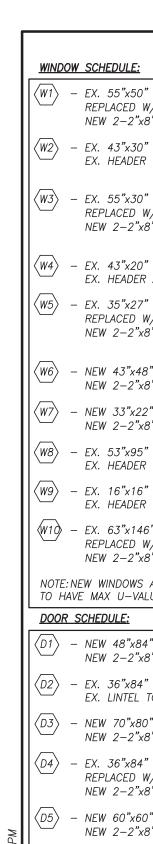

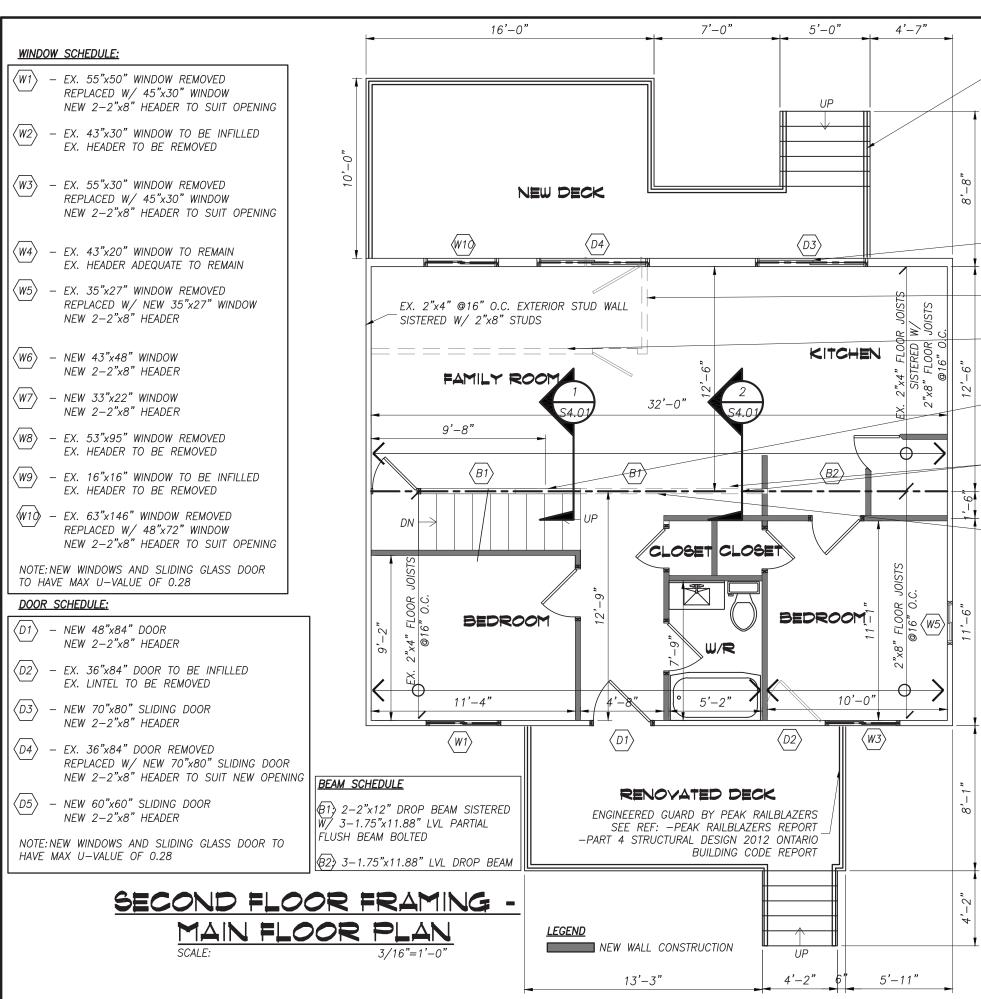

**DESIGN LOADING:** 

MAIN FLOOR:

DEAD LOAD = 15 psfLIVE LOAD = 40 psf

SECOND FLOOR:

DEAD LOAD = 15 psfLIVE LOAD = 40 psf

ROOF LOAD (HAMILTON BELOW ESCARPMENT EAST OF HWY 403)

= 27.2 psf= 8.4 psf

21/06/09 ISSUED FOR PERMIT DATE REVISION

REVISIONS



300 YORK BLVD HAMILTON, ONTARIO L8R 3K6 905-333-9119

# INTERIOR/EXTERIOR HOME RENOVATION

735 BEACH BOULEVARD

SECOND FLOOR FRAMING-

MAIN FLOOR PLAN

PROJECT No. CHECKED BY 21127

JUNE 2021

S1.02 J.P.C.

EXCEED

THE MINIMUM

REQUIRED GUARD SHALL BE,

DESCRIBED IN CLAUSES (A) AND (B).

GOVERNS FOR

(C) 0.75KN/M OR A

ENGINEERED GUARD BY PEAK RAILBLAZERS SEE REF: -PEAK RAILBLAZERS REPORT

EX. WINDOW TO BE REMOVED -NEW 70"X80" SLIDING DOOR C/W

EX. NON LOAD BEARING WALL

EX. LOAD BEARING WALL TO BE REMOVED

3-2"x4" BUILT UP POST

5-2"x4" BUILT UP POST

EX. LOAD BEARING WALL

TO BE REMOVED

PROVIDE SOLID BLOCKING BELOW

NOTE: GUARD DESIGN TO MEET OR

APPLIED INWARD OR OUTWARD AT

CONCENTRATED LOAD OF 1.0KN APPLIED AT ANY POINT, WHICHEVER

LOCATIONS OTHER THAN THOSE

4.1.5.14(C) OF THE O.B.C.

(1) THE MINIMUM SPECIFIED

HORIZONTAL LOAD

REQUIRED HEIGHT OF EVERY

PROVIDE SOLID BLOCKING TO BEAM BELOW

J. P.G. CAMPANA

100138224

WCE OF ON

TO BE REMOVED

2-2"x8" HEADER TO SUIT OPENING

BUILDING CODE REPORT

-PART 4 STRUCTURAL DESIGN 2012

#### **WINDOW SCHEDULE:**

- W1 EX. 55"x50" WINDOW REMOVED
  REPLACED W/ 45"x30" WINDOW
  NEW 2-2"x8" HEADER TO SUIT OPENING
- W2 EX. 43"x30" WINDOW TO BE INFILLED EX. HEADER TO BE REMOVED
- W3 EX. 55"x30" WINDOW REMOVED
  REPLACED W/ 45"x30" WINDOW
  NEW 2-2"x8" HEADER TO SUIT OPENING
- W4 EX. 43"x20" WINDOW TO REMAIN EX. HEADER ADEQUATE TO REMAIN
- W5 EX. 35"x27" WINDOW REMOVED
  REPLACED W/ NEW 35"x27" WINDOW
  NEW 2-2"x8" HEADER
- √W6 − NEW 43"x48" WINDOW NEW 2-2"x8" HEADER
- W7 NEW 33"x22" WINDOW NEW 2-2"x8" HEADER
- W8 EX. 53"x95" WINDOW REMOVED
  EX. HEADER TO BE REMOVED
- (W9) EX. 16"x16" WINDOW TO BE INFILLED EX. HEADER TO BE REMOVED
- W10 EX. 63"x146" WINDOW REMOVED
  REPLACED W/ 48"x72" WINDOW
  NEW 2-2"x8" HEADER TO SUIT OPENING

NOTE: NEW WINDOWS AND SLIDING GLASS DOOR TO HAVE MAX U-VALUE OF 0.28

#### **DOOR SCHEDULE:**


- (D1) NEW 48"x84" DOOR NEW 2-2"x8" HEADER
- D2 EX. 36"x84" DOOR TO BE INFILLED EX. LINTEL TO BE REMOVED
- D3 NEW 70"x80" SLIDING DOOR NEW 2-2"x8" HEADER
- D4 EX. 36"x84" DOOR REMOVED

  REPLACED W/ NEW 70"x80" SLIDING DOOR

  NEW 2-2"x8" HEADER TO SUIT NEW OPENING
- D5 NEW 60"x60" SLIDING DOOR

  NEW 2-2"x8" HEADER

NOTE: NEW WINDOWS AND SLIDING GLASS DOOR TO HAVE MAX U-VALUE OF 0.28

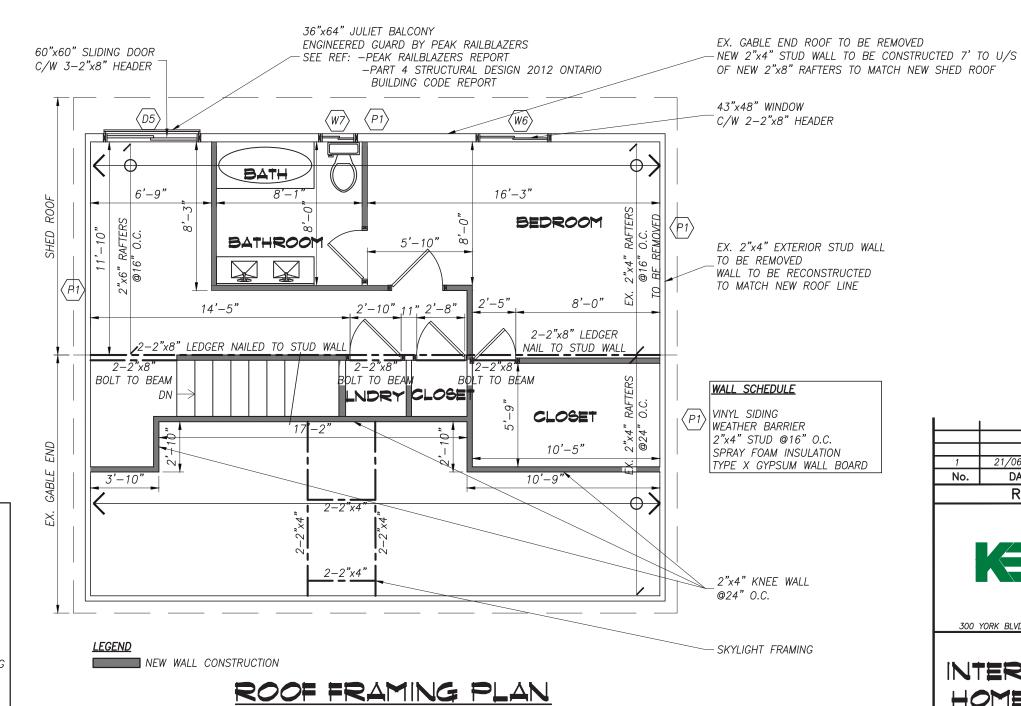

1 21/06/09 ISSUED FOR PERMIT
No. DATE REVISION
REVISION



300 YORK BLVD HAMILTON, ONTARIO L8R 3K6 905-333-9119

# INTERIOR/EXTERIOR HOME RENOVATION

735 BEACH BOULEVARD

HAMILTON

ONTARIO

## ROOF FRAMING PLAN

ATE <b>UNE 2021</b>	DRAWN BY <b>JD</b>	DRAWING No.
ROJECT No. <b>1127</b>	CHECKED BY J.P.C.	S1.03

#### **WINDOW SCHEDULE:**


- $\langle W1 \rangle$  EX. 55"x50" WINDOW REMOVED REPLACED W/ 45"x30" WINDOW NEW 2-2"x8" HEADER TO SUIT OPENING
- EX. 43"x30" WINDOW TO BE INFILLED EX. HEADER TO BE REMOVED
- $\langle W3 \rangle$  EX. 55"x30" WINDOW REMOVED REPLACED W/ 45"x30" WINDOW NEW 2-2"x8" HEADER TO SUIT OPENING
- $\langle W4 \rangle$ - EX. 43"x20" WINDOW TO REMAIN EX. HEADER ADEQUATE TO REMAIN
- $\langle W5 \rangle$ - EX. 35"x27" WINDOW REMOVED REPLACED W/ NEW 35"x27" WINDOW NEW 2-2"x8" HEADER
- $\langle W6 \rangle$ - NFW 43"x48" WINDOW NEW 2-2"x8" HEADER
- NEW 33"x22" WINDOW  $\langle W7 \rangle$ NEW 2-2"x8" HEADER
- EX. 53"x95" WINDOW REMOVED EX. HEADER TO BE REMOVED
- $\langle W9 \rangle$ - EX. 16"x16" WINDOW TO BE INFILLED EX. HEADER TO BE REMOVED
- $\langle W1 \rangle EX. 63"x146"$  WINDOW REMOVED REPLACED W/ 48"x72" WINDOW NEW 2-2"x8" HEADER TO SUIT OPENING

NOTE: NEW WINDOWS AND SLIDING GLASS DOOR TO HAVE MAX U-VALUE OF 0.28

#### **DOOR SCHEDULE:**

- (D1) NEW 48"x84" DOOR NEW 2-2"x8" HEADER
- $\langle D2 \rangle$ - EX. 36"x84" DOOR TO BE INFILLED EX. LINTEL TO BE REMOVED
- NEW 70"x80" SLIDING DOOR NEW 2-2"x8" HEADER
- $\langle D4 \rangle$  EX. 36"x84" DOOR REMOVED REPLACED W/ NEW 70"x80" SLIDING DOOR NEW 2-2"x8" HEADER TO SUIT NEW OPENING
- NEW 60"x60" SLIDING DOOR NEW 2-2"x8" HEADER

NOTE: NEW WINDOWS AND SLIDING GLASS DOOR TO HAVE MAX U-VALUE OF 0.28

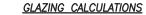

EXISTING BUILDING FACE: 145.26m<sup>2</sup> 16.6m<sup>2</sup> EXISTING GLAZING: % EX. GLAZING COVERAGE: 11.4% PROPOSED BUILDING FACE: 176.14m<sup>2</sup> PROPOSED GLAZING: 20.63m<sup>2</sup> % PROPOSED GLAZING COVERAGE: 11.7%

> EXISTING COVERED PORCH TO BE REMOVED

EXISTING WINDOWS AND DOOR TO BE REMOVED INFILL LOCALLY W/ 2"x4" TO SUIT NEW WINDOW OPENING

PRE-ENGINEERED DECK RAILING

APPLIED INWARD OR OUTWARD AT

CONCENTRATED LOAD OF 1.0KN APPLIED AT ANY POINT, WHICHEVER

REQUIRED HEIGHT OF EVERY

LOCATIONS OTHER THAN THOSE

THE MINIMUM

SHALL BE,

GOVERNS FOR

DESCRIBED IN

REQUIRED GUARD

(C) 0.75KN/M OR A

CLAUSES (A) AND (B).

NCE OF ONT ISSUED FOR PERMIT 21/06/09 DATE REVISION

REVISIONS



300 YORK BLVD HAMILTON, ONTARIO L8R 3K6 905-333-9119

# INTERIOR/EXTERIOR HOME RENOVATION


735 BEACH BOULEVARD

HAMILTON


ONTARIO

# FRONT ELEVATION

DATE	DRAWN BY	DRAWING No.
JUNE 2021	JD	00 04
PROJECT No. <b>21127</b>	CHECKED BY J.P.C.	S2.01
21127	0.1 .0.	

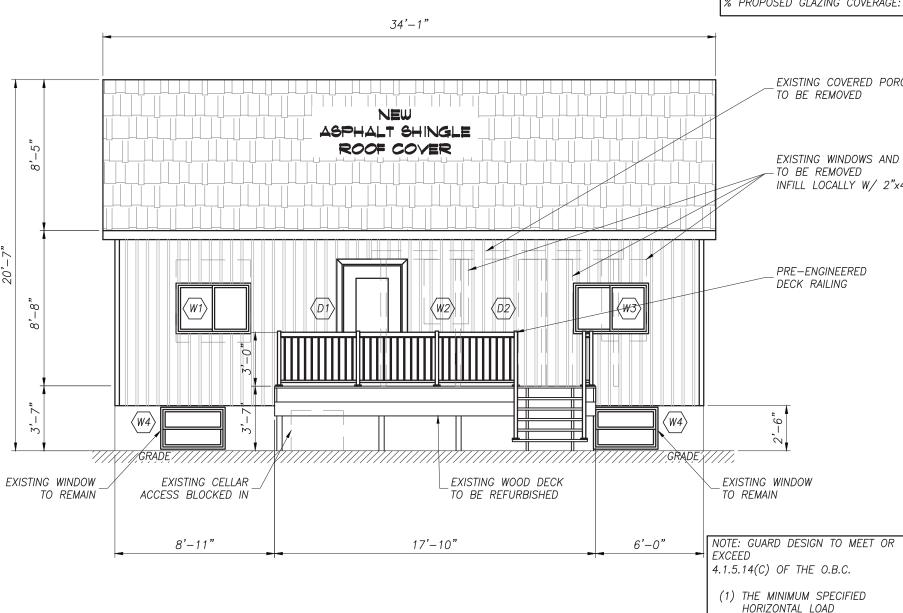

FRONT ELEVATION

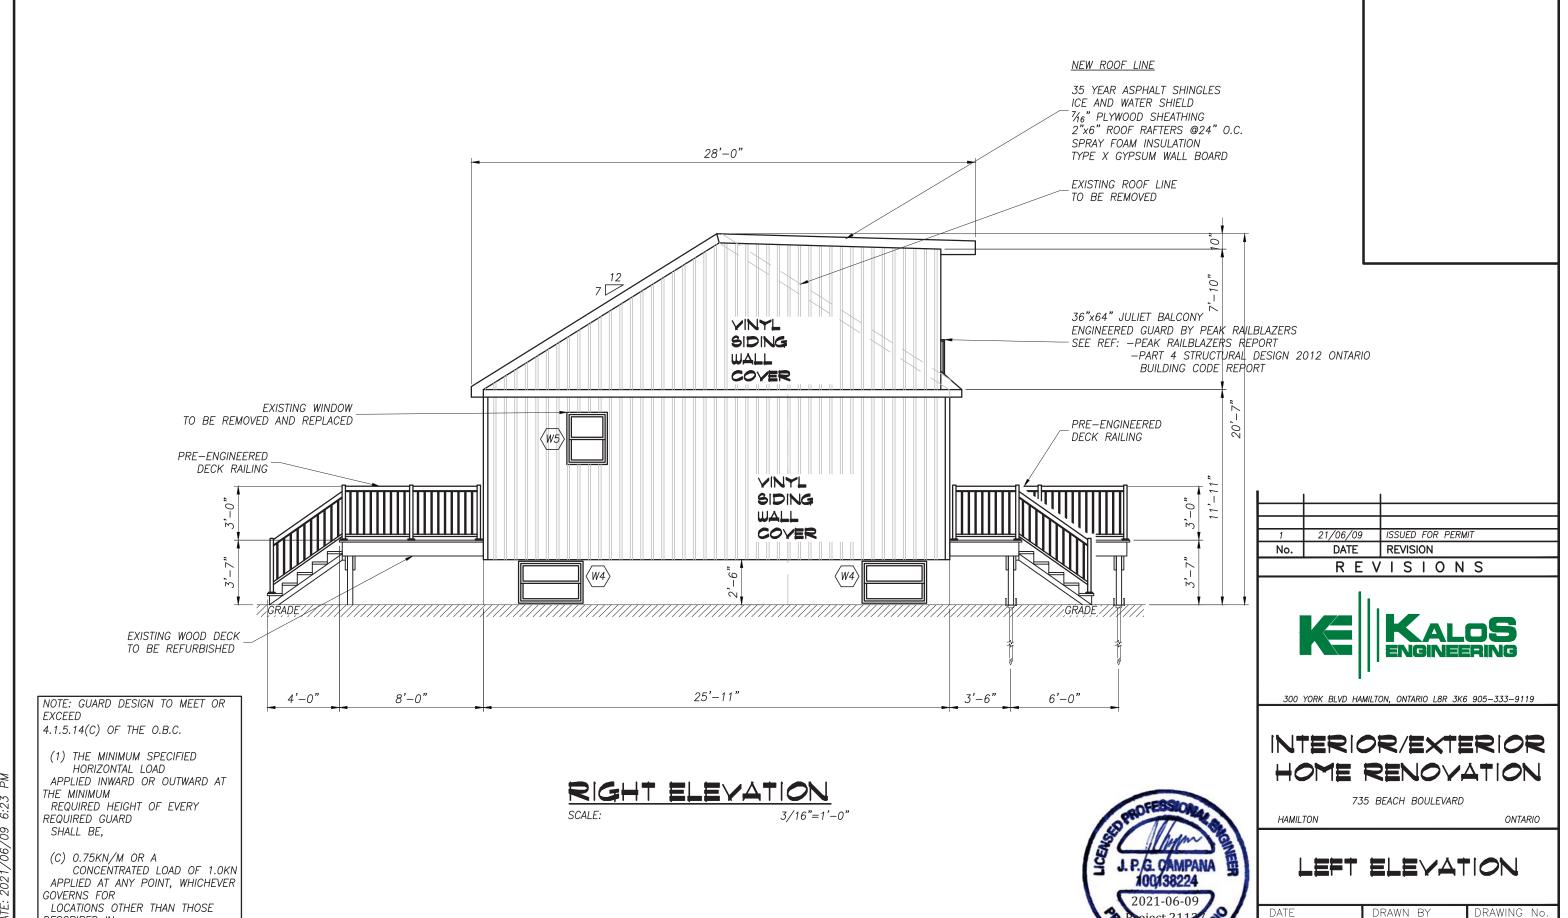

JUNE 2021

21127

PROJECT No.

S2.02

CHECKED BY

J.P.C.

OT DATE: 2021 /06 /00 6:23 DA

DESCRIBED IN

CLAUSES (A) AND (B).

#### **WINDOW SCHEDULE:**

- EX. 55"x50" WINDOW REMOVED REPLACED W/ 45"x30" WINDOW NEW 2-2"x8" HEADER TO SUIT OPENING
- W2 EX. 43"x30" WINDOW TO BE INFILLED EX. HEADER TO BE REMOVED
- W3 EX. 55"x30" WINDOW REMOVED REPLACED W/ 45"x30" WINDOW NEW 2-2"x8" HEADER TO SUIT OPENING
- EX. 43"x20" WINDOW TO REMAIN EX. HEADER ADEQUATE TO REMAIN
- $\langle W5 \rangle$ - EX. 35"x27" WINDOW REMOVED REPLACED W/ NEW 35"x27" WINDOW NEW 2-2"x8" HEADER
- NEW 43"x48" WINDOW NEW 2-2"x8" HEADER
- $\langle W7 \rangle$  NEW 33"x22" WINDOW NEW 2-2"x8" HEADER
- EX. 53"x95" WINDOW REMOVED EX. HEADER TO BE REMOVED
- $\langle W9 \rangle$ - EX. 16"x16" WINDOW TO BE INFILLED EX. HEADER TO BE REMOVED
- EX. 63"x146" WINDOW REMOVED REPLACED W/ 48"x72" WINDOW NEW 2-2"x8" HEADER TO SUIT OPENING

NOTE: NEW WINDOWS AND SLIDING GLASS DOOR TO HAVE MAX U-VALUE OF 0.28

#### **DOOR SCHEDULE:**

- NEW 48"x84" DOOR NEW 2-2"x8" HEADER
- $\langle D2 \rangle$ - EX. 36"x84" DOOR TO BE INFILLED EX. LINTEL TO BE REMOVED
- NEW 70"x80" SLIDING DOOR NEW 2-2"x8" HEADER
- EX. 36"x84" DOOR REMOVED REPLACED W/ NEW 70"x80" SLIDING DOOR NEW 2-2"x8" HEADER TO SUIT NEW OPENING
- $\langle D5 \rangle$  NEW 60"x60" SLIDING DOOR NEW 2-2"x8" HEADER

NOTE: NEW WINDOWS AND SLIDING GLASS DOOR TO HAVE MAX U-VALUE OF 0.28

 $\langle {\it D5} 
angle$ YINYL SIDING WALL COYER  $\langle ws \rangle$  $\langle W9 \rangle$  $\langle D3 \rangle$  $\langle D4 \rangle$ 9-////X/,GRADE −0" DEPTH 6, MIN. 8'-6" 4'-11" 4'-6" 4'-10" 4'-10" 4'-10" 32'-9" NOTE: GUARD DESIGN TO MEET OR

34'-1"

36"x64" JULIET BALCONY ENGINEERED GUARD BY PEAK RAILBLAZERS SEE REF: -PEAK RAILBLAZERS REPORT -PART 4 STRUCTURAL DESIGN 2012 ONTARIO BUILDING CODE REPORT

EXISTING WINDOWS AND DOOR TO BE REMOVED INFILL LOCALLY W/ 2"x4" TO SUIT NEW WINDOW/DOOR OPENING

PRE-ENGINEERED DECK RAILING

POSTECH 3 1/2" PILE

SEE PLAN FOR FACTORED LOAD

HELICAL PILES

4.1.5.14(C) OF THE O.B.C.

(1) THE MINIMUM SPECIFIED

HORIZONTAL LOAD APPLIED INWARD OR OUTWARD AT

REQUIRED HEIGHT OF EVERY

LOCATIONS OTHER THAN THOSE

CONCENTRATED LOAD OF 1.0KN APPLIED AT ANY POINT, WHICHEVER

EXCEED

THE MINIMUM

REQUIRED GUARD SHALL BE,

GOVERNS FOR

DESCRIBED IN

(C) 0.75KN/M OR A

CLAUSES (A) AND (B).

21/06/09 ISSUED FOR PERMIT DATE REVISION REVISIONS



300 YORK BLVD HAMILTON, ONTARIO L8R 3K6 905-333-9119

# INTERIOR/EXTERIOR HOME RENOVATION

735 BEACH BOULEVARD


HAMILTON

ONTARIO

## REAR ELEVATION

D	
HECKED BY . <b>P.C.</b>	S2
	HECKED BY . <b>P.C.</b>


REAR ELEVATION

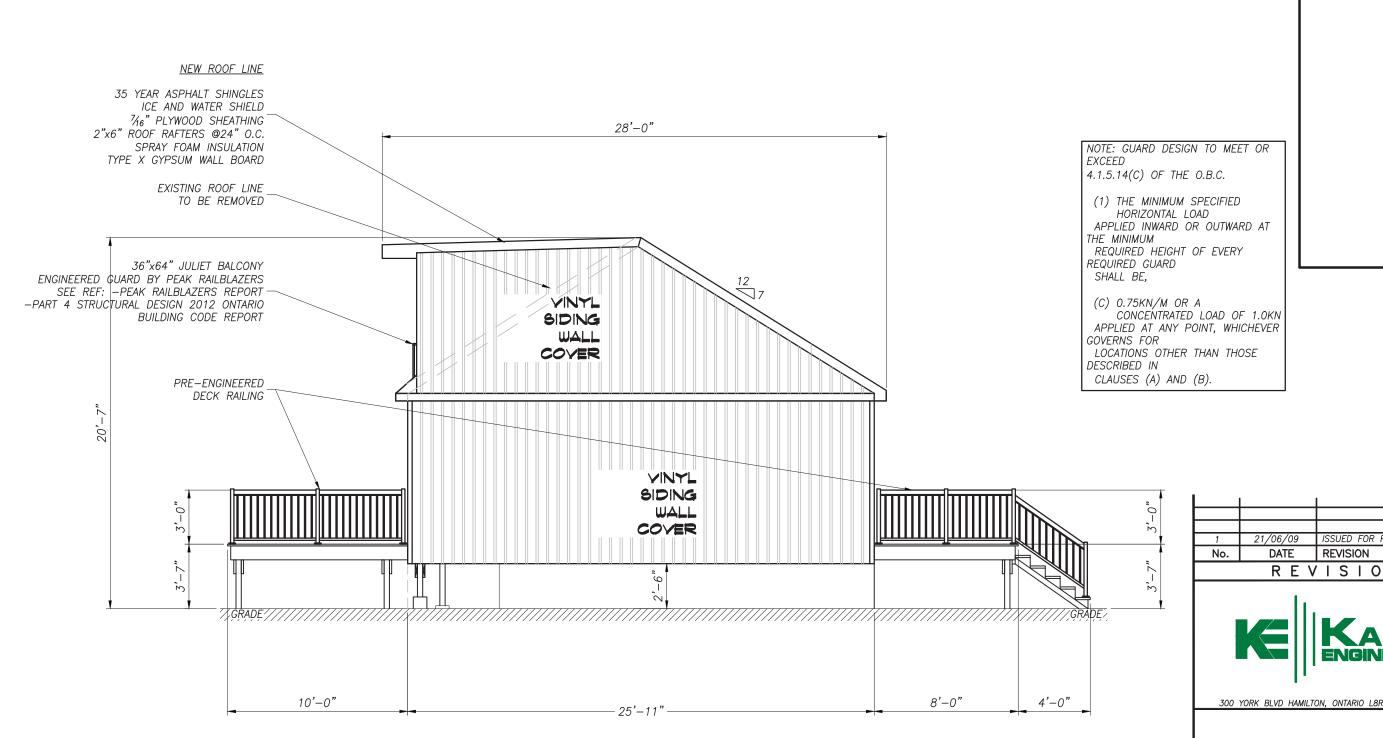

LEFT ELEVATION

3/16"=1'-0" SCALE:



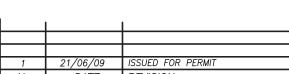

REVISIONS



300 YORK BLVD HAMILTON, ONTARIO L8R 3K6 905-333-9119

# INTERIOR/EXTERIOR HOME RENOVATION


735 BEACH BOULEVARD

HAMILTON

ONTARIO

## RIGHT ELEVATION


JUNE 2021 PROJECT No.	CHECKED BY	<i>S2.04</i>
21127	J.P.C.	

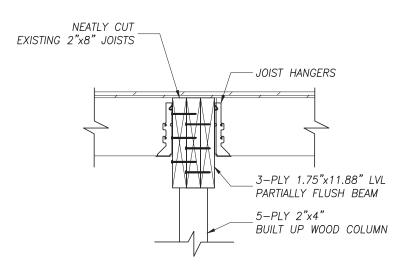


# 2"x8" FLOOR JOISTS TOE NAIL TO BEAM 2 ROWS OF ½"ø THRU BOLTS @12" O.C. (STAGGERED) 2-PLY 2"x12" SISTERED W/ 3-PLY 1.75"x11.88" LVL DROP BEAM 5-PLY 2"x4" BUILT UP WOOD COLUMN

# PARTIALLY FLUSH BEAM DETAIL SCALE: 1"=1'-0" \$1.03



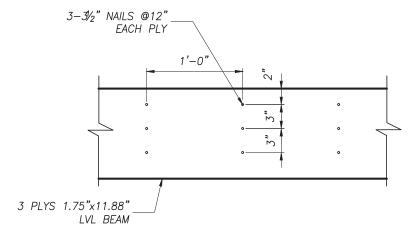

SCALE:

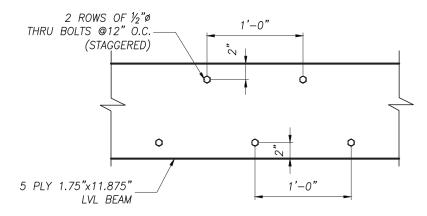

# BEAM NAILING PATTERN

1"=1'-0" **5E**,

BEAM BOLTING PATTERN

SCALE: 1"=1'-0"

	1			
1	21/06/09	ISSUED FOR PERMIT		
No.	DATE	REVISION		
REVISIONS				



300 YORK BLVD HAMILTON, ONTARIO L8R 3K6 905-333-9119

# INTERIOR/EXTERIOR HOME RENOVATION

735 BEACH BOULEVARD

HAMILTON

ONTARIO

DRAWING No.

S4.01

# SECTIONS

DATE	DRAWN BY
JUNE 2021	<b>JD</b>
PROJECT No. <b>21127</b>	CHECKED BY J.P.C.

J. P.G. CAMPANA 100/138224

2021-06-09

Project 2112/ACE OF ONTH



Committee of Adjustment
City Hall, 5th Floor,
71 Main St. W.,

Hamilton, ON L8P4Y5

Phone: (905) 546-2424 ext. 4221 Email: cofa@hamilton.ca

## **APPLICATION FOR A MINOR VARIANCE**

FOR OFFICE USE ONLY.	
APPLICATION NO.	DATE APPLICATION RECEIVED
PAID	DATE APPLICATION DEEMED COMPLETE
SECRETARY'S SIGNATURE	

#### The Planning Act

## **Application for Minor Variance or for Permission**

The undersigned hereby applies to the Committee of Adjustment for the City of Hamilton under Section 45 of the *Planning Act*, R.S.O. 1990, Chapter P.13 for relief, as described in this application, from the Zoning By-law.

Note:

Unless otherwise requested all communications will be sent to the agent, if any.

Names and addresses of any mortgagees, holders of charges or other encumbrances:

Mortgage for the property is with: CIBC 1273 Barton St. E. Hamilton, ON. L8H 2V4

# Additional sheets can be submitted if there is not sufficient room to answer the following questions. Additional sheets must be clearly labelled

4.	Nature and extent of relief applied for:			
	The existing dwelling has had a 1/2 storey addition and would need the following minor variances:			
	rear yard setback - 3.14 m			
	side yard setback - 1.43 m			
	Second Dwelling Unit Reconstruction of Existing Dwelling			
5.	Why it is not possible to comply with the provisions of the By-law?			
	The existing dwelling did not comply with the zoning by-law, previously to work being			
	done on it. The owners have added a second storey to the house. By keeping inline with the first floor of the house the second floor does not meet the minimum setbacks.			
6.	Legal description and Address of subject lands (registered plan must an and latered			
0.	Legal description and Address of subject lands (registered plan number and lot number or other legal description and where applicable, <b>street and street number</b> ):			
	Part of Burlington Beach East Side of Beach Boulevard (Unregistered)			
	735 Beach Boulevard, Hamilton			
7.	PREVIOUS USE OF PROPERTY			
	Residential Industrial Commercial			
	Agricultural 🗌 Vacant 🔲			
	Other			
8.1	If Industrial or Commercial, specify use			
8.2	Has the grading of the subject land been changed by adding earth or other material, i.e. has filling occurred?			
	Yes No Unknown			
8.3	Has a gas station been located on the subject land or adjacent lands at any time?			
	Yes 🗌 No 🔳 Unknown 🗌			
8.4	Has there been petroleum or other fuel stored on the subject land or adjacent lands?			
	Yes No 🔳 Unknown			
8.5	Are there or have there ever been underground storage tanks or buried waste on the subject land or adjacent lands?			
	Yes No Unknown			
8.6	Have the lands or adjacent lands ever been used as an agricultural operation where			
	cyanide products may have been used as pesticides and/or sewage sludge was applied to the lands?			
	Yes No Unknown			
8.7	Have the lands or adjacent lands ever been used as a weapon firing range?			
<b></b>	Yes No Unknown			
8.8	Is the nearest boundary line of the application within 500 metres (1,640 feet) of the fill area			
	of an operational/non-operational landfill or dump?			
	Yes No 🔳 Unknown			
8.9	If there are existing or previously existing buildings, are there any building materials remaining on site which are potentially hazardous to public health (eg. asbestos, PCB's)?			
	Yes No Unknown			

8.10	Is there any reasouses on the site of	r adjacent sites?	pject land may have been contaminated by former	
	165 <u> </u>	NO 💼 On	known	
8.11	What information of Information was p	did you use to deter provided by client.	mine the answers to 8.1 to 8.10 above?	
8.12	previous use inver	property is industria ntory showing all for ne subject land, is no	I or commercial or if YES to any of 8.2 to 8.10, a mer uses of the subject land, or if appropriate, the eeded.	
	Is the previous use	e inventory attached	d? Yes 🗌 No 🗌	
9.	ACKNOWLEDGEMENT CLAUSE I acknowledge that the City of Hamilton is not responsible for the identification and remediation of contamination on the property which is the subject of this Application — by			
10.	Dimensions of land	ds affected:		
	Frontage	15.04 m		
	Depth	53.55 m		
	Area	828.31 m		
	Width of street	13.12 m		
11.	Particulars of all buground floor area,	uildings and structur	res on or proposed for the subject lands: (Specify umber of stories, width, length, height, etc.)	
11.	Particulars of all buground floor area, Existing:	uildings and structur gross floor area, n	res on or proposed for the subject lands: (Specify umber of stories, width, length, height, etc.)	
11.	Particulars of all buground floor area,	uildings and structur gross floor area, no Dwelling 79.69 m2	res on or proposed for the subject lands: (Specify umber of stories, width, length, height, etc.)  Height:	
11.	Particulars of all buground floor area, Existing: 1.5 Storey Sided I Gross floor area: Width: 9.80 m	uildings and structur gross floor area, no Dwelling 79.69 m2	umber of stories, width, length, height, etc.)	
11.	Particulars of all buground floor area, Existing:	uildings and structur gross floor area, no Dwelling 79.69 m2 Length: 8.08 m	umber of stories, width, length, height, etc.)	
11.	Particulars of all buground floor area, Existing:  1.5 Storey Sided I Gross floor area: Width: 9.80 m  Proposed  1.5 Storey Sided I Gross floor area: 7	uildings and structur gross floor area, no Dwelling 79.69 m2 Length: 8.08 m	umber of stories, width, length, height, etc.)  Height:	
11.	Particulars of all buground floor area, Existing:	uildings and structur gross floor area, no Dwelling 79.69 m2 Length: 8.08 m	umber of stories, width, length, height, etc.)	
	Particulars of all buground floor area, Existing:  1.5 Storey Sided I Gross floor area: Width: 9.80 m  Proposed  1.5 Storey Sided I Gross floor area: Width: 9.80 m  Location of all build	uildings and structur gross floor area, no Dwelling 79.69 m2 Length: 8.08 m Dwelling 79.69 m2 Length: 8.08 m	Height:  Height:  Gon or proposed for the subject lands; (Specify	
12.	Particulars of all buground floor area, Existing:  1.5 Storey Sided I Gross floor area: Width: 9.80 m  Proposed  1.5 Storey Sided I Gross floor area: Width: 9.80 m  Location of all build distance from side, Existing: Front Yard Setback Rear Yard Setback	Dwelling 79.69 m2 Length: 8.08 m  Dwelling 79.69 m2 Length: 8.08 m  Length: 8.08 m	Height:  Height:  Gon or proposed for the subject lands; (Specify	
12.	Particulars of all buground floor area, Existing:  1.5 Storey Sided I Gross floor area: Width: 9.80 m  Proposed  1.5 Storey Sided I Gross floor area: Width: 9.80 m  Location of all build distance from side, Existing: Front Yard Setback Rear Yard Setback	Dwelling 79.69 m2 Length: 8.08 m  Dwelling 79.69 m2 Length: 8.08 m  Length: 8.08 m	Height:  Height:  Gon or proposed for the subject lands; (Specify	
12.	Particulars of all buground floor area, Existing:  1.5 Storey Sided I Gross floor area: Width: 9.80 m  Proposed  1.5 Storey Sided I Gross floor area: Width: 9.80 m  Location of all build distance from side, Existing: Front Yard Setback Rear Yard Setback Side Yard Setback Side Yard Setback Side Yard Setback Side Yard Setback	Juildings and structure gross floor area, not of the property	Height:  Height:  Gon or proposed for the subject lands; (Specify	
12.	Particulars of all buground floor area, Existing:  1.5 Storey Sided I Gross floor area: Width: 9.80 m  Proposed  1.5 Storey Sided I Gross floor area: Width: 9.80 m  Location of all build distance from side, Existing: Front Yard Setback Rear Yard Setback Side Yard Setback Side Yard Setback Side Yard Setback	Dwelling 79.69 m2 Length: 8.08 m  Dwelling 79.69 m2 Length: 8.08 m  Dwelling 79.69 m2 Length: 8.08 m  dings and structures rear and front lot line k: 42.30 m k: 3.14 m k: (North): 1.43 m k: (South): 4.34 m  Addition: k: 3.14 m k: (North): 1.43 m	Height:  Height:  Gon or proposed for the subject lands; (Specify	

13.	Date of acquisition of subject lands:  March 2020				
14.	Date of construction of all buildings and structures on subject lands: The dwelling - originally constructed in 1950. July 2020 the 1/2 storey was built.				
15.	Existing uses of the subject property (single family, duplex, retail, factory etc.): Single family dwelling				
16.	Existing uses of abutting properties (single family, duplex, retail, factory etc.): Single family dwellings on all abutting properties.				
17.	Length of time the existing uses of the subject property have continued: 70+ years				
18.	Municipal services available: (check the appropriate space or spaces)				
	Water X Connected X				
	Sanitary Sewer X Connected X				
	Storm Sewers				
19.	Present Official Plan/Secondary Plan provisions applying to the land:				
	Neighbourhoods				
20.	Present Restricted Area By-law (Zoning By-law) provisions applying to the land:				
	C/S-1435				
	Has the owner previously applied for relief in respect of the subject property? (Zoning Bylaw Amendment or Minor Variance)    Yes  No  If yes, please provide the file number:				
	21.1 If a site-specific zoning by-law amendment has been received for the subject property, has the two-year anniversary of the by-law being passed expired?				
	☐ Yes ☐ No				
	21.2 If the answer is no, the decision of Council, or Director of Planning and Chief Planner that the application for Minor Variance is allowed must be included. Failure to do so may result in an application not being "received" for processing.				
22.	Is the subject property the subject of a current application for consent under Section 53 of the <i>Planning Act</i> ?				
	☐ Yes ■ No				
23.	Additional Information (please include separate sheet if needed)				
	/ delicond mioritation (piedse melade separate sneet in needed)				
24	The applicant shall attach to each carry of this applications a law in the control of the contro				
24.	The applicant shall attach to each copy of this application a plan showing the dimensions of the subject lands and of all abutting lands and showing the location, size and type of all buildings and structures on the subject and abutting lands, and where required by the Committee of Adjustment such plan shall be signed by an Ontario Land Surveyor.				