Hamilton

COMMITTEE OF ADJUSTMENT

City Hall, 5th floor, 71 Main Street West, Hamilton, ON L8P 4Y5
Telephone (905) 546-2424, ext. 4221

E-mail: cofa@hamilton.ca

NOTICE OF PUBLIC HEARING Minor Variance

You are receiving this notice because you are either:

- Assessed owner of a property located within 60 metres of the subject property
- Applicant/agent on file, or
- Person likely to be interested in this application

APPLICATION	A-24:191	SUBJECT	70 Seneca Drive, Ancaster
NO.:		PROPERTY:	
ZONE:	ER - Existing Residential and	ZONING BY-	Zoning By-law Ancaster 87-57
	R2 - Low Density Residential	LAW:	and Hamilton 05-200
	- Large Lot		

APPLICANTS: Owner: Marcie Hall

Applicant: Sabih UI islam

The following variances are requested:

1. To permit a minimum rear yard setback of 4.3 metres whereas the by-law requires a minimum rear yard setback of 7.5 metres.

PURPOSE & EFFECT: So as to facilitate the construction of an accessory building (gazebo) to

complement the existing single detached dwelling.

Notes: N/A

This Notice must be posted by the owner of any land which contains seven or more residential units so that it is visible to all residents.

This application will be heard by the Committee as shown below:

DATE:	Tuesday, September 24, 2024
TIME:	2:05 p.m.
PLACE:	Via video link or call in (see attached sheet for details)
	City Hall Council Chambers (71 Main St. W., Hamilton)
	To be streamed (viewing only) at
	www.hamilton.ca/committeeofadjustment

For more information on this matter, including access to drawings illustrating this request and other information submitted:

A-24:191

- Visit www.hamilton.ca/committeeofadjustment
- Visit Committee of Adjustment staff at 5th floor City Hall, 71 Main St. W., Hamilton

PUBLIC INPUT


Written: If you would like to submit written comments to the Committee of Adjustment you may do so via email or hardcopy. Please see attached page for complete instructions, written comments must be received no later than noon September 20, 2024

Orally: If you would like to speak to this item at the hearing you may do so via video link, calling in, or attending in person. Please see attached page for complete instructions, registration to participate virtually must be received no later than noon September 23, 2024

FURTHER NOTIFICATION

If you wish to be notified of future Public Hearings, if applicable, regarding A-24:191, you must submit a written request to cofa@hamilton.ca or by mailing the Committee of Adjustment, City of Hamilton, 71 Main Street West, 5th Floor, Hamilton, Ontario, L8P 4Y5.

If you wish to be provided a Notice of Decision, you must attend the Public Hearing and file a written request with the Secretary-Treasurer by emailing cofa@hamilton.ca or by mailing the Committee of Adjustment, City of Hamilton, 71 Main Street West, 5th Floor, Hamilton, Ontario, L8P 4Y5.

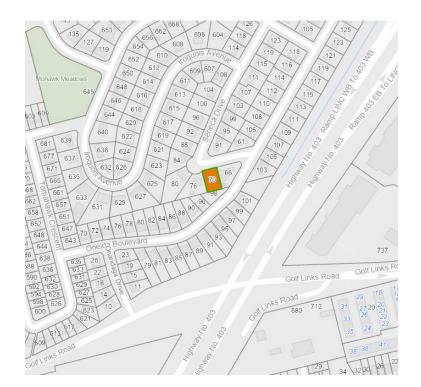

Subject Lands

DATED: September 5, 2024

Jamila Sheffield, Secretary-Treasurer Committee of Adjustment Information respecting this application is being collected under the authority of the Planning Act, R.S.O., 1990, c. P. 13. All comments and opinions submitted to the City of Hamilton on this matter, including the name, address, and contact information of persons submitting comments and/or opinions, will become part of the public record and will be made available to the Applicant and the general public, and may include posting electronic versions.



COMMITTEE OF ADJUSTMENT

City Hall, 5^{th} floor, 71 Main Street West, Hamilton, ON L8P 4Y5 Telephone (905) 546-2424, ext. 4221

E-mail: cofa@hamilton.ca

PARTICIPATION PROCEDURES

Written Submissions

Members of the public who would like to participate in a Committee of Adjustment meeting are able to provide comments in writing advance of the meeting. Comments can be submitted by emailing cofa@hamilton.ca or by mailing the Committee of Adjustment, City of Hamilton, 71 Main Street West, 5th Floor, Hamilton, Ontario, L8P 4Y5. Comments must be received by noon on the date listed on the Notice of Public Hearing.

Comments are available the Friday prior to the Hearing and are available on our website: www.hamilton.ca/committeeofadjustment

Oral Submissions

Members of the public are also able to provide oral comments regarding Committee of Adjustment Hearing items by participating Virtually through Webex via computer or phone or by attending the Hearing In-person. Participation Virtually requires pre-registration in advance. Please contact staff for instructions if you wish to make a presentation containing visual materials.

1. Virtual Oral Submissions

Interested members of the public, agents, and owners **must register by noon on the day listed on the Notice of Public Hearing to** participate Virtually.

To register to participate Virtually by Webex either via computer or phone, please contact Committee of Adjustment staff by email cofa@hamilton.ca. The following information is required to register: Committee of Adjustment file number, hearing date, name and mailing address of each person wishing to speak, if participation will be by phone or video, and if applicable the phone number they will be using to call in.

A separate registration for each person wishing to speak is required. Upon registering for a meeting, members of the public will be emailed a link for the Webex meeting one business day before the Hearing. Only those registered will be called upon to speak.

2. In person Oral Submissions

Interested members of the public, agents, and owners who wish to participate in person may attend Council Chambers on the date and time listed on the Notice of Public Hearing. Please note, you will be required to provide your name and address for the record. It is advised that you arrive **no less than 10 minutes** before the time of the Public Hearing as noted on the Notice of Public Hearing.

We hope this is of assistance and if you need clarification or have any questions, please email cofa@hamilton.ca.

Please note: Webex (video) participation requires either a compatible computer or smartphone and an application (app/program) must be downloaded by the interested party in order to participate. It is the interested party's responsibility to ensure that their device is compatible and operating correctly prior to the Hearing.

70 SENECA DR, ANCASTER, ON L9G 3B8

SCOPE OF WORK:

ADDITION OF A NEW GAZEBO IN THE BACKYARD OF THE HOME

ONTARIO BUILDING CODE 2012 AND NATIONAL BUILDING CODE (2015).

1.WOOD CONSTRUCTION NOTES

- ALL WOOD FRAMING INCLUDING BRIDGING, NAILING AND OTHER DETAILS SHALL BE IN ACCORDANCE WITH THE STRUCTURAL DRAWINGS, CSA-O86.1 AND THE CURRENT BRITISH COLUMBIA BUILDING CODE.
- 2. ALL WOOD FRAMING TO BE SPF#2 OR BETTER BEARING THE GRADE STAMP OF AN AGENCY CERTIFIED BY THE CANADIAN LUMBER STANDARDS ACCREDITATION BOARD UNLESS NOTED OTHERWISE.
- 3. PLYWOOD FOR ROOFS, FLOORS AND WALLS SHALL BE EXTERIOR GRADE DOUGLAS FIR PLYWOOD TO CSA-O121 OR CANADIAN SOFTWOOD PLYWOOD TO CSA-O151 U.N.O.
- 4. THE USE OF FINGER JOINTED WOOD MEMBERS FOR STRUCTURAL MEMBERS SHALL BE RESTRICTED TO THOSE LOADED IN AXIAL COMPRESSION ONLY. USE OF FINGER JOINTED WOOD MEMBERS FORNEXTERIOR STUDS AND NON-COMPRESSION MEMBERS IS NOT ACCEPTABLE.
- FINGER JOINTED STUDS SHALL NOT BE USED FOR SHEAR WALL HOLD-DOWN BUILT-UP POSTS.

 EXTERIOR WALLS IN EXCESS OF 3600mm (12'-0") SHALL HAVE BLOCKING AT 2400mm (8'-0") O/C MAX.
- WALL STUDS SHALL NOT BE NOTCHED, DRILLED OR OTHERWISE DAMAGED SO THAT THE UNDAMAGED PORTION OF THE STUD IS LESS THAN TWO THIRDS (23) OF THE DEPTHS OF THE STUD IF THE STUD IS LOAD BEARING OR 40mm (112") IF THE STUD IS NON-LOAD BEARING UNLESS THE STUDS ARE SUITABLY REINFORCED. SUCH REINFORCEMENT SHALL BE APPROVED BY THE STRUCTURAL ENGINEER.
- 7. TOP AND BOTTOM PLATES IN WALLS SHALL NOT BE NOTCHED, DRILLED OR OTHERWISE DAMAGED SO THAT THE UNDAMAGED WIDTH IS LESS THEN 50mm (2") UNLESS THE PLATES ARE SUITABLY REINFORCED. SUCH REINFORCEMENT SHALL BE APPROVED BY THE STRUCTURAL ENGINEER.
- 8. ALL POSTS AND BUILT-UP STUDS ARE TO BE CARRIED DOWN TO FOUNDATION INCLUDING SOLID BLOCKING AT EACH FLOOR/DECK LEVEL.

COMMON NAIL SIZE: MIN SHANK DIAMETER 64mm (2 12") 75mm (3") 3.25mm (0.128")

2.TIMBER FRAMING

ALL FRAMING, BRIDGING, NAILING, PROTECTION, HARDWARE AND OTHER FRAMING DETAILS ARE TO BE IN ACCORDANCE WITH PART 9 OF THE CANADIAN BUILDING CODE, LATEST EDITION, UNLESS NOTED

EXTERIOR WALL SHEATHING TO BE 12 mm (1/2") EXTERIOR GRADE FIR PLYWOOD NAILED AT 150 mm (6") c/c ALONG EDGES AND 300 mm (12") c/c ON INTERMEDIATE FRAMING MEMBERS. SHEATHING PROVIDES LATERAL SUPPORT FOR FRAMING AND MUST BE NAILED TO EACH STUD.

FLOOR SHEATHING TO BE 16 mm (5/8") T & G FIR PLYWOOD SUB FLOOR GLUED AND NAILED SECURELY TO ALL JOISTS.

UNLESS SPECIFICALLY NOTED OTHERWISE ON THE DRAWINGS, THE CONTRACTOR SHALL PROVIDE STANDARD SIMPSON STRONGTIE HARDWARE OR APPROVED EQUIVALENT FOR ALL JOIST HANGERS,

BEAM HANGERS, BEAM SEATS, POST ANCHORS, ETC.

MEMBERS SHALL BE ALIGNED LEVEL AND PLUMB, WITHIN A TOLERANCE OF 1 IN 500.

MAKE ADEQUATE PROVISIONS FOR ERECTION STRESSES AND FOR SUFFICIENT TEMPORARY BRACING TO KEEP THE STRUCTURAL FRAME PLUMB AND IN TRUE ALIGNMENT UNTIL THE COMPLETION OF THE ENTIRE FRAMING INCLUDING INSTALLATION OF THE FLOOR AND WALL SHEATHING.
FRAME AROUND ALL OPENINGS WITH DOUBLE HEADERS AND TRIMMERS NAILED TOGETHER WITH TWO

ROWS OF 89 mm (3½") SPIRAL NAILS AT 200 mm c/c (8" c/c) STAGGERED UNLESS NOTED OTHERWISE. DO NOT SPLICE MEMBERS BETWEEN SUPPORTS.
ALL BEAMS SUPPORTED ON TIMBER WALLS ARE TO BEAR ON BUILT UP POSTS OR BE CONNECTED TO


OTHER BEAMS WITH METAL BEAM HANGERS. PRESSURE NAILING PLATES WILL NOT BE ACCEPTED. ALL BUILT UP POSTS ARE TO BE CONSTRUCTED CONTINUOUSLY TO THE FOUNDATION WITH TRANSFER BLOCKING AT EACH FLOOR FRAMING. POSTS ARE TO CONTINUE TO FOUNDATIONS EVEN IF SUPPORTED ON LOADBEARING STUD WALLS, UNLESS NOTED OTHERWISE ON THE DRAWINGS.


BUILT UP POSTS OF 2 OR 3 PLY SHALL BE NAILED TOGETHER AT 150 mm (6") c/c STAGGERED UNLESS

NOTED OTHERWISE.
PROVIDE DOUBLE FLOOR JOISTS AT ALL NON-LOADBEARING AND LOADBEARING PARTITION WALLS SPANNING PARALLEL TO.

3.FOUNDATIONS

- 1. FOUND ALL FOOTINGS ON SOIL CAPABLE OF SUSTAINING AN UNFACTORED BEARING STRESS OF 100 kN/m².
- 2. DO NOT EXCEED A RISE OF 7 IN A RUN OF 10 IN THE LINE OF SLOPE BETWEEN ADJACENT FOOTING EXCAVATIONS OR ALONG STEPPED FOOTINGS. FOR STEPPED FOOTINGS, USE STEPS NOT EXCEEDING 600 mm (2'-0") IN HEIGHT AND 1200 mm (4'-0") (MIN.) IN LENGTH.
- 3. PROVIDE A VAPOUR RETÀRDÉR MEMBRANE COVER OVÈR THÈ PRÉPARED BASE MATERIAL BELOW SLABS-ON-GRADE, WHERE NOTED ON THE DRAWINGS. LAP JOINTS OF MEMBRANE 150 mm (6") AND TAPE WITH MATERIAL AS RECOMMENDED BY MEMBRANE MANUFACTURER.

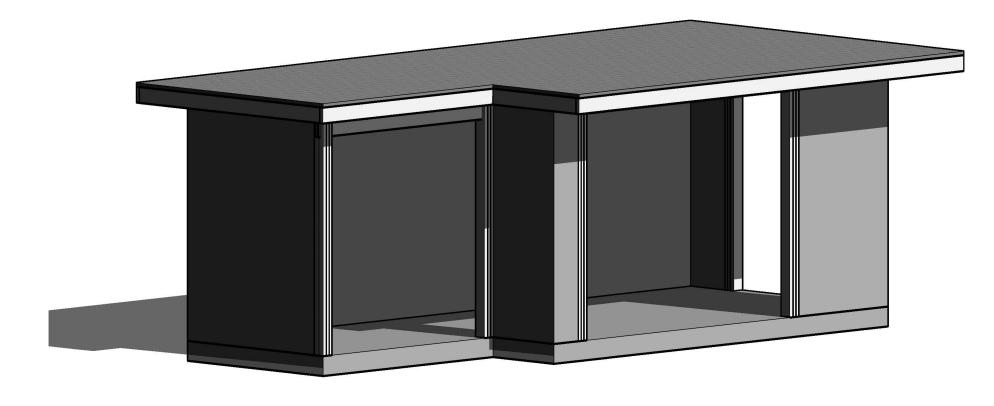

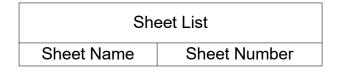

Cover Sheet	A101
Site Plan	A102
Foundation Plan	A103
WALL PLAN	A104
Gazebo Framing Plan	A105
Side Elevations	A106
Front Elevation	A107
Sections	A108
Framing Connection Details - 1	A109
Framing Connection Details - 2	A110
FOUNDATION DETAIL	A111
FRAMING DETAIL	A112



"CONTRACTOR SHALL VERIFY ALL
CONDITIONS AND DIMENSIONS AT THE
JOB SITE AND NOTIFY THE ENGINEER OF
ANY DIMENSIONAL ERRORS, OMISSIONS
OR DISCREPANCIES BEFORE BEGINNING
OR FABRICATING ANY WORK."

ENGINEER AND DESIGNER ARE NOT RESPONSIBLE FOR ANY DAMAGES OCCURED DURING CONSTRUCTION


70 Seneca Dr, Ancaster, ON L9G 3B8


GAZEBO PERMIT DRAWINGS Cover Sheet

Project number	Project Number
Date	Issue Date
Drawn by	Author
Checked by	Checker

A101

Scale

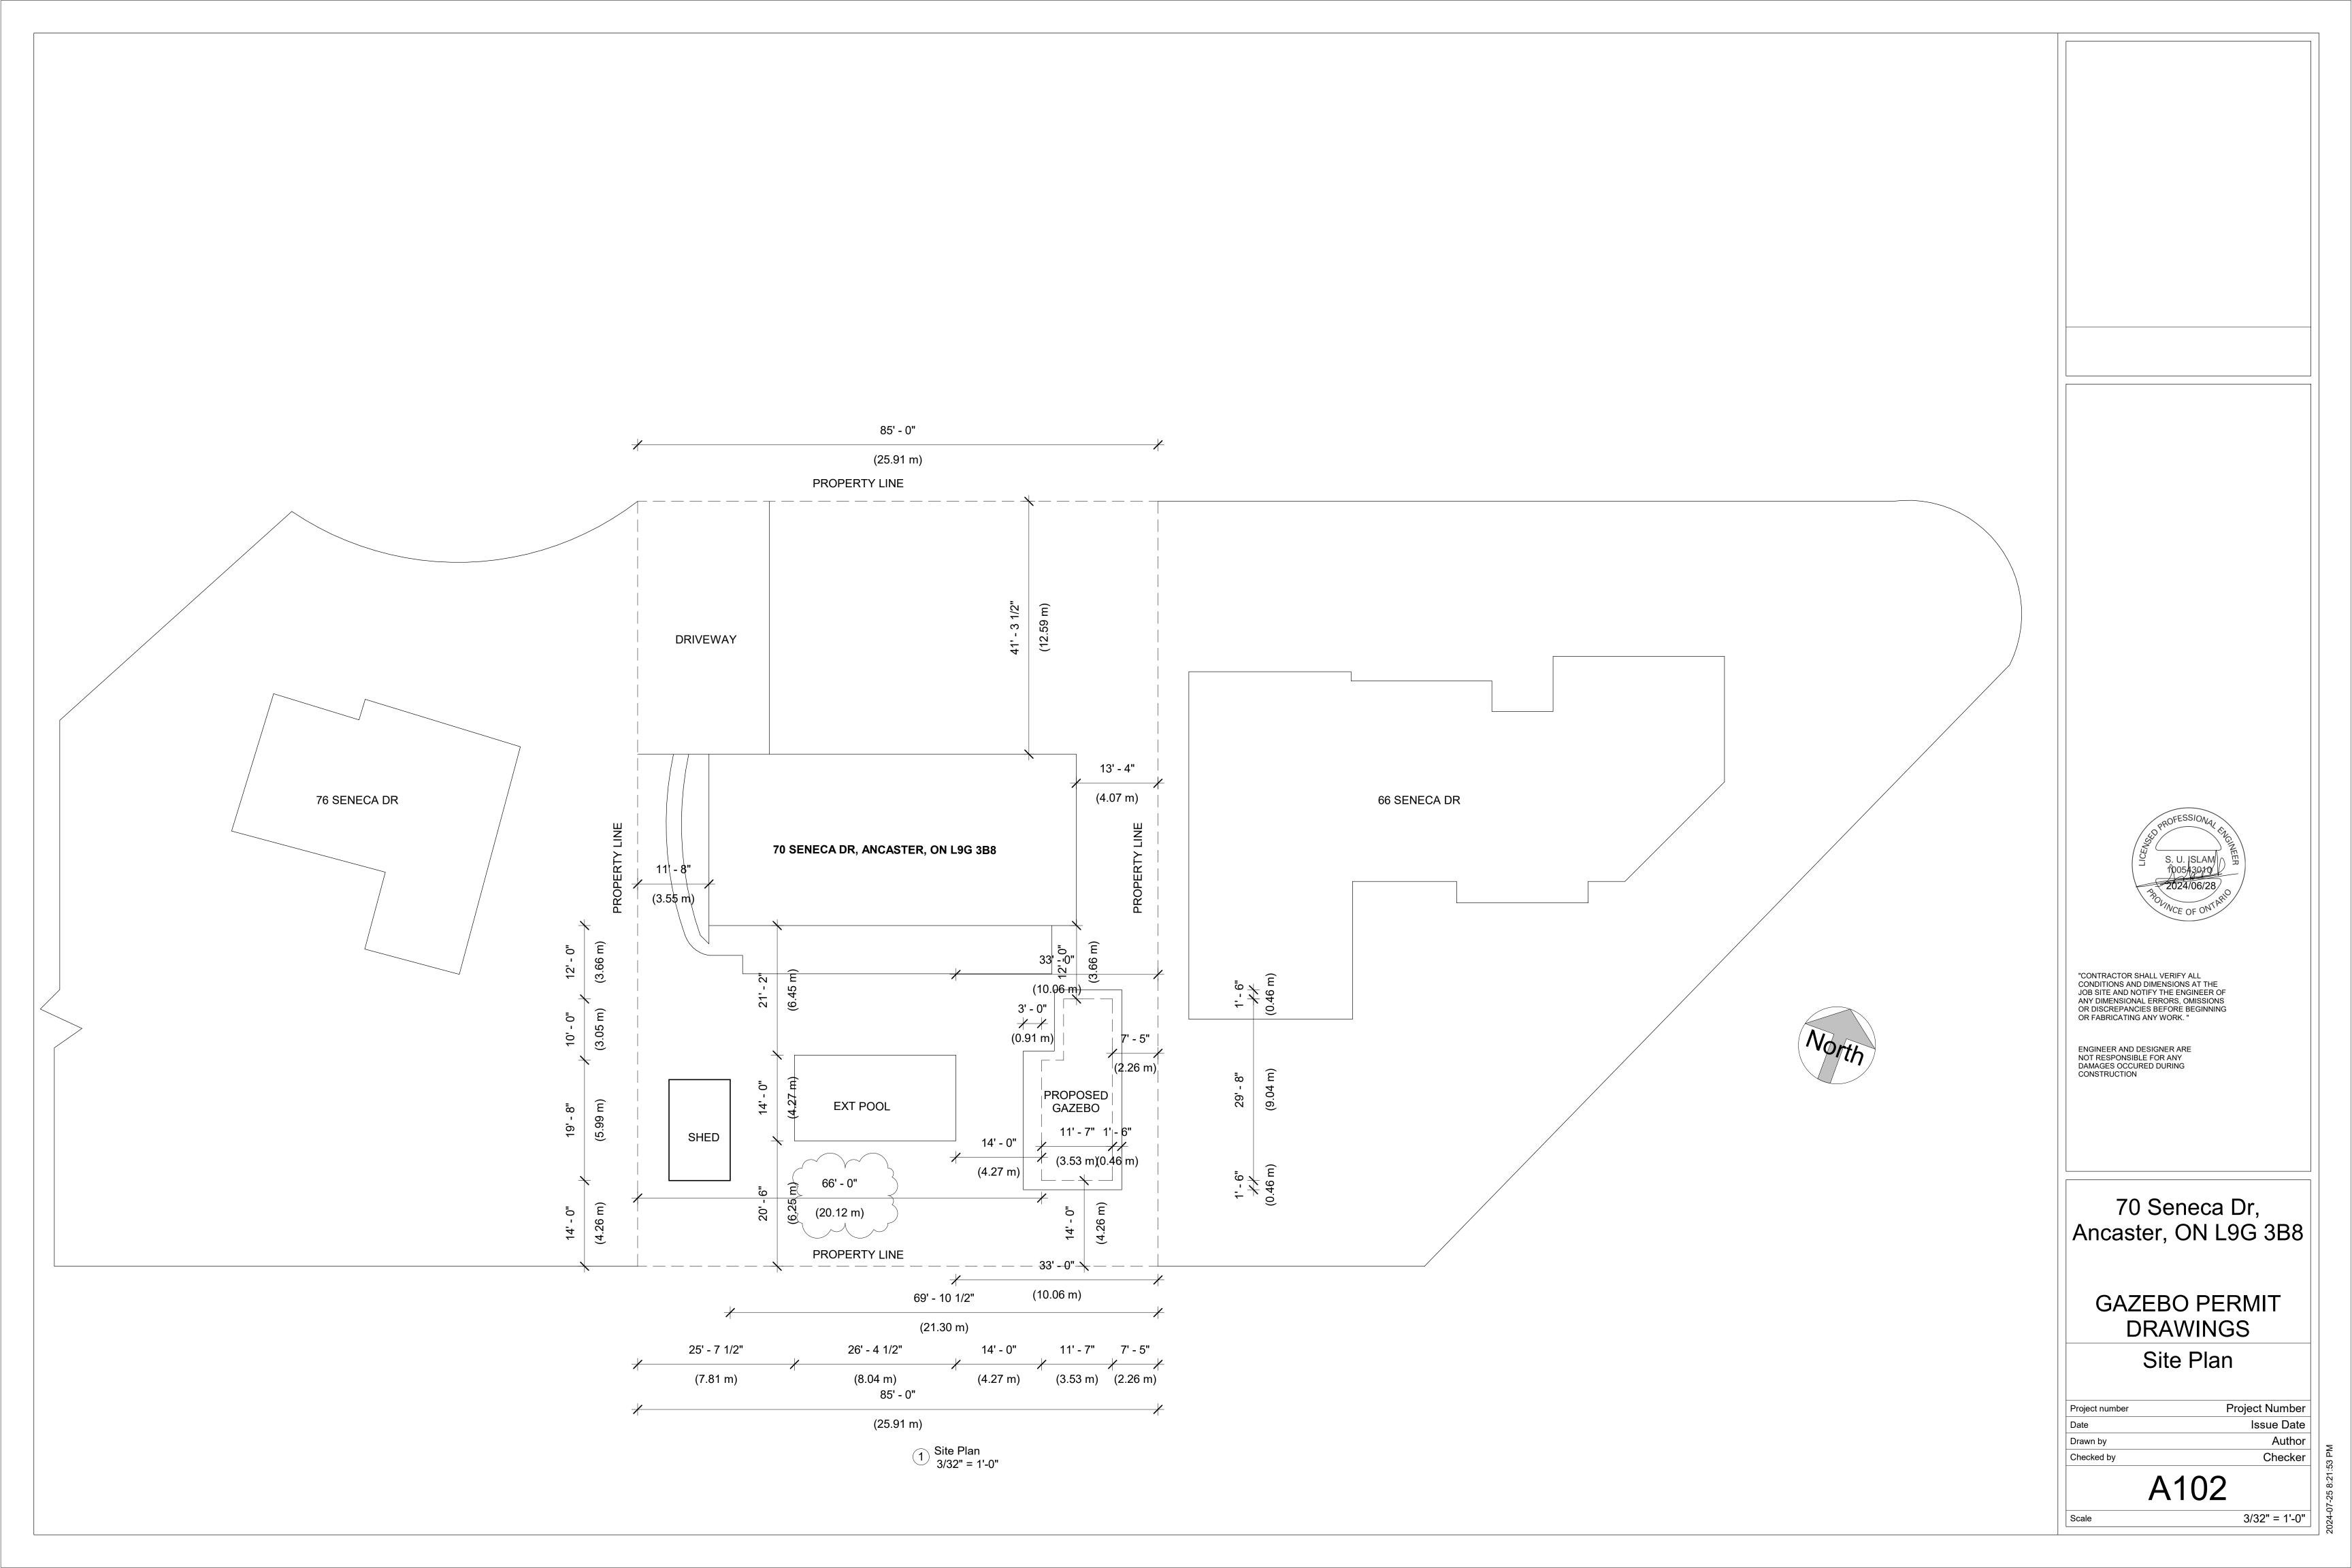

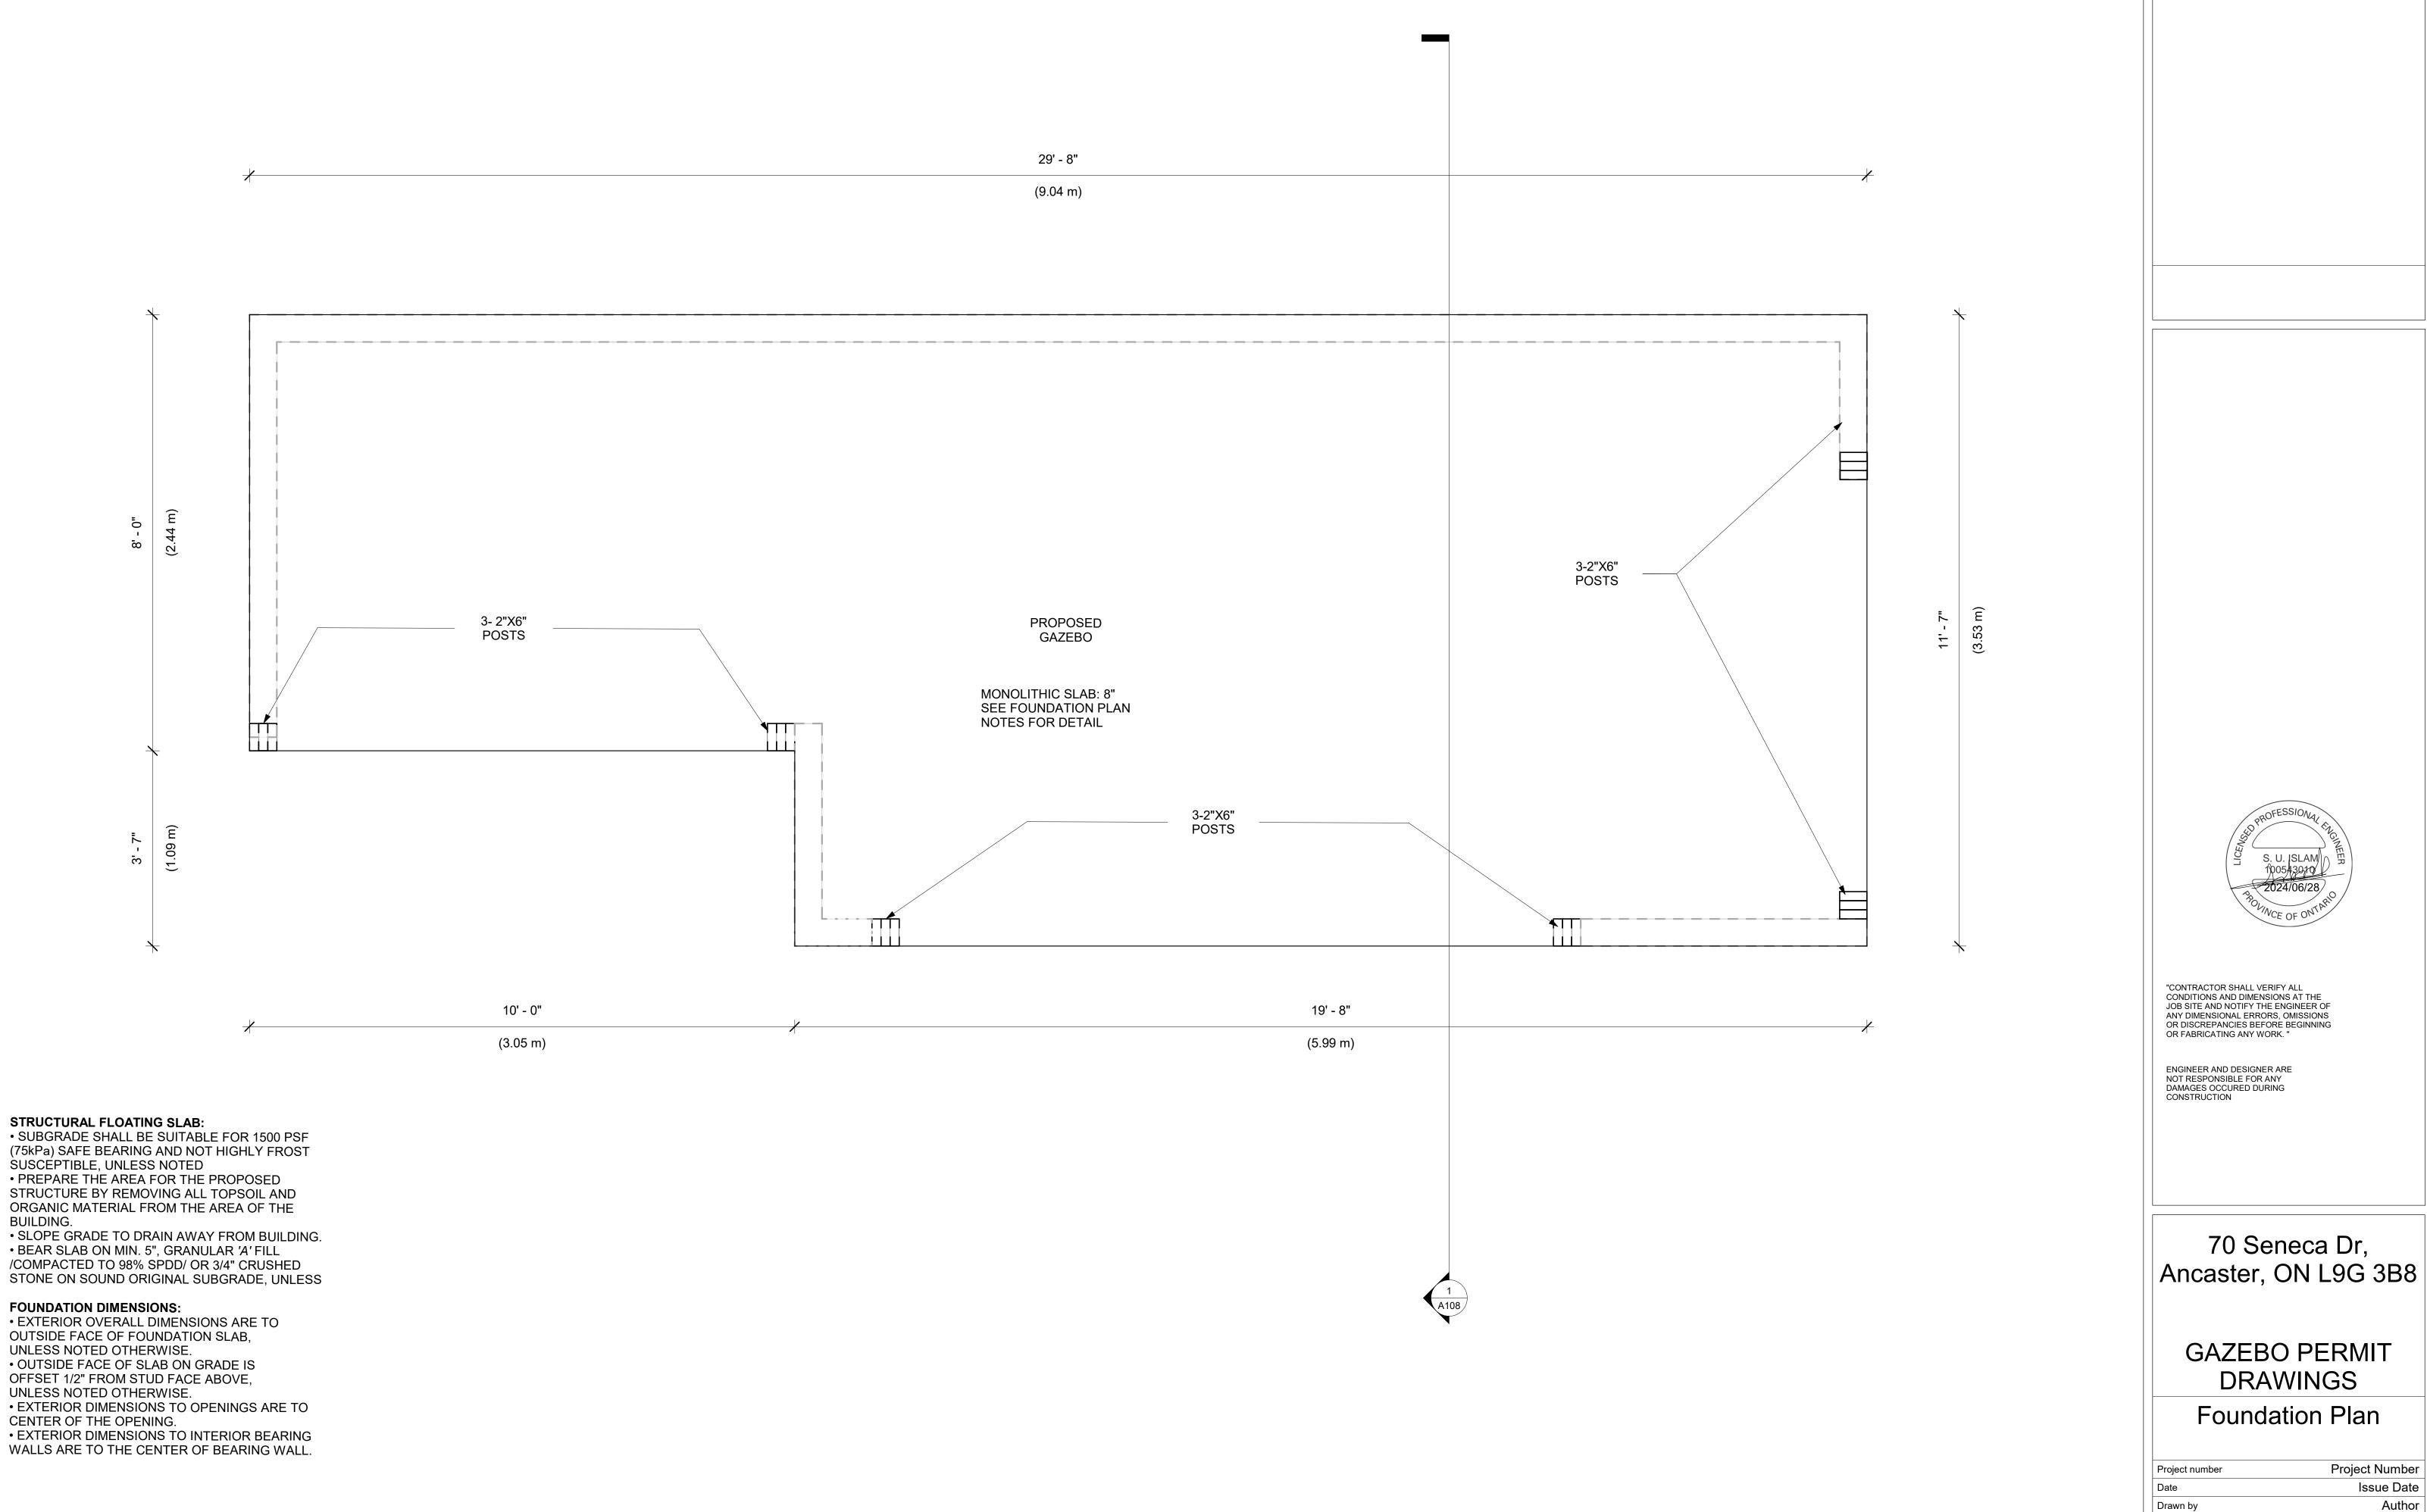



Foundation Plan 3/4" = 1'-0"


Checked by


Scale

A103

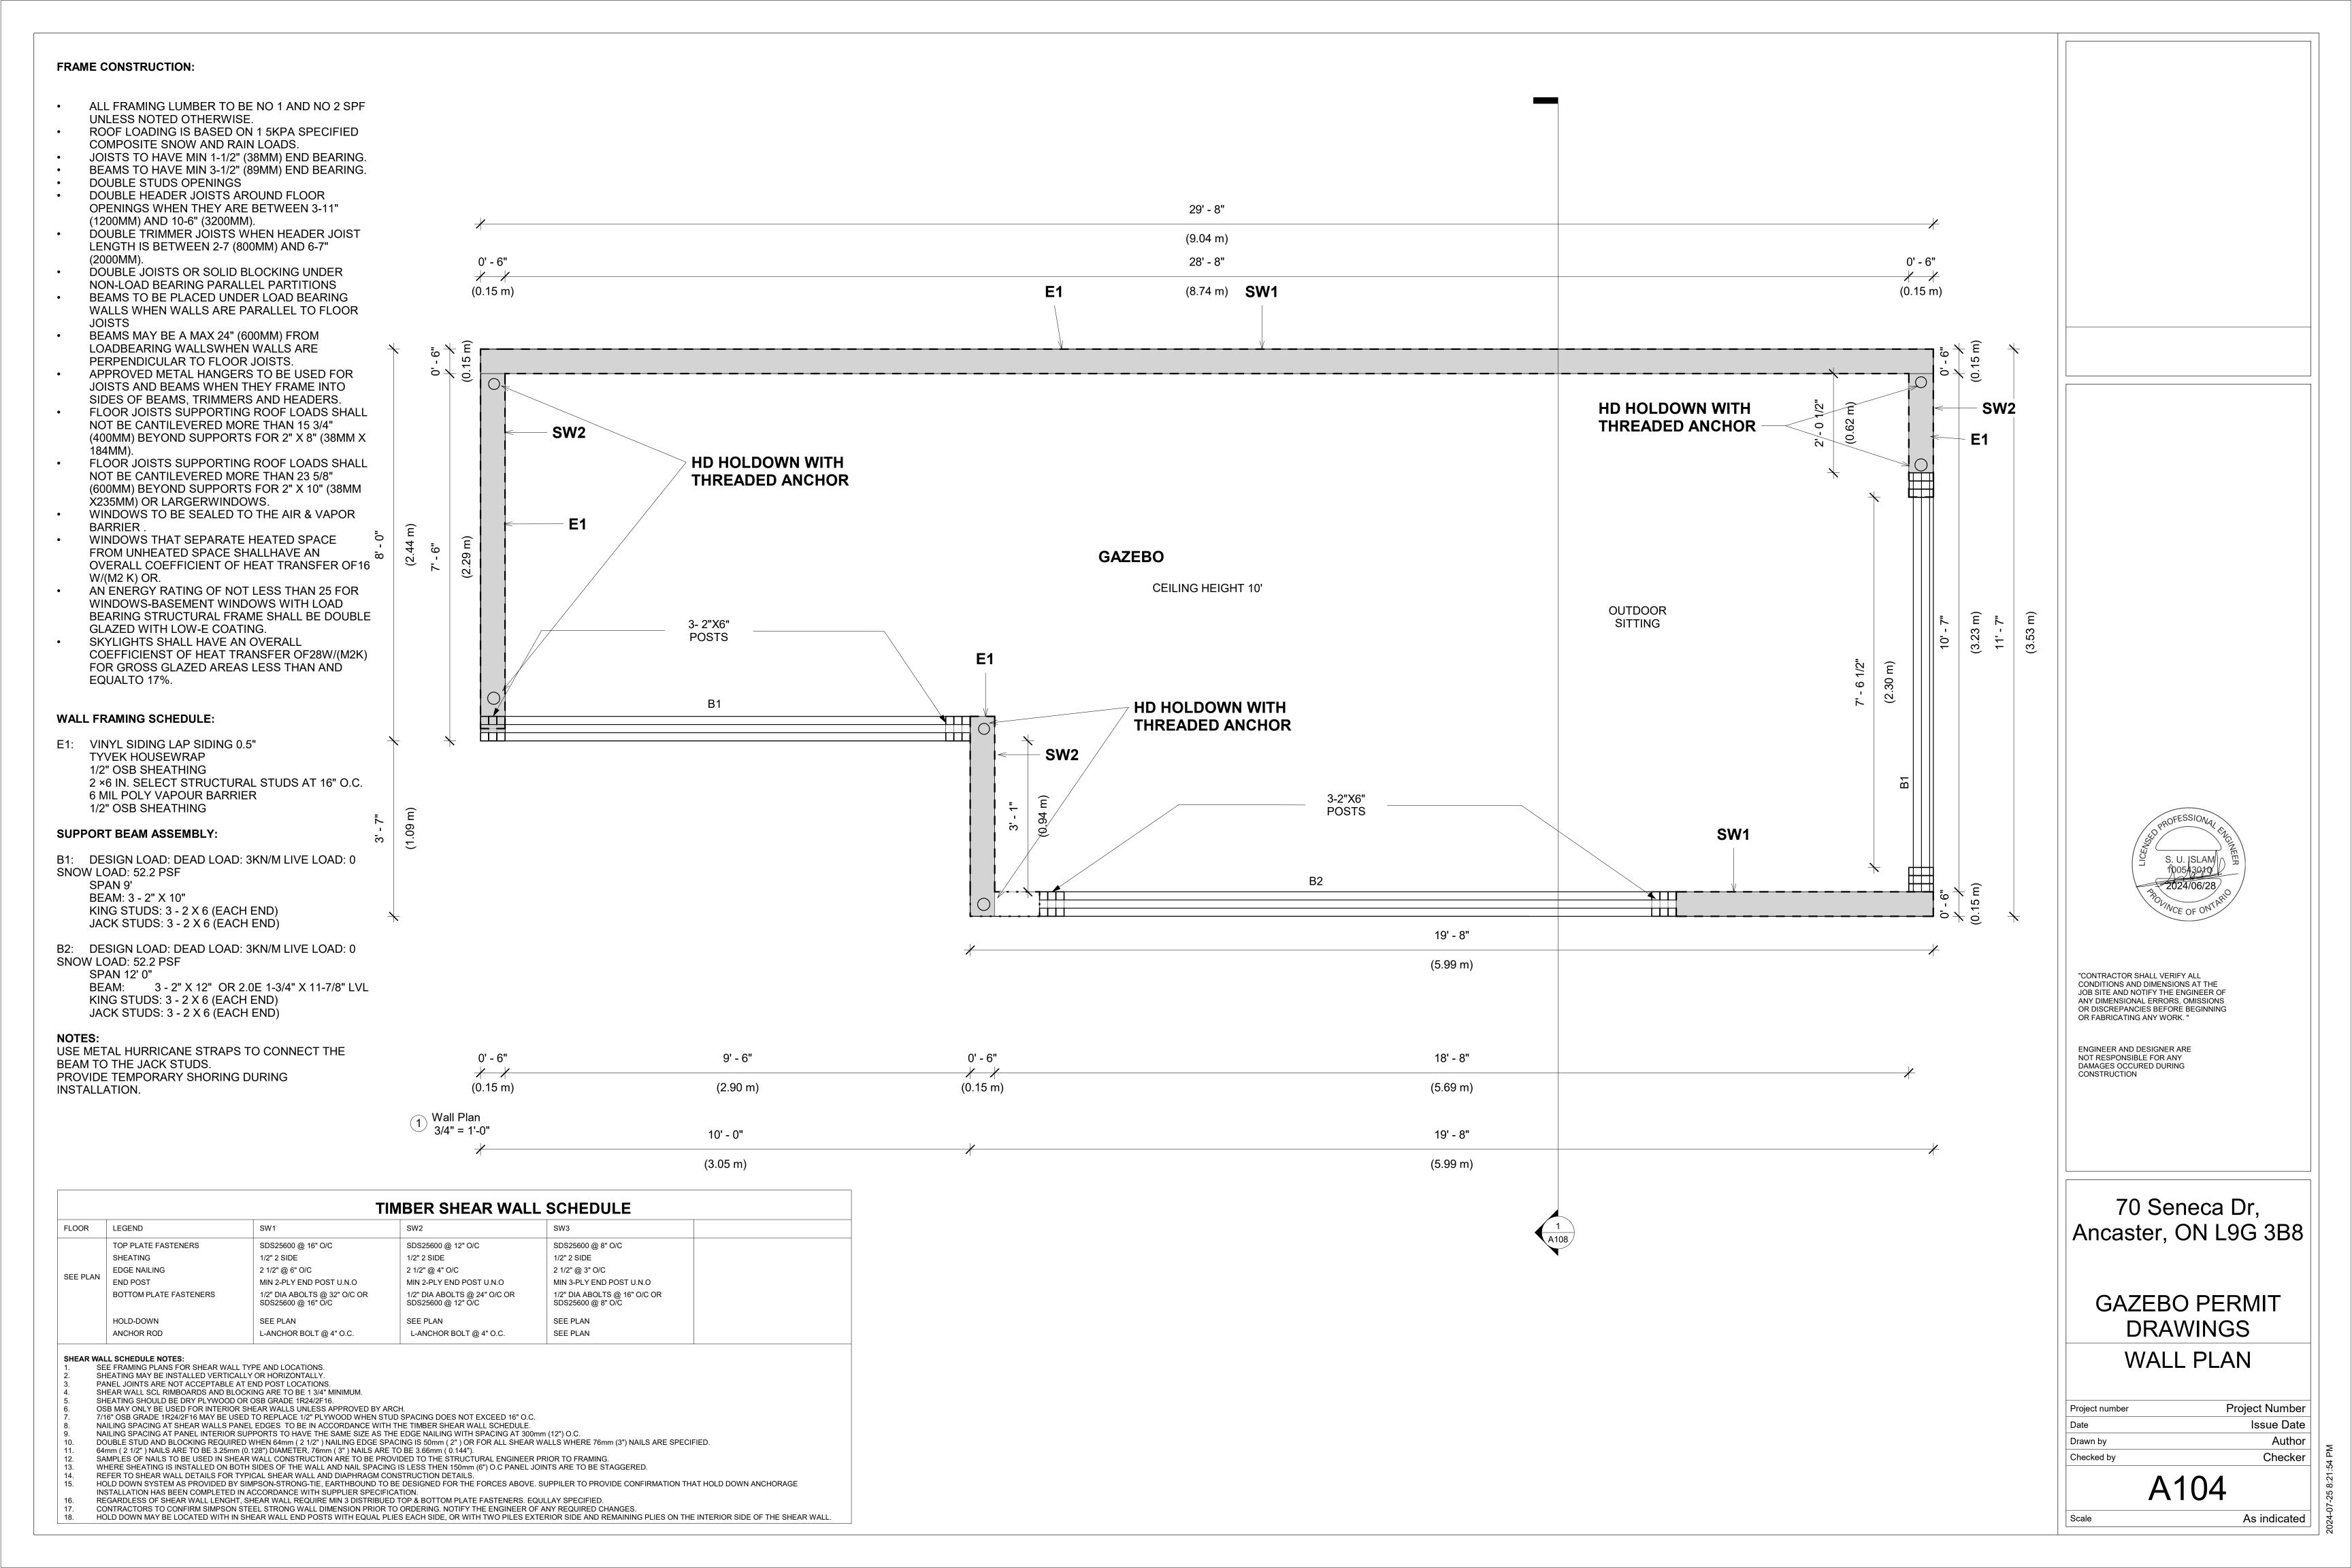

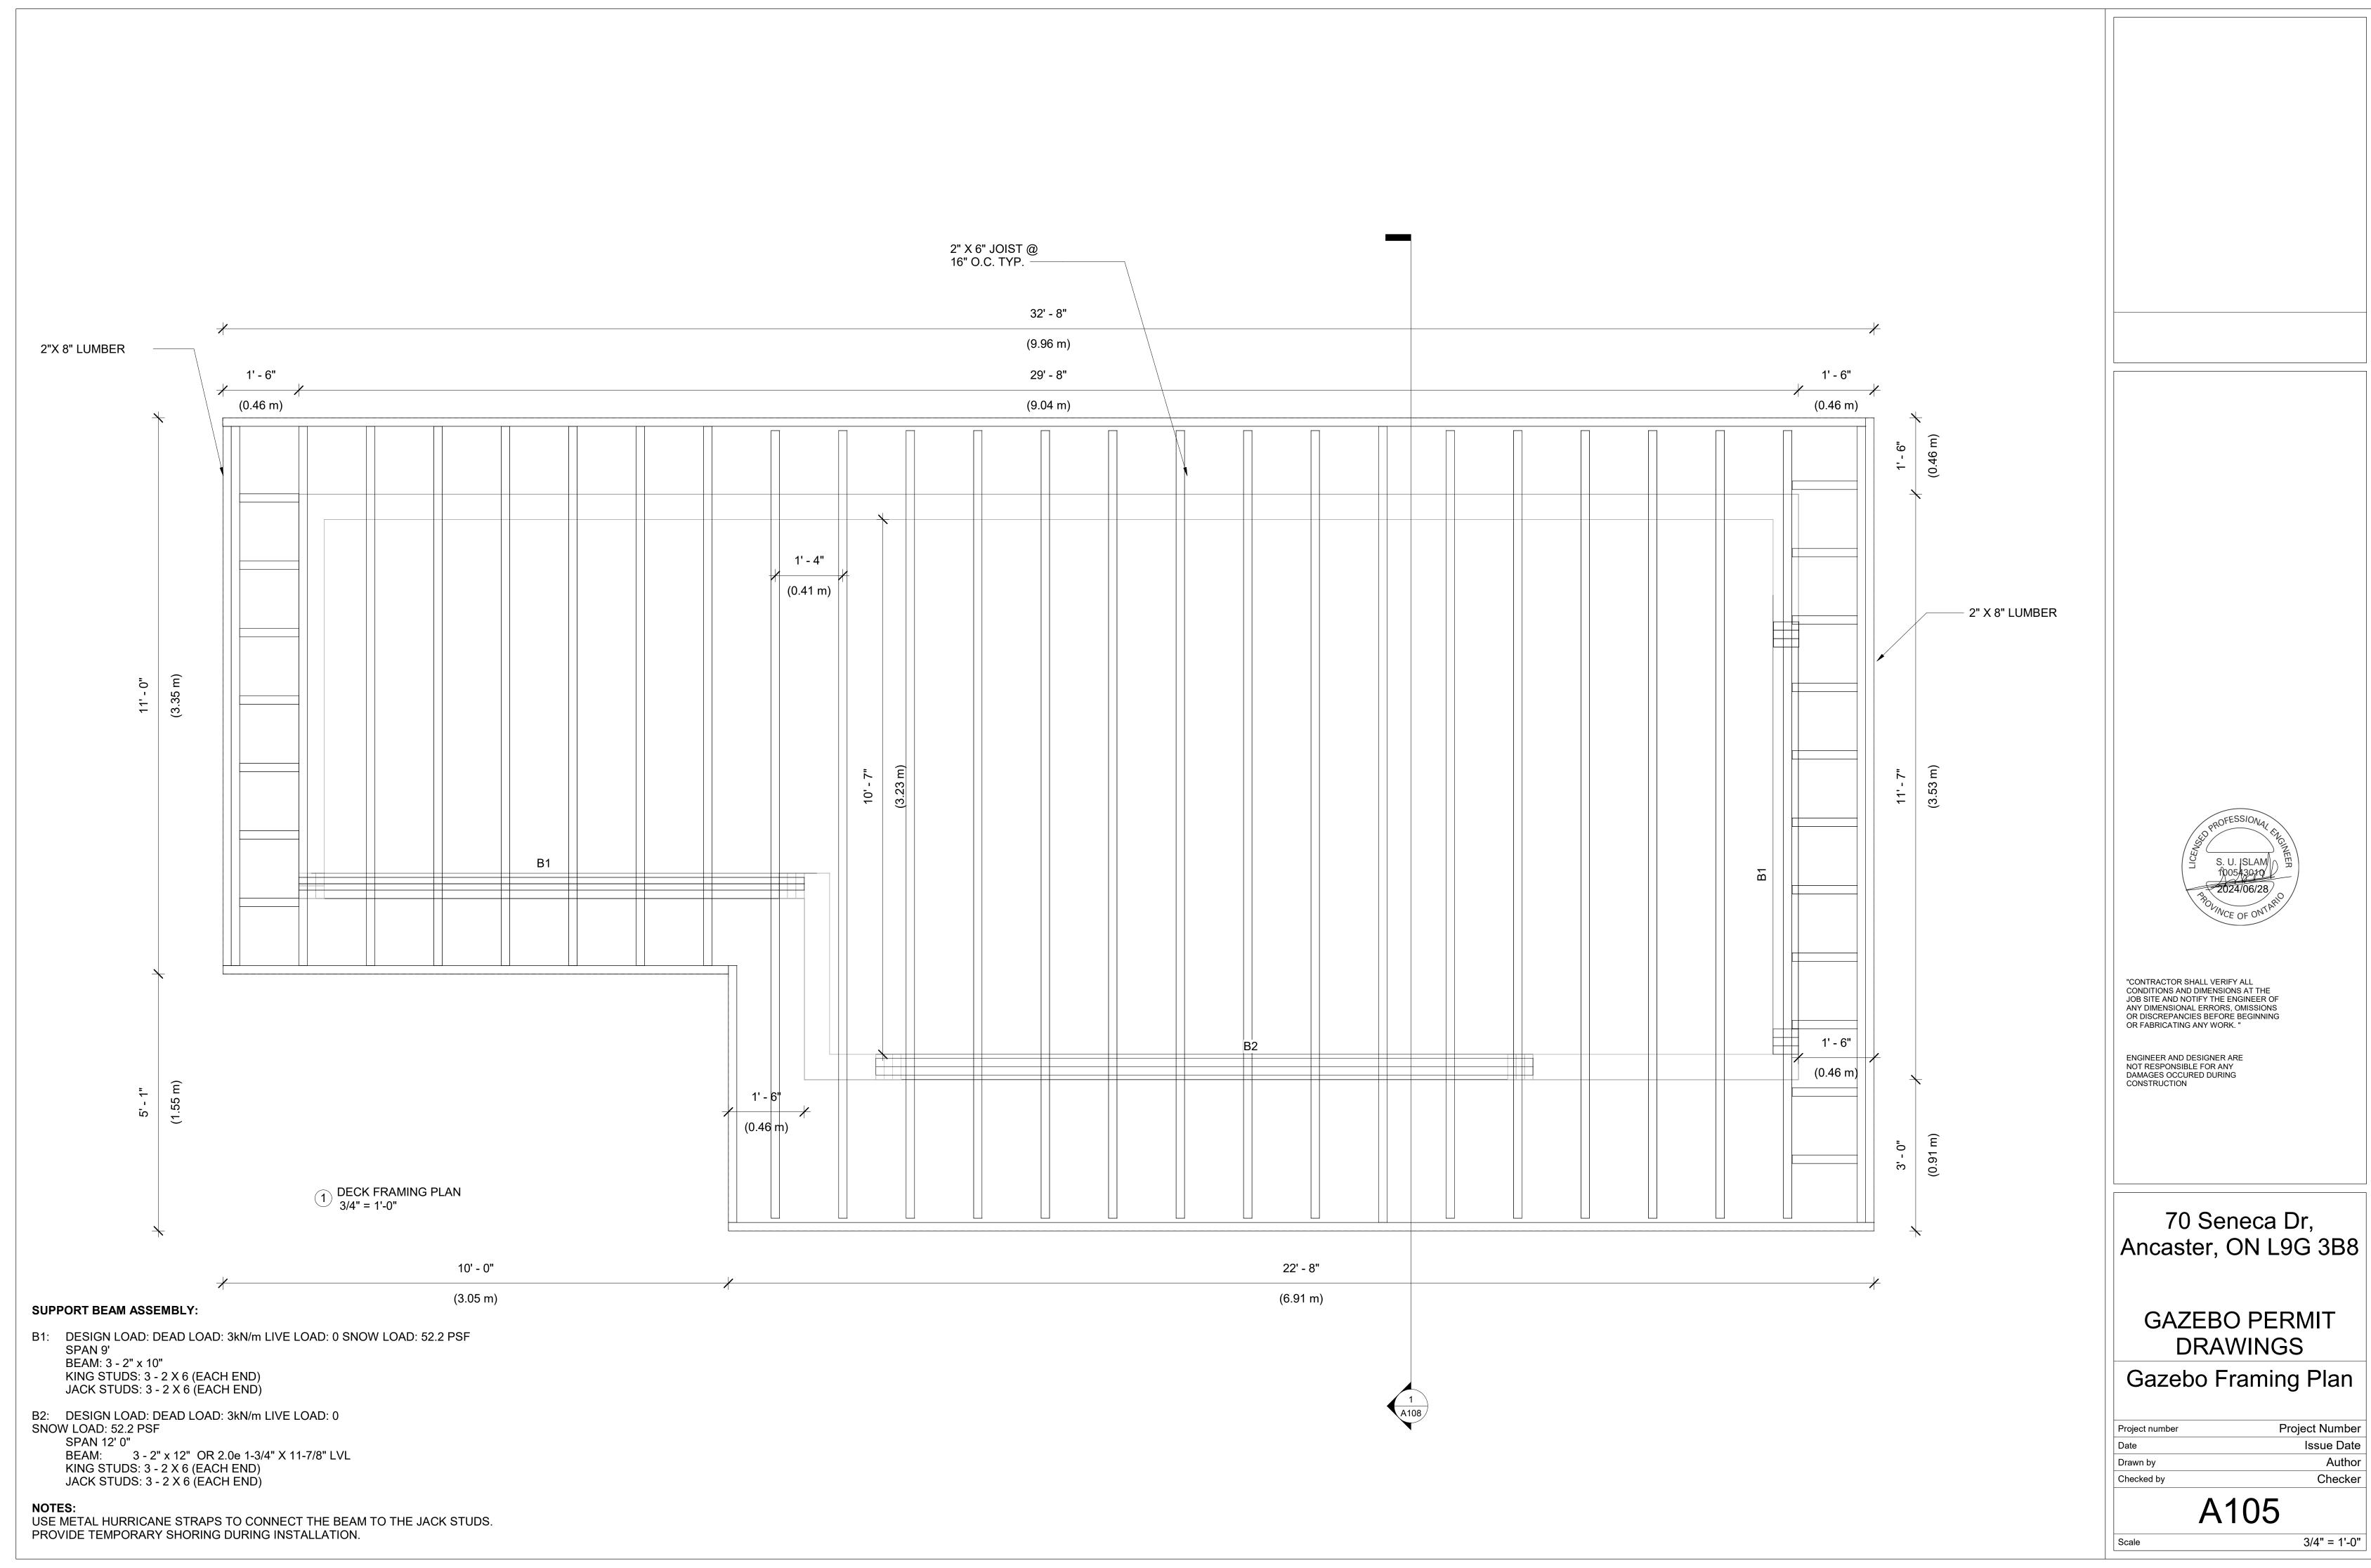

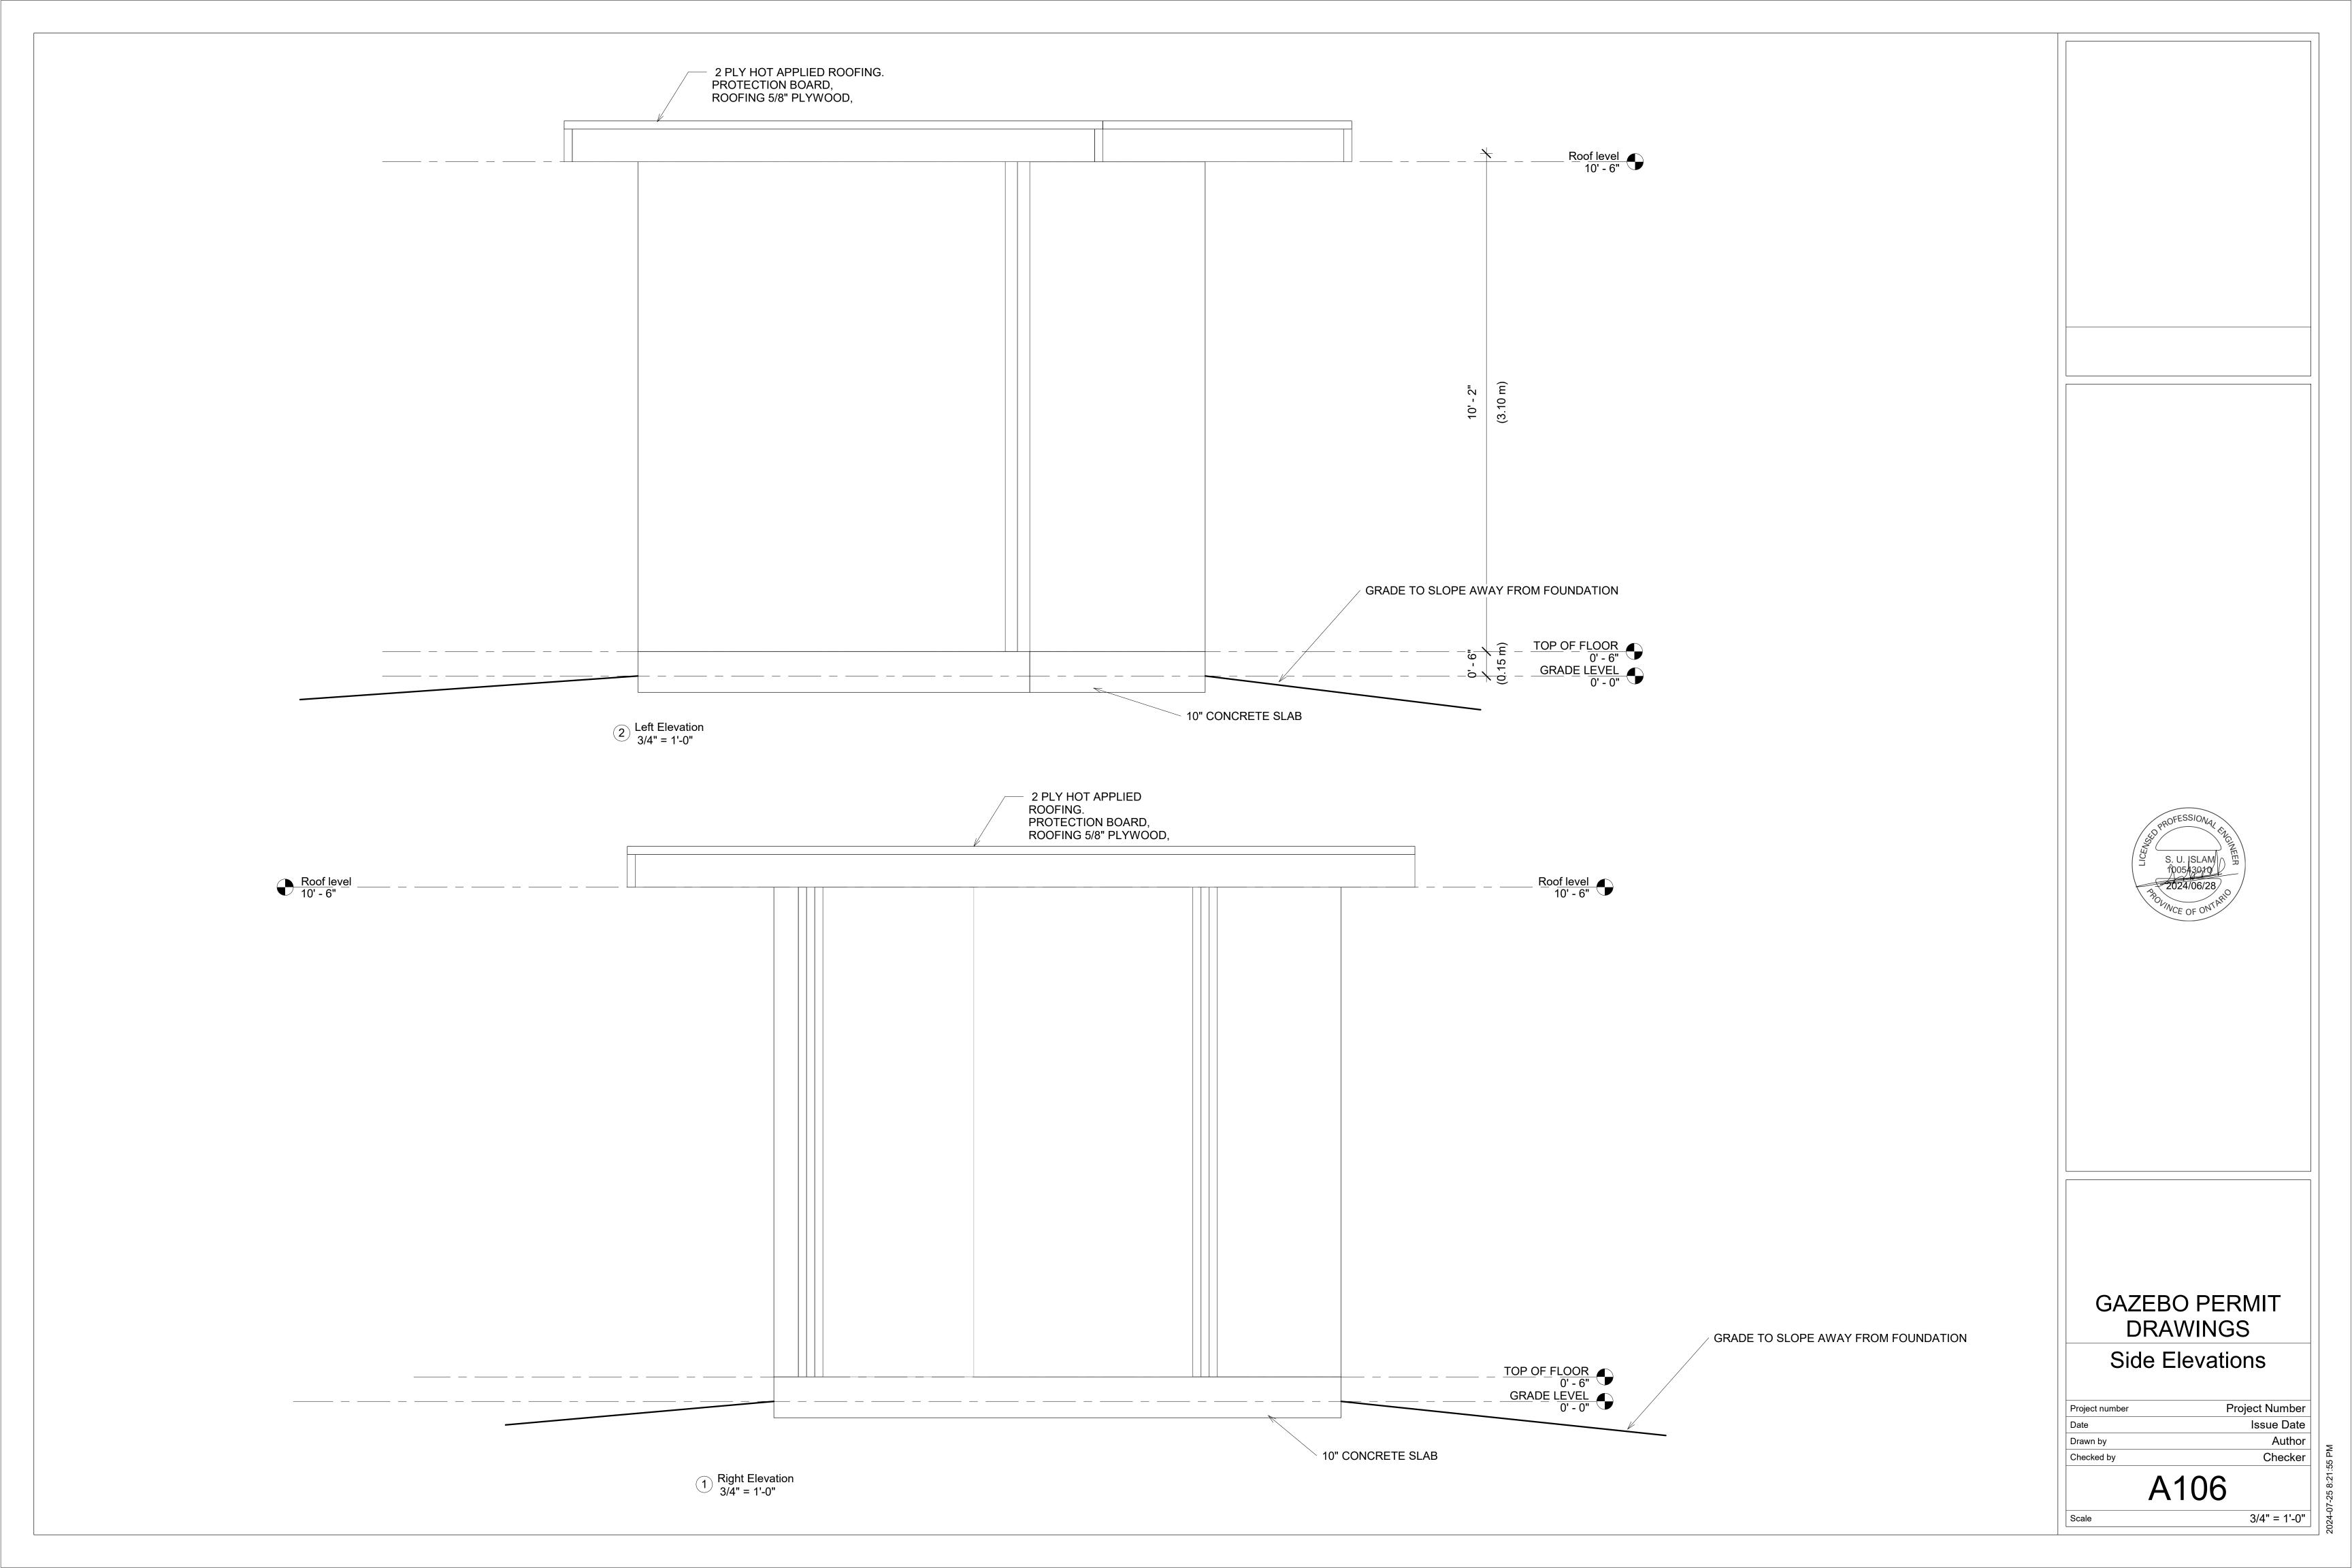

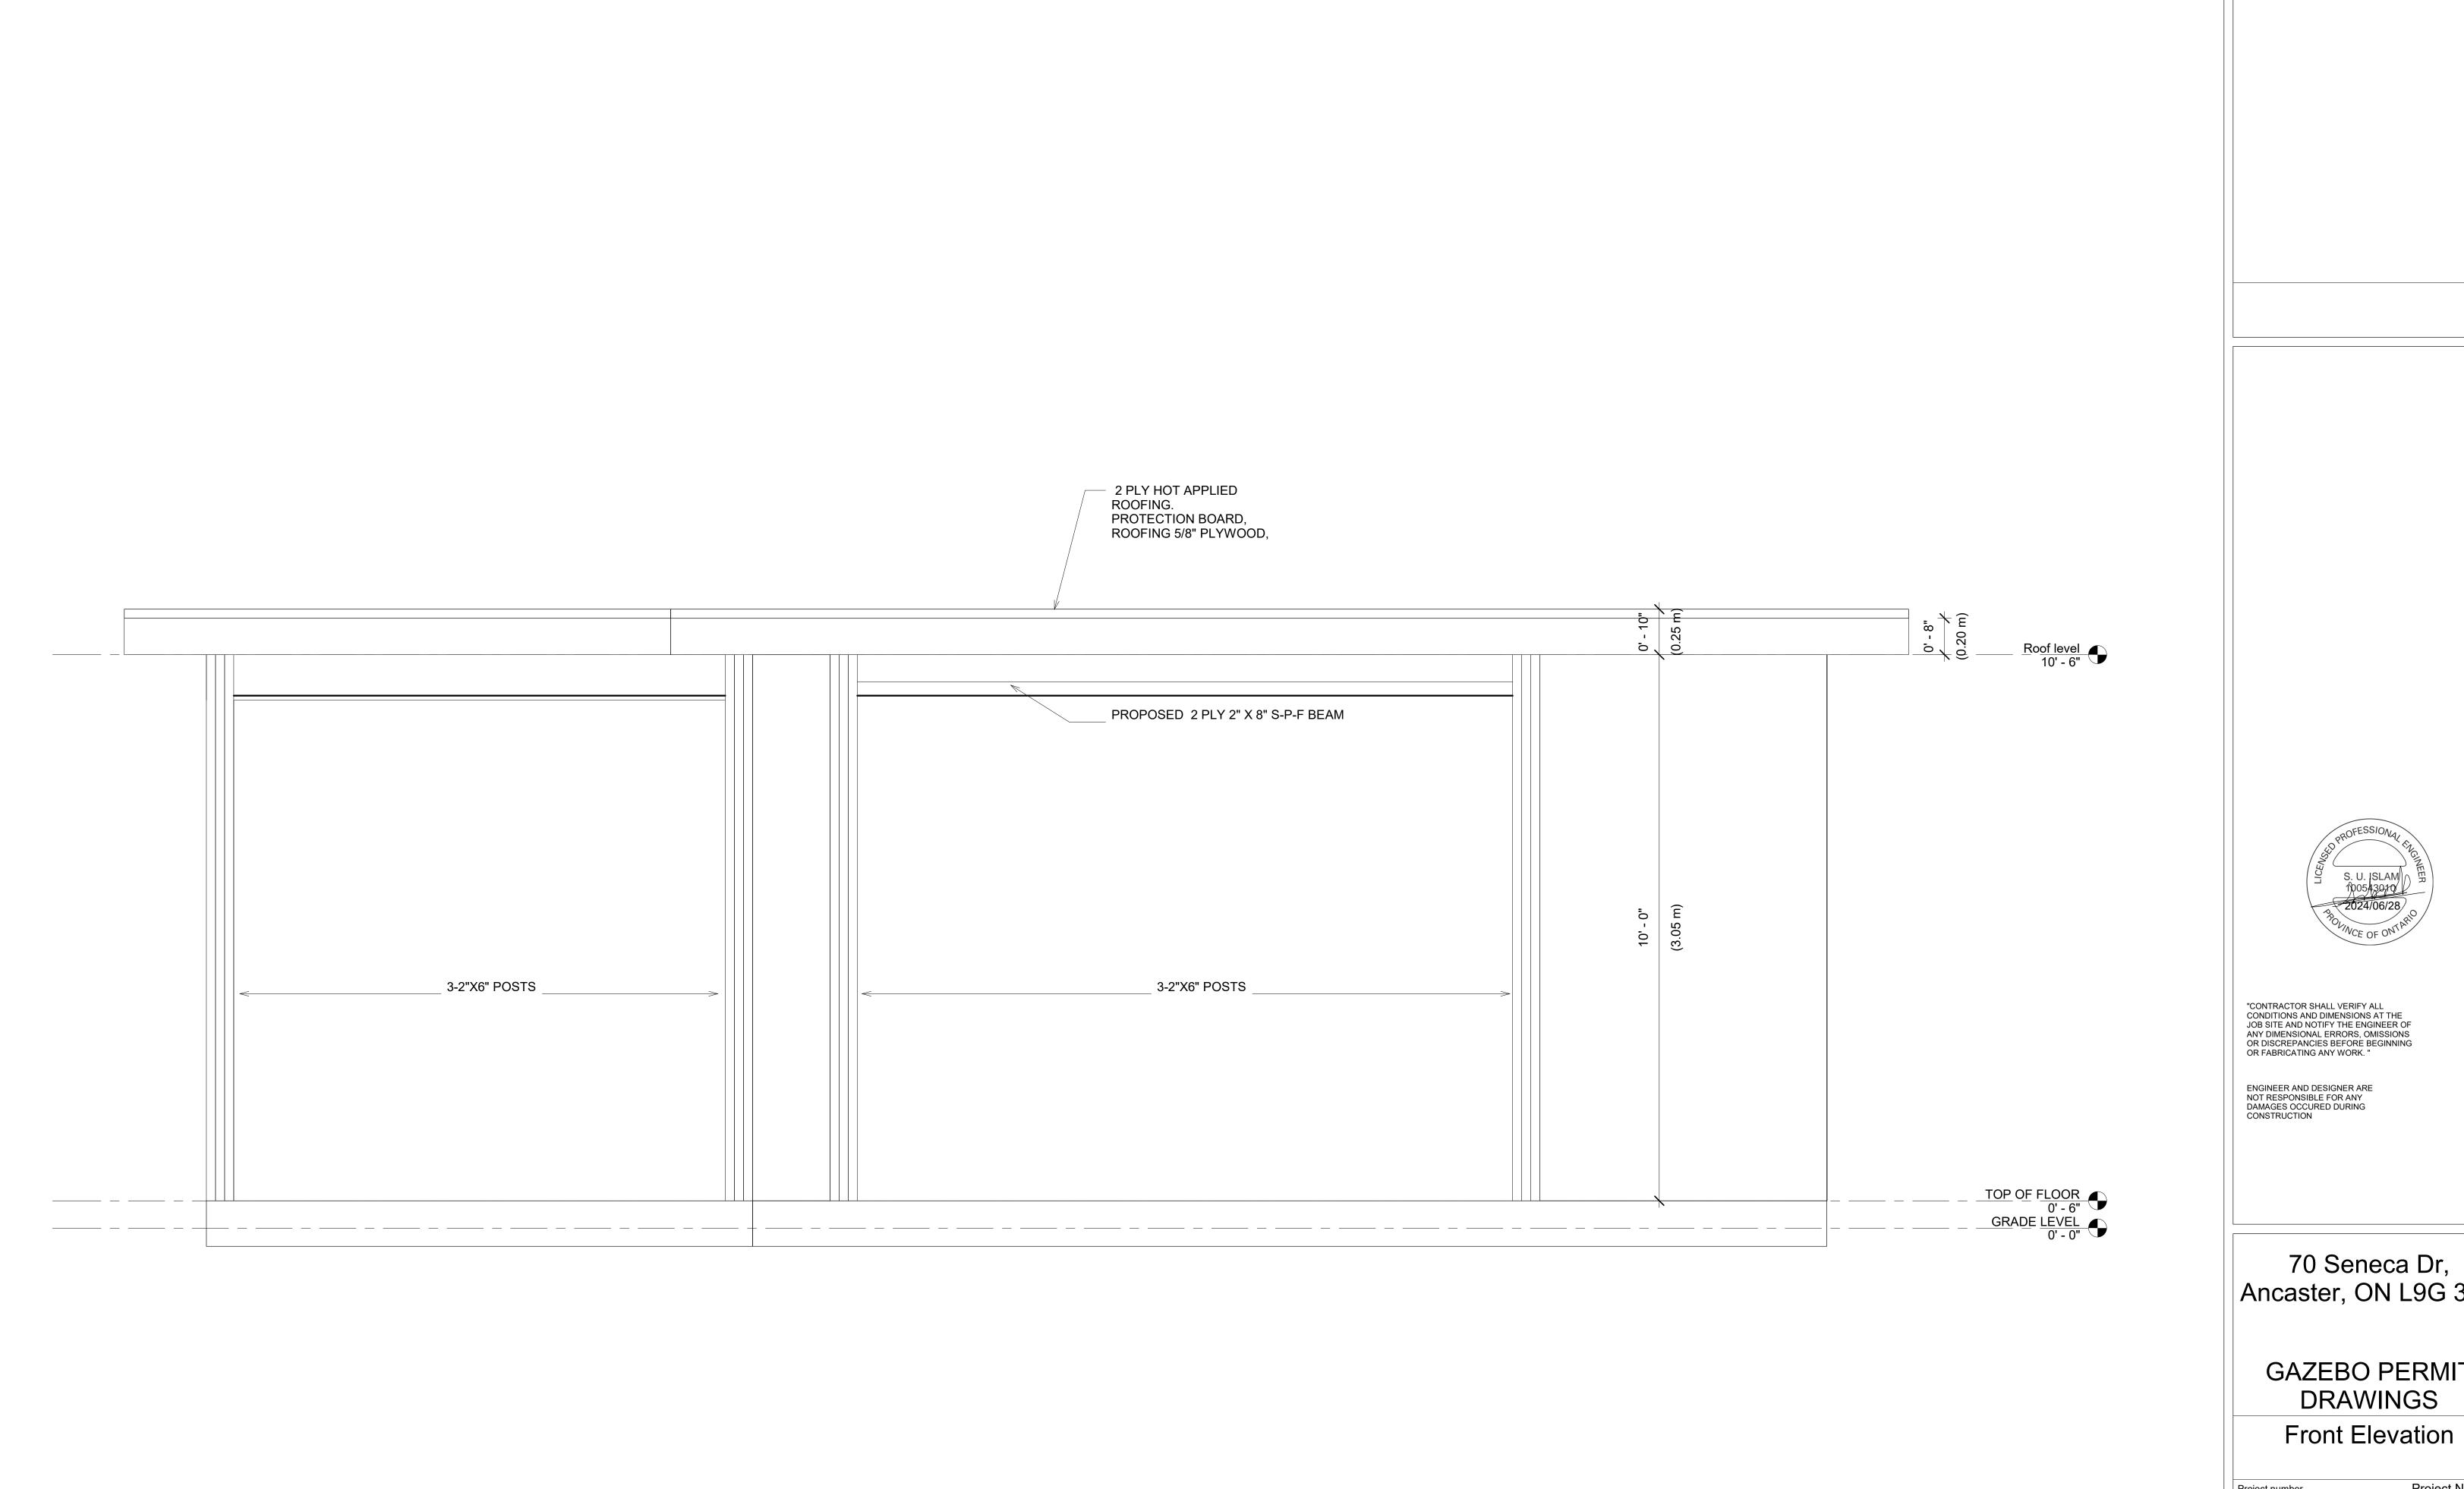



70 Seneca Dr, Ancaster, ON L9G 3B8


GAZEBO PERMIT DRAWINGS

	1107	•
Checked by		Chec
Drawn by		Aut
Date		Issue D
Project number		Project Num

Scale

A107

3/4" = 1'-0"

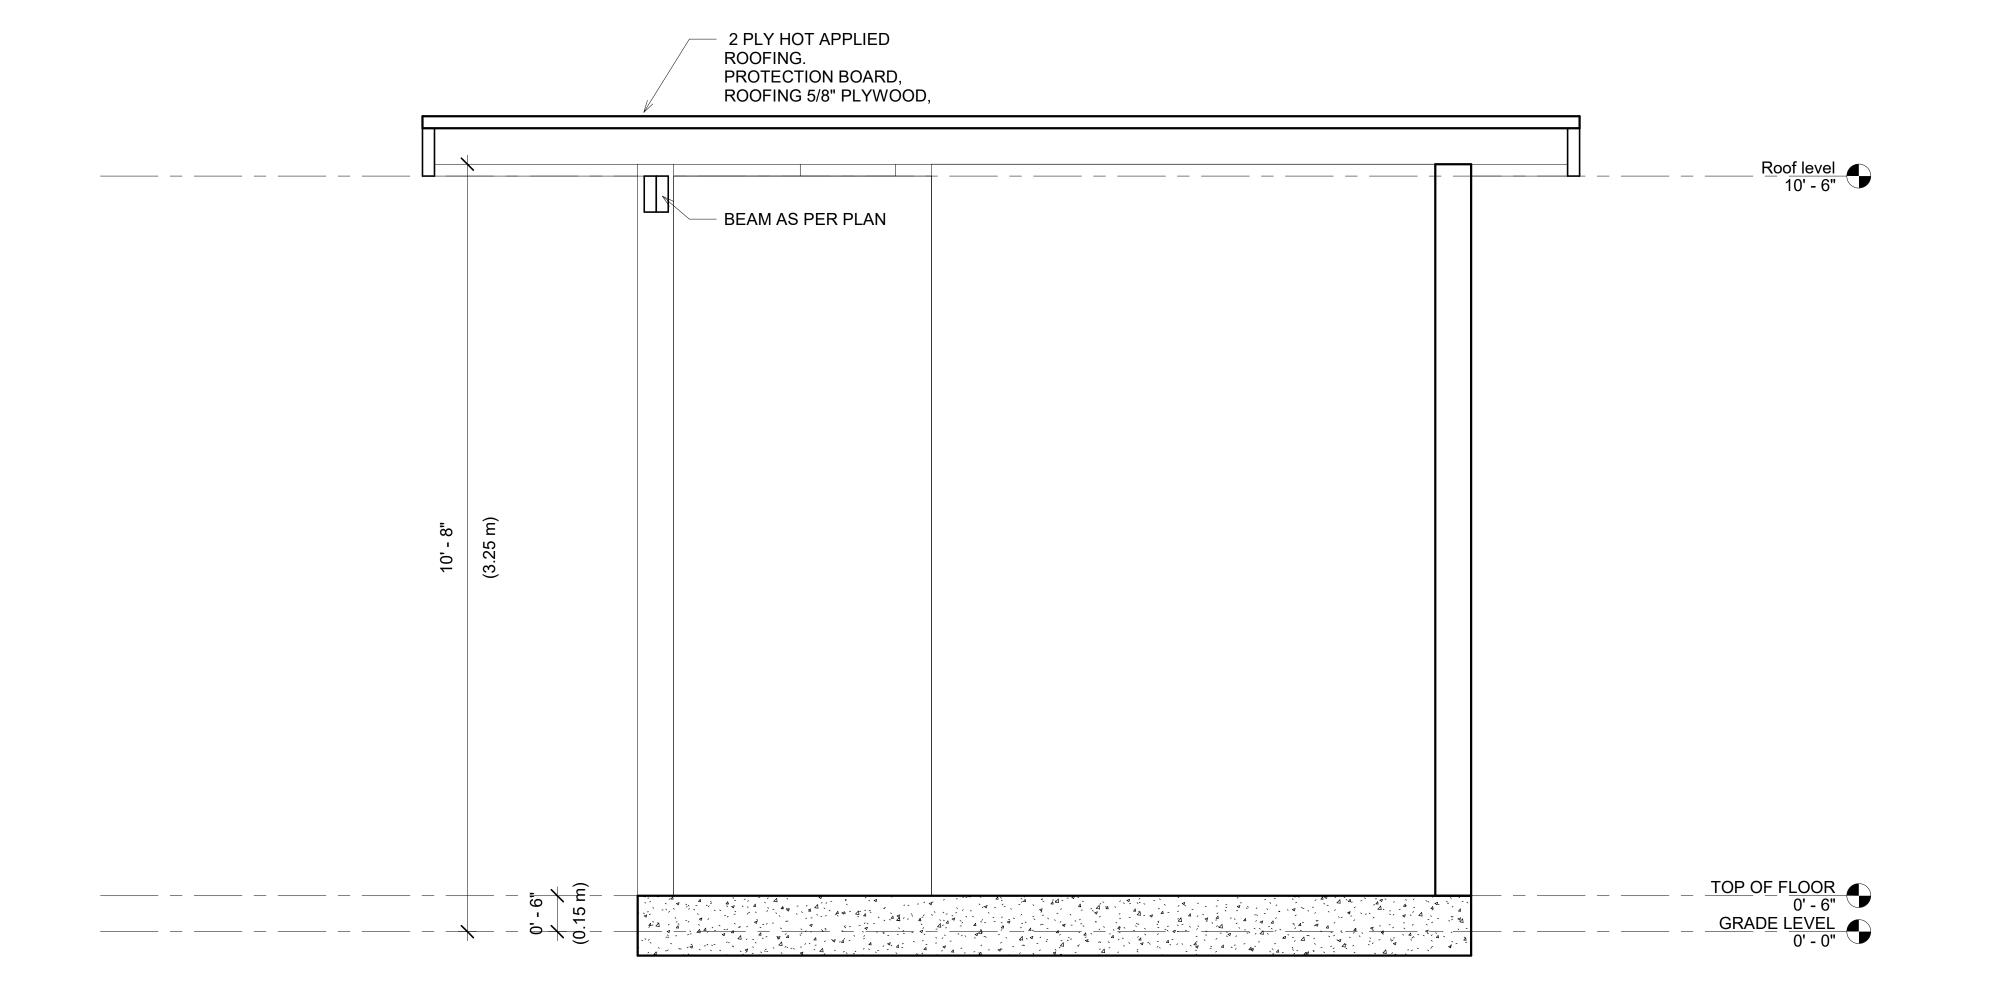



"CONTRACTOR SHALL VERIFY ALL CONDITIONS AND DIMENSIONS AT THE JOB SITE AND NOTIFY THE ENGINEER OF ANY DIMENSIONAL ERRORS, OMISSIONS OR DISCREPANCIES BEFORE BEGINNING OR FABRICATING ANY WORK."

ENGINEER AND DESIGNER ARE NOT RESPONSIBLE FOR ANY DAMAGES OCCURED DURING CONSTRUCTION

70 Seneca Dr, Ancaster, ON L9G 3B8

GAZEBO PERMIT DRAWINGS


Sections

Project number


ate		Issue Date
awn by		Author
necked by		Checker
	A108	
ale		3/4" = 1'-0"

Project Number

1 Section 2 3/4" = 1'-0"

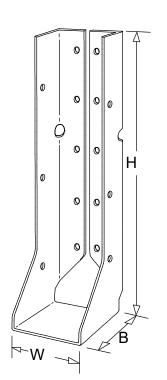

LUC

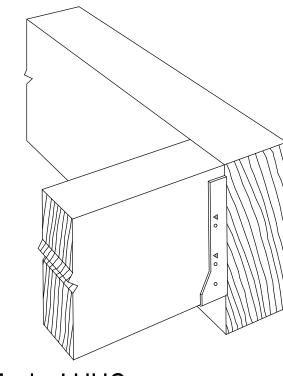

Installation:


- For HUC installations, models have triangle and round holes. To achieve maximum loads, fill both round and triangle holes (fastener quantities listed fill both holes).
- For installations into single 2x headers or ledgers, use the specified full length fasteners into the joist and the following fasteners into the header for reduced loads in accordance with www.strongtie.com:
- 10dx1½ nails for installations with Nails
- SD #9x1½ for LUC26Z and LUC210Z installations with SD Screws


Typical HUC Installation (LUC

		Simila	,	Fasteners				
Model No.	Dimensions (in.)		N	ails	SD Sc	crews		
	W	Н	В	Header	Joist	Header	Joist	
LUC26Z	1 9/16	4 3/4	1 3/4	6-10d	4-10dx1½	6-SD #9x2½	4-SD #9x1½	
LUC210Z	1 9/16	7 3/4	1 3/4	10-10d	6-10dx1½	10-SD #9x2½	6-SD #9x1½	
HUC26-2Z	3 1/8	5 3/8	2 1/2	12-16d	6-10d	-	-	
HUC28-2Z	3 1/8	7	2 1/2	14-16d	6-10d	-	-	
HUC210-2Z	3 1/8	8 13/16	2 1/2	18-16d	10-10d	-	-	


^{1. □} indicates connector is available in stainless steel. Replace Z in model number with SS when ordering.

^{2.} Refer to current Wood Construction Connectors catalog for additional information.

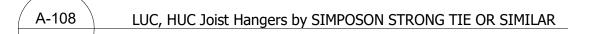

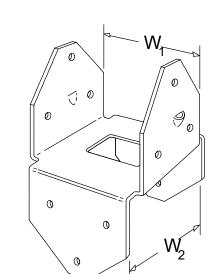



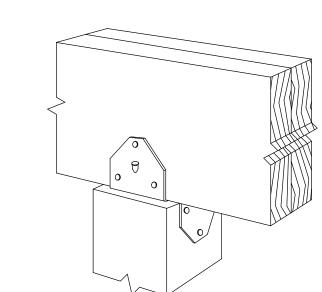

Typical BCS Installation (BC Similar)


Installation:


- BCS: Install dome nails on beam; drive nails at an angle through the beam into the post below.
- BC: Do not install bolts into pilot holes.


			Dimens	sions (in	ı .)		Fasteners			
Model No.							Nails		SD Screws	
	W1	W2	L1	L2	H1	H2	Beam Flange	Post Flange	Beam Flange	Post Flange
BC4Z	3 9/16	3 9/16	2 7/8	2 7/8	3	3	6-16d	6-16d	6-SD #10x1½	6-SD #10x1½
BC6Z	5 1/2	5 1/2	4 3/8	4 3/8	3 3/8	3 3/8	12-16d	12-16d	-	-
BCS2-2/4Z	3 1/8	3 9/16	2 7/8	2 7/8	2 15/16	2 15/16	8-10d	6-10d	8-SD #9x2½	6-SD #9x2½
BCS2-3/6Z	4 5/8	5 9/16	4 3/8	2 7/8	3 5/16	2 15/16	12-16d	6-16d	-	-

^{1. □} indicates connector is available in stainless steel. Replace Z in model number with SS when ordering.

^{2.} Refer to current Wood Construction Connectors catalog for additional information.

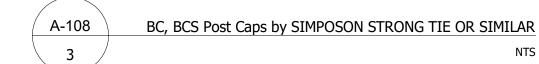

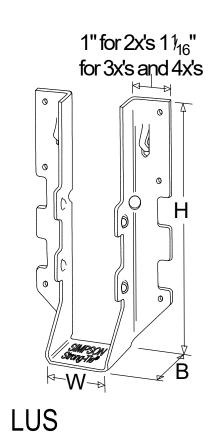

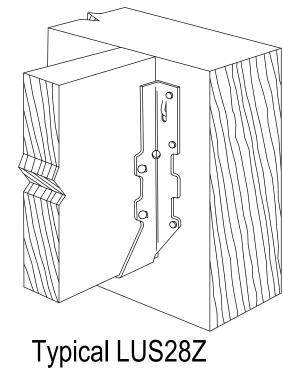

Installation

Installation:


- LUS hangers install with double shear nailing.
- For installations into single 2x headers or ledgers, use the specified full length fasteners into the joist and the following fasteners into the header for reduced loads in accordance with www.strongtie.com:
- 10dx1½ nails for installations with Nails
- SD #9x1½ for LUS28Z and LUS210Z installations with SD Screws
- •• SD #10x1½ for LUS26-2Z and LUS210-2Z installations with SD Screws

H8Z

	D:	Dimensions (in)			Fasteners			
Model No.	וט	Dimensions (in.)		Nails		SD Screws		
	W	Н	В	Header	Joist	Header	Joist	
DUS26Z	1 9/16	4 3/4	1 3/4	4-10d	4-10d	-	-	
LUS28Z	1 9/16	6 5/8	1 3/4	6-10d	4-10d	6-SD #9x2½	4-SD #9x2½	
DUS210Z	1 9/16	7 13/16	1 3/4	8-10d	4-10d	8-SD #9x2½	4-SD #9x2½	
LUS26-2Z	3 1/8	4 7/8	2	4-16d	4-16d	4-SD #10x2½	4-SD #10x21/2	
US210-2Z	3 1/8	9	2	8-16d	6-16d	8-SD #10x2½	6-SD #10x21/2	

^{1. □} indicates connector is available in stainless steel. Replace Z in model number with SS when ordering.

^{2.} Refer to current Wood Construction Connectors catalog for additional information.

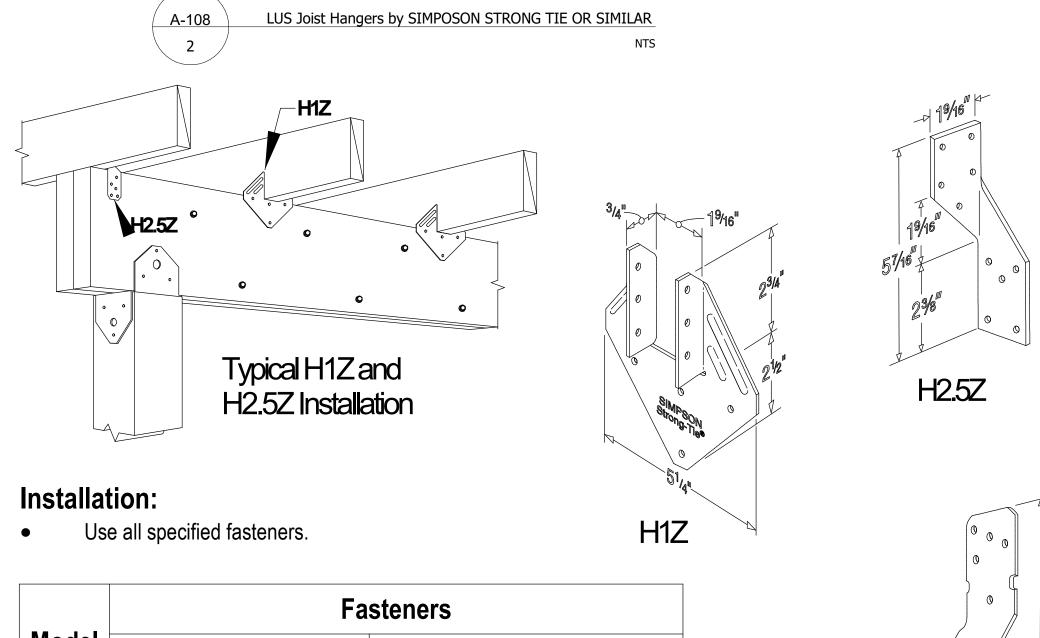

	Fasteners							
Model No.	Na	ils	SD Screws					
1101	To Joist	To Beam	To Joist	To Beam				
H1Z	6-8dx1½	4-8dx1½	6-SD #9x1½	4-SD #9x1½				
H2.5Z	5-8dx1½	5-8dx1½	5-SD #9x1½	5-SD #9x1½				
H8Z	5-10dx1½	5-10dx1½	5-SD #9x1½	5-SD #9x1½				

indicates connector is available in stainless steel. Replace Z in model number with SS when ordering.

H1Z by SIMPOSON STRONG TIE OR SIMILAR





"CONTRACTOR SHALL VERIFY ALL CONDITIONS AND DIMENSIONS AT THE JOB SITE AND NOTIFY THE ENGINEER OF ANY DIMENSIONAL ERRORS, OMISSIONS OR DISCREPANCIES BEFORE BEGINNING OR FABRICATING ANY WORK."

ENGINEER AND DESIGNER ARE NOT RESPONSIBLE FOR ANY DAMAGES OCCURED DURING CONSTRUCTION

70 Seneca Dr, Ancaster, ON L9G 3B8


GAZEBO PERMIT DRAWINGS

Framing Connection Details - 1

Project number	Project Number
Date	Issue Date
Drawn by	Author
Checked by	Checker


A109

3/4" = 1'-0"

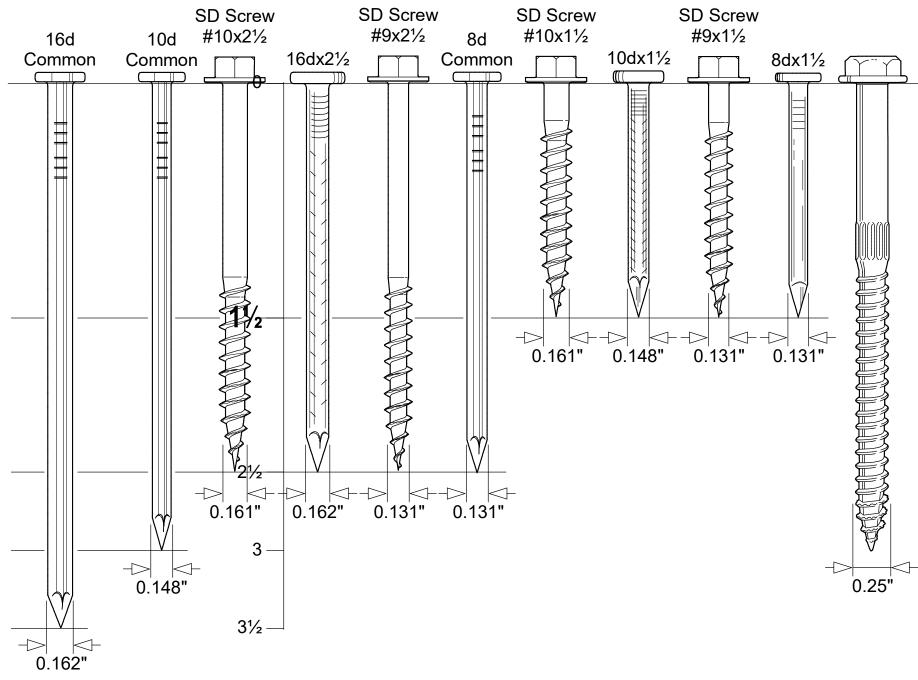


Fastener Notes:

- The specified quantity, type and size of fastener must be installed in the correct holes on the connector to achieve published loads. Incorrect fastener selection or installation can compromise connector performance and could lead to failure.
- Nail diameter assumes no coating. See technical bulletin T-NAILGUIDE for more information. The Simpson Strong-Drive ® SD structural-connector screw is the only screw approved for use with our connectors.
- NAIL reference in tables: 16d = 16d common, 10d = 10d common

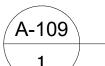



Fasteners by SIMPOSON STRONG TIE OR SIMILAR

NTS

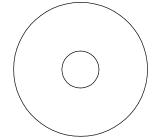


Round Holes Purpose : to fasten a connector. Fill requirements : always fill, unless noted otherwise.

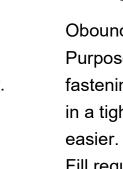

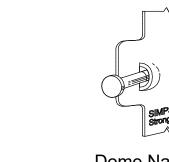

Dome Nailing Used to temporarily This feature guides the nail into the position and secure the joist and header at connector for easier a 45° angle. and faster installation.

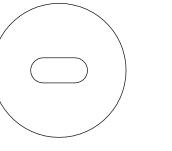

Obound Holes Purpose: to make fastening a connector in a tight location Fill requirements . always fill.

Fill requirements always fill when fastening a connector to concrete or masonry.

or masonry.

Hexagonal Holes

Purpose : to fasten a

connector to concrete

Triangular Holes

Purpose : to increase

a connector's strength


or to achieve Max

Fill requirements .

when the designer •


specifies Max nailing.

strength.

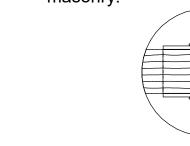


Double Shear Nailing The nail is installed in the joist and header, distributing the load through two points on each joist nail for

greater strength.

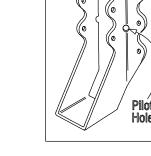

Pilot Holes Tooling holes for manufacturing purposes. No fasteners required.

Fastening Identification

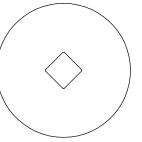

Diamond Holes Purpose: to temporarily fasten a connector to make installing easier.

Fill requirements .

none.

"CONTRACTOR SHALL VERIFY ALL CONDITIONS AND DIMENSIONS AT THE JOB SITE AND NOTIFY THE ENGINEER OF ANY DIMENSIONAL ERRORS, OMISSIONS OR DISCREPANCIES BEFORE BEGINNING OR FABRICATING ANY WORK."

ENGINEER AND DESIGNER ARE NOT RESPONSIBLE FOR ANY DAMAGES OCCURED DURING CONSTRUCTION

70 Seneca Dr, Ancaster, ON L9G 3B8

GAZEBO PERMIT DRAWINGS


Framing Connection Details - 2

Project Number Project number Issue Date Drawn by Checked by Checker

A110

Scale

3/4" = 1'-0"

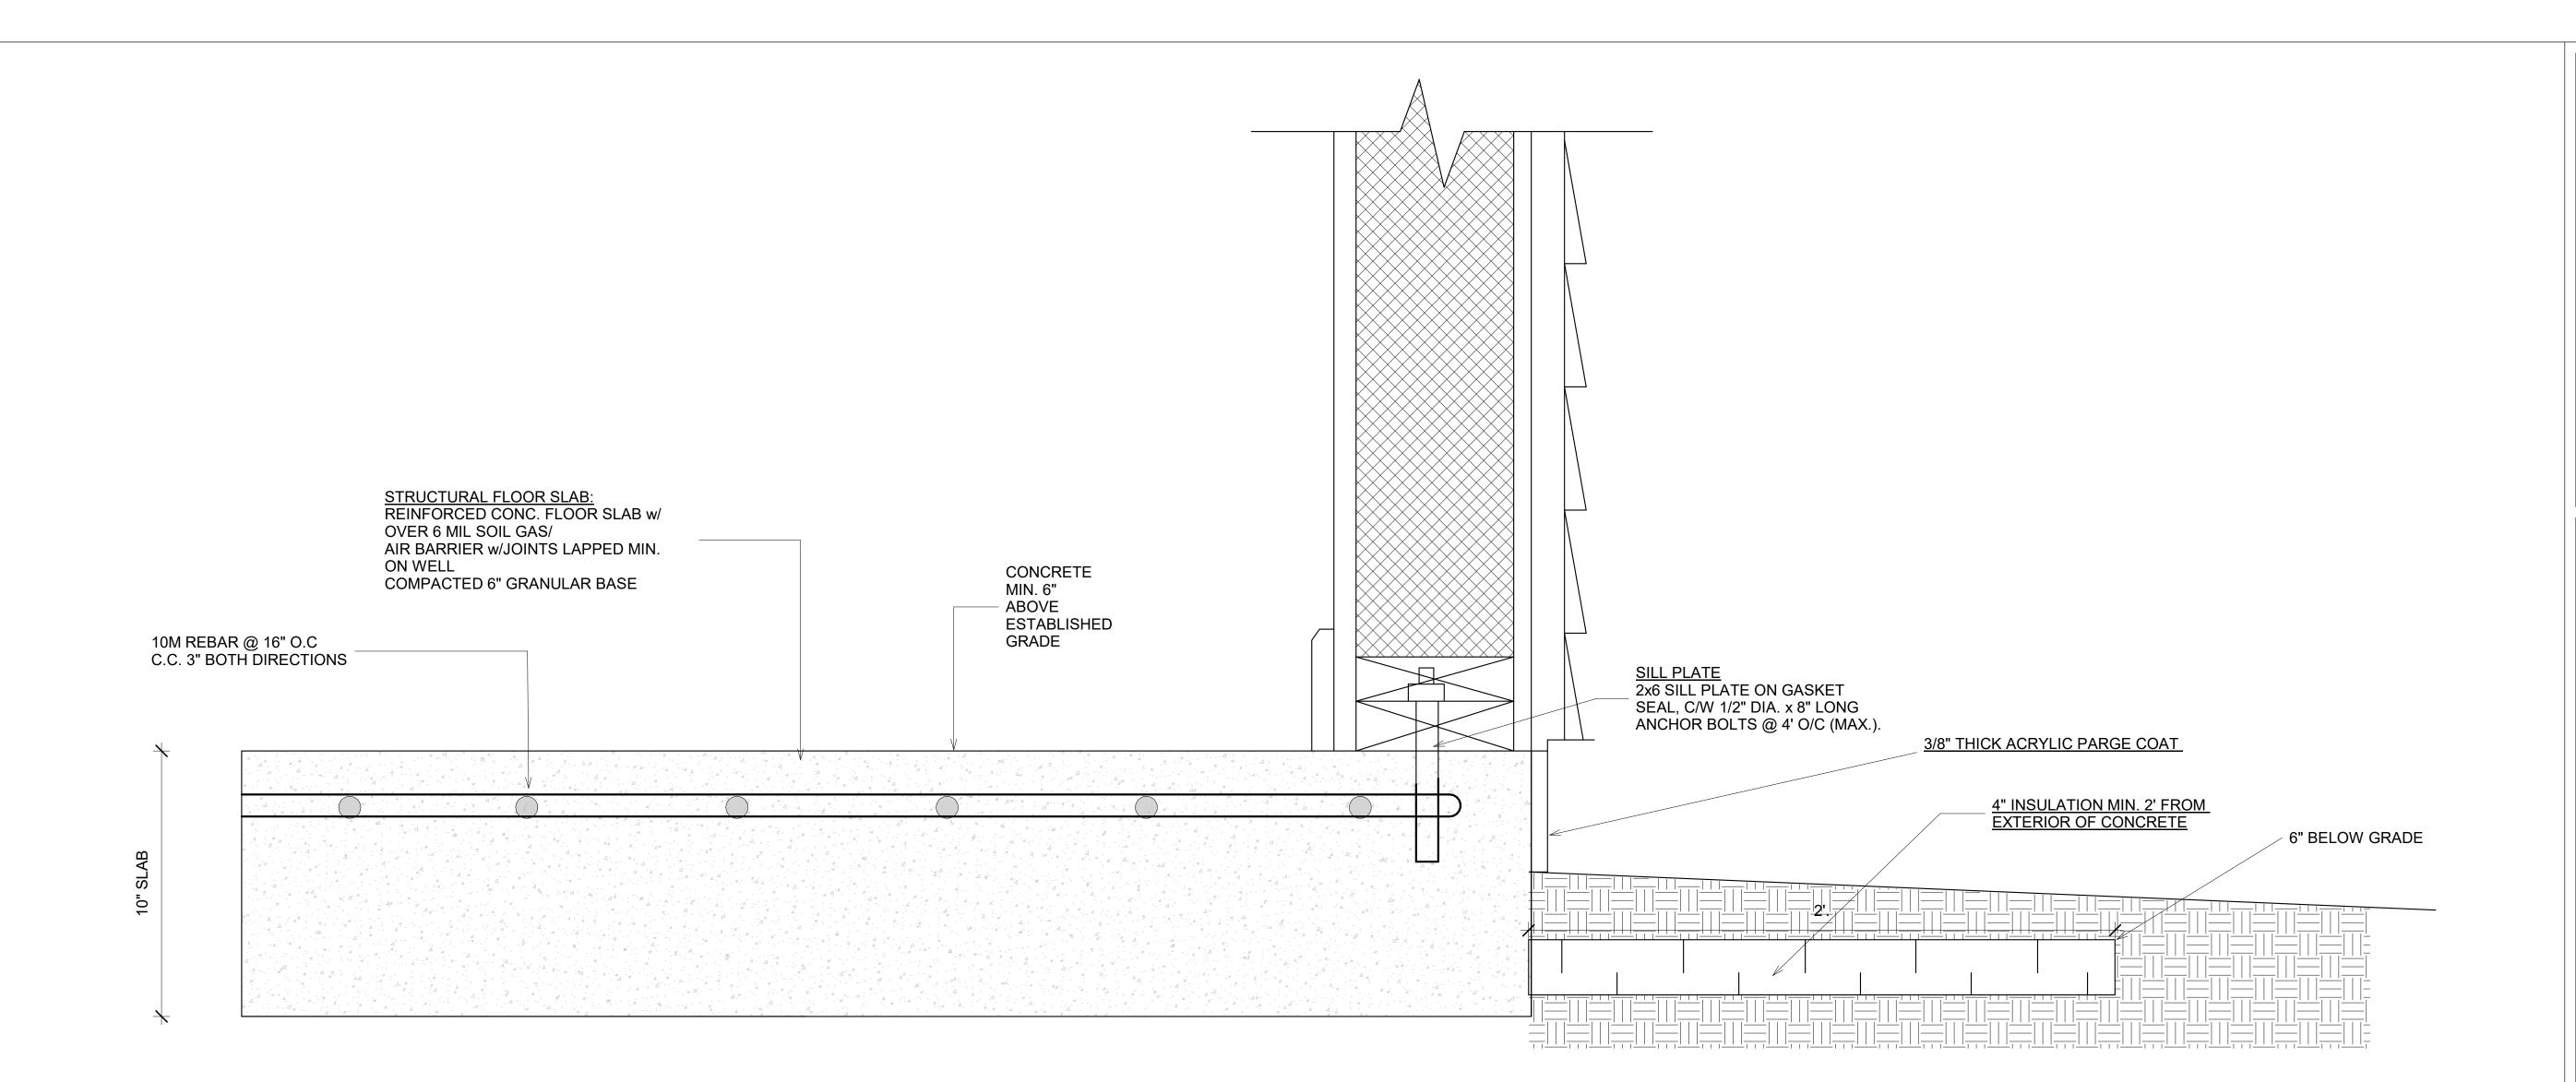



"CONTRACTOR SHALL VERIFY ALL CONDITIONS AND DIMENSIONS AT THE JOB SITE AND NOTIFY THE ENGINEER OF ANY DIMENSIONAL ERRORS, OMISSIONS OR DISCREPANCIES BEFORE BEGINNING OR FABRICATING ANY WORK."

ENGINEER AND DESIGNER ARE NOT RESPONSIBLE FOR ANY DAMAGES OCCURED DURING CONSTRUCTION

70 Seneca Dr, Ancaster, ON L9G 3B8


GAZEBO PERMIT DRAWINGS FOUNDATION DETAIL


Project number	Project Number
Date	Issue Date
Drawn by	Author
Checked by	Checker


Scale

A111

1 FLOOR FOUNDATION 6" = 1'-0"

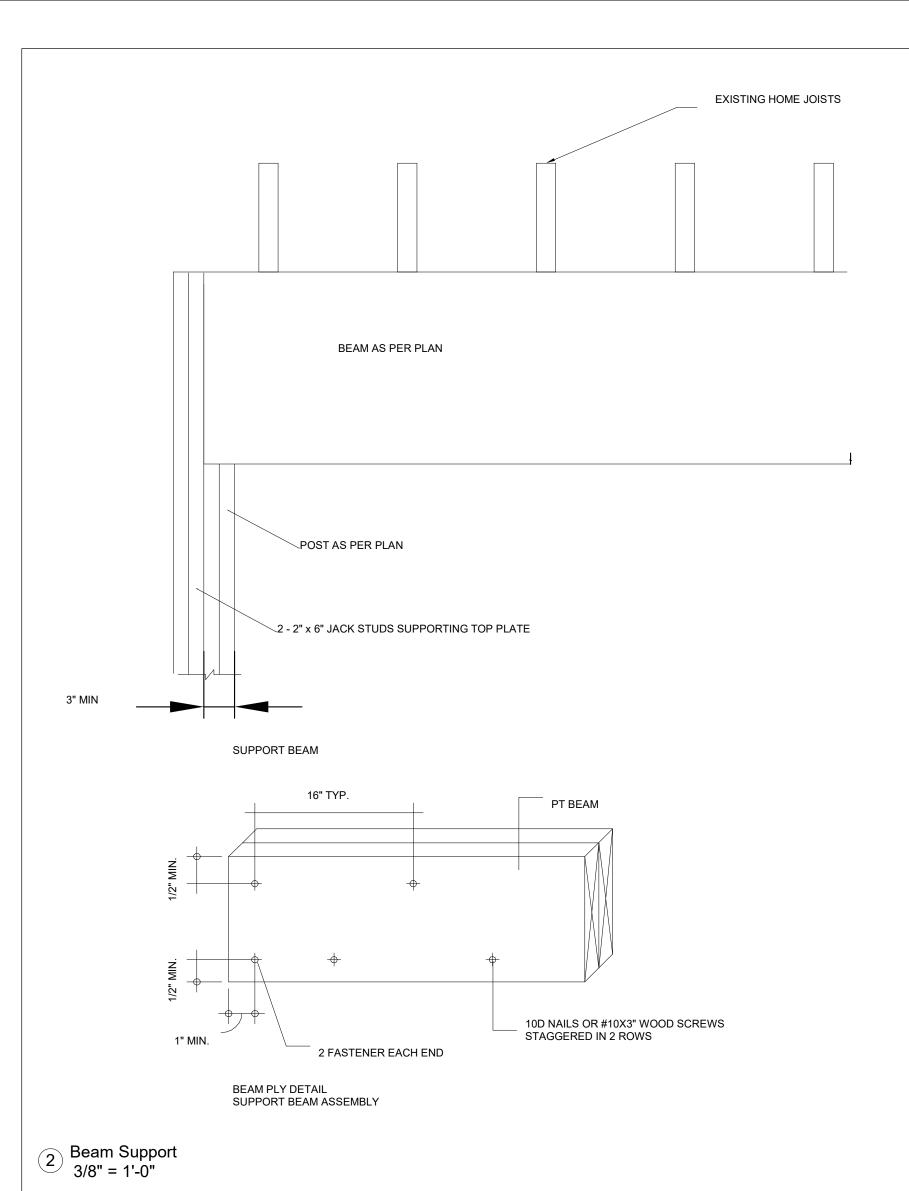

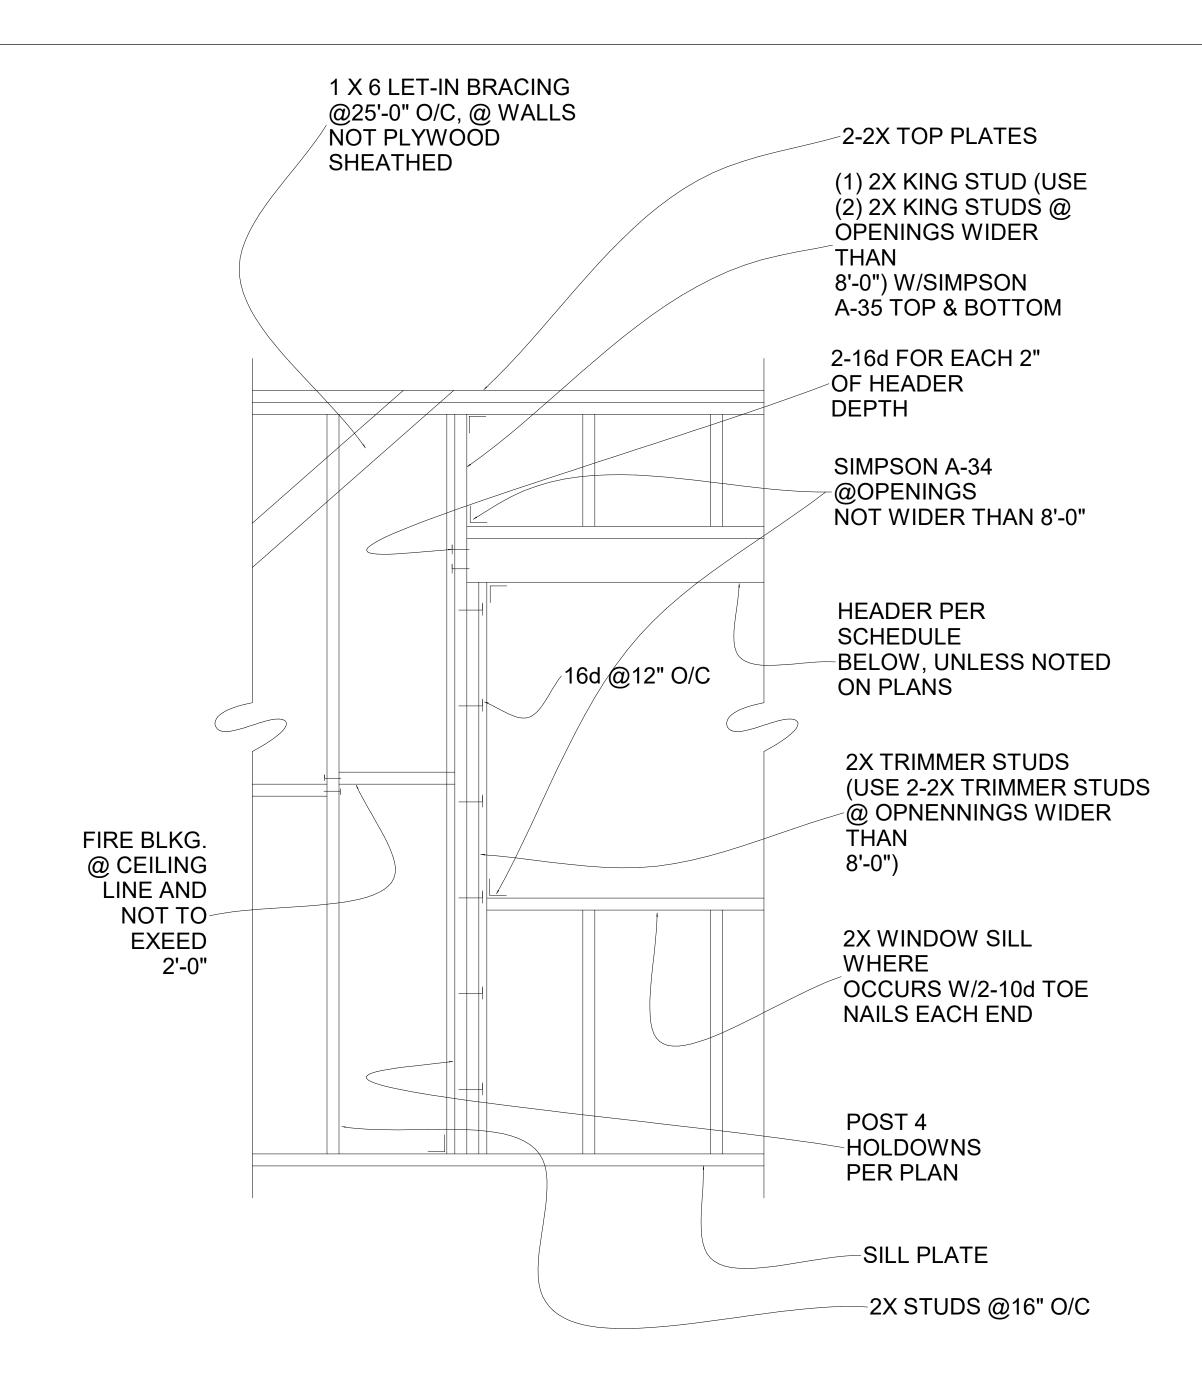

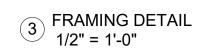



"CONTRACTOR SHALL VERIFY ALL CONDITIONS AND DIMENSIONS AT THE JOB SITE AND NOTIFY THE ENGINEER OF ANY DIMENSIONAL ERRORS, OMISSIONS OR DISCREPANCIES BEFORE BEGINNING OR FABRICATING ANY WORK."

ENGINEER AND DESIGNER ARE NOT RESPONSIBLE FOR ANY DAMAGES OCCURED DURING CONSTRUCTION

70 Seneca Dr, Ancaster, ON L9G 3B8

GAZEBO PERMIT DRAWINGS FRAMING DETAIL

	Project number	Project Numbe
	Date	Issue Date
	Drawn by	Autho
	Checked by	Checke

A112

Scale

As indicated

)24-07-25 8:21:57 PI



Committee of Adjustment

City Hall, 5th Floor, 71 Main St. W., Hamilton, ON L8P4Y5

Phone: (905) 546-2424 ext. 4221

Email: cofa@hamilton.ca

APPLICATION FOR A MINOR VARIANCE/PERMISSION

UNDER SECTION 45 OF THE PLANNING ACT

1. APPLICANT INFORMATION

	NAME			
Registered Owners(s)	Marcie Hall	selle		
Applicant(s)	Sabih UI islam	Ant.		
Agent or Solicitor	Charman of mace 3	palleds) (n.	ata no tem	Phone:
, metres, hectares,	etienika varinu pinetre	own in behavoirg ed		E-mail:
.2 Primary contact	a erli of mutrico Jon	☐ Applicant	oppiled for	☑ Owner ☐ Agent/Solicitor
.3 Sign should be s	ent to	☐ Applicant		☑ Owner ☐ AgentSolicitor
.4 Request for digit	al copy of sign	☑ Yes*	□ No	and other and a h vrMV
If YES, provide e	email address where	sign is to be sent		y rest edit
.5 All corresponder	nce may be sent by	email JaA paint	☑ Yes*	□ No
(if applicable). O	mail must be include only one email addre es not guarantee all	ss submitted will r	esult in the	AND the Applicant/Agent voiding of this service. email.
.6 Payment type		☑ In person ☐ Cheque	ane.	Credit over phone*
			*Must pr	ovide number above

2. LOCATION OF SUBJECT LAND

2.1 Complete the applicable sections:

Municipal Address	70 Seneca DrAncaster, ON L9G 3B8			
Assessment Roll Number				
Former Municipality				
Lot	2011/11/19	Concession	(O J99A	
Registered Plan Number	Law water and	Lot(s)		
Reference Plan Number (s)		Part(s)	Se Control & No. 10 Control	

2.2	Are there any	easements	or restrictive covenants	affecting the	subject land?
-----	---------------	-----------	--------------------------	---------------	---------------

☑ Yes ☐ No

If YES, describe the easement or covenant and its effect:

HYDRO ELECTRIC POWER COMISSION EASEMENT NO. AN 33948

BELL TELELPHONE EASEMENT NO. AN33812

3. PURPOSE OF THE APPLICATION

Additional sheets can be submitted if there is not sufficient room to answer the following questions. Additional sheets must be clearly labelled

All dimensions in the application form are to be provided in metric units (millimetres, metres, hectares, etc.)

3.1 Nature and extent of relief applied for:

We are proposing a gazebo in the rear yard which does not conform to the side setback requirements.

☐ Second Dwelling Unit

☐ Reconstruction of Existing Dwelling

3.2 Why it is not possible to comply with the provisions of the By-law?

The rear yard required setback is 7.5m, We are proposing Rear yard setback of 4.3m

3.3 Is this an application 45(2) of the Planning Act.

☐ Yes

☑ No

If yes, please provide an explanation:

4. DESCRIPTION OF SUBJECT LAND AND SERVICING INFORMATION

4.1 Dimensions of Subject Lands:

Lot Frontage	Lot Depth	Lot Area	Width of Street
25m (81.4ft)	45 m (145 ft)	1125 m2 (11803 sqft)	6.5m (22 ft)

4.2 Location of all buildings and structures on or proposed for the subject lands: (Specify distance from side, rear and front lot lines)

Existina:

Type of Structure	Front Yard Setback	Rear Yard Setback	Side Yard Setbacks	Date of Construction
Single Family Detached Home	12.6 m	17m 201 83150	4.04 & 3.55	harma []
Shed	N/A	4.26	1.56	10/10/2023
Pool	the tree agent terms	6.5	4 & 12	10/10/2023
E (SIS VISOR IN	a engle anilewb	bancelob entital /flend	to late data and to 13	wasterness of

Proposed:

Type of Structure	Front Yard Setback	Rear Yard Setback	Side Yard Setbacks	Date of Construction
Gazebo	N/A	4.3	2,26	07/14/2024
		, 31	ma readence ann	NO FROM SALE

Particulars of all buildings and structures on or proposed for the subject lands (attach additional sheets if necessary):

Existing:

Type of Structure	Ground Floor Area	Gross Floor Area	Number of Storeys	Height
Pool	36	36	0	0
Shed	9	9	er oeiltevü bara	2.4
Single Family Detach	de 121,6/m²	Charles and a second	1	
0. 1	and the state of t	Seatter of the Filters and	1	

Proposed:

Type of Structure	Ground Floor Area	Gross Floor Area	Number of Storeys	Height
Gazebo	27	27	1	3.1
				141-151
			A share in the course of	
			Che tributhout to a 100 M	

- Type of water supply: (check appropriate box) 4.4
 - ☐ publicly owned and operated piped water system ☐ lake or other water body ☐ privately owned and operated individual well ☐ other means (specify)
 - other means (specify)
 - Type of storm drainage: (check appropriate boxes)
 - publicly owned and operated storm sewers ☐ swales

	ditches
11/2	other means (specify

(22 ft)

Page 2 of 8

4.6	Type of sewage disposal proposed: (check appropriate box)
	 ☑ publicly owned and operated sanitary sewage ☐ system privately owned and operated individual ☐ septic system other means (specify)
4.7	Type of access: (check appropriate box) ☐ provincial highway ☐ municipal road, seasonally maintained ☐ municipal road, maintained all year ☐ municipal road, maintained all year
4.8	Proposed use(s) of the subject property (single detached dwelling duplex, retail, factory etc.): Single Detached Dwelling
4.9	Existing uses of abutting properties (single detached dwelling duplex, retail, factory etc.): Single Detached Dwelling
7	HISTORY OF THE SUBJECT LAND
7.1	Date of acquisition of subject lands:
7.2	Previous use(s) of the subject property: (single detached dwelling duplex, retail, factory etc) Single Detached Dwelling
7.3	Existing use(s) of the subject property: (single detached dwelling duplex, retail, factory etc) Single Detached Dwelling
7.4	Length of time the existing uses of the subject property have continued:
7.5	What is the existing official plan designation of the subject land?
	Rural Hamilton Official Plan designation (if applicable):
	Rural Settlement Area:
	Urban Hamilton Official Plan designation (if applicable) Neighbourhoods
	Please provide an explanation of how the application conforms with the Official Plan.
7.6	What is the existing zoning of the subject land?
7.8	Has the owner previously applied for relief in respect of the subject property? (Zoning By-lawAmendment or Minor Variance) ☐ Yes ✓ No
	If yes, please provide the file number:

	Planning Act? ☐ Yes	☑ No	
	If yes, please provide the file number:		TEL Ske Skeps
	of Planning and Chief Planner to submit		
8	ADDITIONAL INFORMATION (transpersions and allowed leaders state) and		
8.1	Number of Dwelling Units Existing: 1		
8.2	Number of Dwelling Units Proposed: 0	frisinase	
			Septic Assertment
8.3	Additional Information (please include separa	te sheet if needed	d): aekaA lebinoi serbaA 🗍
	we to the second		

	✓ Application Fee	01. (2)		
	Site Sketch			
	Complete Application f	form		
	Signatures Sheet			
11.4	Other Information Deemed N	ecessary		
	Cover Letter/Planning Justification Report			
	Authorization from Con application for Minor V		or of Planning and Chief	F Planner to submit
	☐ Minimum Distance Separation Formulae (data sheet available upon request)			
	☐ Hydrogeological Asse	ssment		
	Septic Assessment (belies not been a been supposed by the second recognition of the red multiple of the r			
	Archeological Assessr			
	☐ Noise Study			
	☐ Parking Study		78	