50 Markland St

RENOVATION PROPOSAL

Project Address: 50 Markland St. Hamilton, ON

Owner information: Eric and Sarah Desrosiers

Project Overview: Demolish the back portion of the existing home and rebuild with salvaged or like materials

(specified and outlined herein).

Attached

Appendix A – Photos of Existing [Attached Herein]

Appendix B – Architectural Drawings / Blueprints

INTRODUCTION

After years of searching and waiting, Sarah and I became the keepers of 50 Markland St., for years to come. After living in the Herkimer Apartments (looking into this very backyard every day) we were fortunate to make contact with Carl Turkstra, the previous owner of this home and a proud member of this community. Unfortunately, after 30 years of living there, he was no longer able to keep up with the maintenance of the home and it slowly fell into a somewhat weathered state. Sarah and I look forward to many years in this home, having just welcomed two children into this world since 2022, our vision is to raise our kids in this community and continue to thrive many years after.

Below, you will find our outlined proposal and vision to bring this home back into its glory and into a more liveable functional home so that it may remain our family home.

We look forward to discussions regarding our proposed renovations.

Scope of Work Breakdown

DEMOLITION

Our proposal includes the full demolition of the back portion of the home, as outlined and displayed in the attached drawings. This demolition will include the full demolition of the foundation, exterior walls and windows, and roof.

RECONSTRUCTION

The reconstruction will expand the back portion of the home using like materials (outlined throughout this document). The plans call to extend the home back 4' and increase the liveable space on both the main floor and second floor. Currently the back portion of the home is deteriorating due to previous neglect and was laid out in a manor that did not connect the liveable space to the back yard – as was common design in years past. We hope to rebuild the back portion in a manor to increase access to the rear yard and bring in more natural light to the liveable space. The reconstruction will utilize as many like or salvaged materials as possible.

BRICKS/MASONRY

During the demolition our best effort will be made to salvage some brick and material, though we are being advised by restoration masons and the engineer that not much brick will be kept. Currently we are allowing for all new brick. We have sourced a brick that is identical to the existing and perfectly matches the aged/ imperfect brick from this old home. This brick was also utilized on our Garage renovation (Hertiage Permit: HP2023-018)



WINDOWS


For the front portion of the house, we are working with a company to be able to closely match the windows with a heritage style window. We have been advised that the current condition of the windows may hinder us from properly and effectively restoring them. The function of many windows is not effective, being unable to open or in some cases having lost the counterweight.

For the remaining windows (all side windows and windows at back of building) we are proposing to install all new windows in a matching style. We are proposing to install wood windows (same as existing) with an identical mullion pattern and trim from the exterior.

We believe this maintains the heritage look of the home from all visible sightlines, while increasing functionality in our home. It is important for us to keep the same aesthetic, while equally important to be able to properly utilize these fixtures.


The street facing windows we are proposing are Pella – Reserve windows. From Pella's brochure "Pella Reserve – Traditional products provide historical elements with uncompromised attention to detail." These windows are of same wood construction and both the profile, and the grille will be a near seamless match.

The non street facing windows we are proposing are Pella – Lifestyle windows. There of similar design and look, using wood construction, however they utilize some more modern technology and systems for better efficiency and functionality.

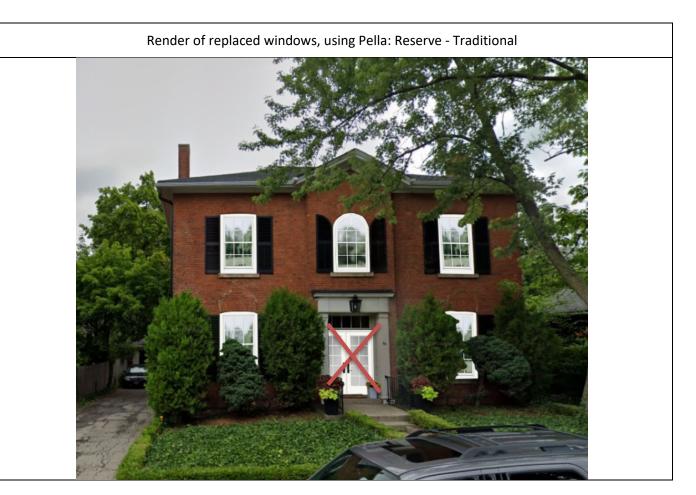

DOORS

The only door that will be visible from any sightline will be the front door (street facing). We intend to replace this door with a similar door and sidelights.

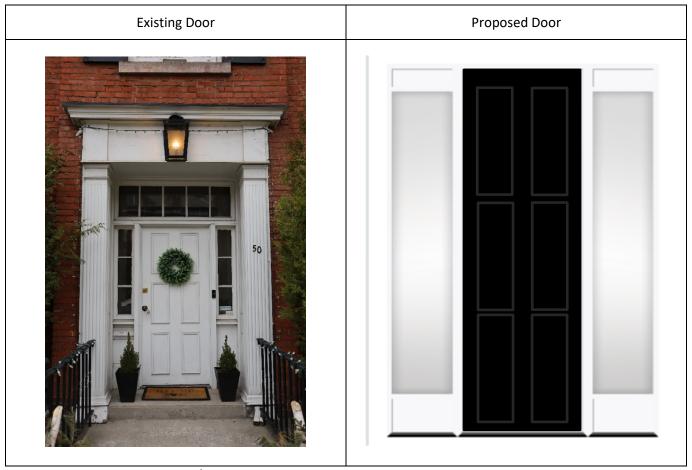


We are proposing a similar door/sidelight assembly – *door panel in rendering is not accurate and will more closely match the existing.*

We will be changing the door colour to black to match the existing window shutters on the house.

ROOF

The new roof on the proposed addition will be set at the same level as the existing roof (as displayed in the Drawings – Appendix). The roofing will be of the same material, and all trim and gutters will match in colour and style.

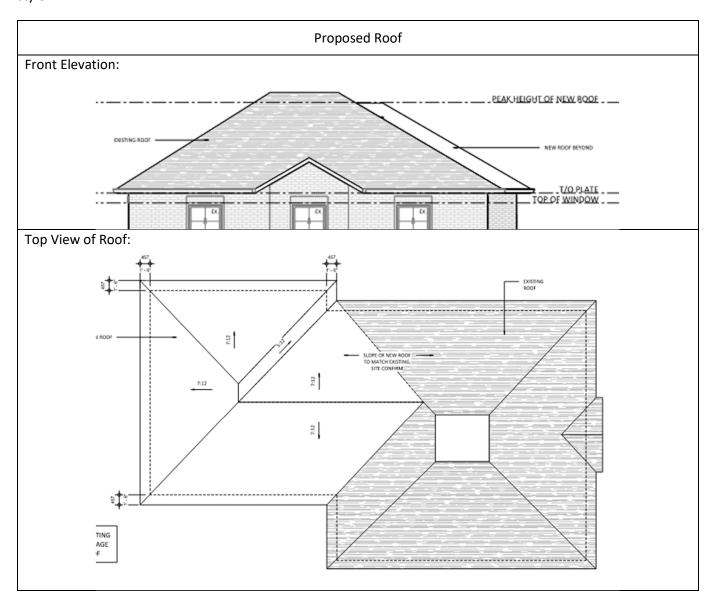

Existing and proposed materials will be the same – GAF Black Architectural Shingles.


The visible downspouts are not being changed and will remain as is. The new downspouts will be a perfect match of same material and colour (black aluminum downspouts and off-white gutters).

Appendix A – Photos







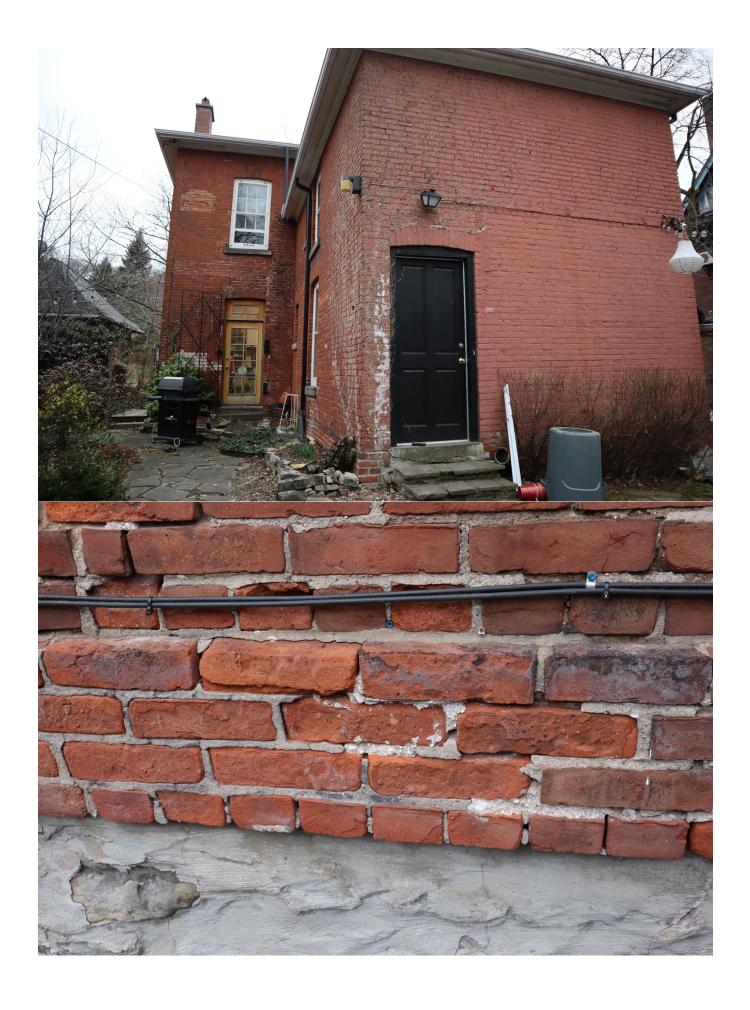



Appendix B - Drawings

Provided on Following pages.



1650 SISMET ROAD MISSISSAUGA, ONTARIO L4W 1R4

50 MARKLAND STREET 2-STOREY EXTENSION

50 MARKLAND ST, HAMILTON, ON, L8P 2J7
PROJECT No. 23-310





STRUCTURAL

Quinn Dressel Associates 890 Yonge Street, Suite 300 Toronto, Ontario M4W 3P4 Canada T: 416-961-8294 Ext 220 F: 416-961-7434 www.quinndressel.com



2		OFA NEW	GFA - EXISTING TO	OFA EVICTING		
50	TOTAL (SQM)	GFA - NEW (SQM)	BE DEMOLISHED (SQM)	GFA - EXISTING TO REMAIN (SQM)	LEVEL	
	118.66	84.14	35.61	70.13	BASEMENT	
CLIENT	188.45	59.72	35.61	164.34	GROUND FLOOR	
	207.26	78.53	35.61	164.34	SECOND FLOOR	
	24.81	0.00		24.81	ATTIC	
	539.18	TOTAL AREA				
1650	420.53	TOTAL GFA ABOVE GRADE				
	DV I AIM CEO2	BY I AW 05 200 BY I AW 6509		SITE STATISTICS		
ARCHIT	BY-LAW 6593	BY-LAW 05-200	REQUIRED	SQM		
	360.00	360.00	360 sqm	751.87	LOT AREA - EXISTING PER SURVEY	
				188.45	BUILDING AREA PROPOSED (FOOTPRINT)	
				49.05	EXISTING GARAGE (FOOTPRINT)	
				99.466	ASPHALT DRIVEWAY AREA - EXISTING	
	NOT PROVIDED	SECTION 15.1.2.1(h): 30%	30% min.	414.89 sqm (55.18%)	TOTAL LANDSCAPED AREA	
CONSU						
				LANDSCAPING	FRONT YARD	
			REQUIRED (%)	SQM		
				45.535	FRONT YARD AREA (FYA)	
				9.093	ASPHALT DRIVEWAY AREA (WITHIN FRONT YARD)	
	NOT PROVIDED	SECTION 4.35(a): 50%	50.00%	36.442sqm (80.03%)	FRONT YARD LANDSCAPING (FYL)	
THIS DRAW REFER TO						
ELECTRICA PROCEEDI				DING DIMENSIONS	SETBACKS/ BUIL	
CONSTRUC REQUIREM			REQUIRED (m)	PROPOSED (m)		
THE CONTI MARKED "F RESPONSII DAMAGES	11m	10.5m	10.50	9.78m New (10.3m existing)	BUILDING HEIGHT LIMIT	
THIS DRAW AND IS THE	12m	12m	12.00	18.54m - EXISTING	LOT WIDTH	
THE CONTI						
THE APPRO SUPPLIED			REQUIRED (m)	PROPOSED (m)	SETBACKS	
KEY PL	6m MIN.	4m MIN	4m MIN	2.4 to 2.5m - EXISTING	FRONT YARD SETBACK	
	1.2m MIN.	1.2m MIN.	1.2m MIN.	2.3 to 4.86m - EXISTING	SIDE YARD SETBACK	
	7.5m MIN.	7.5m MIN.	7.5m MIN.	1	REAR YARD SETBACK	

GROSS FLOOR AREAS - 50 MARKLAND ST

50 MARKLAND STREET 2-STOREY EXTENSION

50 MARKLAND ST, HAMILTON, ON, L8P 2J7

VERLY CONSTRUCTION GROUP

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CONSTRUCTION MUST CONFORM TO ALL APPLICABLE CODES AND REQUIREMENTS OF AUTHORITIES HAVING JURISDICTION.

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THE CONTRACTOR SHALL VERIFY AND ACCEPT RESPONSIBILITY FOR ALL DIMENSIONS AND CONDITIONS ON SITE AND SHALL NOTIFY THE APPROPRIATE CONSULTANT OF ANY VARIATIONS FROM THE SUPPLIED INFORMATION.

CHARL TON AVE WEST

WEST

WARKLAND STREET

WORK

ST. JAMES PL

SEAL NORTH ARROW

N
PROJECT NORTH TRUE NO

Description

No. Date

PRE IMMARY FOR REVIEW AND BIT

No. Date Description

ISSUED:

DRAWN BY: Author REVIEWED BY: Checker

DATE: Issue Date SCALE: 1:100

PROJECT NO.: 23-310

SHEET TITLE
SITE PLAN AND STATISTICS

SHEET NUMBER: REVISION NO.



50 MARKLAND STREET 2-STOREY EXTENSION

50 MARKLAND ST, HAMILTON, ON, L8P 2J7

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NORTH ARROW


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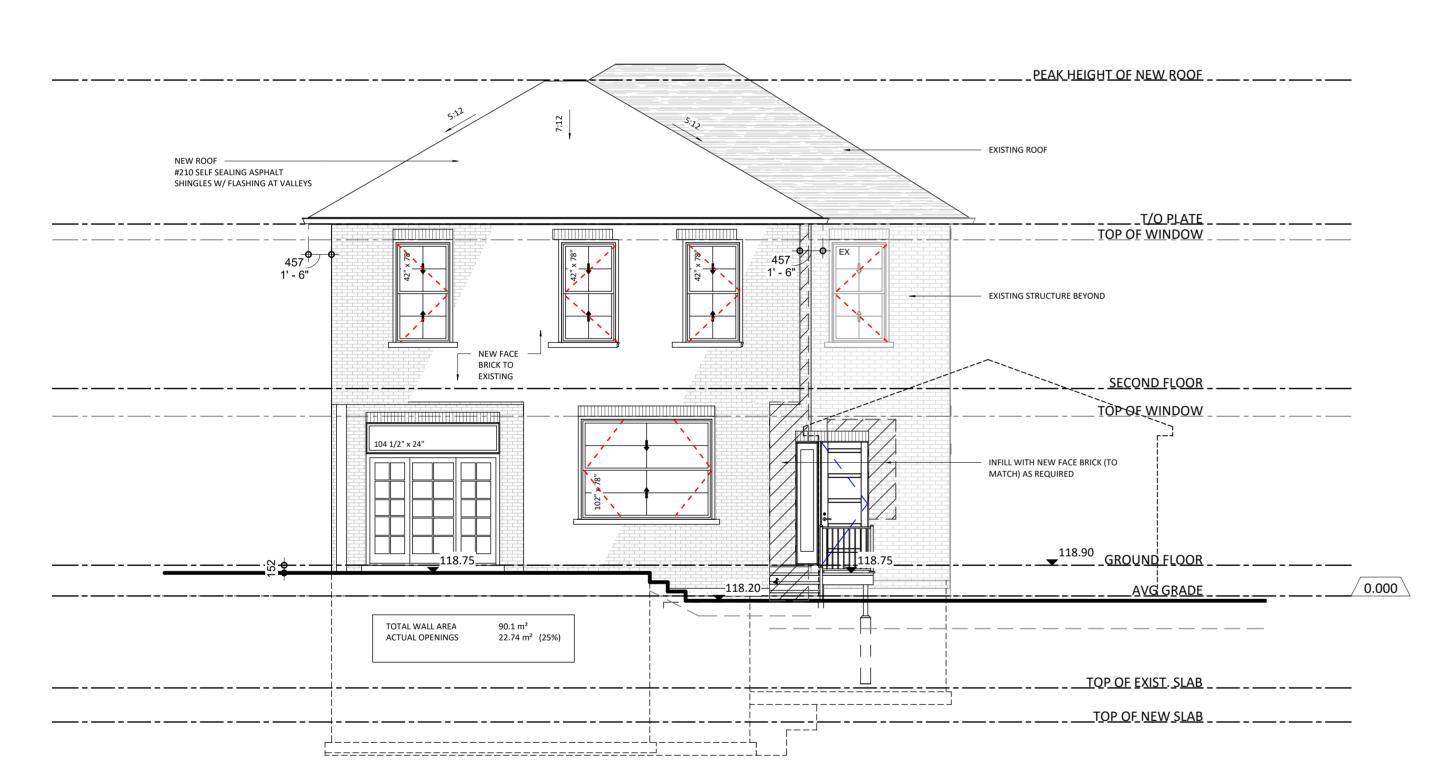
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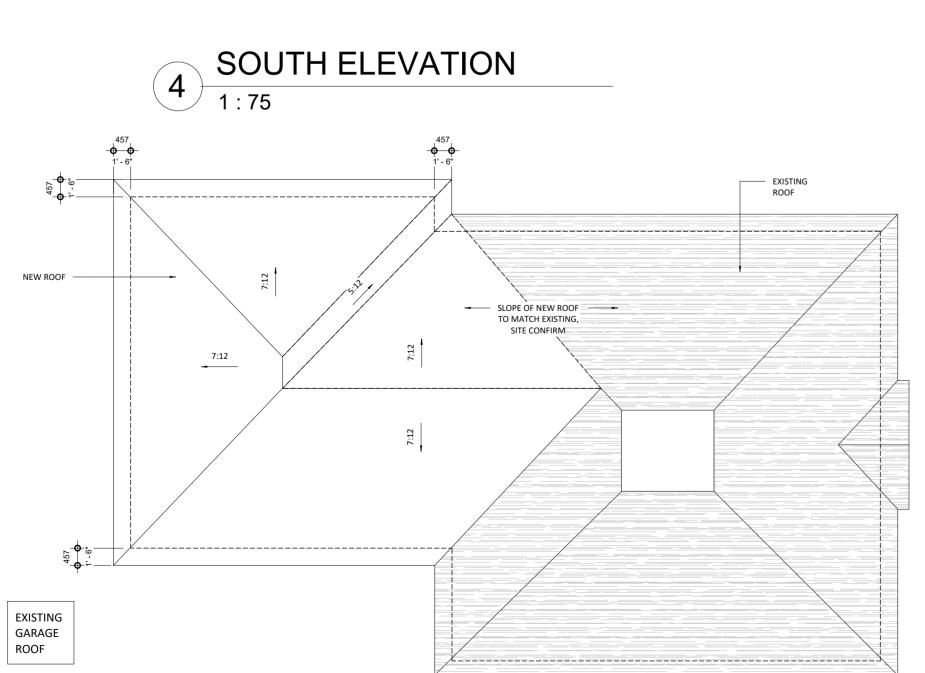
EXISTING - DEMOLITION PLANS

SHEET NUMBER: REVISION NO. A-101


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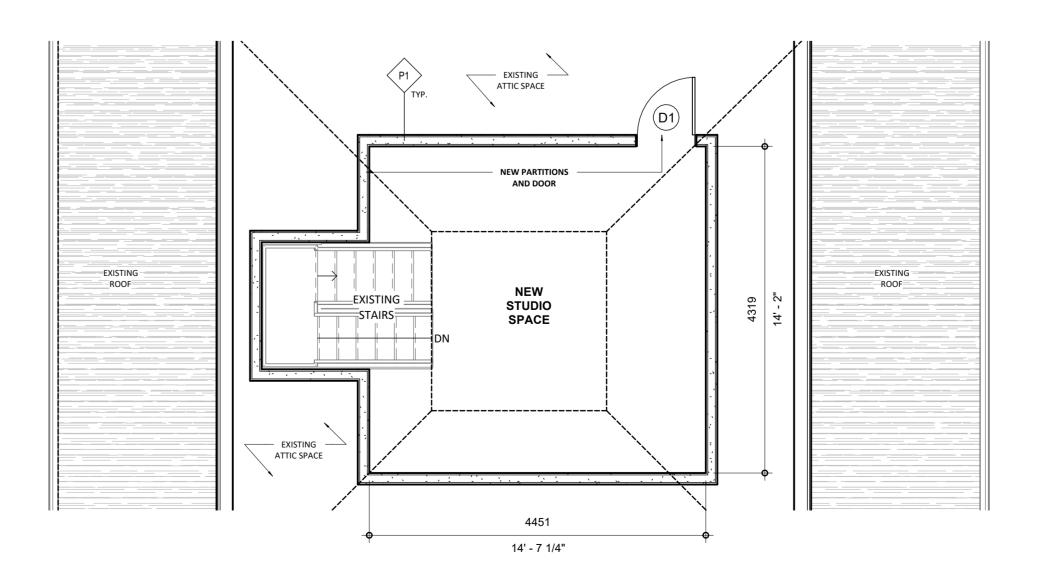




ROOF PLAN

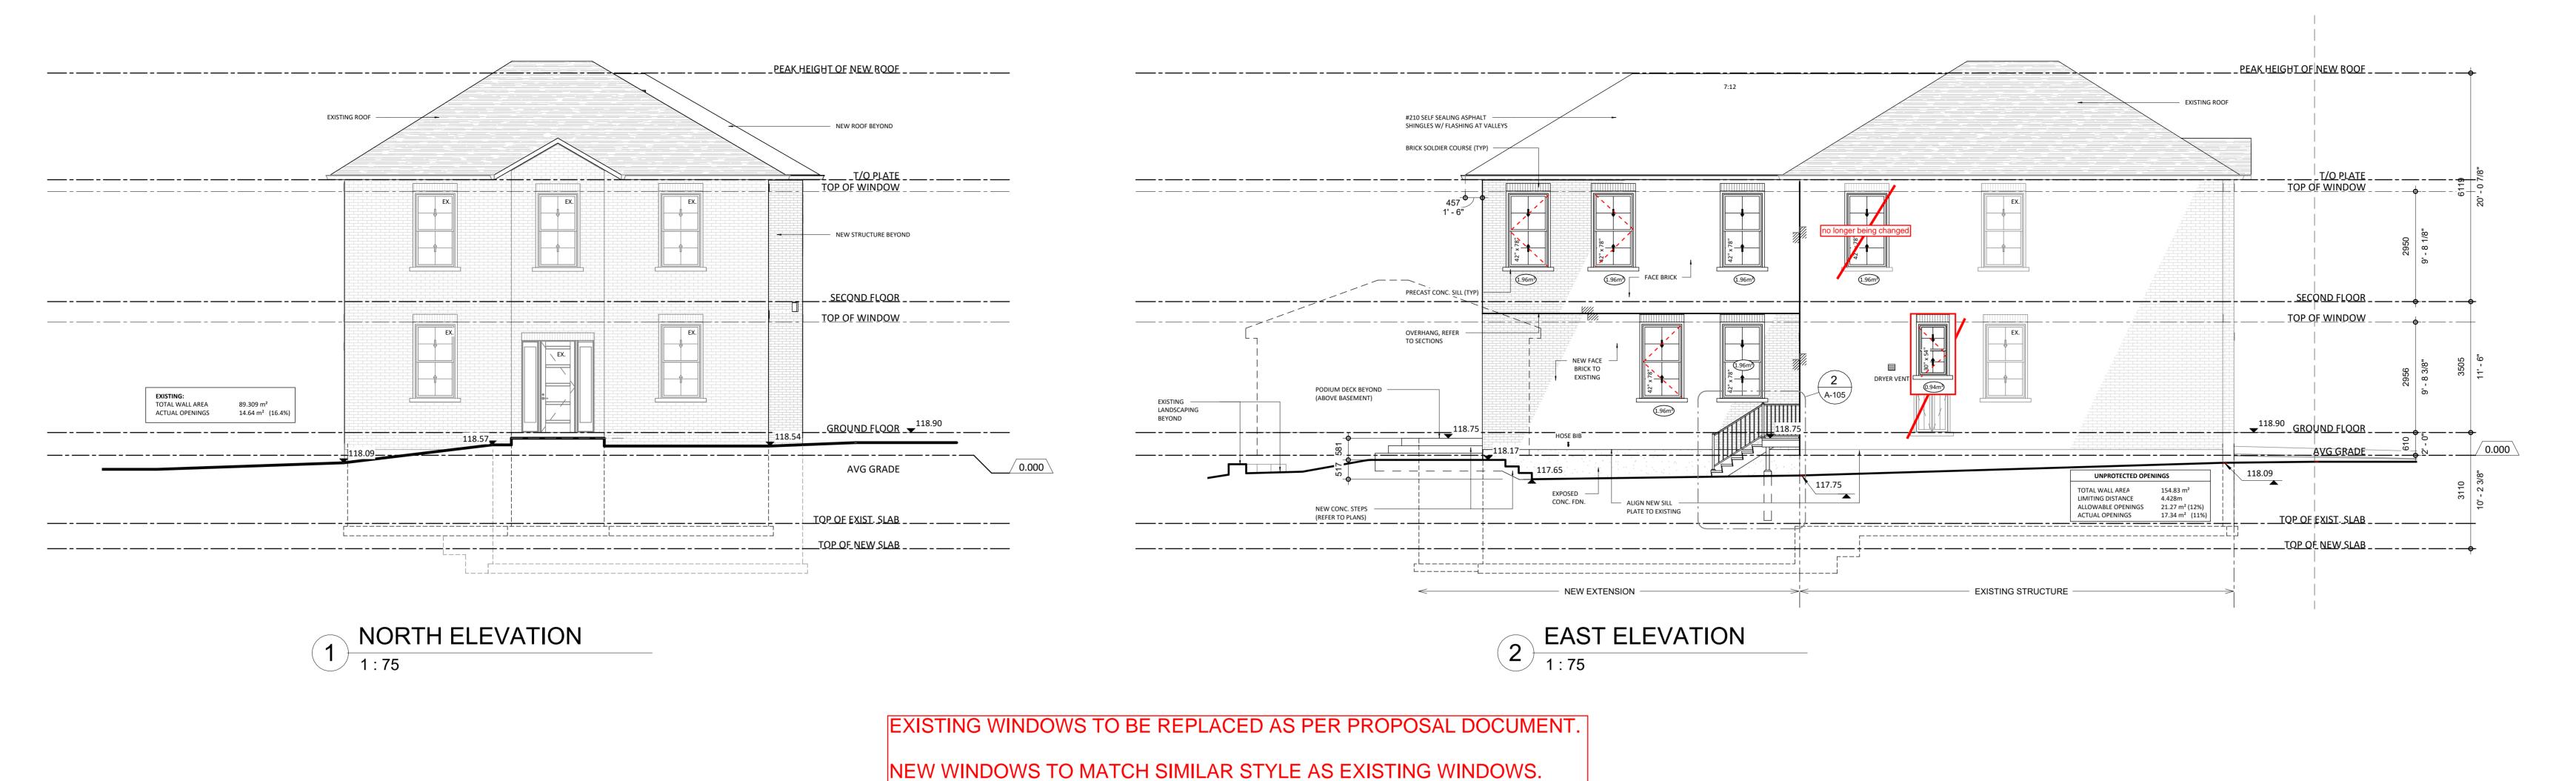



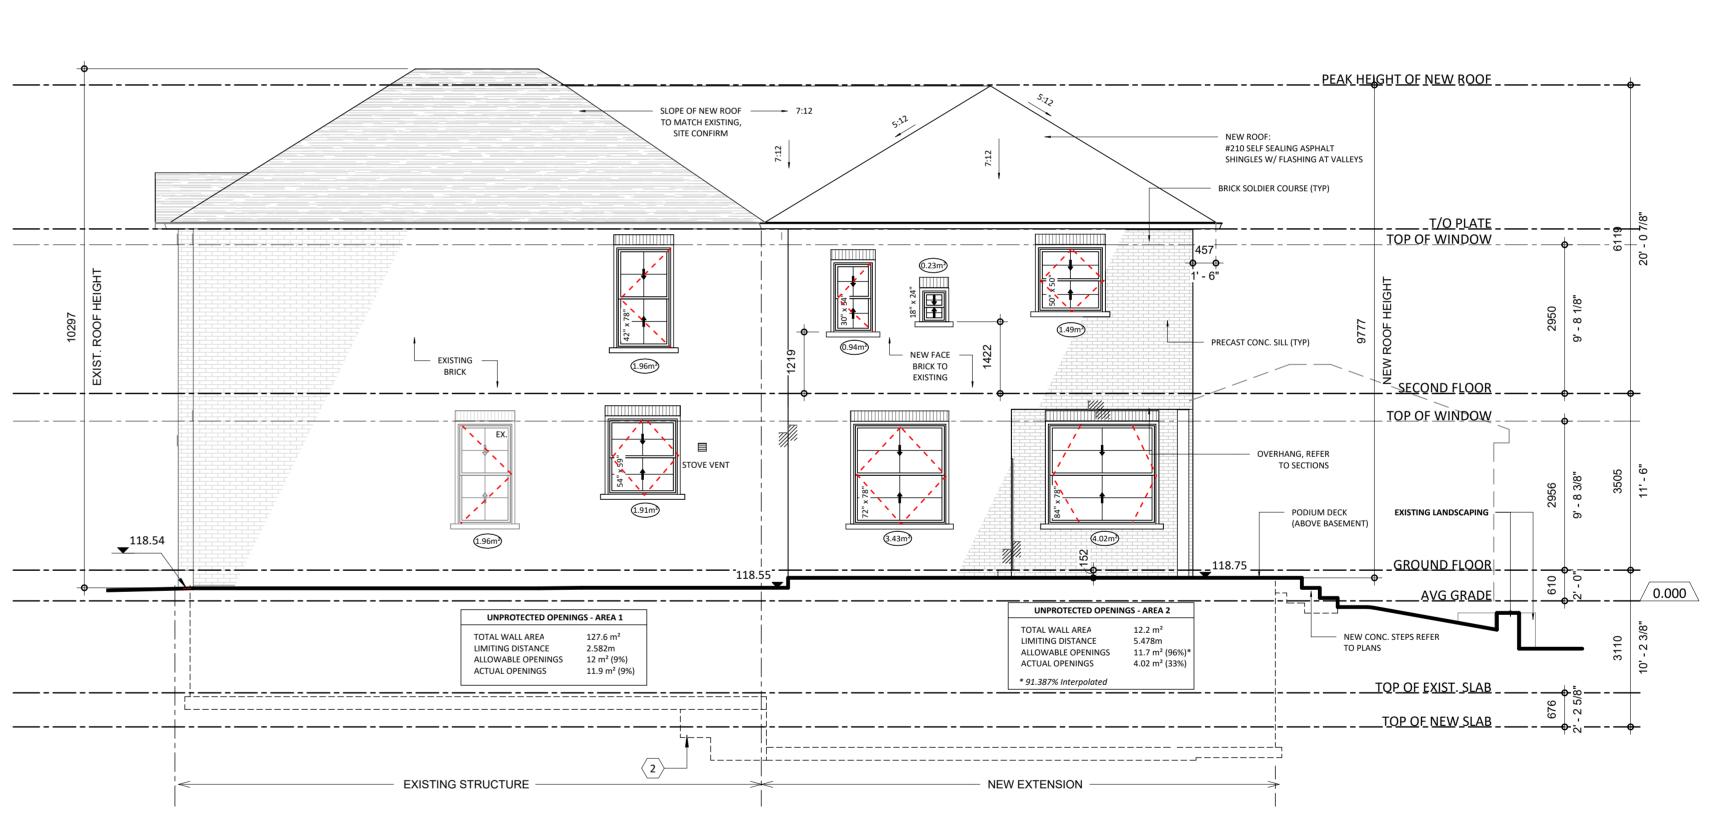

6 EXISTING ATTIC SPACE

PROJECT 50 MARKLAND STREET 2-STOREY EXTENSION

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NORTH ARROW REVISIONS

Description

No. Date

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ELEVATIONS & PLANS

REVISION NO. SHEET NUMBER: A-103

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