50 Markland St

RENOVATION PROPOSAL

Project Address: 50 Markland St. Hamilton, ON

Owner information: Eric and Sarah Desrosiers

Project Overview: Demolish the back portion of the existing home and rebuild with salvaged or like materials

(specified and outlined herein).

Attached

Appendix A – Photos of Existing [Attached Herein]

Appendix B – Architectural Drawings / Blueprints

INTRODUCTION

After years of searching and waiting, Sarah and I became the keepers of 50 Markland St., for years to come. After living in the Herkimer Apartments (looking into this very backyard every day) we were fortunate to make contact with Carl Turkstra, the previous owner of this home and a proud member of this community. Unfortunately, after 30 years of living there, he was no longer able to keep up with the maintenance of the home and it slowly fell into a weathered state. Sarah and I look forward to many years in this home, having just welcomed two children into this world since 2022, our vision is to raise our kids in this community and continue to thrive many years after.

Below, you will find our outlined proposal and vision to bring this home back into its glory and into a more liveable functional home so that it may remain our family home.

We look forward to discussions regarding our proposed renovations.

Scope of Work Breakdown

DEMOLITION

Our proposal includes the full demolition of the back portion of the home, as outlined and displayed in the attached drawings. This demolition will include the full demolition of the foundation, exterior walls and windows, and roof.

RECONSTRUCTION

The reconstruction will expand the back portion of the home using like materials (outlined throughout this document). The plans call to extend the home back 4' and increase the liveable space on both the main floor and second floor. Currently the back portion of the home is deteriorating due to previous neglect and was laid out in a manor that did not connect the liveable space to the back yard – as was common design in years past. We hope to rebuild the back portion in a manor to increase access to the rear yard and bring in more natural light to the liveable space. The reconstruction will utilize as many like or salvaged materials as possible.

BRICKS/MASONRY

During the demolition our best effort will be made to salvage some brick and material, though we are being advised by restoration masons and the engineer that not much brick will be kept. Currently we are allowing for all new brick. We have sourced a brick that is identical to the existing and perfectly matches the aged / imperfect brick from this old home. This brick was also utilized on our Garage renovation (Hertiage Permit: HP2023-018)



Withing the scope of the masonry brick work, we will be repointing all necessary areas, following the heritage standard.

WINDOWS

The front façade of the house will be under a separate heritage application.

For the remaining windows (all side windows and windows at back of building) we are proposing to install all new windows in a matching style. We are proposing to install windows with an identical mullion pattern and trim from the exterior.

We believe this maintains the heritage look of the home from all visible sightlines, while increasing functionality in our home. It is important for us to keep the same aesthetic, while equally important to be able to properly utilize these fixtures.

The non street facing windows we are proposing are Pella – Lifestyle windows (or similar). There of similar design and look, using wood construction, however they utilize some more modern technology and systems for modern day efficiency and functionality.




DOORS

The only door that will be visible from any sightline will be the front door (street facing). **The front door proposal shall be under a separate heritage permit.**

ROOF

The new roof on the proposed addition will be set at the same level as the existing roof (as displayed in the Drawings – Appendix). The roofing will be of the same material, and all trim and gutters will match in colour and style.

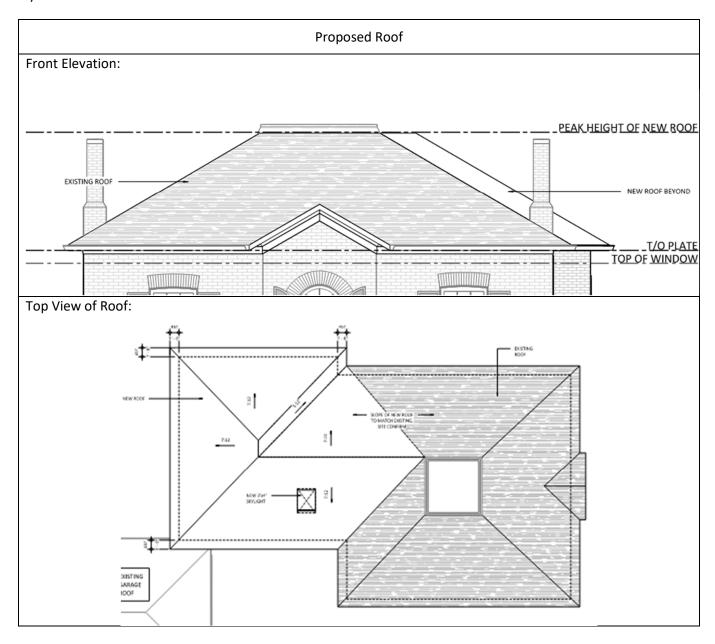

Existing and proposed materials will be the same – GAF Black Architectural Shingles.


The visible downspouts are not being changed and will remain as is. The new downspouts will be a perfect match of same material and colour (black aluminum downspouts and off-white gutters).

Appendix A – Photos







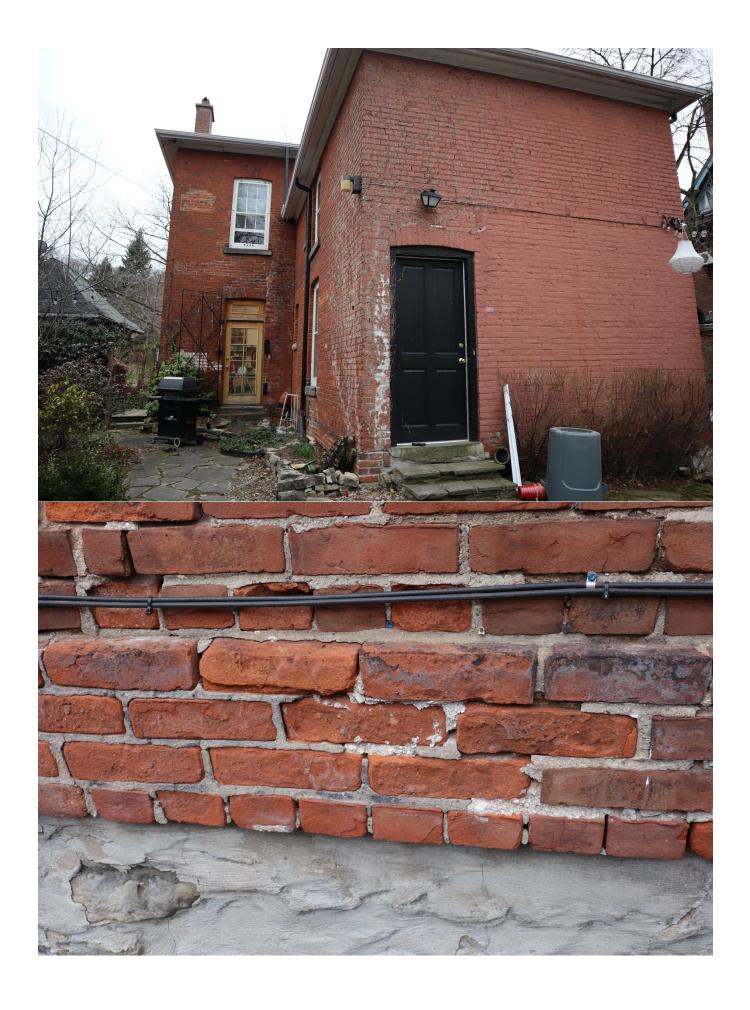



Appendix B - Drawings

Provided on Following pages.



GROSS FLOOR AREAS - 50 WARRLAND ST					2-STOREY EX
LEVEL	GFA - EXISTING TO REMAIN (SQM)	GFA - EXISTING TO BE DEMOLISHED (SQM)	GFA - NEW (SQM)	TOTAL (SQM)	50 MARKLAND ST, HAMIL
BASEMENT	70.13	35.61	84.14	118.66	
GROUND FLOOR	164.34	35.61	59.72	188.45	CLIENT
SECOND FLOOR	164.34	35.61	78.53	207.26	
ATTIC	24.81		0.00	24.81	VER
			TOTAL AREA	539.18	CONSTRUCTION
		тот	AL GFA ABOVE GRADE	420.53	VERLY CONSTRUCTION 1650 SISMET RD, MISSISSA
SITE ST	ATISTICS		DV I AW 05 000	DV I AW 0500	1000 GIGWIET ND, WIGGIGGA
	SQM	REQUIRED	BY-LAW 05-200	BY-LAW 6593	ARCHITECT
LOT AREA - EXISTING PER SURVEY	751.87	360 sqm	360.00	360.00	
BUILDING AREA PROPOSED (FOOTPRINT)	188.45				
EXISTING GARAGE (FOOTPRINT)	49.05				
ASPHALT DRIVEWAY AREA - EXISTING	99.466				architect
TOTAL LANDSCAPED AREA	414.89 sqm (55.18%)	30% min.	SECTION 15.1.2.1(h): 30%	NOT PROVIDED	143 Searle Ave, Toronto, ON t 647.898.5157 e pa-archit
					CONSULTANT
FRONT YARD	LANDSCAPING				
	SQM	REQUIRED (%)			Quinn Di
FRONT YARD AREA (FYA)	45.535				ASSOCI
ASPHALT DRIVEWAY AREA (WITHIN FRONT YARD)	9.093				CONSULTING STRUCTUR 890 Yonge St., Suite 300, Toronto, Ont
FRONT YARD LANDSCAPING (FYL)	36.442sqm (80.03%)	50.00%	SECTION 4.35(a): 50%	NOT PROVIDED	e: drawings@quinndressel.com
					THIS DRAWING IS NOT TO BE SCALED. REFER TO APPROPRIATE SURVEY, STRU
SETBACKS/ BUIL	DING DIMENSIONS				PROCEEDING WITH THE WORK.
	PROPOSED (m)	REQUIRED (m)			CONSTRUCTION MUST CONFORM TO AL REQUIREMENTS OF AUTHORITIES HAVIN
BUILDING HEIGHT LIMIT	9.78m New (10.3m existing)	10.50	10.5m	11m	THE CONTRACTOR WORKING FROM DR. MARKED "FOR CONSTRUCTION" MUST A RESPONSIBILITY AND BEAR COSTS FOR DAMAGES RESULTING FROM THEIR WOI
LOT WIDTH	18.54m - EXISTING	12.00	12m	12m	THIS DRAWING, AS AN INSTRUMENT OF AND IS THE PROPERTY OF THE ARCHITE
					THE CONTRACTOR SHALL VERIFY AND A FOR ALL DIMENSIONS AND CONDITIONS THE APPROPRIATE CONSULTANT OF AN
SETBACKS	PROPOSED (m)	REQUIRED (m)			SUPPLIED INFORMATION.
FRONT YARD SETBACK	2.4 to 2.5m - EXISTING	4m MIN	4m MIN	6m MIN.	KEY PLAN
SIDE YARD SETBACK	2.3 to 4.86m - EXISTING	1.2m MIN.	1.2m MIN.	1.2m MIN.	
REAR YARD SETBACK		7.5m MIN.	7.5m MIN.	7.5m MIN.	CHA)

GROSS FLOOR AREAS - 50 MARKLAND ST

PROJECT 50 MARKLAND STREET 2-STOREY EXTENSION

50 MARKLAND ST, HAMILTON, ON, L8P 2J7

VERLY CONSTRUCTION GROUP VERLY CONSTRUCTION GROUP INC.

1650 SISMET RD, MISSISSAUGA, ON L4W 1R4 ARCHITECT

architects inc. 143 Searle Ave, Toronto, ON, M3H 4B2, Canada t 647.898.5157 **e** pa-architects@outlook.com


CONSULTANT

Quinn Dressel ASSOCIATES CONSULTING STRUCTURAL ENGINEERS 890 Yonge St., Suite 300, Toronto, Ontario, Canada M4W 3P4 t: 416.961.8294 f: 416.961.7434 e: drawings@quinndressel.com www.quinndressel.com

REFER TO APPROPRIATE SURVEY, STRUCTURAL, MECHANICAL, ELECTRICAL, LANDSCAPE, ETC. CONSULTANT DRAWINGS BEFORE PROCEEDING WITH THE WORK.

CONSTRUCTION MUST CONFORM TO ALL APPLICABLE CODES AND REQUIREMENTS OF AUTHORITIES HAVING JURISDICTION. THE CONTRACTOR WORKING FROM DRAWINGS NOT SPECIFICALLY MARKED "FOR CONSTRUCTION" MUST ASSUME FULL RESPONSIBILITY AND BEAR COSTS FOR ANY CORRECTIONS OR DAMAGES RESULTING FROM THEIR WORK. THIS DRAWING, AS AN INSTRUMENT OF SERVICE IS PROVIDED BY AND IS THE PROPERTY OF THE ARCHITECT. THE CONTRACTOR SHALL VERIFY AND ACCEPT RESPONSIBILITY FOR ALL DIMENSIONS AND CONDITIONS ON SITE AND SHALL NOTIFY THE APPROPRIATE CONSULTANT OF ANY VARIATIONS FROM THE SUPPLIED INFORMATION. KEY PLAN

ARCHITECT'S SEAL **ENGINEER'S SEAL**

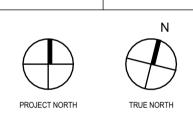


REVISIONS No. Date

ISSUED: DRAWN BY: Author REVIEWED BY: Checker SCALE: 1:100

SITE PLAN AND STATISTICS

SHEET NUMBER: REVISION NO. A-001

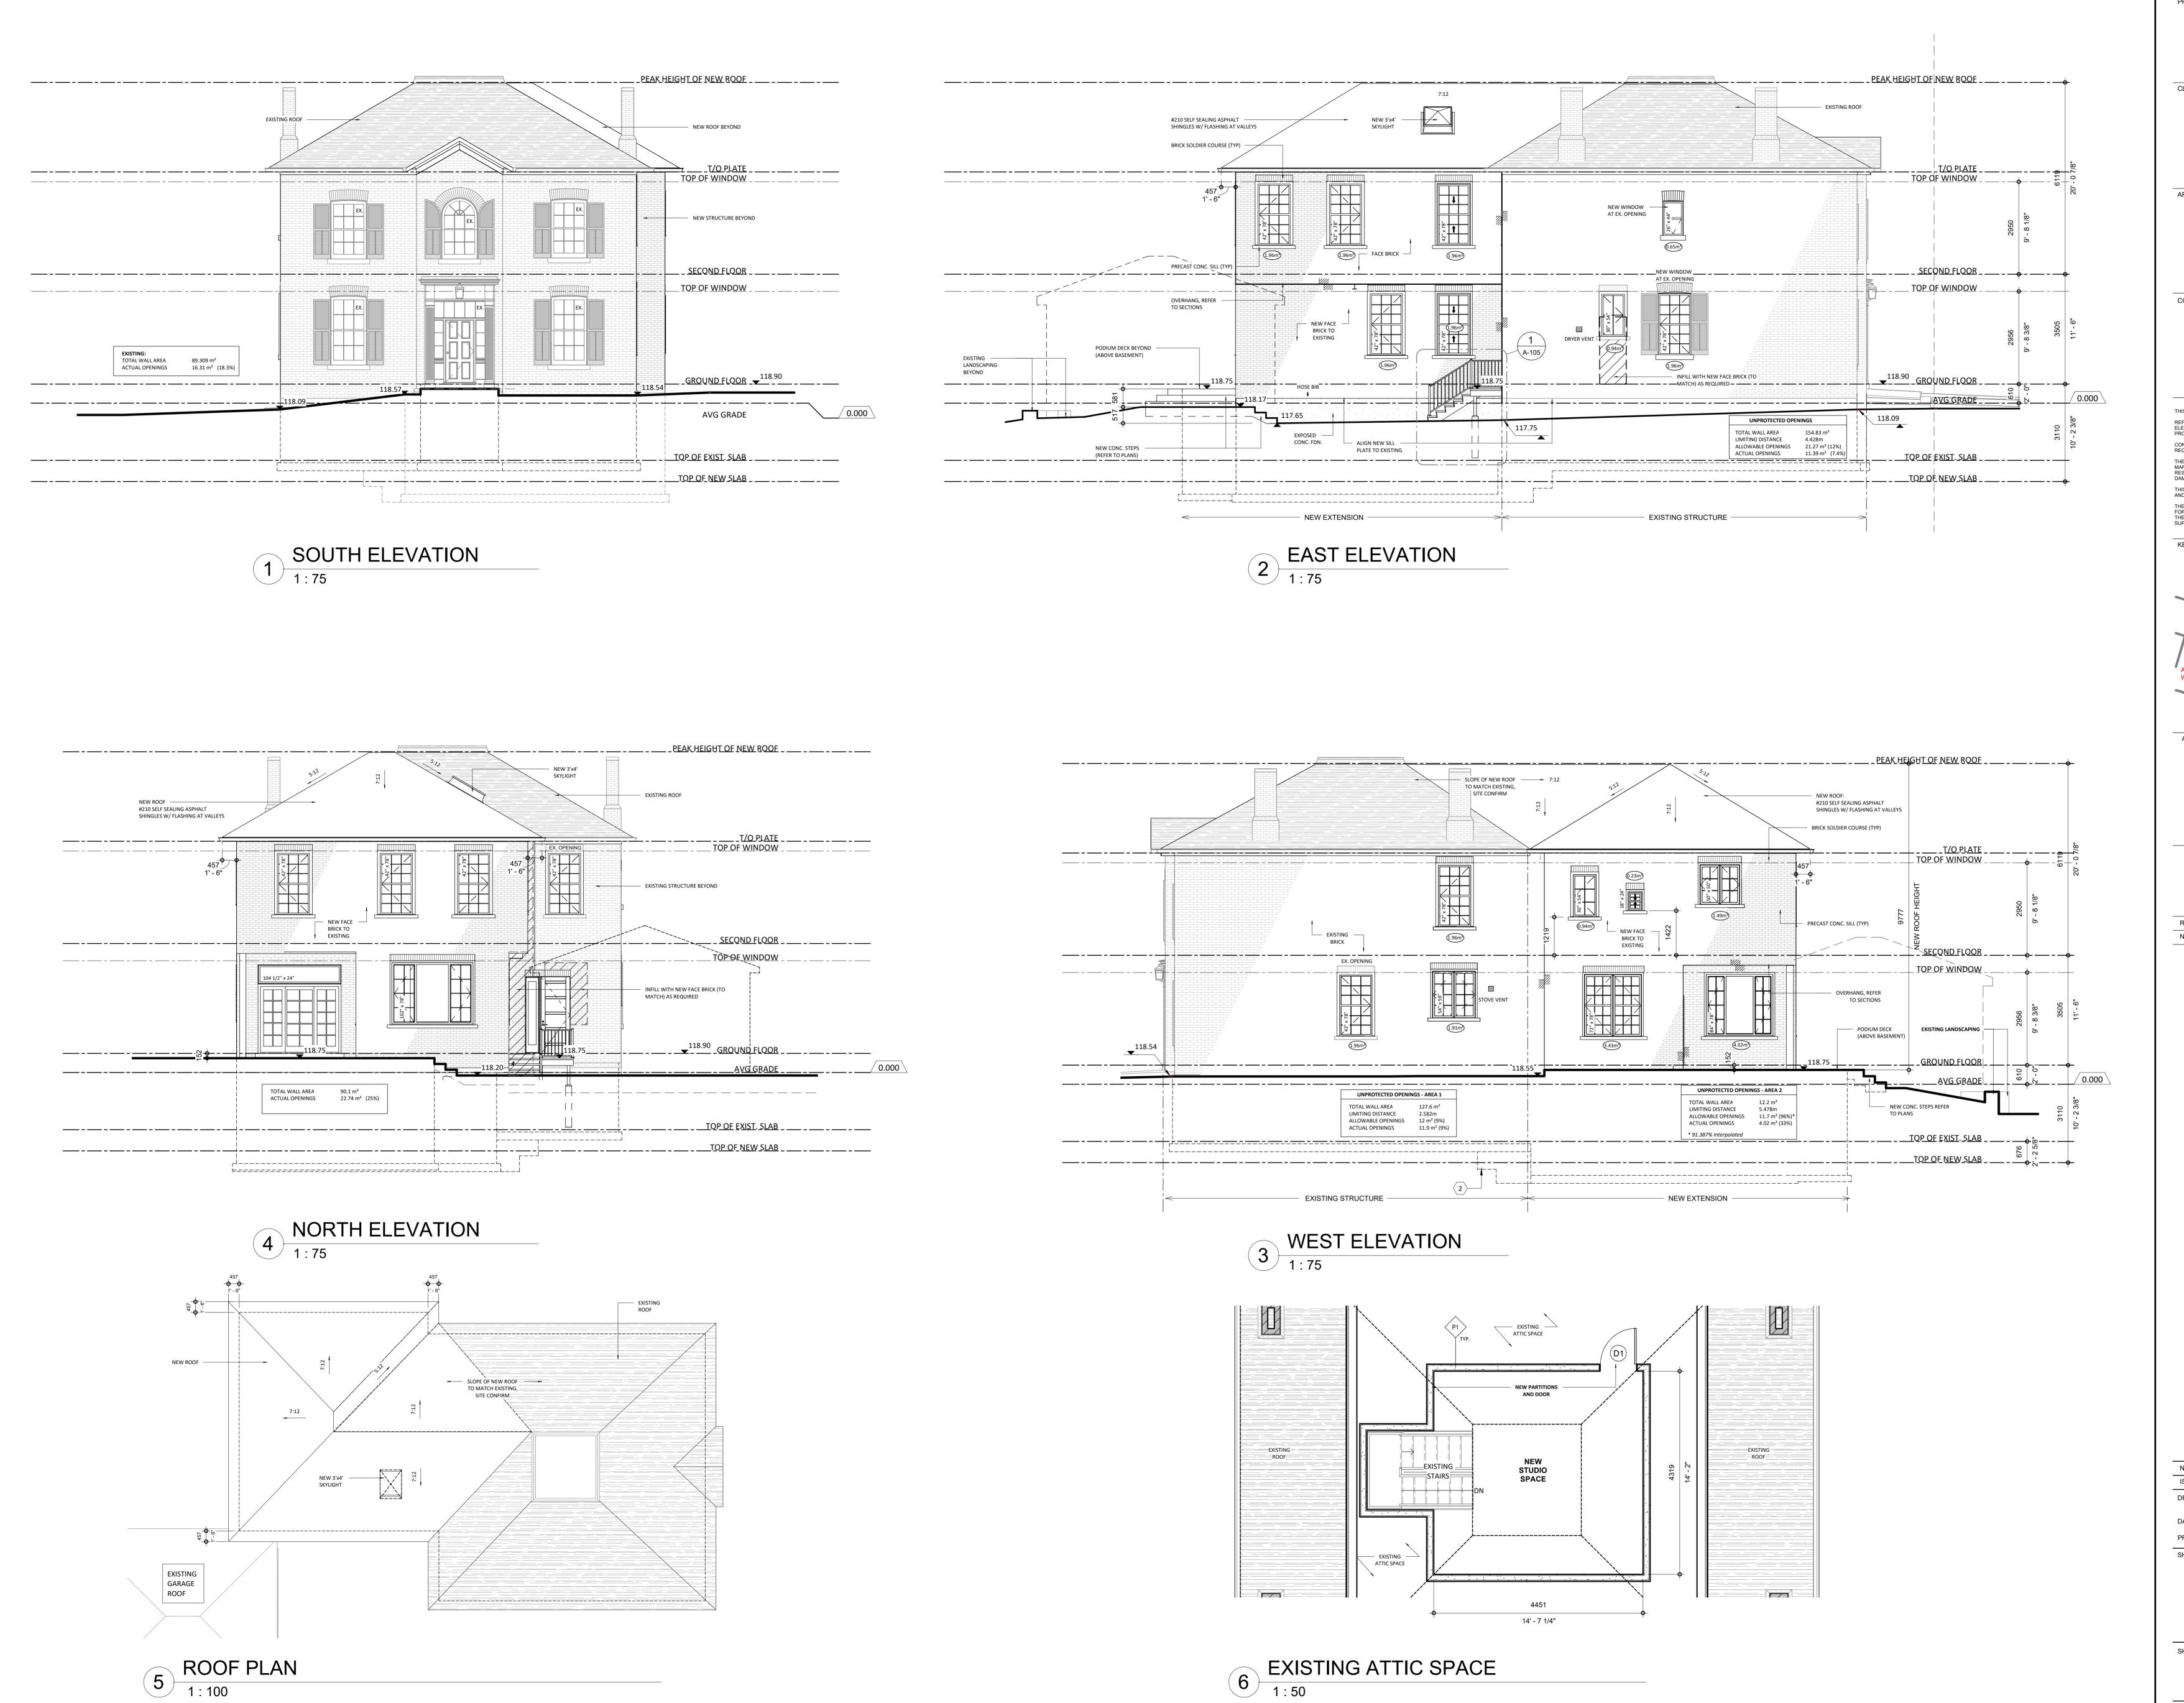

PROJECT 50 MARKLAND STREET 2-STOREY EXTENSION

50 MARKLAND ST, HAMILTON, ON, L8P 2J7

VERLY CONSTRUCTION GROUP INC. 1650 SISMET RD, MISSISSAUGA, ON L4W 1R4 ARCHITECT

143 Searle Ave, Toronto, ON, M3H 4B2, Canada t 647.898.5157 e pa-architects@outlook.com

CONSULTANT


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ARCHITECT'S SEAL



REVISIONS No. Date

No. Date ISSUED: REVIEWED BY: Checker DRAWN BY: Author 23-310

ELEVATIONS & PLANS

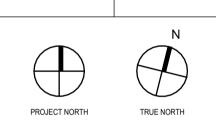REVISION NO. SHEET NUMBER: A-103

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