A. GENERAL NOTES

1. GENERAL INFORMATION

- 1.1. THE INFORMATION PRESENTED ON THESE DRAWINGS HAVE BEEN DESIGNED IN ACCORDANCE WITH THE ONTARIO BUILDING CODE 2024. CONSTRUCTION IS TO BE PERFORMED IN ACCORDANCE WITH THIS AND ALL OTHER APPLICABLE CODES AND STANDARDS NOTED HERIN. REFER TO SPECIFICATIONS FOR ALL OTHER APPLICABLE STANDARDS.
- 1.2. THE MATERIALS LISTED HEREIN APPLY TO THIS PROJECT, UNLESS NOTED OTHERWISE OR ON SPECIFICATIONS.
- 1.3. THESE DRAWINGS ARE FOR THE USE OF THE CLIENT ONLY. THE CONSULTANT DOES NOT GUARANTEE THAT THE DRAWINGS ARE ERROR-FREE, COMPLETE, OR FIT FOR ANY OTHER PURPOSE. THE INFORMATION SHOWN ON THE DRAWINGS STRICTLY APPLY TO THIS PROJECT ONLY. DECISIONS OR ACTIONS MADE BY THIRD PARTIES BASED ON THESE DRAWINGS IS THE SOLE RESPONSIBILITY OF SUCH PARTIES.
- 1.4. THESE DRAWINGS SHOW THE COMPLETED STRUCTURE. THE CONTRACTOR SHALL HAVE THE SOLE RESPONSIBILITY FOR THE DESIGN, ERECTION, OPERATION, MAINTENANCE, AND REMOVAL OF TEMPORARY SUPPORTS, STRUCTURES, AND FACILITIES, AND THE DESIGN AND EXECUTION OF CONSTRUCTION METHODS REQUIRED IN THEIR USE.
- 1.5. THE USE OF THESE DRAWINGS SHALL BE STRICTLY LIMITED TO THE INSTRUCTIONS IN THE REVISION BLOCK. BUILDING FROM THESE DRAWINGS SHALL PROCEED ONLY WHEN "ISSUED FOR CONSTRUCTION"
- 1.6. CONSTRUCTION TO BE IN CONFORMANCE WITH DETAILS IDENTIFIED AS BEING "TYPICAL", UNLESS NOTED OTHERWISE.

2. SITE CONDITIONS

- 2.1. THE SCOPE OF THE WORK DEPENDS ON THE SITE CONDITIONS. NOTIFY THE CONSULTANT WHERE ON-SITE CONDITIONS MAY REQUIRE MODIFICATIONS TO THE CONTRACT DOCUMENTS.
- 2.2. PROTECT ALL ADJACENT BUILDING MATERIALS INCLUDING WINDOWS, DOORS, FIXTURES, SIGNAGE, PLAQUES, LANDSCAPING AND SODDING IN AND ADJACENT TO THE WORK FOR THE DURATION OF THE WORK. MAKE GOOD AND RESTORE ALL DAMAGED AREAS TO MATCH EXISTING.
- 2.3. NOTIFY CONSULTANT AND OWNER OF ANY EXISTING CONDITIONS OR MATERIALS THAT MAY BECOME DAMAGED OR DISTURBED AS A RESULT OF THE WORK.
- 2.4. ALL FINAL COLOURS TO BE CONFIRMED BY OWNER PRIOR TO ORDERING MATERIAL.

3. <u>DIMENSIONS</u>

- 3.1. DO NOT SCALE DRAWINGS. CHECK ALL DIMENSIONS ON THE DRAWINGS WITH THE SITE CONDITIONS. REPORT ANY INCONSISTENCIES BEFORE PROCEEDING WITH THE WORK.
- 3.2. ALL DIMENSIONS ARE IN MILLIMETERS, UNLESS OTHERWISE NOTED.
- 3.3. BEFORE SUBMITTING BID FOR THE WORK, THE CONTRACTOR SHALL FIELD VERIFY ALL DIMENSIONS, ELEVATIONS AND LOCATION OF EXISTING STRUCTURES.

4. FIELD REVIEW

- 4.1. THE CONSULTANT WILL CONDUCT PERIODIC INSPECTIONS AND PROVIDE CONSTRUCTION REVIEW REPORTS (CRR), OUTLINING PROGRESS OF WORK, AND STATING WHETHER OR NOT WORK CONFORMS TO THE CONTRACT DOCUMENTS.
- 4.2. CRR'S, WILL OUTLINE ANY DEFICIENCIES FOUND.
- 4.3. MATERIALS AND WORKMANSHIP NOT CONFORMING TO THE SPECIFICATIONS SHALL BE REJECTED.
- 4.4. NOTIFY CONSULTANT FOR REVIEW OF <u>ALL</u> RAKED OUT OR BACKPOINTED MORTAR JOINTS <u>PRIOR</u>
 <u>TO PLACEMENT OF NEW MORTAR</u>. CONSULTANT WILL REVIEW AND APPROVE FOR PLACEMENT OF
 MORTAR. PLACEMENT OF MORTAR PRIOR TO RECEIPT OF CONSULTANT ACCEPTANCE WILL BE
 CAUSE FOR REJECTION OF THE AFFECTED PART OF THE WORK.

5. MASONRY

- 5.1. DO NOT USE MASONRY CEMENT. USE PORTLAND CEMENT AND LIME ONLY.
- 5.2. INCLUDE FOR THE REMOVAL OF CAULKING, METAL NAILS OR PINS THAT MAY BE PRESENT IN THE JOINTS TO BE RAKED OUT.
- 5.3. COMPLETE A MIN. 300mm x 300mm MOCK-UP EACH OF:
 - 5.3.1. RAKING OUT AND JOINT PREPARATION
 - 5.3.2. BACKPOINTING
 - 5.3.3. FINISHPOINTING, INCLUDING MORTAR COLOUR
 - 5.3.4. BRICK REPLACEMENT / REBUILD
- 5.4. MORTAR COLOUR TO BE APPROVED BY CONSULTANT AND OWNER PRIOR TO PLACEMENT BEYOND MOCK-UP AREA.
- 5.5. ALL MORTAR JOINTS TO BE INSPECTED AND APPROVED BY CONSULTANT PRIOR TO POINTING. ANY MORTAR PLACED INTO JOINTS PRIOR TO RECEIPT OF CONSULTANT APPROVAL IS TO BE REMOVED AND REINSTALLED AT THE CONTRACTOR'S OWN EXPENSE.
- 5.6. REFER TO TYPICAL DETAILS FOR RAKING OUT AND REPOINTING OF MORTAR JOINTS.

ANCHORAGE

6.1. INSTALLATION OF ALL POST-INSTALLED ANCHORS TO BE IN CONFORMANCE WITH MANUFACTURER'S DIRECTIONS, INCLUDING BUT NOT LIMITED TO: DRILL BIT SIZE AND TYPE, HOLE CLEANING, TEMPERATURE, CURING, AND TORQUE.

B. MATERIAL AND DESIGN DATA

UNLESS NOTED OTHERWISE ON DRAWINGS OR ON SPECIFICATIONS, THE MATERIALS LISTED BELOW APPLY TO THIS PROJECT AND THE DESIGN AND CONSTRUCTION SHALL COMPLY WITH THE FOLLOWING CODES AND STANDARDS. ALL STANDARDS TO LATEST EDITION, UNLESS NOTED.


REFER TO SPECIFICATIONS FOR ALL OTHER APPLICABLE STANDARDS.

1. MASONRY DESIGN AND CONSTRUCTION: CSA S304-14 (R2019) & CAN/CSA-A371-14 (R2024)


	MASONRY ELEMENT TYPE	DESIGN DATA	STANDARD
Α	REPLACEMENT BRICK:	'SOFT' BRICK, COLOUR TO MATCH EXISTING	CSA-A82:14 (R2023)
		COMPRESSIVE STRENGTH: 20 TO 35MPa 24-HOUR COLD WATER ABSORPTION: 12-18% ACCEPTABLE PRODUCT: IBSTOCK BRICK, WIENERBERGER BRICK, OR WATSONTOWN BRICK. PROVIDE SAMPLE TO CONFIRM COLOUR PRIOR TO ORDERINGALTERNATES ARE ACCEPTABLE TO THE APPROVAL OF CONSULTANT.	
В	MORTAR:	TYPE O ACCEPTABLE PRODUCT:	CAN/CSA-A179-14 (R2024)
		KING MASONCARE 300 OR KING MASONMIX ALTERNATES ARE ACCEPTABLE TO THE APPROVAL OF CONSULTANT AND OWNER.	
С	CONNECTORS FOR MASONRY:	STAINLESS STEEL (TYPE 304 OR 316)	CSA A370:14 (R2023)

C. CODES AND STANDARDS

- 1. CONFORM TO THE REQUIREMENTS OF THE ONTARIO BUILDING CODE 2024 AND THE OCCUPATIONAL HEALTH AND SAFETY ACT AND REGULATIONS FOR CONSTRUCTION PROJECTS (LATEST EDITION).
- 2. MASONRY DESIGN AND CONSTRUCTION: CSA S304-14 (R2019) AND CAN/CSA-A371-14 (R2024), RESPECTIVELY.

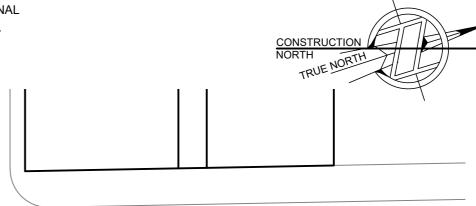

JAMES ST. S.

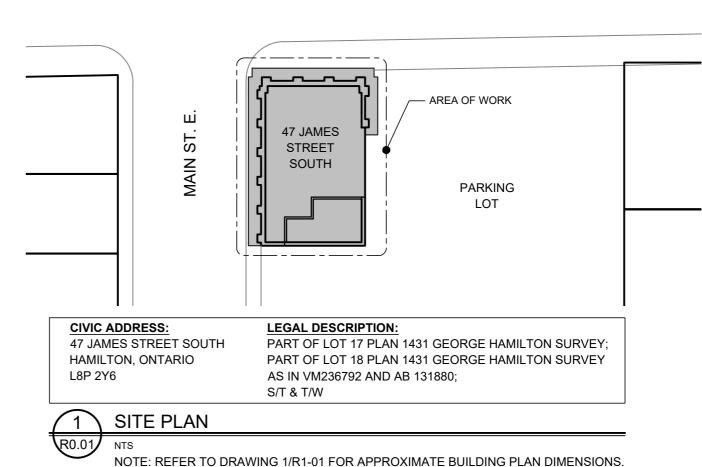

DRAWING LIST


S0.01 GENERAL NOTES AND SITE PLAN

\$1.01 EXISTING ROOF PLAN

S2.01 PARAPET WALL ELEVATIONS

\$3.01 TYPICAL DETAILS



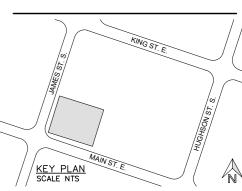



02	ISSUED FOR BUILDING PERMIT	2025-06-23	
01	ISSUED FOR PRICING	2025-06-23	
no.	description	date	
DDO IECT.			

BRICK
PARAPET REPAIRS

47 JAMES STREET S,
HAMILTON, ONTARIO

DRAWING:

GENERAL NOTES AND SITE PLAN

DESIGNED BY:

DRAWN BY:

CP

SCALE: DATE:


AS SHOWN 2025-05-08


PROJECT No.

25115

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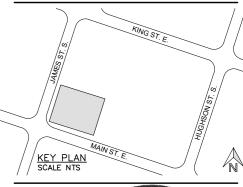
R0.01



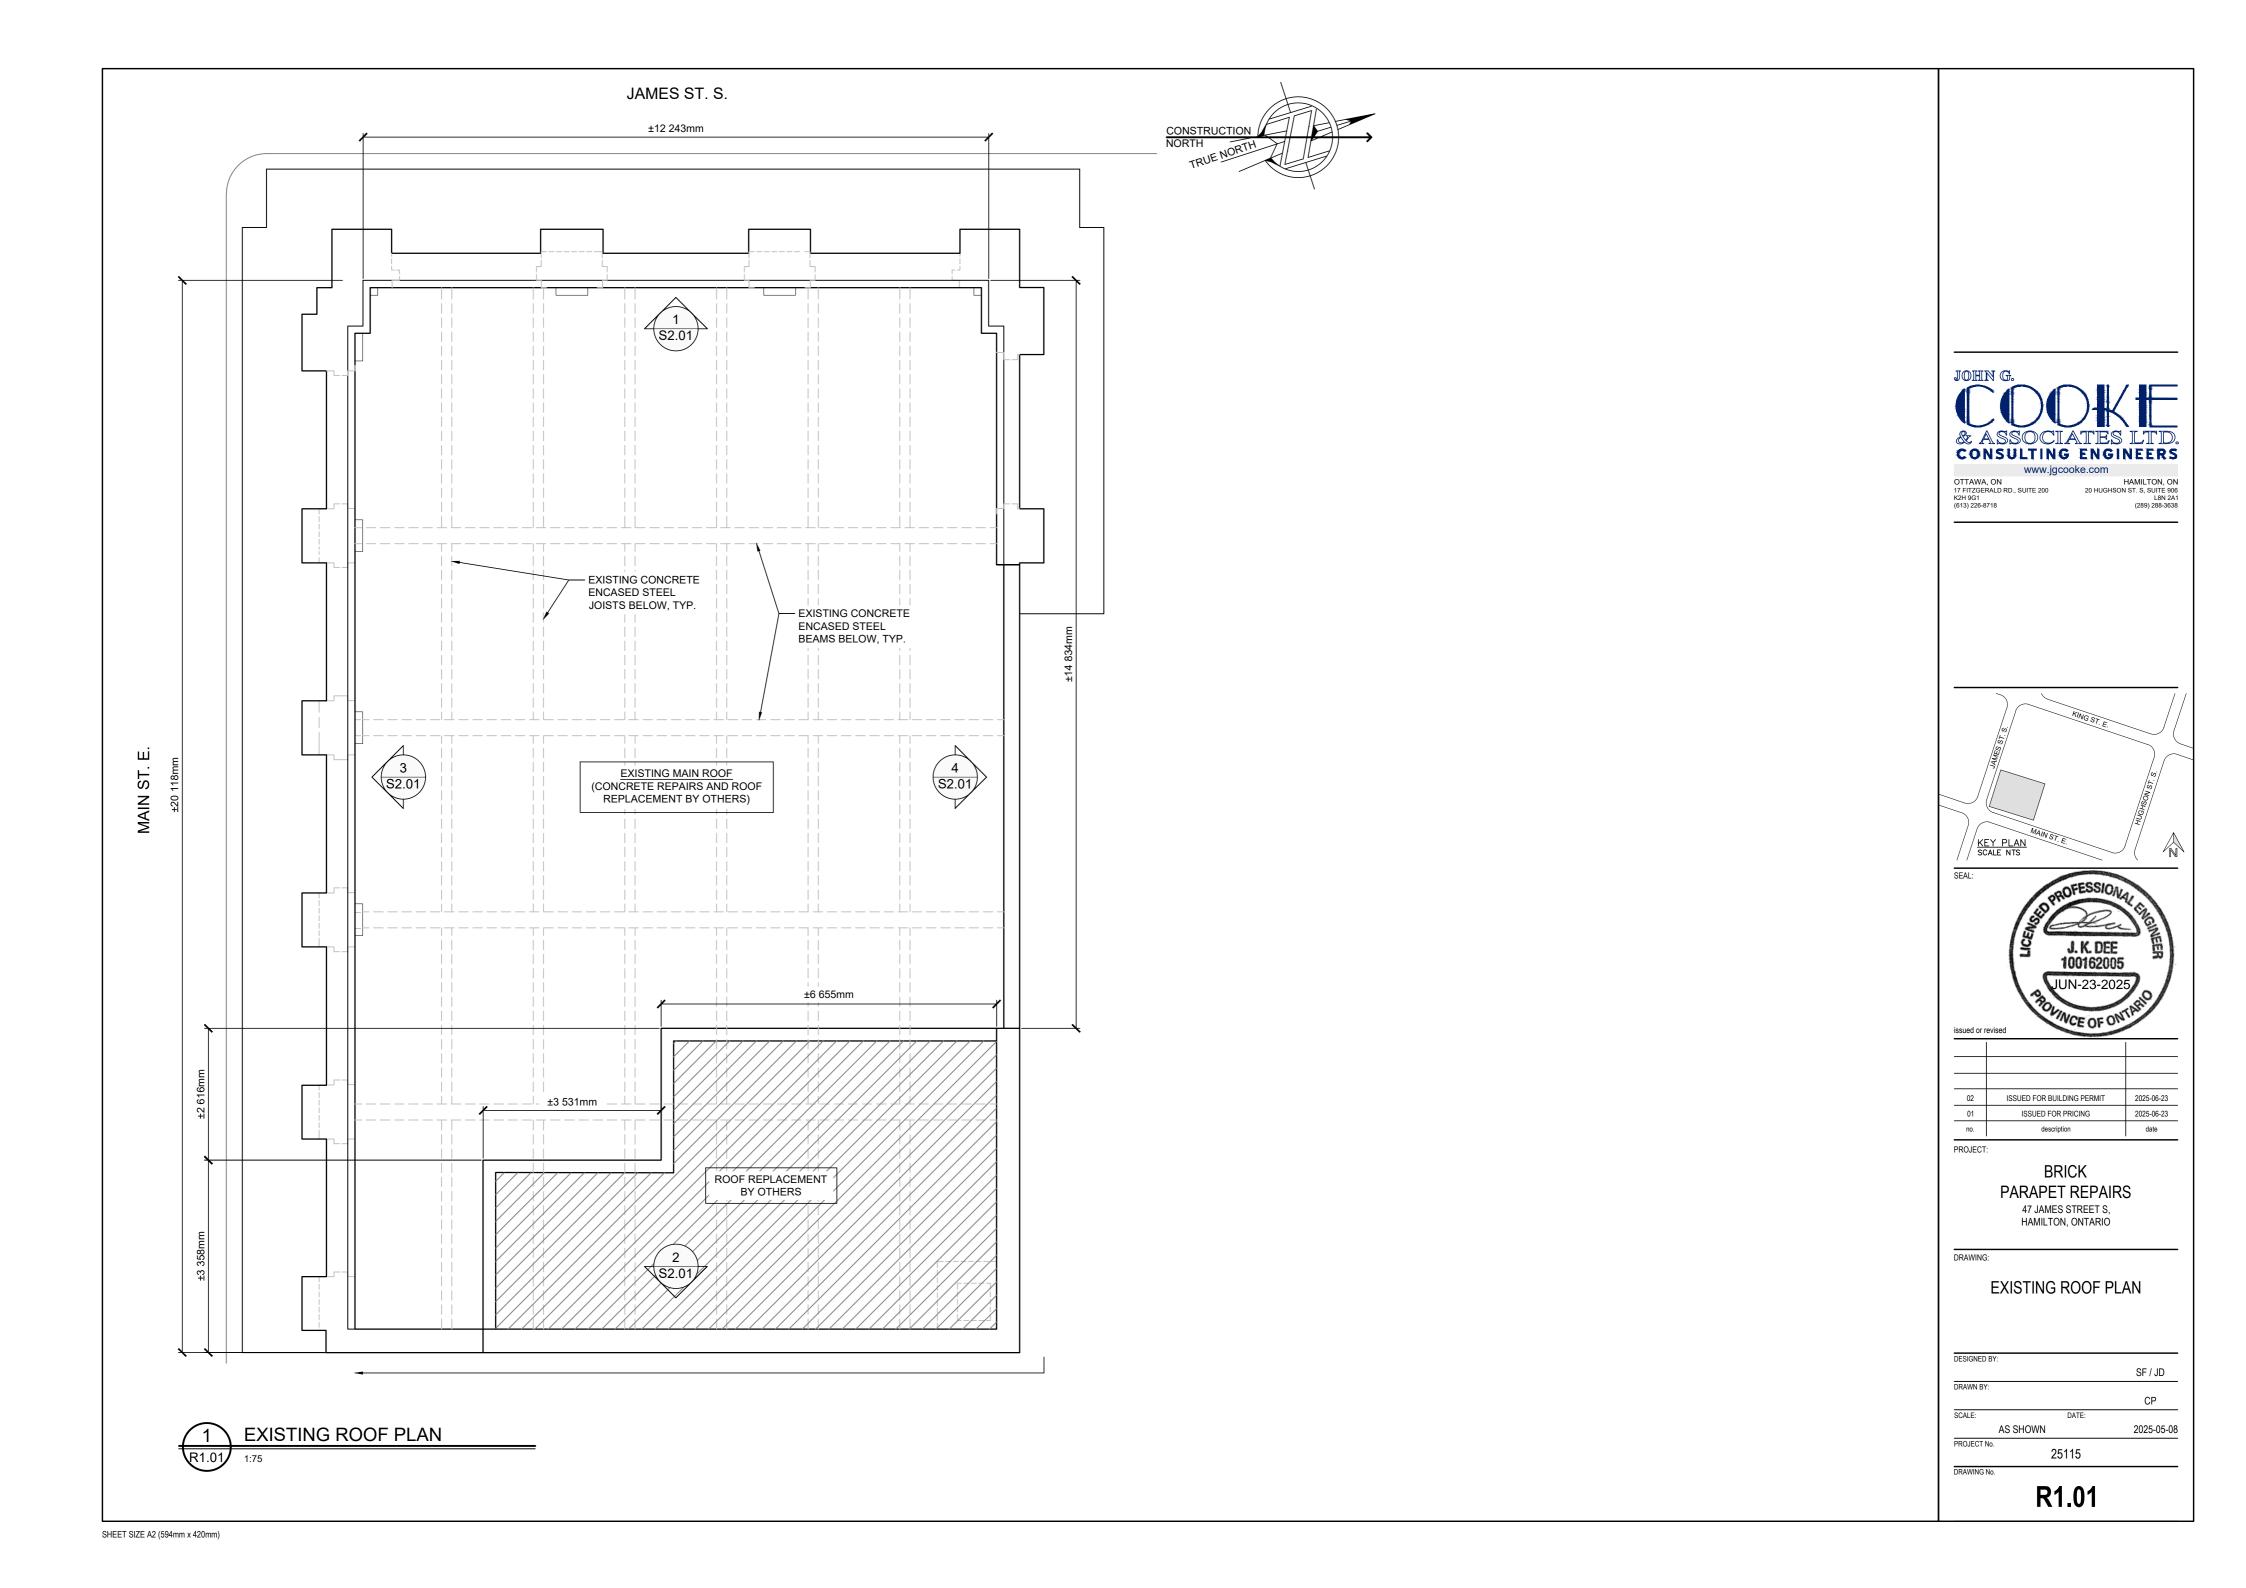

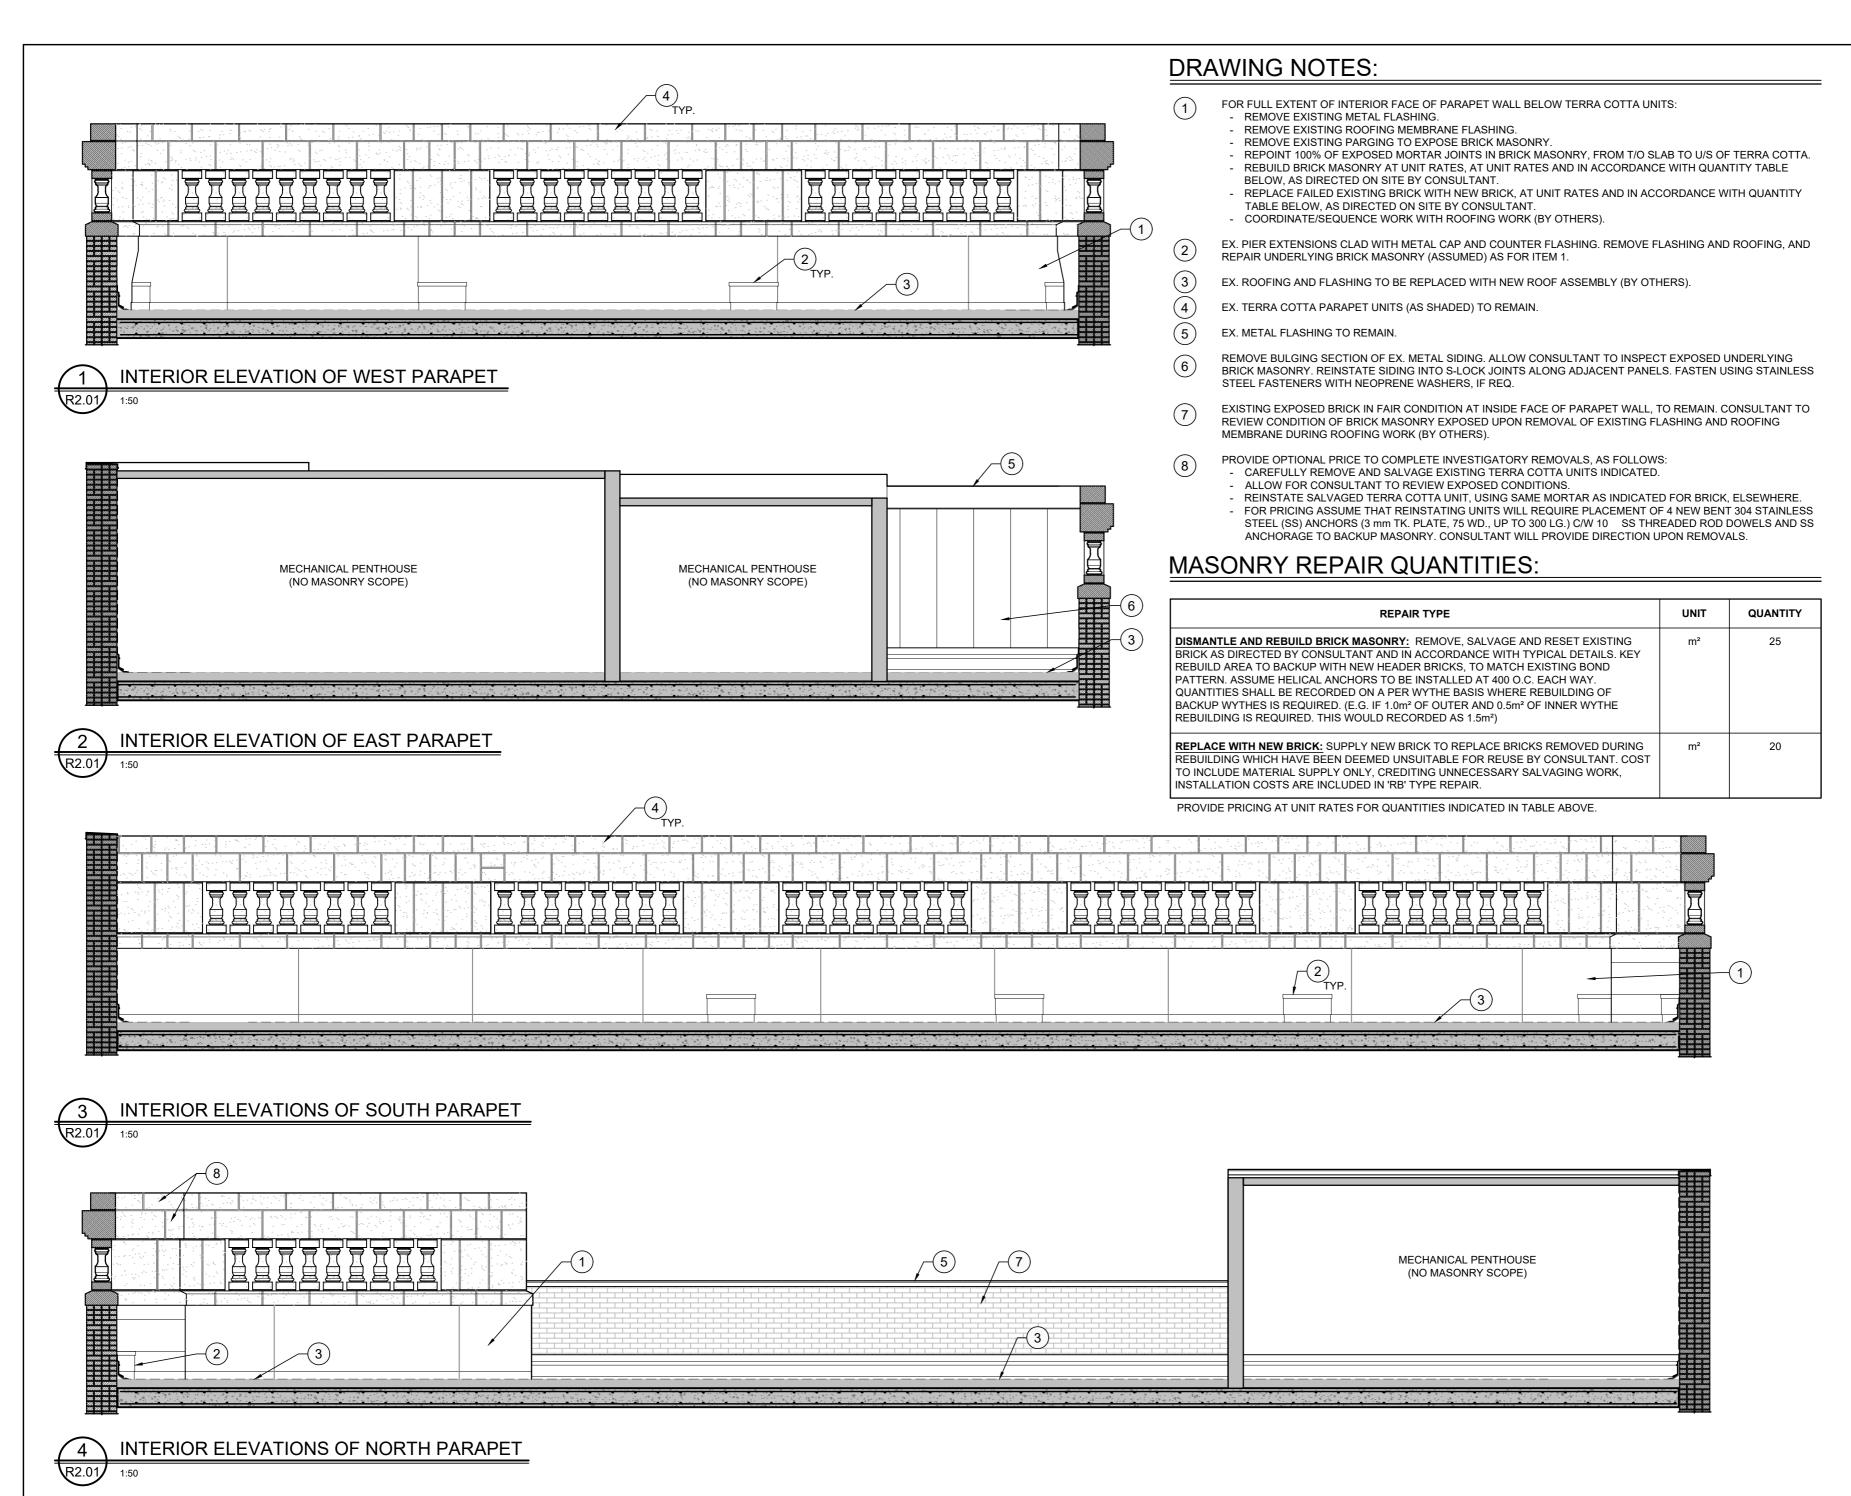

17 FITZGERALD RD., SUITE 200 20 HUGHSON ST. S, SUITE 200 K2H 9G1 L8N 2 (289) 288-36



SEAL:

J. K. DEE

100162005

JUN-23-2025

issued or revised

 02
 ISSUED FOR BUILDING PERMIT
 2025-06-23

 01
 ISSUED FOR PRICING
 2025-06-23

 no.
 description
 date

PROJECT:

BRICK
PARAPET REPAIRS

47 JAMES STREET S,
HAMILTON, ONTARIO

DRAWING:

PARAPET WALL ELEVATIONS

DESIGNED BY:

SF / JD

DRAWN BY:

CP

SCALE: DATE:


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DRAWING No.

R2.01



RAKING OUT PROCEDURE

- RAKE OUT EXISTING MORTAR SQUARE TO BRICK. REMOVE ALL OVERPOINTING FROM BRICK FACE.
- CLEAN OUT JOINT USING COMPRESSED AIR, OR WASH OUT JOINTS USING PRESSURIZED WATER, PRIOR TO REPOINTING.
- REMOVE ALL RESIDUE FROM BRICK FACE TO ALLOW NEW MORTAR TO BOND TO BRICK

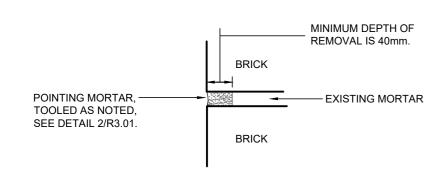
- DO NOT CHIP OR OTHERWISE DAMAGE EDGE OF BRICK DURING REMOVALS
- GRINDERS OR SAW BLADES MUST NOT TOUCH BRICK FACE. CUT CENTRE OF JOINT CAREFULLY, WITHOUT MARKING BRICK. REMOVE REMAINDER OF MORTAR USING HAND TOOLS. MECHANICAL TOOLS ONLY TO BE USED WHEN APPROVED TO MAKE RELIEF CUTS IN THE CENTRE OF JOINTS.
- ALL CRACKED MORTAR, MORTAR DEBONDED FROM BRICK, OR DETERIORATED MORTAR, MUST BE REMOVED FROM JOINT PRIOR TO REPOINTING.
- INTENT IS TO REMOVE ALL PORTLAND CEMENT BASED MORTARS FROM JOINTS.
- REFER TO SCOPE OF WORK, DEFINED ELSEWHERE, FOR PROJECT REQUIREMENTS.
- REMOVE ALL CAULKING, WHERE PRESENT IN JOINTS.
- NOTIFY CONSULTANT WHERE BRICK BECOMES LOOSE.

TYPICAL RAKING OUT DETAIL

WHERE FULL DEPTH REMOVALS IN HORIZONTAL JOINTS ARE NECESSARY, EXERCISE CAUTION SO AS NOT TO DESTABILIZE THE WALL. IN THIS CASE, REMOVE MORTAR IN ONLY SMALL PORTIONS OF THE WALL AND REPOINT EXCEPT FOR FINAL LAYER BEFORE PROCEEDING WITH

FOR PRICING, ASSUME THE FOLLOWING:


- AVERAGE DEPTH OF BRICK: 100mm.
- CEMENTITIOUS PARGING MUST BE REMOVED FROM THE FACE OF THE WALL PRIOR TO REPOINTING. 50% OF THIS PARGING IS DELAMINATED FROM THE BRICK.
- 60% OF REMOVALS FOR VERTICAL JOINTS ARE IN THE ORDER OF 30 TO 40mm DEEP AND THE REMAINDER ARE FULL DEPTH REMOVALS.
- 40% OF REMOVALS FOR HORIZONTAL JOINTS ARE IN THE ORDER OF 30 TO 40mm DEEP AND THE REMAINDER ARE FULL DEPTH REMOVALS.

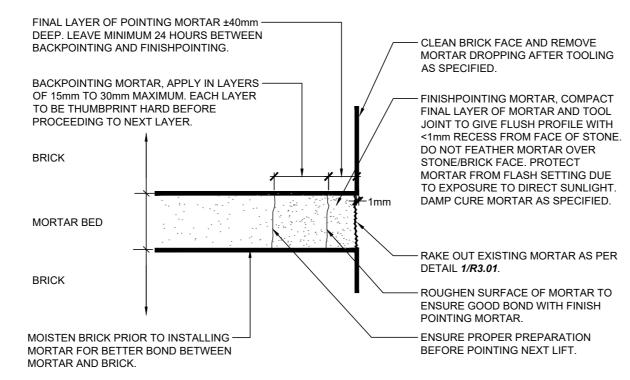

 BACKPOINTING: REQUEST INSPECTION TO REVIEW PRIOR TO BACKPOINTING. REQUEST INSPECTION FOR REVIEW OF COMPLETED BACKPOINTING BEFORE PROCEEDING TO MASONRY REPAIRS AND





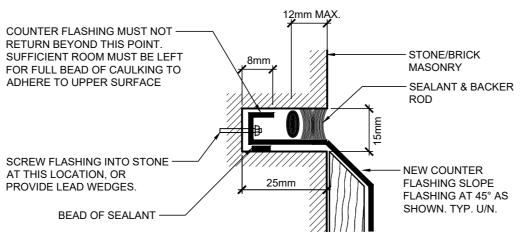

- ALLOW FOR REPOINTING BEHIND ALL EXISTING FLASHING, ONCE EXISTING FLASHING IS REMOVED. ASSUMED RAKE OUR AND REPOINTING DEPTH IS 100mm. SEE DETAILS 1 AND 2 ON
- SEE ROOF REPLACEMENT DRAWINGS (BY OTHERS) FOR BALANCE OF ROOFING AND FLASHING

TYPICAL REGLET DETAIL CUT INTO STONE MASONRY

TYPICAL REGLET DETAIL CUT INTO MORTAR JOINT

REMOVED. ASSUMED RAKE OUR AND REPOINTING DEPTH IS 100mm. SEE DETAILS 1 AND 2 ON

2. SEE ROOF REPLACEMENT DRAWINGS (BY OTHERS) FOR BALANCE OF ROOFING AND FLASHING

50mm

— BEAD OF SEALAN

1. ALLOW FOR REPOINTING BEHIND ALL EXISTING FLASHING, ONCE EXISTING FLASHING IS

INSTALL NEW 8mm S.S. SPIRAL ANCHORS AT 400mm c/c. HORZ. SPACING, AND 400mm c/c. VERT. SPACING, TYPICAL ADDITIONAL SPACING REQUIREMENTS HORIZONTAL SPACING: HORIZONTAL ANCHORS TO BE INSTALLED LESS THAN 300mm FROM OPENINGS. VERTICAL SPACING: UPPERMOST ROW OF TIES TO BE

INSTALLED LESS THAN 300mm FROM

25mm MIN. CUT BACK ANCHOR AS NECESSARY.

TOP OF WALL.

SECTION

BRICK BACKUP

INSTALL SPIRAL ANCHORS

INTO BACKUP BRICK.

- RETROFIT ANCHOR TYPE: STAINLESS STEEL HELICAL WALL TIE.
- 2. ANCHOR DIAMETER: 8mmØ INSTALLED INTO BRICK BACKUP, USE STANDARD
- 8mmØ ANCHOR ANCHOR LENGTH: 195mm

FILL JOINT WITH MORTAR, AFTER -

FLASHING MUST NOT RETURN —

INSTALLATION OF FLASHING.

SUFFICIENT ROOM MUST BE

LEFT FOR FULL BEAD OF

SCREW FLASHING INTO

LOCATION, OR PROVIDE

SOUND. ALLOW FOR AN

ADDITIONAL 50mm OF

ENSURE REMAINING MORTAR IS -

DETERIORATED MORTAR TO BE

RAKED OUT AND REPOINTED.

CAULKING TO ADHERE TO

COMPACT MORTAR.

BEYOND THIS POINT.

UPPER SURFACE

MORTAR AT THIS

LEAD WEDGES

- RECOMMENDED PRODUCT IS SPIRAL-LOK BY BLOK-LOK. SUBMIT DATA SHEETS FOR REVIEW
- 5. DRILL TYPE: BECAUSE THE BACK-UP MATERIAL IS BRICK, A SPECIALIZED DRILL IS REQUIRED, WHICH HAS A REDUCED POWER HAMMER SETTING.
- 5.1. APPROVED DRILLS:
 - HILTI TE 2-S DRILL, WITH A 30% HAMMER **ACTION SETTING**

TYPICAL RETROFIT ANCHOR DETAIL

HIGH SPEED ROTARY PERCUSSION DRILL, 3-JAW CHUCK TYPE.

INSTALLATION INSTRUCTIONS:

- 1. FOLLOW MANUFACTURER'S INSTRUCTIONS, AND NOTE THE FOLLOWING
- 2. INSTALLATION TYPE: BRICK TO BRICK (ENTRY THROUGH MORTAR JOINT)
- 2.1. DRILL 5mm PILOT HOLE INTO MORTAR JOINT IN BRICK BACK-UP, MIN. 75mm **EMBEDMENT**
- 2.2. DRILL TYPE FOR PILOT HOLE TO BE AS PER NOTE 5.1
- 2.3. HOLE LOCATION SHALL BE IN BED JOINT, AVOIDING AS BEST AS POSSIBLE THE CORES OF THE BRICK, AND NOT IN THE 'T' JOINT
- 2.4. INSTALL 8mm SPIRA-LOK ANCHOR, DRIVEN INTO POSITION USING THE BLOCK-LOK DRY SET INSTALLATION TOOL, MOUNTED ON AN ELECTRIC SDS HAMMER DRILL. ANCHOR TO BE INSET INTO MORTAR JOINT BY 10mm.

STONE/BRICK

NEW SEALANT & BACKER

ROD. INCLUDE REMOVAL OF EXISTING CAULKING

OR MORTAR BACK TO

NEW COUNTER

FLASHING SLOPE

FLASHING AT 45° AS

SHOWN. TYP. U/N.

SOUND MORTAR.

MASONRY

2.5. EMBED ANCHORS INTO BED JOINTS OF NEW BRICK TO BE REBUILT.



CONSULTING ENGINEERS

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KEY PLAN SCALE NTS OFESSION J. K. DEE 100162005 UN-23-202

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> BRICK PARAPET REPAIRS 47 JAMES STREET S, HAMILTON, ONTARIO


DRAWING:

PROJECT

TYPICAL DETAILS

SF / JD CP AS SHOWN 2025-05-08 PROJECT 25115

R3.01

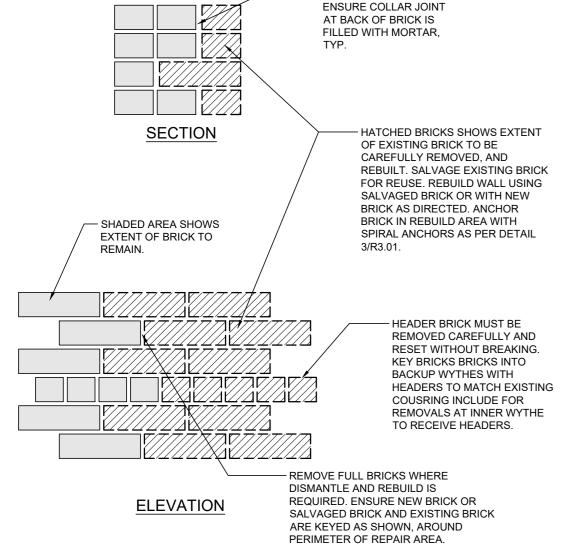

AS BRICKS ARE LAID,

TYPICAL BRICK DISMANTLE AND REBUILD

SHEET SIZE A2 (594mm x 420mm