

COMMITTEE OF ADJUSTMENT

City Hall, 5th floor, 71 Main Street West, Hamilton, ON L8P 4Y5
Telephone (905) 546-2424, ext. 4221

E-mail: cofa@hamilton.ca

NOTICE OF PUBLIC HEARING Minor Variance

You are receiving this notice because you are either:

- Assessed owner of a property located within 60 metres of the subject property
- Applicant/agent on file, or
- Person likely to be interested in this application

APPLICATION	A-25:134	SUBJECT	61 Clapham Road, Hamilton
NO.:		PROPERTY:	
ZONE:	RT-30-H/S-1738 (Street -	ZONING BY-	Former Hamilton Zoning By-law
	Townhouse)	LAW:	6593

APPLICANTS: Owner: LaCaban Developments Inc. Tayo Omosehin

Agent: Ross Defina

The following variances are requested:

- A minimum side yard width of 1.5 metres shall be permitted for a Street Townhouse Dwelling not exceeding two (2) storeys in height, instead of the minimum required side yard width of 2.0 metres.
- 2. An unenclosed porch shall be permitted within a side yard instead of the requirement that an unenclosed porch shall only be permitted within a front or rear Yard.
- 3. A minimum driveway dimension of 2.8 metres by 5.5 metres for a Secondary Dwelling Unit shall be permitted instead of the minimum required 2.8 metres by 5.8 metres.
- 4. A minimum parking and loading space dimension of 3.0 metres by 5.5 metres for a Secondary Dwelling Unit shall be permitted instead of the minimum required 3.0 metres by 5.8 metres.
- 5. Every access driveway where a townhouse dwelling is adjacent to a residential district that does not permit such use shall be located not less than 1.9 metres from the common boundary between the district in which the townhouse dwelling is located and the district that does not permit such use, instead of the required 3.0 metres.

PURPOSE & EFFECT: To permit the construction of five (5) Street Townhouse Dwellings each

containing a Secondary Dwelling Unit.

A-25:134

Notes:

- i. Please be advised variance No. 3 and 4 have been written as requested.
- ii. Please be advised insufficient information was provided to determine zoning conformity with Section 18A (7b) garage floor height above grade. Additional variances may be required if conformity cannot be achieved.

This Notice must be posted by the owner of any land which contains seven or more residential units so that it is visible to all residents.

This application will be heard by the Committee as shown below:

DATE:	E: Thursday, August 14, 2025	
TIME:	12:20 p.m.	
PLACE:	Via video link or call in (see attached sheet for details)	
	City Hall Council Chambers (71 Main St. W., Hamilton)	
	To be streamed (viewing only) at	
	www.hamilton.ca/committeeofadjustment	

For more information on this matter, including access to drawings illustrating this request and other information submitted:

- Visit www.hamilton.ca/committeeofadjustment
- Visit Committee of Adjustment staff at 5th floor City Hall, 71 Main St. W., Hamilton

PUBLIC INPUT


Written: If you would like to submit written comments to the Committee of Adjustment you may do so via email or hardcopy. Please see attached page for complete instructions, written comments must be received no later than noon August 12, 2025

Orally: If you would like to speak to this item at the hearing you may do so via video link, calling in, or attending in person. Please see attached page for complete instructions, registration to participate virtually must be received no later than noon August 13, 2025

FURTHER NOTIFICATION

If you wish to be notified of future Public Hearings, if applicable, regarding A-25:134, you must submit a written request to cofa@hamilton.ca or by mailing the Committee of Adjustment, City of Hamilton, 71 Main Street West, 5th Floor, Hamilton, Ontario, L8P 4Y5.

If you wish to be provided a Notice of Decision, you must attend the Public Hearing and file a written request with the Secretary-Treasurer by emailing cofa@hamilton.ca or by mailing the Committee of Adjustment, City of Hamilton, 71 Main Street West, 5th Floor, Hamilton, Ontario, L8P 4Y5.

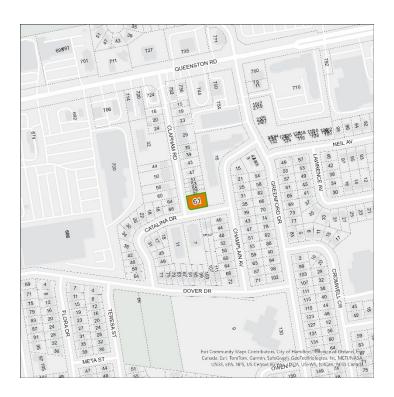

Subject Lands

DATED: July 28, 2025

Justin Leung, Secretary-Treasurer Committee of Adjustment Information respecting this application is being collected under the authority of the Planning Act, R.S.O., 1990, c. P. 13. All comments and opinions submitted to the City of Hamilton on this matter, including the name, address, and contact information of persons submitting comments and/or opinions, will become part of the public record and will be made available to the Applicant and the general public, and may include posting electronic versions.



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Telephone (905) 546-2424, ext. 4221

E-mail: cofa@hamilton.ca

PARTICIPATION PROCEDURES

Written Submission Ahead of the Meeting

Members of the public who wish to provide input without speaking at the Hearing may submit written comments in advance of the meeting. Comments must be received by 12:00 p.m. (noon) on the date listed on the Notice of Public Hearing.

How to Submit Written Comments:

By Email:

Send to: cofa@hamilton.ca

By Mail:

Committee of Adjustment City of Hamilton 71 Main Street West, 5th Floor Hamilton, Ontario L8P 4Y5

All written comments received will be made available to the Committee and the public by the Tuesday prior to the Hearing.

Oral Submissions During the Hearing

Interested members of the public, agents, and owners may provide oral comments on Committee of Adjustment Hearing items either virtually via Webex (computer or phone) or by attending in person.

Speaking Time Limit:

All participants providing oral submissions, either in person or virtually are limited to a maximum of 5 minutes to speak. This is to ensure all parties have an equal opportunity to be heard and that the meeting runs efficiently.

In-Person Oral Submissions

To participate in person, attend Council Chambers on the date and time listed in the Notice of Public Hearing. You will be required to provide your name and address for the record. It is recommended you arrive at least 10 minutes prior to the scheduled start time.

A-25:134

Virtual Oral Submissions

To participate virtually, you must register by 12:00 p.m. (noon) on the date listed on the Notice of Public Hearing. To register, email cofa@hamilton.ca with the following information:

- · Committee of Adjustment file number
- Hearing date
- Name and mailing address of each person wishing to speak
- Method of participation (phone or video), and, if applicable, the phone number to be used
- Each person must register separately

Registered participants will receive a Webex link one business day before the Hearing. Only those registered will be called upon to speak.

Presentations

All presentations are permitted at the discretion of the Committee.

Virtual Presentations:

Presenters participating virtually may be granted permission to share their screen during the Hearing. A copy of the presentation must be submitted to cofa@hamilton.ca no later than 12:00 p.m. (noon) on the business day prior to the Hearing. The submission must be one document in PDF format only.


In-Person Presentations:

Presenters attending in person may be granted permission to use the presentation screen. Presentations must be brought on a USB device and opened by the owner/applicant. A copy of the presentation must also be sent to cofa@hamilton.ca by 12:00 p.m. (noon) on the business day prior to the Hearing in PDF format as a single document. Handouts are permitted only if the same content can be displayed on the presentation screen.

Additional Notes

- Webex (video) participation requires a compatible computer or smartphone. The necessary application must be downloaded in advance.
- It is the interested party's responsibility to ensure their device is functional and compatible prior to the Hearing.

For any questions, contact staff at cofa@hamilton.ca or call 905-546-2424 ext. 4221.

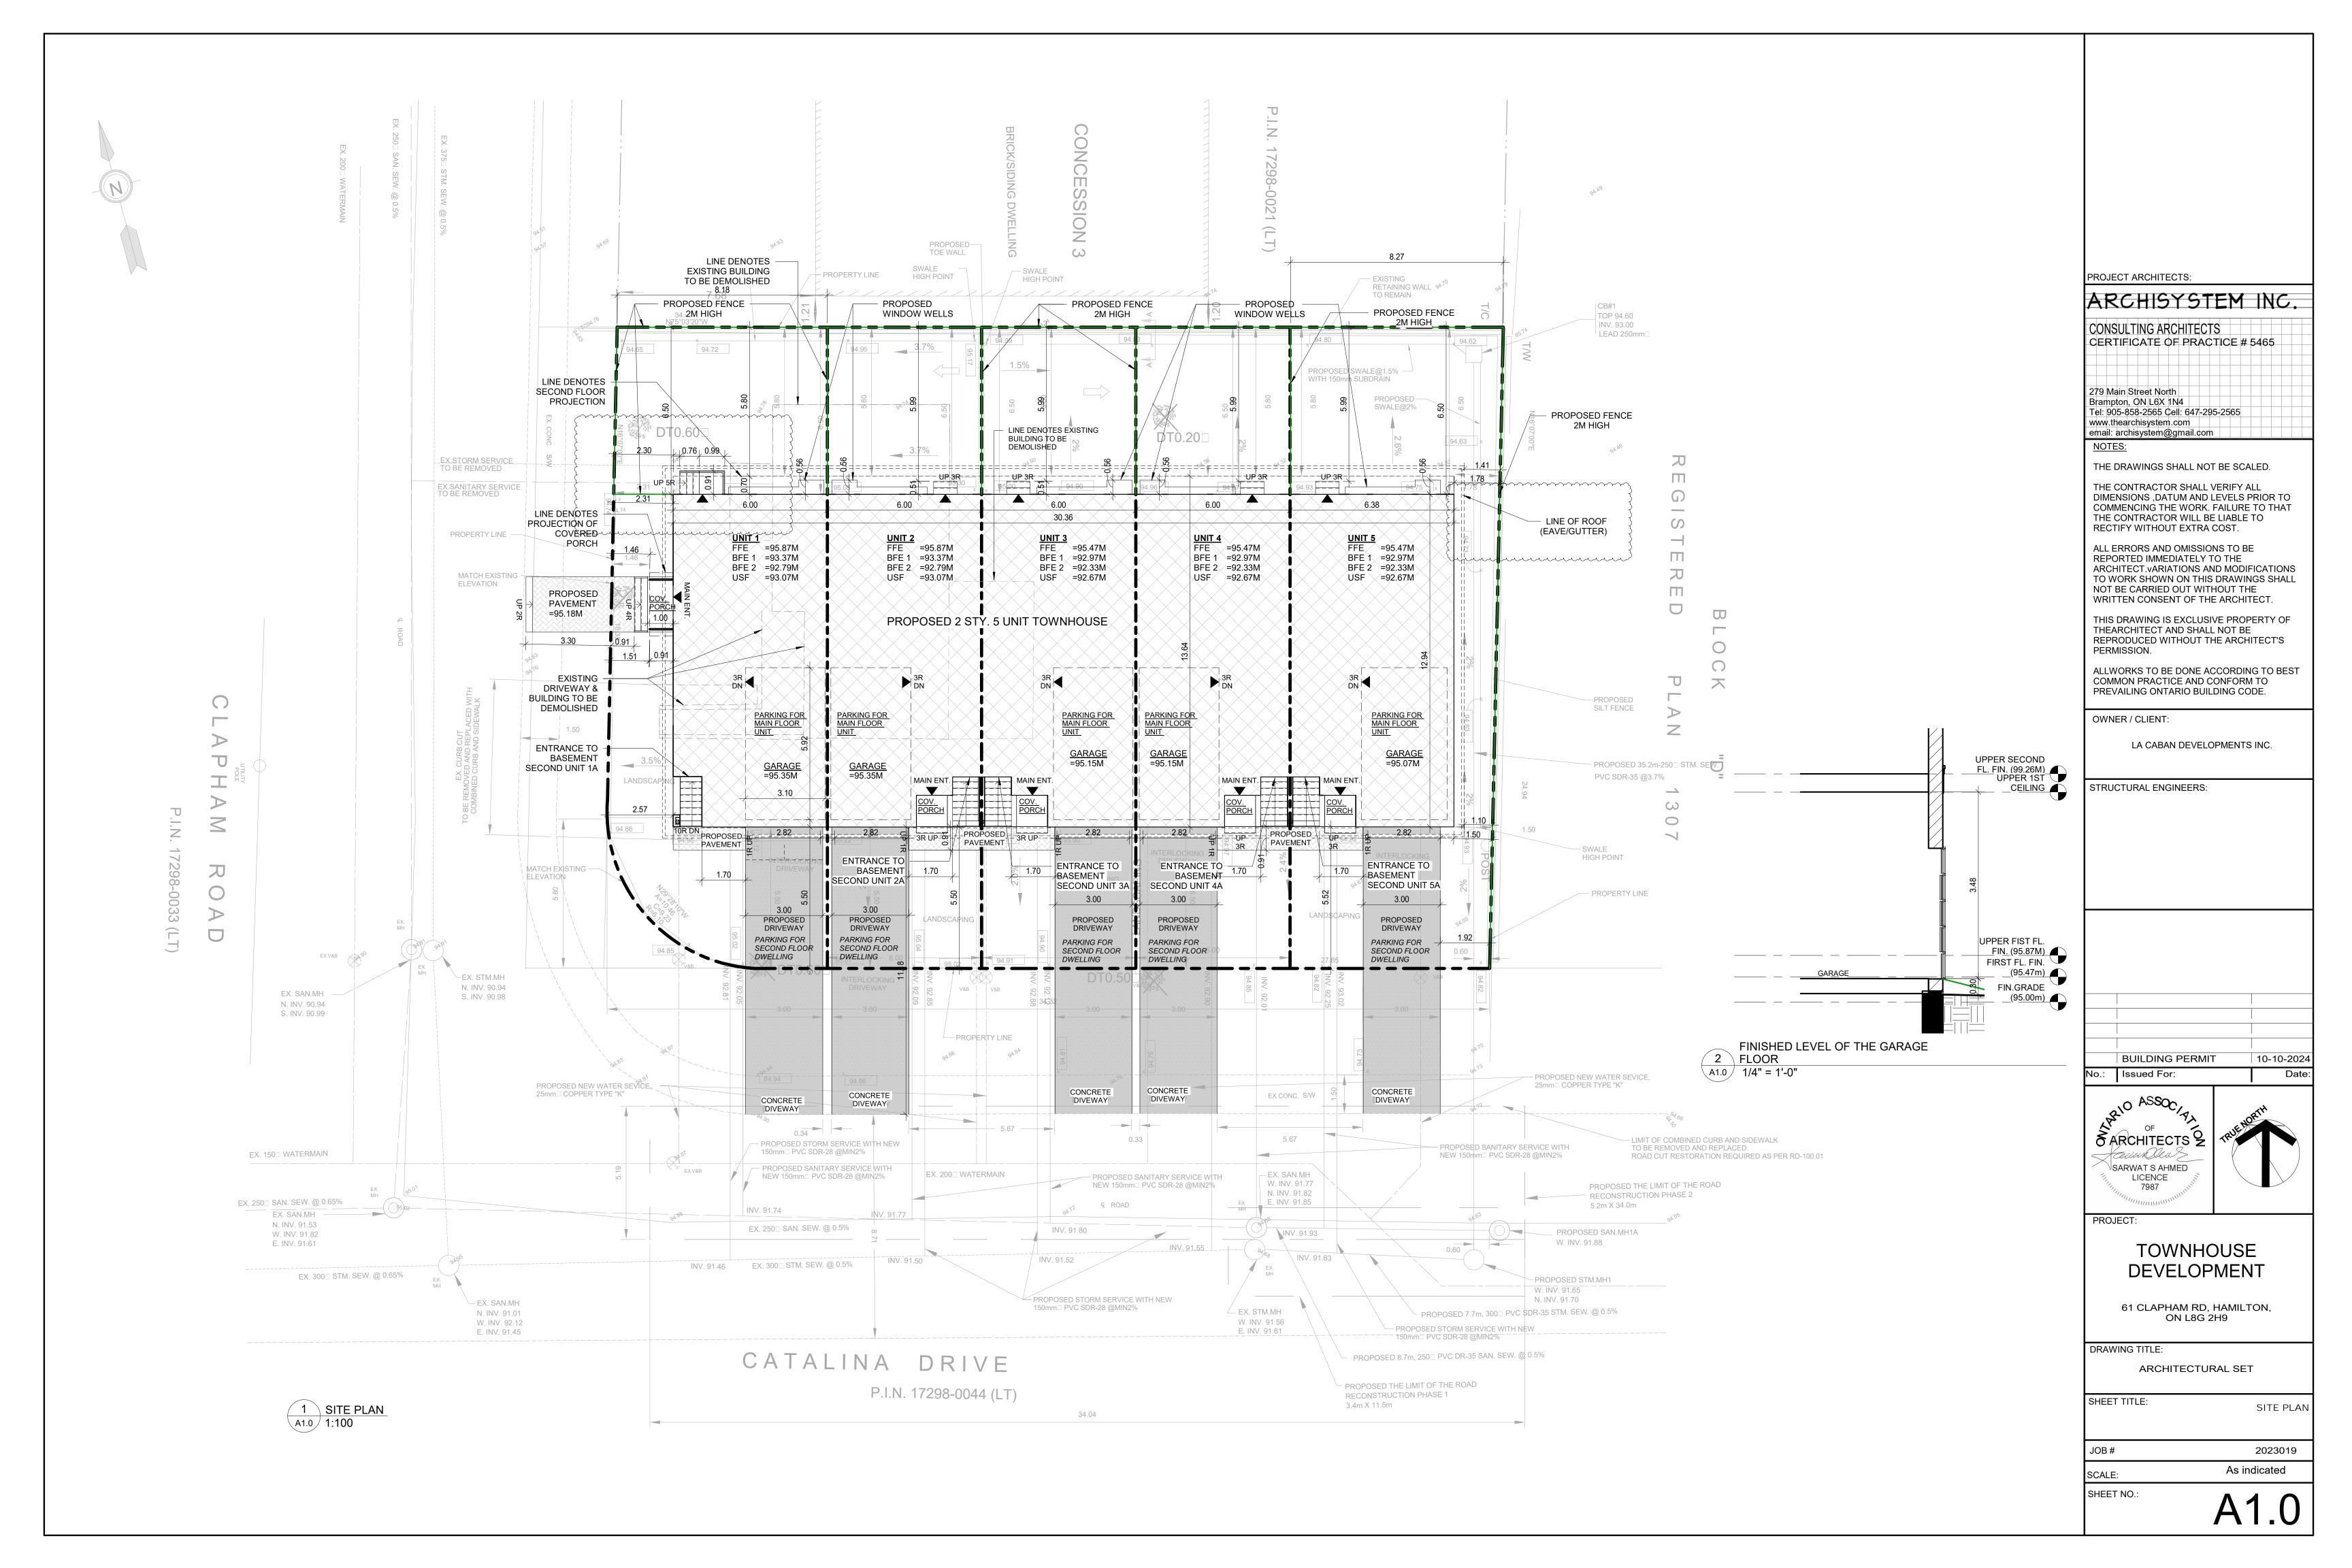

KEY MAP KEY PLAN NOT TO SCALE ADDRESS: 61 CLAPHAM ROAD SITE PLAN OF PART OF LOT 28 CONCESSION 3 94.31 CITY OF HAMILTON SCALE & NOTES SCALE: 1:200 20 Metres EDWARD J. GRENKIE ONTARIO LAND SURVEYOR 0 1-© COPYRIGHT 2015 00 LEGEND *94.83* DENOTES OVERHEAD WIRES DENOTES PROPOSED ELEVATION (92.00) SW DENOTES PROPOSED SWALE ELEVATION 92.00 DENOTES EXISTING ELEVATION DENOTES DRAINAGE DENOTES UTILITY POLE DENOTES DECIDUOUS TREE 94.73 70 \mathcal{C} DENOTES CONIFEROUS TREE DENOTES NORTH-EAST-SOUTH-WEST DENOTES TREE TO BE REMOVED 94.50 DENOTES SUBJECT LANDS BOUNDARY 0 % DENOTES DEED LINE DENOTES LOT LINE \approx ∞ — DENOTES LIMIT OF STREET — X — X — DENOTES FENCE LINE MBEARING NOTE BEARINGS ARE ASTRONOMIC AND ARE REFERRED TO THE EASTERLY LIMIT OF CLAPHAM ROAD AS SHOWN ON PLAN 62R-4690 RHAVING A BEARING OF N16°07'00"E. *95.05 95.09* 0 BENCH MARK NOTE ×94.65 ELEVATIONS ARE REFERRED TO THE CITY OF HAMILTON BENCHMARK No. 0011963U3501 HAVING A ELEVATION OF 91.674 METRES. NOTE 94.86 \mathcal{C} BEFORE DIGGING, ALL UNDERGROUND SERVICE SHOULD BE LOCATED ON SITE BY THE RESPECTIVE AGENCIES. TREE PROTECTION AS REQUIRED 94.91 MAN HOLE HOLE 94.91 THE SURVEY WAS COMPLETED JUNE 29, 2015. 94.59 *94.76* 27.85 N75°03'20"W DISTANCES SHOWN ON THIS PLAN ARE IN METRES AND CAN BE CONVERTED TO FEET BY DIVIDING BY 0.3048 94.99x ⁺ 94.83x 94.94 CONCRETE SIDEWALK 94.66 94.50 94.72 **₩**^{MAN} HOLE **94.87** 94.72, CENTERLINE OF ROAD 94.63 MAN HOLE 94.68 MAN HOLE 94.68 6, JULY 2015 94.95 ONTARIO LAND SURVEYOR C A T A L I N AD R I V EDWN BY: SD Barich Grenkie Surveying Ltd.
11 - 428 MILLEN ROAD - STONEY CREEK, ON P.I.N. 17298--0044 (LT) CHK BY: EG

(905) 662-6767

JOB No. 15-1935



PROPOSED TOWNHOUSE DEVELOPMENT AT 61 CLAPHAM RD, HAMILTON, ON L8G 2H9

OWNER:

LA CABAN DEVELOPMENTS INC.

PROJECT ARCHITECTS:

ARCHISYSTEM INC.

CONSULTING ARCHITECTS

CERTIFICATE OF PRACTICE # 5465

279 Main Street North
Brampton, ON L6X 1N4
Tel: 905-858-2565 Cell: 647-295-2565
www.thearchisystem.com
email: archisystem@gmail.com

SITE SERVICE & GRADING:

LAND & BUILDING EXPERTS

570 ALDEN ROAD UNIT 6, MARKHAM ONTARIO, L3R 8N5 (647) 340-8649 building.experts@yahoo.com

MECHANICAL:




2985 DREW ROAD SUITE 202, MISSISSAUGA, ONT. L4T 0A4 TEL: 905-671-9800

L4T 0A4 TEL: 905-671-9800 EMAIL: DAVE@GTADESIGNS.CA WEB: WWW.GTADESIGNS.CA

TRUSS:

UNITED TRUSS
3325 THOMAS STREET
INNISFIL ON L9S 3W4
PHONE: (705) 436-3425
www.unitedlumber.ca

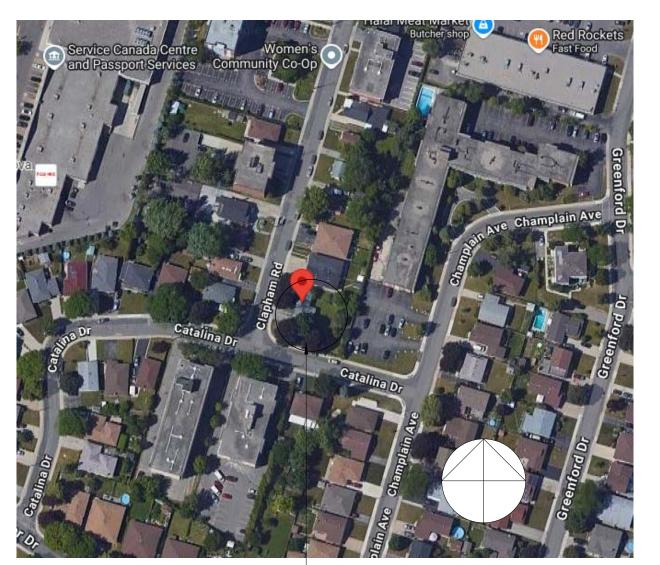

	LOCATION MAP
	NTS

PROPOSED GROSS FLOOR AREA

61 CLAPHAM RD, HAMILTON, ON L8G 2H9

SITE DATA	M/SM
ZONING	RT-30-H/S-1738
PLAN NO:	-
LOT NO:	-
LOT AREA	850.70 SM (9156.80 SQ.FT)
EXISTING TO BE DEMOLISHED	PROPOSED
EXISTING LOT COVERAGE	PROPOSED LOT COVERAGE
EX. DWELLING = 108.03 SQ.M. [1162.85 SF.] EX. LOT COV. = 108.03 SQ.M. [1162.85 SF.] = 12.70%	PROPOSED DWELLING FOOT PRINT = 414.82 SQ.M. [4465.09 SF.] (INCL. GARAGES & COVERD AREAS)
	PROPOSED COV. PORCHES = 9.08 SQ.M. [97.83 SF.] PROPOSED GARAGES = 93.13 SQ.M. [1002.52 SF.] OTHER BALCONY, 2ND FL. OVERHANGS = 20.05 SQ.M [215.85 SF.]
	PROPOSED TOTAL LOT COVERAGE = 416.1 SQ.M. [4,478.8 SF.] = 48.9 %
EX. GROSS FLOOR AREA	GROSS FLOOR AREA
EX. FIRST FL. AREA = 103.37 SQ.M. [1112.63 SF.]	PROPOSED FIRST FL. AREA = 291.6 SQ.M. [3,138.7 SF] (EXCL. PORCHES & GARAGES)
EX. GFA. = 103.37 SQ.M. [1112.63 SF.]	PROPOSED SECOND FL. AREA = 413.1 SQ.M. [4,446.6 SF.] (EXCL. STAIRCASE)
	<u>TOTAL GFA. PROPOSED</u> = 704.7 SQ.M. [7585.3 SF.]
	PROPOSED BASEMENT FINISHED AREA = 432.55 SQ.M. [4655.86 SF.] PROPOSED WALK-UP STAIRCASE AREA = 29.01 SQ.M. [311.98 SF.]
	PROPOSED BASEMENT TOTAL AREA = 550.47 SQ.M. [5925.26 SF.]

PROPOSED LOT COVERAGE FOR EACH UNIT				
UNIT#	LOT AREA	LOT COVERAGE		
1	201.9 SQ.M. [2172.9 SF.]	88.8 SQ.M. = 44.0%		
2	149.6 SQ.M. [1610.6 SF.]	81.8 SQ.M. = 54.7%		
3	149.6 SQ.M. [1610.6 SF.]	81.8 SQ.M. = 54.7%		
4	149.6 SQ.M. [1610.6 SF.]	81.8 SQ.M. = 54.7%		
5	200.0 SQ.M. [2152.8 SF.]	81.8 SQ.M. = 40.9%		
TOTAL	850.80 SQ.M. [9157.4 SF.]	416.1 SQ.M. = 48.9 %		

FRONT YARD LANDSCAPED AREA TO HARDSCAPE AREA				
UNIT #	FRONT YARD AREA	FRONT LANDSCAPE AREA		
1	39.39 SQ.M. [424 SF.]	22.91 SQ.M. [246.60 SF.] = 58.16 %		
2	32.98 SQ.M. [355 SF.]	16.50 SQ.M. [177.60 SF.] = 50.03%		
3	32.98 SQ.M. [355 SF.]	16.50 SQ.M. [177.60 SF.] = 50.03%		
4	32.98 SQ.M. [355 SF.]	16.50 SQ.M. [177.60 SF.] = 50.03%		
5	43.00 SQ.M. [462.9 SF.]	26.52 SQ.M. [285.46 SF.] = 61.67%		

CONSTRUCTION

217.0 SQ.M. [2335.6 SF.]

208.0 SQ.M. [2238.5 SF.]

208.0 SQ.M. [2238.5 SF.]

208.0 SQ.M. [2238.5 SF.]

219.9 SQ.M. [2367.5 SF.]

1060.8 SQ.M. [11418.4 SF.]

GARAGE AREA +

PORCH AREA

25.37 SQ.M.

20.41 SQ.M.

20.41 SQ.M.

20.41 SQ.M.

19.96 SQ.M.

106.56 SQ.M.


UNIT#	1ST FLOOR AREA	2ND FLOOR AREA	TOTAL GFA. FOR EACH UNIT	
1	59.2 SQ.M.	81.7 SQ.M.	140.9 SQ.M. [1516.6 SF.]	
2	57.2 SQ.M.	81.7 SQ.M.	138.9 SQ.M. [1494.8 SF.]	
3	57.2 SQ.M.	81.7 SQ.M.	138.9 SQ.M. [1494.8 SF.]	
4	57.2 SQ.M.	81.7 SQ.M.	138.9 SQ.M. [1494.8 SF.]	
5	60.7 SQ.M.	86.4 SQ.M.	147.2 SQ.M. [1584.1 SF.]	
TOTAL	291.6 SQ.M.	413.1 SQ.M.	704.7 SQ.M. [7585.1 SF.]	
PROPOSED	GROSS FLOOR AREA - SEC	OND DWELLING UNIT		
SECOND DWELLING UNIT #	BASEMENT FINISHED AREA	WALK-UP STAIRCASE AREA	BASEMENT TOTAL AREA W/ FOUNDATION WALLS (CONSTRUCTION AREA)	
1A	50.71 SQ.M. [545.84 SF.]	5.49 SQ.M. [59.06 SF.]	79.10 SQ.M. [851.47 SF.]	
2A	48.68 SQ.M. [523.98 SF.]	5.88 SQ.M. [63.23 SF.]	77.19 SQ.M. [830.84 SF.]	
3A	48.68 SQ.M. [523.98 SF.]	5.88 SQ.M. [63.23 SF.]	77.19 SQ.M. [830.84 SF.]	
4A	48.68 SQ.M. [523.98 SF.]	5.88 SQ.M. [63.23 SF.]	77.19 SQ.M. [830.84 SF.]	
5A	52.82 SQ.M. [568.55 SF.]	5.88 SQ.M. [63.23 SF.]	81.60 SQ.M. [878.33 SF.]	
TOTAL	249.57 SQ.M. [2,686.33 SF.]	29.01 SQ.M. [311.98 SF.]	550.47 SQ.M. [5925.26 SF.]	

NO ASSOCIAN ARCHISYSTEM INC. CERTIFICATE OF PRACTICE #5465 & ARCHITECTS > Janua Den Name of Project: SARWAT S AHMED LICENCE PROPOSED 2 STY TOWNHOUSE DEVELOPMENT AT 61 CLAPHAM RD, HAMILTON, ON L8G 2H9 **OBC** References ONTARIO BUILDING CODE MATRIX - PART 3 OR 9 PART 11 PART 3 PART 9 NEW 2.1.1 Project Description: ADDITION DEMOLISH 1STY EXISTING BUILDING, 9.10.1.3 PROPOSE 2 STY TOWNHOUSE ALTERATION DEVELOPMENT AT 61 CLAPHAM RD, HAMILTON, ON L8G 2H9 CHANGE OF USE MAJOR OCCUPANCY(S) - GROUP C 9.10.2 3.1.2.1.(1) BUILDING AREA (m²) EXISTING 108.03 SQ.M. NEW <u>414.82 SQ.M.</u> TOTAL 414.82 SQ.M. 1.13.2 1.4.1.2[A] 1.4.1.2[A] 1.13.2 EXISTING 103.37 SQ.M. GROSS AREA (m²) NEW <u>673.64 SQ.M.</u> TOTAL <u>673.64 SQ.M.</u> 2.1.1.3 NUMBER OF STOREYS ABOVE GRADE_ BELOW GRADE 1 NUMBER OF STREETS / FIRE FIGHTER ACCESS 2 3.2.2.10 & 3.2.5.5 9.10.2 BUILDING CLASSIFICATION: C - 3.2.2.47 3.2.2.20-83 9.10.4 SPRINKLER SYSTEM PROPOSED 3.2.2.20-83 9.10.8 ENTIRE BUILDING SELECTED COMPARTMENTS 9.1.8.2 3.2.1.5 SELECTED FLOOR AREAS 3.2.217 BASEMENT IN LIEU OF ROOF RATING NOT REQUIRED STANDPIPE REQUIRED YES NO <3000 m2 3.2.9.1 FIRE ALARM REQUIRED YES 3.2.4..1(h) 9.10.7.2 WATER SERVICE / SUPPLY IS ADEQUATE YES NO 3.2.5.7 N/A NO YES HIGH BUILDING 3.2.6 CONSTRUCTION RESTRICTIONS COMBUSTIBLE NON-COMBUSTIBLE BOTH 3.2.2.57 9.10.6 PERMITTED PERMITTED **ACTUAL CONSTRUCTION** COMBUSTIBLE NON-COMBUSTIBLE BOTH 3.2.1.1.(3)-(8) 9.10.4.1 MEZZANINE(S) AREA (m²) OCCUPANT LOAD BASED ON m² / PERSON DESIGN OF BUILDING 3.1.17. 9.9.1.3 OCCUPANCY BASEMENT: 5 BEDROOM = 10 PERSONS TOTAL OCCUPANT LOAD FIRST FLOOR: 0 BEDROOM = 0 PERSONS = 40 PERSONS SECOND FLOOR: 15 BEDROOM = 30 PERSONS NOT REQUIRED 3.8. 9.5.2 BARRIER-FREE DESIGN NO (EXPLAIN) HAZARDOUS SUBSTANCES 3.3.1.2 & 3.3.1.19 9.10.1.3.(4) YES REQUIRED HORIZONTAL ASSEMBLIES LISTED DESIGN NO: 3.2.2.47 9.10.8 FRR (HOURS) OR DESCRIPTION (SG-2) RESISTANCE MINUTES 9.10.9 RATING (FRR) ROOF HOURS MEZZANINE HOURS SPATIAL SEPARATION - CONSTRUCTION OF EXTERIOR WALLS Area of L.D. * L/H or Permitted Proposed FRR Comb. Const. Non-Comb. EBF (m²) (m) H/L Max % of % of (Hours) Const. Non-Cladding Constr. Listed Design of Description Openings Openings NORTH N/A SOUTH N/A N/A N/A N/A N/A N/A 9.10.15.4 N/A N/A 1.5 1.98 2.01 89.54 N/A N/A N/A N/A N/A N/A N/A N/A * FROM CENTRE LINE OF PROPERTY **OBC** References PLUMBING FIXTURE REQUIREMENTS PART 9 PART 3 Male/Female Count @ ____50___% ___50___% FIXTURES FIXTURES OCCUPANT OBC except noted otherwise TABLE NO: REQUIRED PROVIDED

Name of Practice:

OTHER (Describe)

PROJECT ARCHITECTS: ARCHISYSTEM INC. CONSULTING ARCHITECTS CERTIFICATE OF PRACTICE # 5465 279 Main Street North Brampton, ON L6X 1N4 Tel: 905-858-2565 Cell: 647-295-2565 www.thearchisystem.com email: archisystem@gmail.com NOTES: THE DRAWINGS SHALL NOT BE SCALED. THE CONTRACTOR SHALL VERIFY ALL DIMENSIONS ,DATUM AND LEVELS PRIOR TO COMMENCING THE WORK. FAILURE TO THAT THE CONTRACTOR WILL BE LIABLE TO RECTIFY WITHOUT EXTRA COST. ALL ERRORS AND OMISSIONS TO BE REPORTED IMMEDIATELY TO THE ARCHITECT.vARIATIONS AND MODIFICATIONS TO WORK SHOWN ON THIS DRAWINGS SHALL NOT BE CARRIED OUT WITHOUT THE WRITTEN CONSENT OF THE ARCHITECT. THIS DRAWING IS EXCLUSIVE PROPERTY OF THEARCHITECT AND SHALL NOT BE REPRODUCED WITHOUT THE ARCHITECT'S PERMISSION. ALLWORKS TO BE DONE ACCORDING TO BEST COMMON PRACTICE AND CONFORM TO PREVAILING ONTARIO BUILDING CODE. OWNER / CLIENT: LA CABAN DEVELOPMENTS INC. STRUCTURAL ENGINEERS:

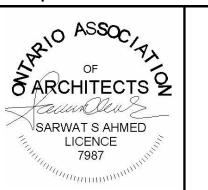

BUILDING PERMIT

No.: Issued For:

10-10-2024

Date:

PROJECT:


TOWNHOUSE DEVELOPMENT

61 CLAPHAM RD, HAMILTON, ON L8G 2H9

DRAWING TITLE: ARCHITECTURAL SET


SHEET TITLE: **OBC MATRIX & SITE** DATA

JOB# 2023019 As indicated SCALE: SHEET NO.

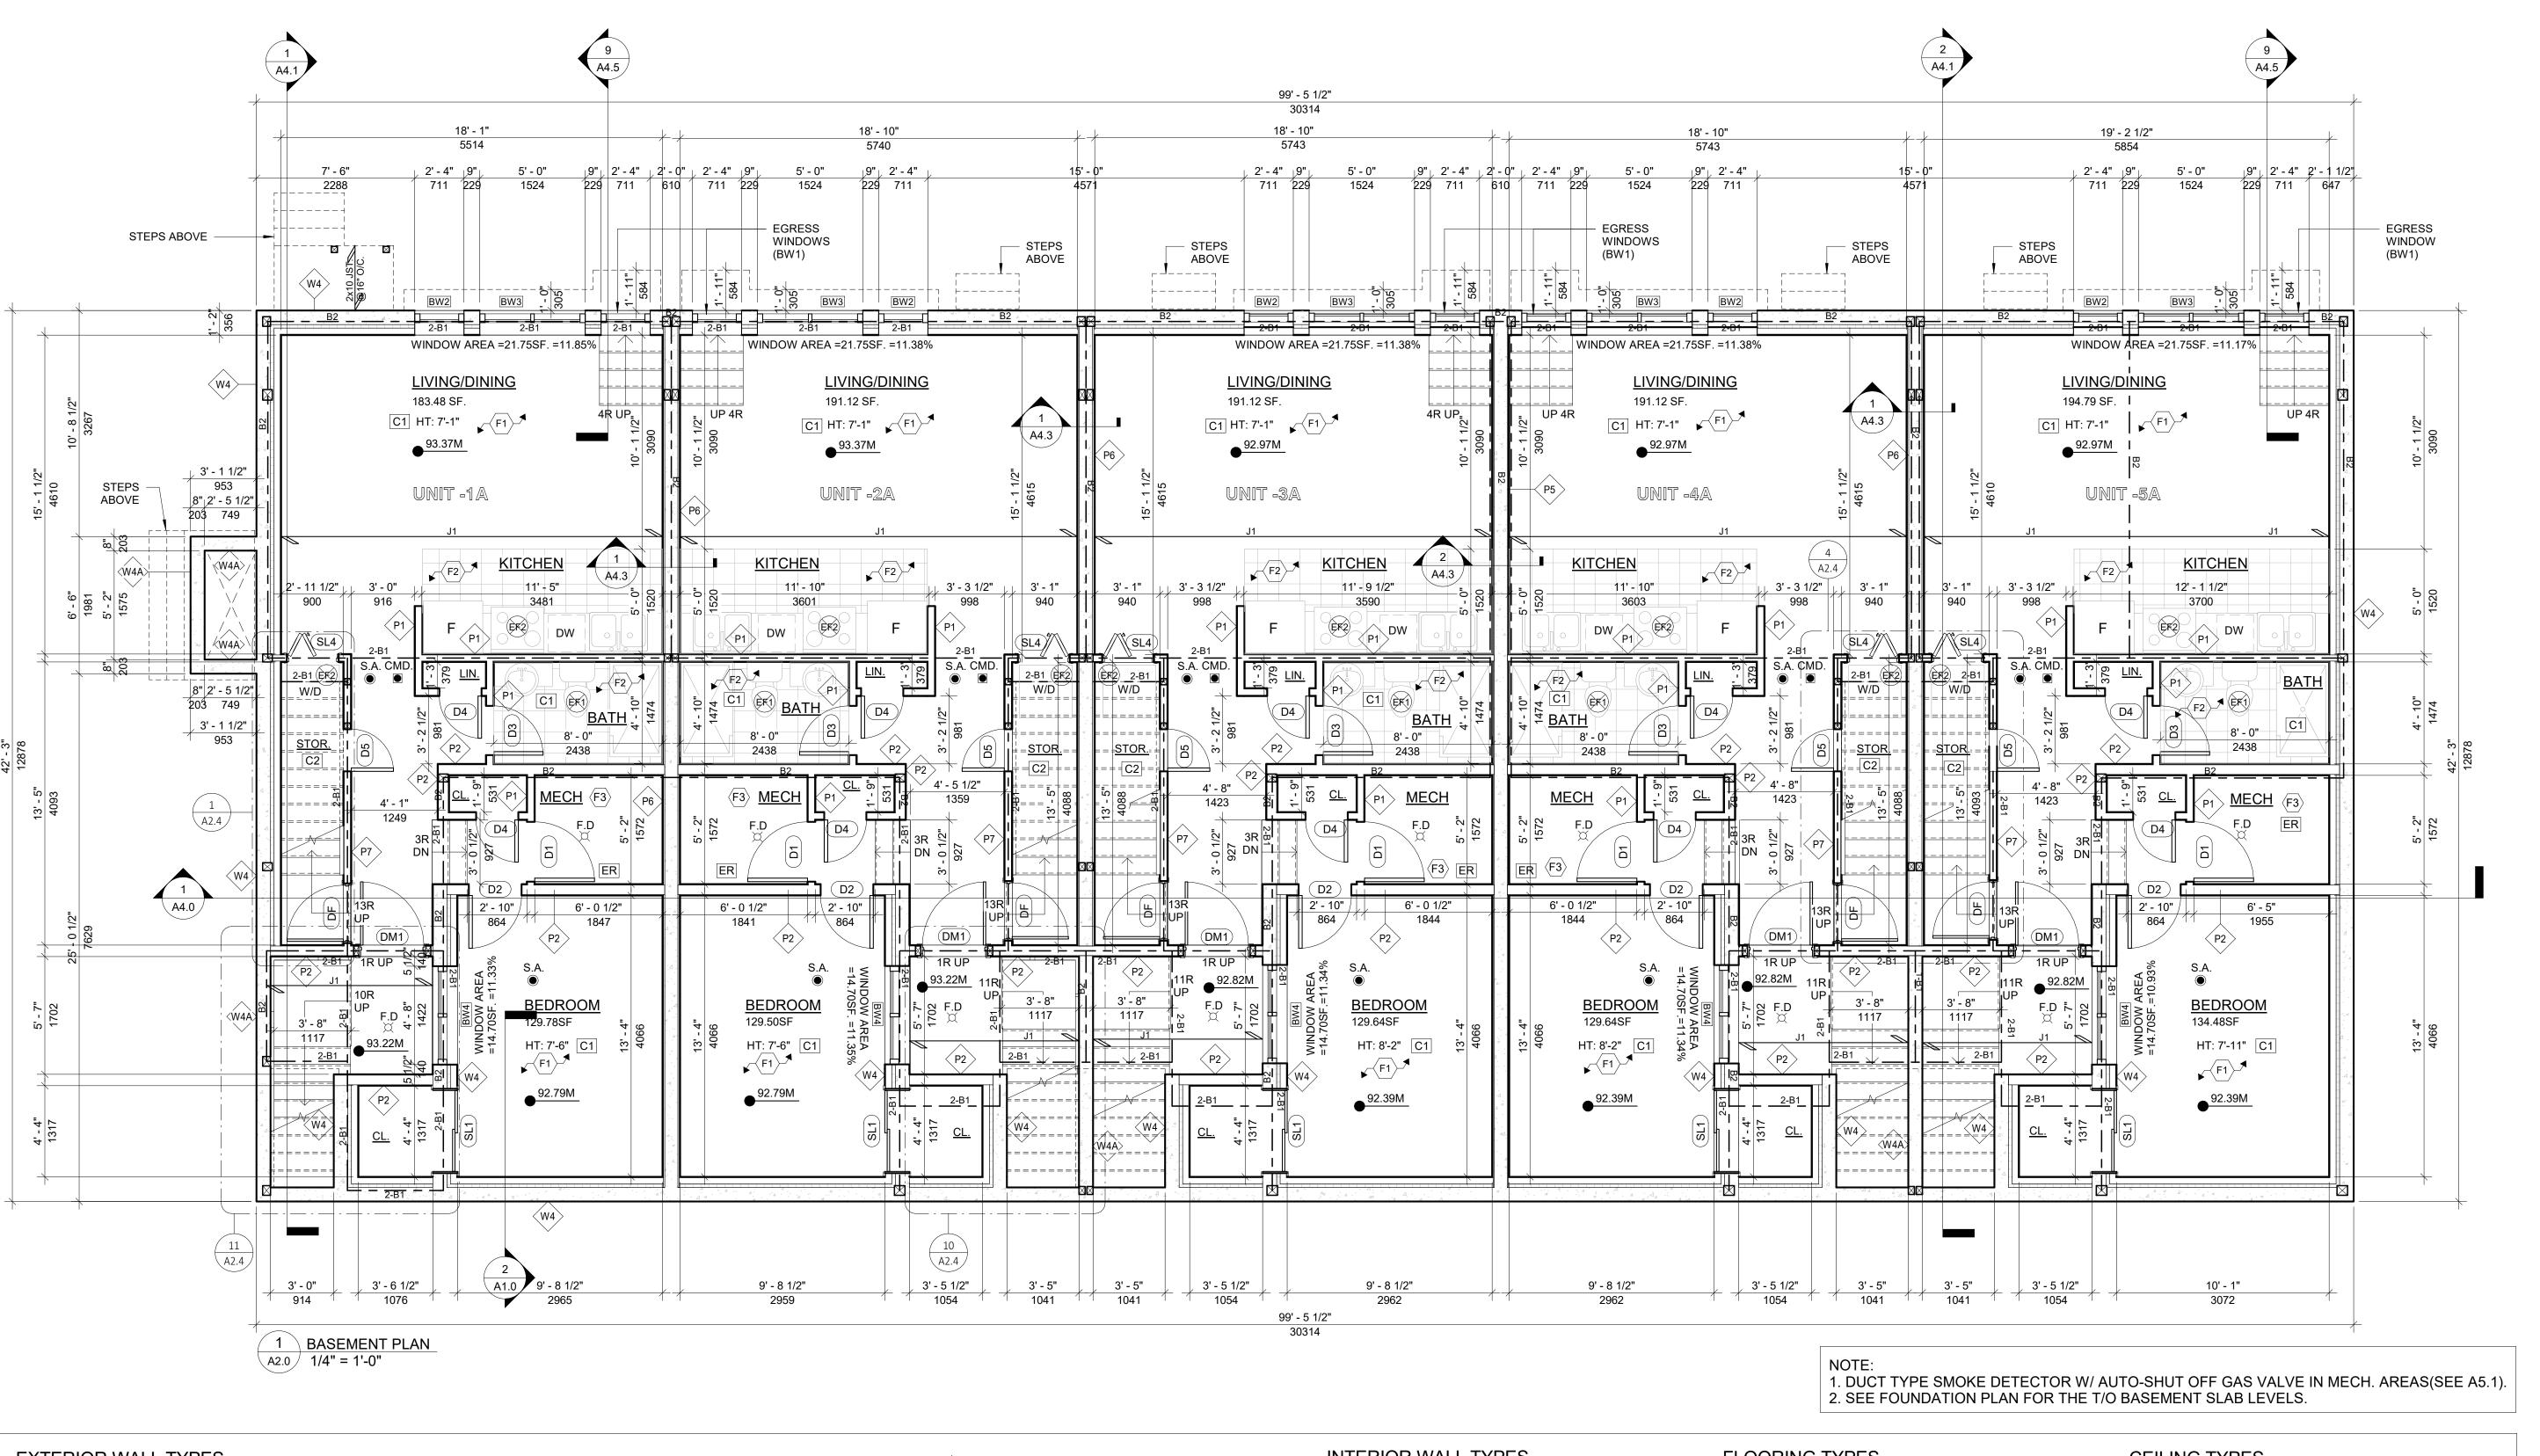

EXTERIOR WALL TYPES

10 1/2" STONE CLADDING EXTERIOR WALL

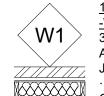

WITH INSULATION 3" EXTERIOR CULTURED STONE CLADDING FINISH, EXTERIOR APPROVED CONTINUOUS AIR BARRIER HOUSE WRAP, ALL JOINTS LAPPED & SEALED W/ APPROVED TAPE. · EXTERIOR WALL STUDS 2X6 (38X140) K.D. SPRUCE @16" (406) O.C. W/ SINGLE BOTTOM PLATE & DOUBLE TOP PLATES

· EXTERIOR WALL SHEATHING 1/2"X4'X8' PLYWOOD OR EQ. · R-24 (RSI-4.23) BATT INSULATION · APPROVED 6 MIL. POLYETHYLENE VAPOUR BARRIER, MIN. 1/2" (12.7) DRYWALL FINISH



10 1/2" STONE/BRICK CLADDING EXTERIOR WALL


- WITH OUT INSULATION



10 1/2" BRICK CLADDING EXTERIOR WALL <u>-WITH INSULATION</u>

3" EXTERIOR CULTURED BRICK CLADDING FINISH, EXTERIOR APPROVED CONTINUOUS AIR BARRIER HOUSE WRAP, ALL JOINTS LAPPED & SEALED W/ APPROVED TAPE. · EXTERIOR WALL STUDS 2X6 (38X140) K.D. SPRUCE @16" (406) O.C. W/ SINGLE BOTTOM PLATE & DOUBLE TOP PLATES


· EXTERIOR WALL SHEATHING 1/2"X4'X8' PLYWOOD OR EQ. · R-24 (RSI-4.23) BATT INSULATION · APPROVED 6 MIL. POLYETHYLENE VAPOUR BARRIER, MIN. 1/2" (12.7) DRYWALL FINISH

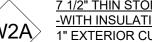

7 1/2" THIN STONE/ BRICK CLADDING EXTERIOR WALL -WITH INSULATION

1" EXTERIOR CULTURED STONE/ BRICK VENEER FINISH ON 1/2" SCRATCH COAT, EXTERIOR APPROVED CONTINUOUS AIR BARRIER HOUSE WRAP, ALL JOINTS LAPPED & SEALED W/ APPROVED TAPE. 1/2" PLYWOOD ON EXTERIOR WALL STUDS 2x6 K.D. SPRUCE @16" (406) O.C. W/ SINGLE BOTTOM PLATE & DOUBLE TOP PLATES · EXTERIOR WALL SHEATHING 1/2"X4'X8' PLYWOOD OR EQ. · R-24 (RSI-4.23) BATT INSULATION

· APPROVED 6 MIL. POLYETHYLENE VAPOUR BARRIER, MIN. 1/2"

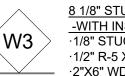

8 1/8" STUCCO FINISH EXTERIOR WALL

(12.7) DRYWALL FINISH

 \cdot 1/8" STUCCO OVER 2" RIGID INSULATION DRAINAGE LAYER ·1/2" R-5 XP INSULSHEATHING EXTERIOR SHEATHING ·2"X6" WD. STUDS @ 16" O/C TOP/BOTTOM PLATES ·R24 BATT INSULATION 6MIL POLY AVB. ·1/2" GWB TAPPED & PLASTERED. PROVIDE MOISTURE -RESISTANT GWB ON ALL WATER-BOURNE AREAS



1-2" POUR CONC. REINFORCED WALL - WITH INSULATION 8" (200) REINFORCED POURED CONCRETE WALLS,

2" CONTINUOUS 2LBS SPRAY FOAM INSULATION, 2x4 WD. STUD WALL OVER 2X4 PIT SILL PLATE, SINGLE BOTTOM AND TOP PLATES @ 16" O|C - C|W R-12 BATT INSULATION. COMBINED R24., 6 MIL POLY VAPOUR BARRIER, MIN. 1/2" DRYWALL FINISH.



8" POUR CONC. REINFORCED WALL 8" POUR CONC. REINFORCED WALL O/S TROWEL APPLIED WATERPROOFING LAYER, PROTECTION BOARD W/ GRAVEL REFILLING, INTERIOR SMOOTH SURFACE W/ CEMENT MORTAR PARGING WHERE REQUIRED.

8" MASONRY WALL STUCCO FINISH ON 190mm CONCRETE BLOCK WALL OR MATCH THE EXTERIOR WALL FINISH (STONE/BRICK)



POWDER COATED BLACK METAL CNC CUT SCREENS 3'WX10'H EACH. CONNECTORS, FASTENERS AND INSTALLATION AS PER MANUFACTURER

NOTE: FOR FOUNDATION WALLS TO BE AS PER STRUCTURAL DRWS.


INTERIOR WALL TYPES

4 1/2" INTERNAL PARTITION WALL 1/2" G.W.B B/S 2x4 WD. STUDS @16" O/C TAPED, PLASTERED, SANDED AND PAINTED. PROVIDE MOISTURE RESISTANT G.W.B I/S WATER BOURNE AREAS E.G BATHS &

6 1/2" INTERIOR WALL - WITH INSULATION 1/2" GWB., SPRAY-FOAM INSULATION R24, GAS PROOF WALL CONSTRUCTION @GARAGE

INTERIOR WALL TYPES

<u>10 1/2" INTERIOR LOAD BEARING WALL</u> 1/2" GWB. B/S 2x10 WD. STUDS @16" O/C TAPED, 〈P3〉 PLASTERED, SANDED AND PAINTED. PROVIDE MOISTURE RESISTANT G.W.B I/S WATER BOURNE AREAS E.G BATHS & KITCHEN

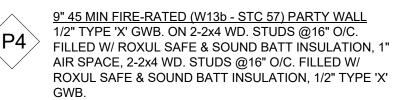

10" 3 HR FIRE-RATED (B4c - STC 50) CMU. 5/8" [15.9mm] TYPE 'X' GWB., 1/2" RESILIENT METAL CHANNEL ON 190mm CONCRETE BLOCK, 1/2" RESILIENT METAL CHANNEL, 5/8" [15.9mm] TYPE 'X' GWB.

10" 1.5 HR FIRE-RATED (B1b - STC 50) CMU. 1/2" GWB. TAPED & PLASTERED ON BOTH SIDES, 3/4"x2" WD. STRAPPING @24" O/C. ON 190mm CONCRETE BLOCK

4 1/2" 1 HR FIRE-RATED PARTITION WALL

(W6h - OBC.2012 SB3 - STC.50) 1/2" REGULER G.W.B B/S TAPED & PLASTERED, RESILIENT CHANNEL AT 24" O/C, 3 1/2" BATT INSULATION FRICTION FIT B/W STUDS @ 24" O/C T/B PLATES, PROVIDE MOISTURE RESISTANT 1/2" G.W.B FOR ALL WATER BOURNE AREAS

FLOORING TYPES

3/4" ENG. WD. FLOOR TO MATCH EXISTING WD. FLOORING COLOUR (T.B.D.) W/T & G JOINTS OVER 1/8" THICK STYROFOAM UNDERLAY OVER 6MIL A.V.B. OVER FLOOR JOIST OR CONC. SLAB




UNFINISHED CONC. FLOORING 4" POURED CONCRETE SLAB, REINFORCED (SEE STRUCT.) MIN.1/2" SCREED BOARD AROUND PERIMETER, MIN. R-10 (RSI-1.76) RIGID FOAM INSULATION UNDER ENTIRE SLAB, COMPACTED COARSE AND GRANULAR STONE INFILL, SOIL GAS\RADON CONTROL AS PER O.B.C 9.1.1.7 AND 9.13.4.

<u> 15 MINUTES FIRE-RATED PORCELAIN TILES FLOORING</u>

INSULATED UNFINISHED CONC. FLOORING 5" CONC. SLAB (SEE STRUCT.), INSTALL R31 RIGID INSULATION MECHANICALLY FASTENED TO CONC. SLAB B/W 2"X6" WD. STUDS 6MIL POLY ABV. NEW 1/2" WATER RESISTANT GWB CEILING ON PLASTERED, TAPED PROVIDE SMOOTH PLASTER

CEILING TYPES

1/2" GWB SMOOTH PLASTERED CEILING ON PLASTERED, TAPED PROVIDE SMOOTH PLASTER

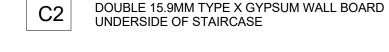

ER EXPOSED RAFTER

ROOF TYPES



PROPOSED SLOPED ROOF CONST. ASPHALT SHINGLES TO MATCH EXISTING #15 BUILDING PAPER, 5/8" EXT. PLYWOOD SHEATHING OVER WD. JOISTS (SEE FLOOR PLANS), R60 INSULATION, 1/2" GWB TAPED & PLASTERED

R2 2" PEA GRAVEL OVER EPDM RUBBERIZED ROOFING ADHERED 3/4" EXTERIOR SHEATHING MIN. SLOPED 2% OVER STRAIGHT ROOF JOISTS FILLED W/ MIN. @ 2LB/SQ.FT. B/W THE ROOF JOISTS 5/8" THICK GWB. CEILING TAPED, SMOOTHED PLASTERED, SANDED AND PAINTED PROJECT ARCHITECTS:

ARCHISYSTEM INC.

CONSULTING ARCHITECTS CERTIFICATE OF PRACTICE # 5465

279 Main Street North Brampton, ON L6X 1N4 Tel: 905-858-2565 Cell: 647-295-2565

www.thearchisystem.com

NOTES:

email: archisystem@gmail.com

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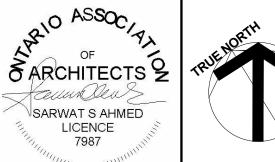
OWNER / CLIENT:

LA CABAN DEVELOPMENTS INC.

STRUCTURAL ENGINEERS:

BUILDING PERMIT 10-10-202

Issued For: O ASSOC OF



PROJECT: TOWNHOUSE **DEVELOPMENT**

61 CLAPHAM RD, HAMILTON,

ON L8G 2H9


DRAWING TITLE:

SHEET NO.

ARCHITECTURAL SET

SHEET TITLE: BASEMENT PLAN

2023019 As indicated SCALE:

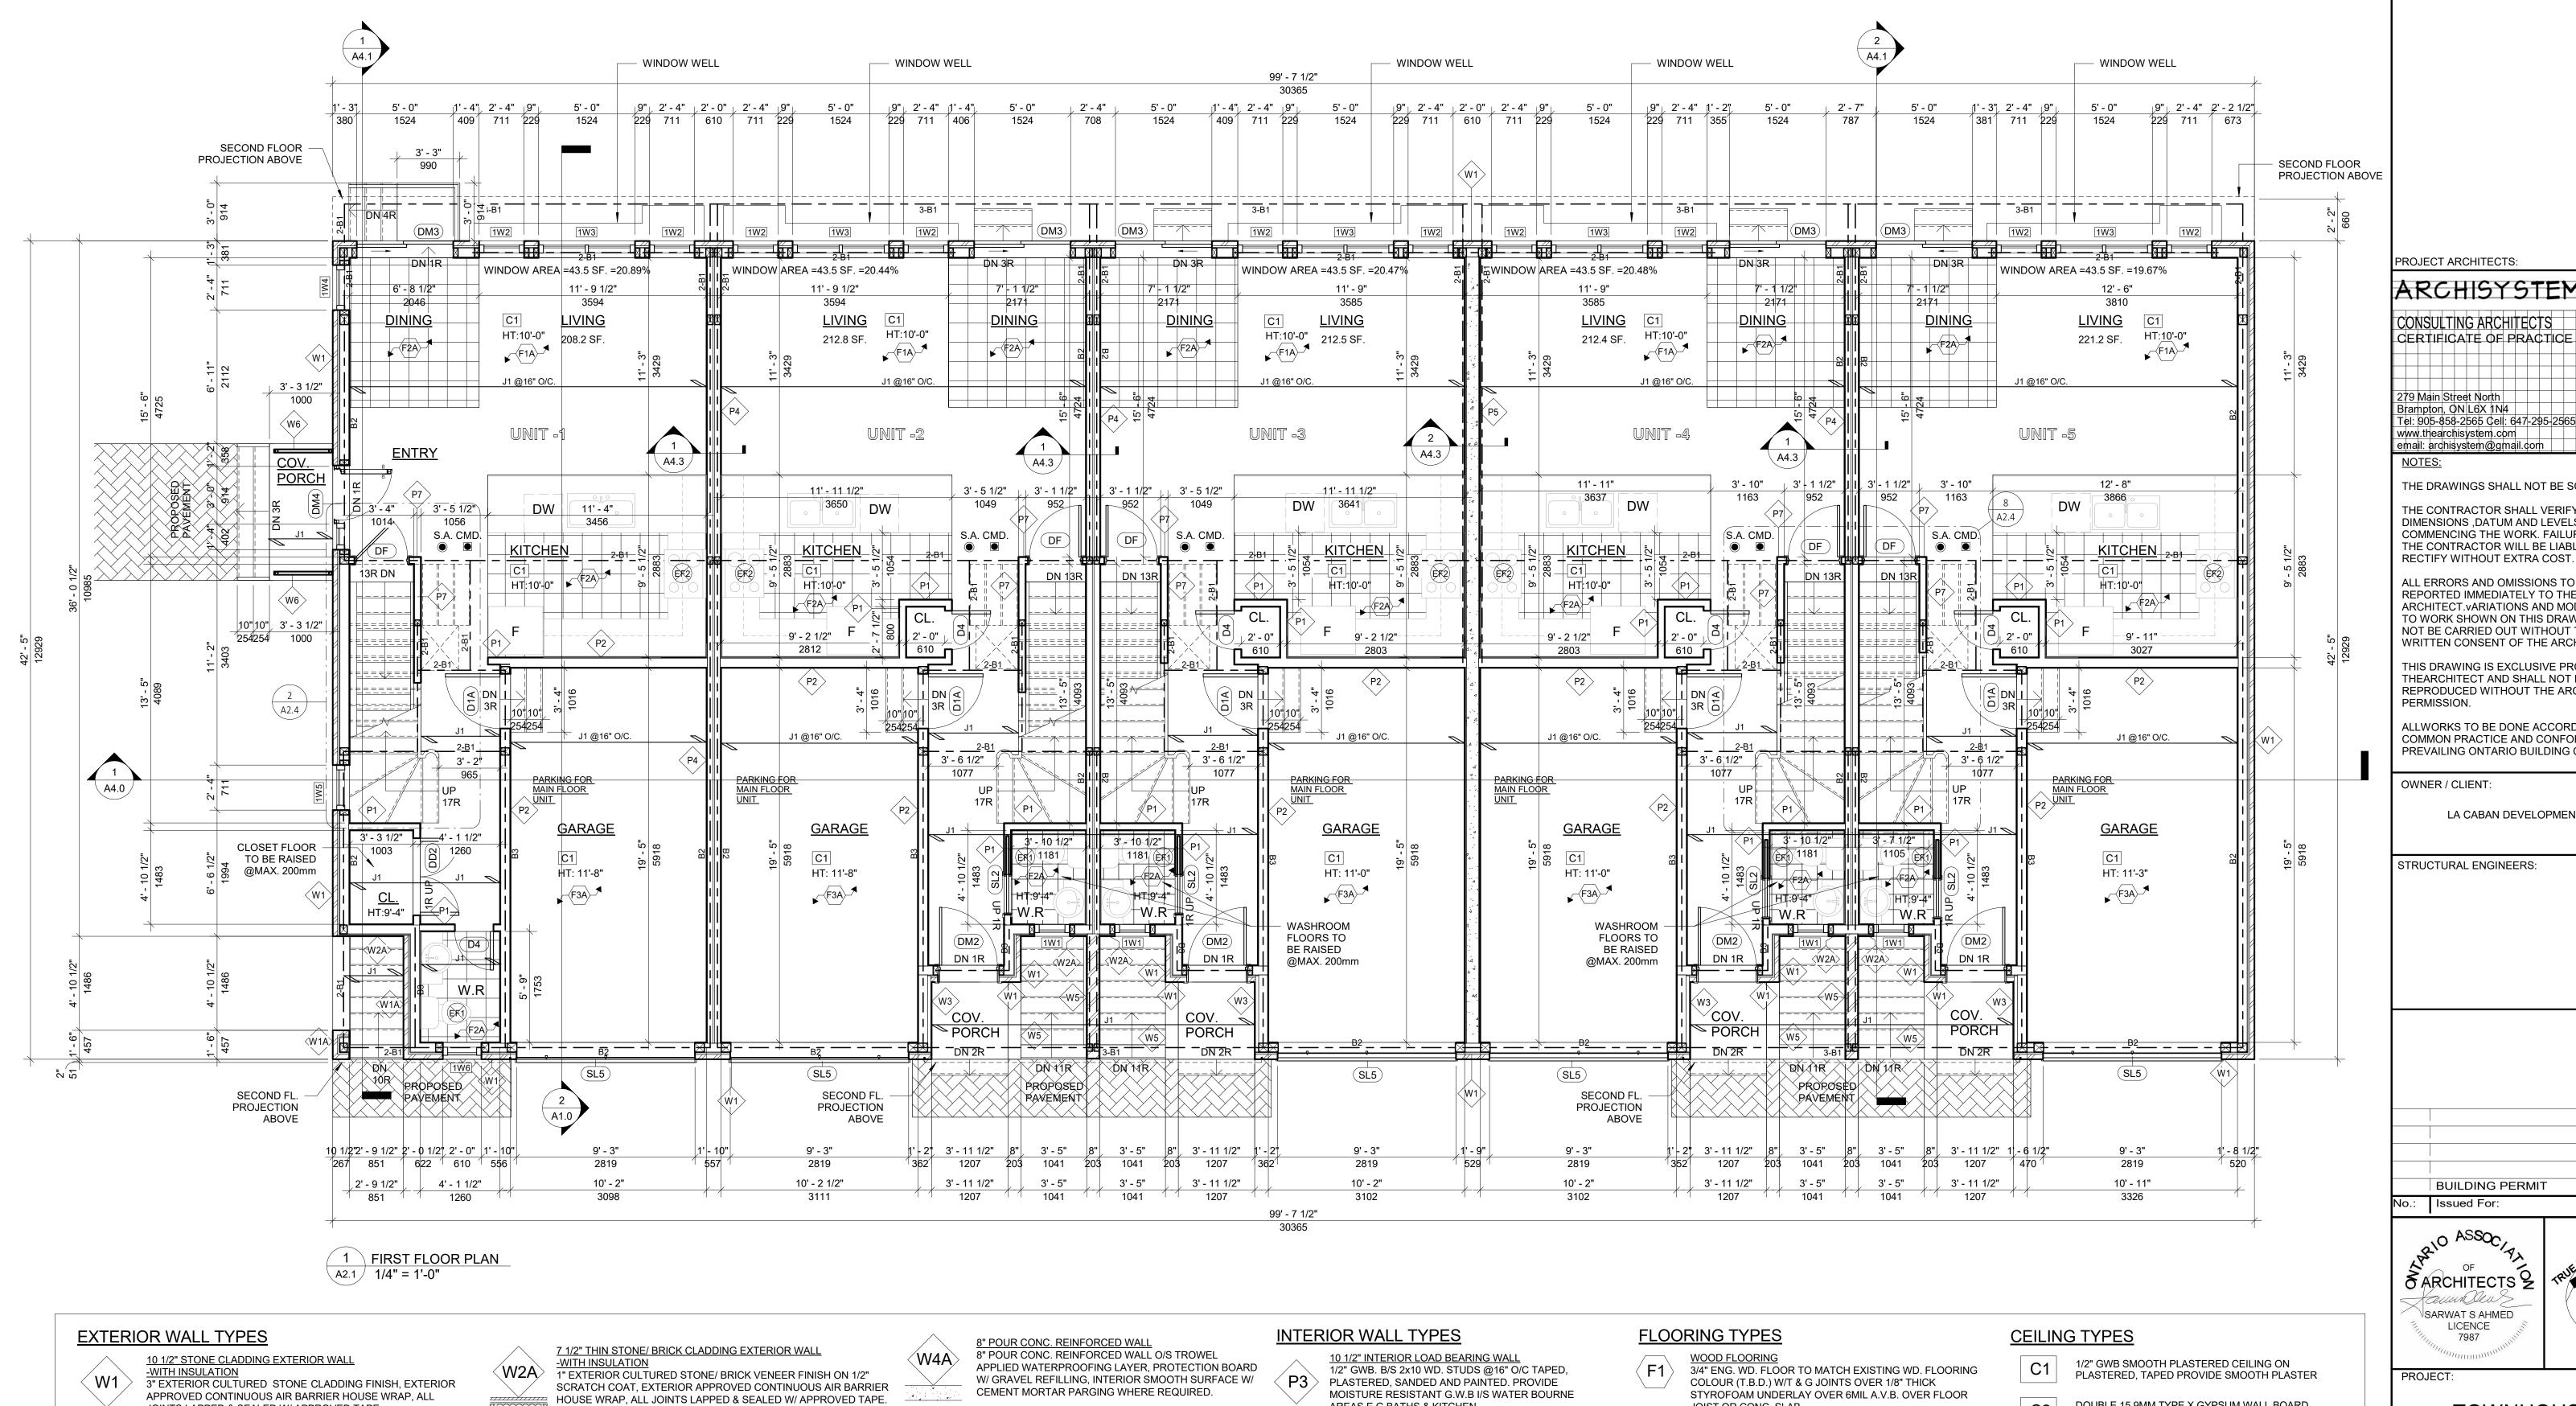



APPROVED CONTINUOUS AIR BARRIER HOUSE WRAP, ALL JOINTS LAPPED & SEALED W/ APPROVED TAPE. · EXTERIOR WALL STUDS 2X6 (38X140) K.D. SPRUCE @16" (406) O.C. W/ SINGLE BOTTOM PLATE & DOUBLE TOP PLATES

· EXTERIOR WALL SHEATHING 1/2"X4'X8' PLYWOOD OR EQ. · R-24 (RSI-4.23) BATT INSULATION · APPROVED 6 MIL. POLYETHYLENE VAPOUR BARRIER, MIN. 1/2"

(12.7) DRYWALL FINISH



10 1/2" STONE/BRICK CLADDING EXTERIOR WALL - WITH OUT INSULATION



10 1/2" BRICK CLADDING EXTERIOR WALL -WITH INSULATION

(12.7) DRYWALL FINISH

3" EXTERIOR CULTURED BRICK CLADDING FINISH, EXTERIOR APPROVED CONTINUOUS AIR BARRIER HOUSE WRAP, ALL JOINTS LAPPED & SEALED W/ APPROVED TAPE.

· EXTERIOR WALL STUDS 2X6 (38X140) K.D. SPRUCE @16" (406) O.C. W/ SINGLE BOTTOM PLATE & DOUBLE TOP PLATES EXTERIOR WALL SHEATHING 1/2"X4'X8' PLYWOOD OR EQ. R-24 (RSI-4.23) BATT INSULATION APPROVED 6 MIL. POLYETHYLENE VAPOUR BARRIER, MIN. 1/2"

8 1/8" STUCCO FINISH EXTERIOR WALL -WITH INSULATION

(12.7) DRYWALL FINISH

· R-24 (RSI-4.23) BATT INSULATION

·1/8" STUCCO OVER 2" RIGID INSULATION DRAINAGE LAYER ·1/2" R-5 XP INSULSHEATHING EXTERIOR SHEATHING ·2"X6" WD. STUDS @ 16" O/C TOP/BOTTOM PLATES ·R24 BATT INSULATION 6MIL POLY AVB. ·1/2" GWB TAPPED & PLASTERED. PROVIDE MOISTURE

-RESISTANT GWB ON ALL WATER-BOURNE AREAS

· 1/2" PLYWOOD ON EXTERIOR WALL STUDS 2x6 K.D. SPRUCE @16"

(406) O.C. W/ SINGLE BOTTOM PLATE & DOUBLE TOP PLATES

· APPROVED 6 MIL. POLYETHYLENE VAPOUR BARRIER, MIN. 1/2"

· EXTERIOR WALL SHEATHING 1/2"X4'X8' PLYWOOD OR EQ.



1-2" POUR CONC. REINFORCED WALL - WITH INSULATION 8" (200) REINFORCED POURED CONCRETE WALLS,

2" CONTINUOUS 2LBS SPRAY FOAM INSULATION, 2x4 WD. STUD WALL OVER 2X4 P|T SILL PLATE, SINGLE BOTTOM AND TOP PLATES @ 16" O|C - C|W R-12 BATT INSULATION. COMBINED R24., 6 MIL POLY VAPOUR BARRIER, MIN. 1/2" DRYWALL FINISH.



STUCCO FINISH ON 190mm CONCRETE BLOCK WALL OR MATCH THE EXTERIOR WALL FINISH (STONE/BRICK)





POWDER COATED BLACK METAL CNC CUT SCREENS 3'WX10'H EACH. CONNECTORS, FASTENERS AND INSTALLATION AS PER MANUFACTURER


NOTE: FOR FOUNDATION WALLS TO BE AS PER STRUCTURAL DRWS.

INTERIOR WALL TYPES

4 1/2" INTERNAL PARTITION WALL 1/2" G.W.B B/S 2x4 WD. STUDS @16" O/C TAPED, PLASTERED, SANDED AND PAINTED. PROVIDE MOISTURE RESISTANT G.W.B I/S WATER BOURNE AREAS E.G BATHS &

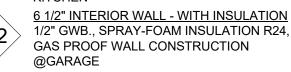

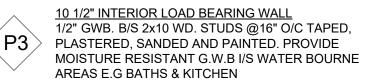

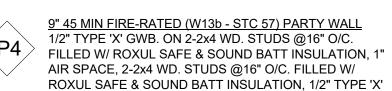


10" 3 HR FIRE-RATED (B4c - STC 50) CMU. 5/8" [15.9mm] TYPE 'X' GWB., 1/2" RESILIENT METAL CHANNEL ON 190mm CONCRETE BLOCK, 1/2" RESILIENT METAL CHANNEL, 5/8" [15.9mm] TYPE 'X' GWB.

10" 1.5 HR FIRE-RATED (B1b - STC 50) CMU. 1/2" GWB. TAPED & PLASTERED ON BOTH SIDES, 3/4"x2" WD. STRAPPING @24" O/C. ON 190mm CONCRETE BLOCK

4 1/2" 1 HR FIRE-RATED PARTITION WALL

(W6h - OBC.2012 SB3 - STC.50) 1/2" REGULER G.W.B B/S TAPED & PLASTERED, RESILIENT CHANNEL AT 24" O/C, 3 1/2" BATT INSULATION FRICTION FIT B/W STUDS @ 24" O/C T/B PLATES, PROVIDE MOISTURE RESISTANT 1/2" G.W.B FOR ALL WATER BOURNE AREAS

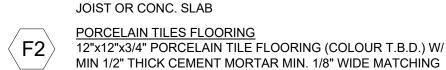

UNFINISHED CONC. FLOORING 4" POURED CONCRETE SLAB, REINFORCED (SEE STRUCT.) MIN.1/2" SCREED BOARD AROUND PERIMETER, MIN. R-10 (RSI-1.76) RIGID FOAM INSULATION UNDER ENTIRE SLAB, COMPACTED COARSE AND GRANULAR STONE INFILL, SOIL

GROUTED JOINTS OVER FLOOR JOIST OR CONC. SLAB

GAS\RADON CONTROL AS PER O.B.C 9.1.1.7 AND 9.13.4. 45 MINUTES FIRE-RATED WOOD FLOORING

SMOOTH PLASTER

45 MINUTES FIRE-RATED PORCELAIN TILES FLOORING <u>- F17d (51 STC)</u>

INSULATED UNFINISHED CONC. FLOORING 5" CONC. SLAB (SEE STRUCT.), INSTALL R31 RIGID INSULATION MECHANICALLY FASTENED TO CONC. SLAB B/W 2"X6" WD. STUDS 6MIL POLY ABV. NEW 1/2" WATER RESISTANT GWB CEILING ON PLASTERED, TAPED PROVIDE




ER EXPOSED RAFTER

ROOF TYPES



PROPOSED SLOPED ROOF CONST. ASPHALT SHINGLES TO MATCH EXISTING #15 BUILDING PAPER, 5/8" EXT. PLYWOOD SHEATHING OVER WD. JOISTS (SEE FLOOR PLANS), R60 INSULATION, 1/2" GWB TAPED & PLASTERED

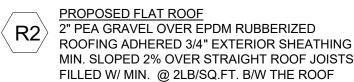

JOISTS 5/8" THICK GWB. CEILING TAPED,

SMOOTHED PLASTERED, SANDED AND PAINTED

PROJECT ARCHITECTS:

ARCHISYSTEM INC.

CONSULTING ARCHITECTS CERTIFICATE OF PRACTICE # 5465 279 Main Street North Brampton, ON L6X 1N4 ГеІ: 905-858-2565 СеІІ: 647-295-2565

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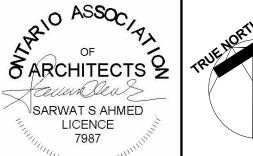
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OWNER / CLIENT:

LA CABAN DEVELOPMENTS INC.

STRUCTURAL ENGINEERS:

BUILDING PERMIT 10-10-202 Issued For:



TOWNHOUSE **DEVELOPMENT**

61 CLAPHAM RD, HAMILTON, ON L8G 2H9


DRAWING TITLE:

ARCHITECTURAL SET

SHEET TITLE: FIRST FLOOR PLAN

2023019 As indicated


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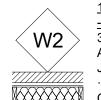
WITH INSULATION

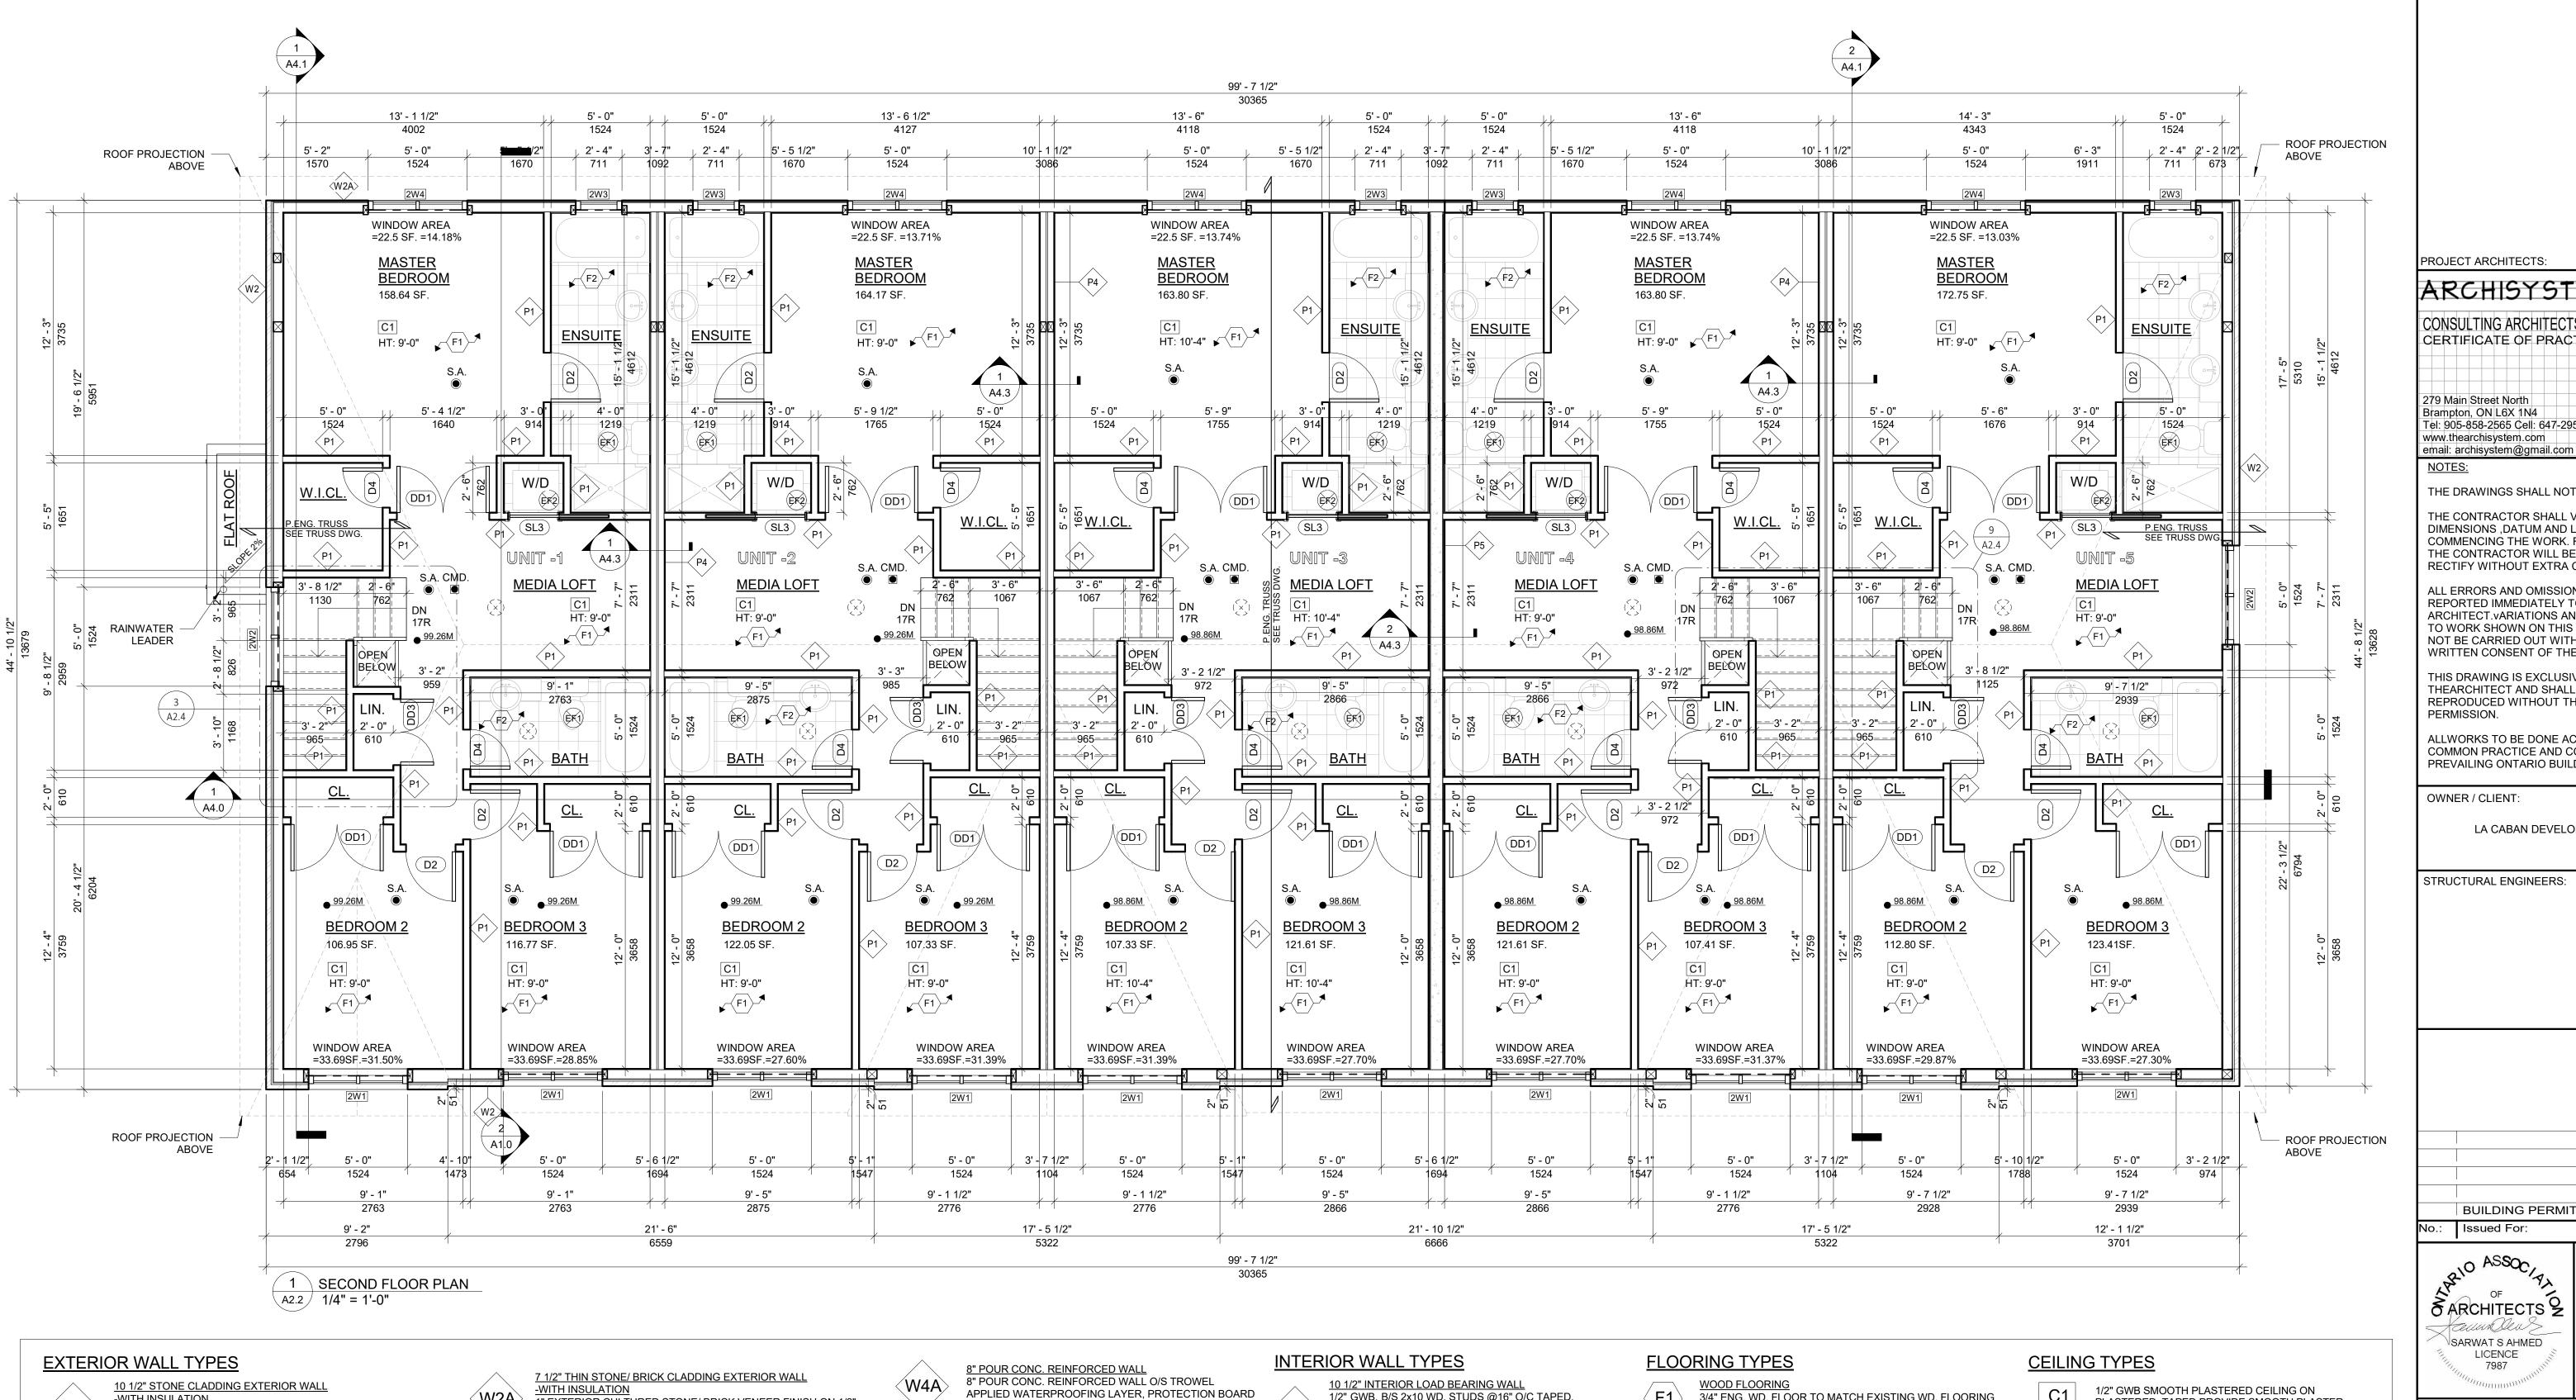3" EXTERIOR CULTURED STONE CLADDING FINISH, EXTERIOR APPROVED CONTINUOUS AIR BARRIER HOUSE WRAP, ALL JOINTS LAPPED & SEALED W/ APPROVED TAPE. · EXTERIOR WALL STUDS 2X6 (38X140) K.D. SPRUCE @16" (406) O.C. W/ SINGLE BOTTOM PLATE & DOUBLE TOP PLATES

· EXTERIOR WALL SHEATHING 1/2"X4'X8' PLYWOOD OR EQ. · R-24 (RSI-4.23) BATT INSULATION · APPROVED 6 MIL. POLYETHYLENE VAPOUR BARRIER, MIN. 1/2" (12.7) DRYWALL FINISH




10 1/2" STONE/BRICK CLADDING EXTERIOR WALL

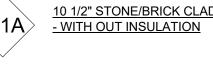

10 1/2" BRICK CLADDING EXTERIOR WALL <u>-WITH INSULATION</u>

3" EXTERIOR CULTURED BRICK CLADDING FINISH, EXTERIOR APPROVED CONTINUOUS AIR BARRIER HOUSE WRAP, ALL JOINTS LAPPED & SEALED W/ APPROVED TAPE. · EXTERIOR WALL STUDS 2X6 (38X140) K.D. SPRUCE @16" (406) O.C. W/ SINGLE BOTTOM PLATE & DOUBLE TOP PLATES

· EXTERIOR WALL SHEATHING 1/2"X4'X8' PLYWOOD OR EQ. · R-24 (RSI-4.23) BATT INSULATION · APPROVED 6 MIL. POLYETHYLENE VAPOUR BARRIER, MIN. 1/2" (12.7) DRYWALL FINISH

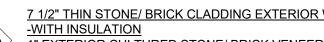

8 1/8" STUCCO FINISH EXTERIOR WALL

·R24 BATT INSULATION 6MIL POLY AVB.

·2"X6" WD. STUDS @ 16" O/C TOP/BOTTOM PLATES

-RESISTANT GWB ON ALL WATER-BOURNE AREAS

8" (200) REINFORCED POURED CONCRETE WALLS,

·1/2" GWB TAPPED & PLASTERED. PROVIDE MOISTURE

1-2" POUR CONC. REINFORCED WALL - WITH INSULATION

2" CONTINUOUS 2LBS SPRAY FOAM INSULATION, 2x4 WD. STUD

R24., 6 MIL POLY VAPOUR BARRIER, MIN. 1/2" DRYWALL FINISH.

WALL OVER 2X4 P|T SILL PLATE, SINGLE BOTTOM AND TOP

PLATES @ 16" O|C - C|W R-12 BATT INSULATION. COMBINED

(12.7) DRYWALL FINISH

1" EXTERIOR CULTURED STONE/ BRICK VENEER FINISH ON 1/2" SCRATCH COAT, EXTERIOR APPROVED CONTINUOUS AIR BARRIER HOUSE WRAP, ALL JOINTS LAPPED & SEALED W/ APPROVED TAPE. · 1/2" PLYWOOD ON EXTERIOR WALL STUDS 2x6 K.D. SPRUCE @16" (406) O.C. W/ SINGLE BOTTOM PLATE & DOUBLE TOP PLATES · EXTERIOR WALL SHEATHING 1/2"X4'X8' PLYWOOD OR EQ. · R-24 (RSI-4.23) BATT INSULATION

· APPROVED 6 MIL. POLYETHYLENE VAPOUR BARRIER, MIN. 1/2"

 \cdot 1/8" STUCCO OVER 2" RIGID INSULATION DRAINAGE LAYER ·1/2" R-5 XP INSULSHEATHING EXTERIOR SHEATHING

POWDER COATED BLACK METAL CNC CUT SCREENS 3'WX10'H EACH. CONNECTORS, FASTENERS AND INSTALLATION AS PER MANUFACTURER

CEMENT MORTAR PARGING WHERE REQUIRED.

STUCCO FINISH ON 190mm CONCRETE BLOCK WALL

OR MATCH THE EXTERIOR WALL FINISH (STONE/BRICK)

W/ GRAVEL REFILLING, INTERIOR SMOOTH SURFACE W/

NOTE: FOR FOUNDATION WALLS TO BE AS PER STRUCTURAL DRWS.

INTERIOR WALL TYPES

8" MASONRY WALL

4 1/2" INTERNAL PARTITION WALL 1/2" G.W.B B/S 2x4 WD. STUDS @16" O/C TAPED, PLASTERED, SANDED AND PAINTED. PROVIDE MOISTURE RESISTANT G.W.B I/S WATER BOURNE AREAS E.G BATHS &

6 1/2" INTERIOR WALL - WITH INSULATION 1/2" GWB., SPRAY-FOAM INSULATION R24, GAS PROOF WALL CONSTRUCTION @GARAGE

1/2" GWB. B/S 2x10 WD. STUDS @16" O/C TAPED, 〈P3〉 PLASTERED, SANDED AND PAINTED. PROVIDE MOISTURE RESISTANT G.W.B I/S WATER BOURNE AREAS E.G BATHS & KITCHEN

9" 45 MIN FIRE-RATED (W13b - STC 57) PARTY WALL 1/2" TYPE 'X' GWB. ON 2-2x4 WD. STUDS @16" O/C. FILLED W/ ROXUL SAFE & SOUND BATT INSULATION, 1" AIR SPACE, 2-2x4 WD. STUDS @16" O/C. FILLED W/ ROXUL SAFE & SOUND BATT INSULATION, 1/2" TYPE 'X'

10" 3 HR FIRE-RATED (B4c - STC 50) CMU. 5/8" [15.9mm] TYPE 'X' GWB., 1/2" RESILIENT METAL CHANNEL ON 190mm CONCRETE BLOCK, 1/2" RESILIENT METAL CHANNEL, 5/8" [15.9mm] TYPE 'X' GWB.

10" 1.5 HR FIRE-RATED (B1b - STC 50) CMU. 1/2" GWB. TAPED & PLASTERED ON BOTH SIDES, 3/4"x2" WD. STRAPPING @24" O/C. ON 190mm CONCRETE BLOCK

4 1/2" 1 HR FIRE-RATED PARTITION WALL

(W6h - OBC.2012 SB3 - STC.50) 1/2" REGULER G.W.B B/S TAPED & PLASTERED, RESILIENT CHANNEL AT 24" O/C, 3 1/2" BATT INSULATION FRICTION FIT B/W STUDS @ 24" O/C T/B PLATES, PROVIDE MOISTURE RESISTANT 1/2" G.W.B FOR ALL WATER BOURNE AREAS

3/4" ENG. WD. FLOOR TO MATCH EXISTING WD. FLOORING COLOUR (T.B.D.) W/T & G JOINTS OVER 1/8" THICK STYROFOAM UNDERLAY OVER 6MIL A.V.B. OVER FLOOR JOIST OR CONC. SLAB

PORCELAIN TILES FLOORING 12"x12"x3/4" PORCELAIN TILE FLOORING (COLOUR T.B.D.) W/ MIN 1/2" THICK CEMENT MORTAR MIN. 1/8" WIDE MATCHING GROUTED JOINTS OVER FLOOR JOIST OR CONC. SLAB

UNFINISHED CONC. FLOORING 4" POURED CONCRETE SLAB, REINFORCED (SEE STRUCT.) MIN.1/2" SCREED BOARD AROUND PERIMETER, MIN. R-10 (RSI-1.76) RIGID FOAM INSULATION UNDER ENTIRE SLAB, COMPACTED COARSE AND GRANULAR STONE INFILL, SOIL GAS\RADON CONTROL AS PER O.B.C 9.1.1.7 AND 9.13.4.

<u> 15 MINUTES FIRE-RATED PORCELAIN TILES FLOORING</u>

INSULATED UNFINISHED CONC. FLOORING 5" CONC. SLAB (SEE STRUCT.), INSTALL R31 RIGID INSULATION MECHANICALLY FASTENED TO CONC. SLAB B/W 2"X6" WD. STUDS 6MIL POLY ABV. NEW 1/2" WATER RESISTANT GWB CEILING ON PLASTERED, TAPED PROVIDE SMOOTH PLASTER

1/2" GWB SMOOTH PLASTERED CEILING ON PLASTERED, TAPED PROVIDE SMOOTH PLASTER

DOUBLE 15.9MM TYPE X GYPSUM WALL BOARD UNDERSIDE OF STAIRCASE

ER EXPOSED RAFTER

ROOF TYPES

PROPOSED SLOPED ROOF CONST. ASPHALT SHINGLES TO MATCH EXISTING #15 BUILDING PAPER, 5/8" EXT. PLYWOOD SHEATHING OVER WD. JOISTS (SEE FLOOR PLANS), R60 INSULATION, 1/2" GWB TAPED & PLASTERED

R2 2" PEA GRAVEL OVER EPDM RUBBERIZED ROOFING ADHERED 3/4" EXTERIOR SHEATHING MIN. SLOPED 2% OVER STRAIGHT ROOF JOISTS FILLED W/ MIN. @ 2LB/SQ.FT. B/W THE ROOF JOISTS 5/8" THICK GWB. CEILING TAPED,

SMOOTHED PLASTERED, SANDED AND PAINTED

PROJECT ARCHITECTS:

ARCHISYSTEM INC.

CONSULTING ARCHITECTS CERTIFICATE OF PRACTICE # 5465

279 Main Street North Brampton, ON L6X 1N4 Tel: 905-858-2565 Cell: 647-295-2565 www.thearchisystem.com

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OWNER / CLIENT:

LA CABAN DEVELOPMENTS INC.

STRUCTURAL ENGINEERS:

BUILDING PERMIT 10-10-202





PROJECT:

Issued For:

TOWNHOUSE **DEVELOPMENT**

61 CLAPHAM RD, HAMILTON, ON L8G 2H9


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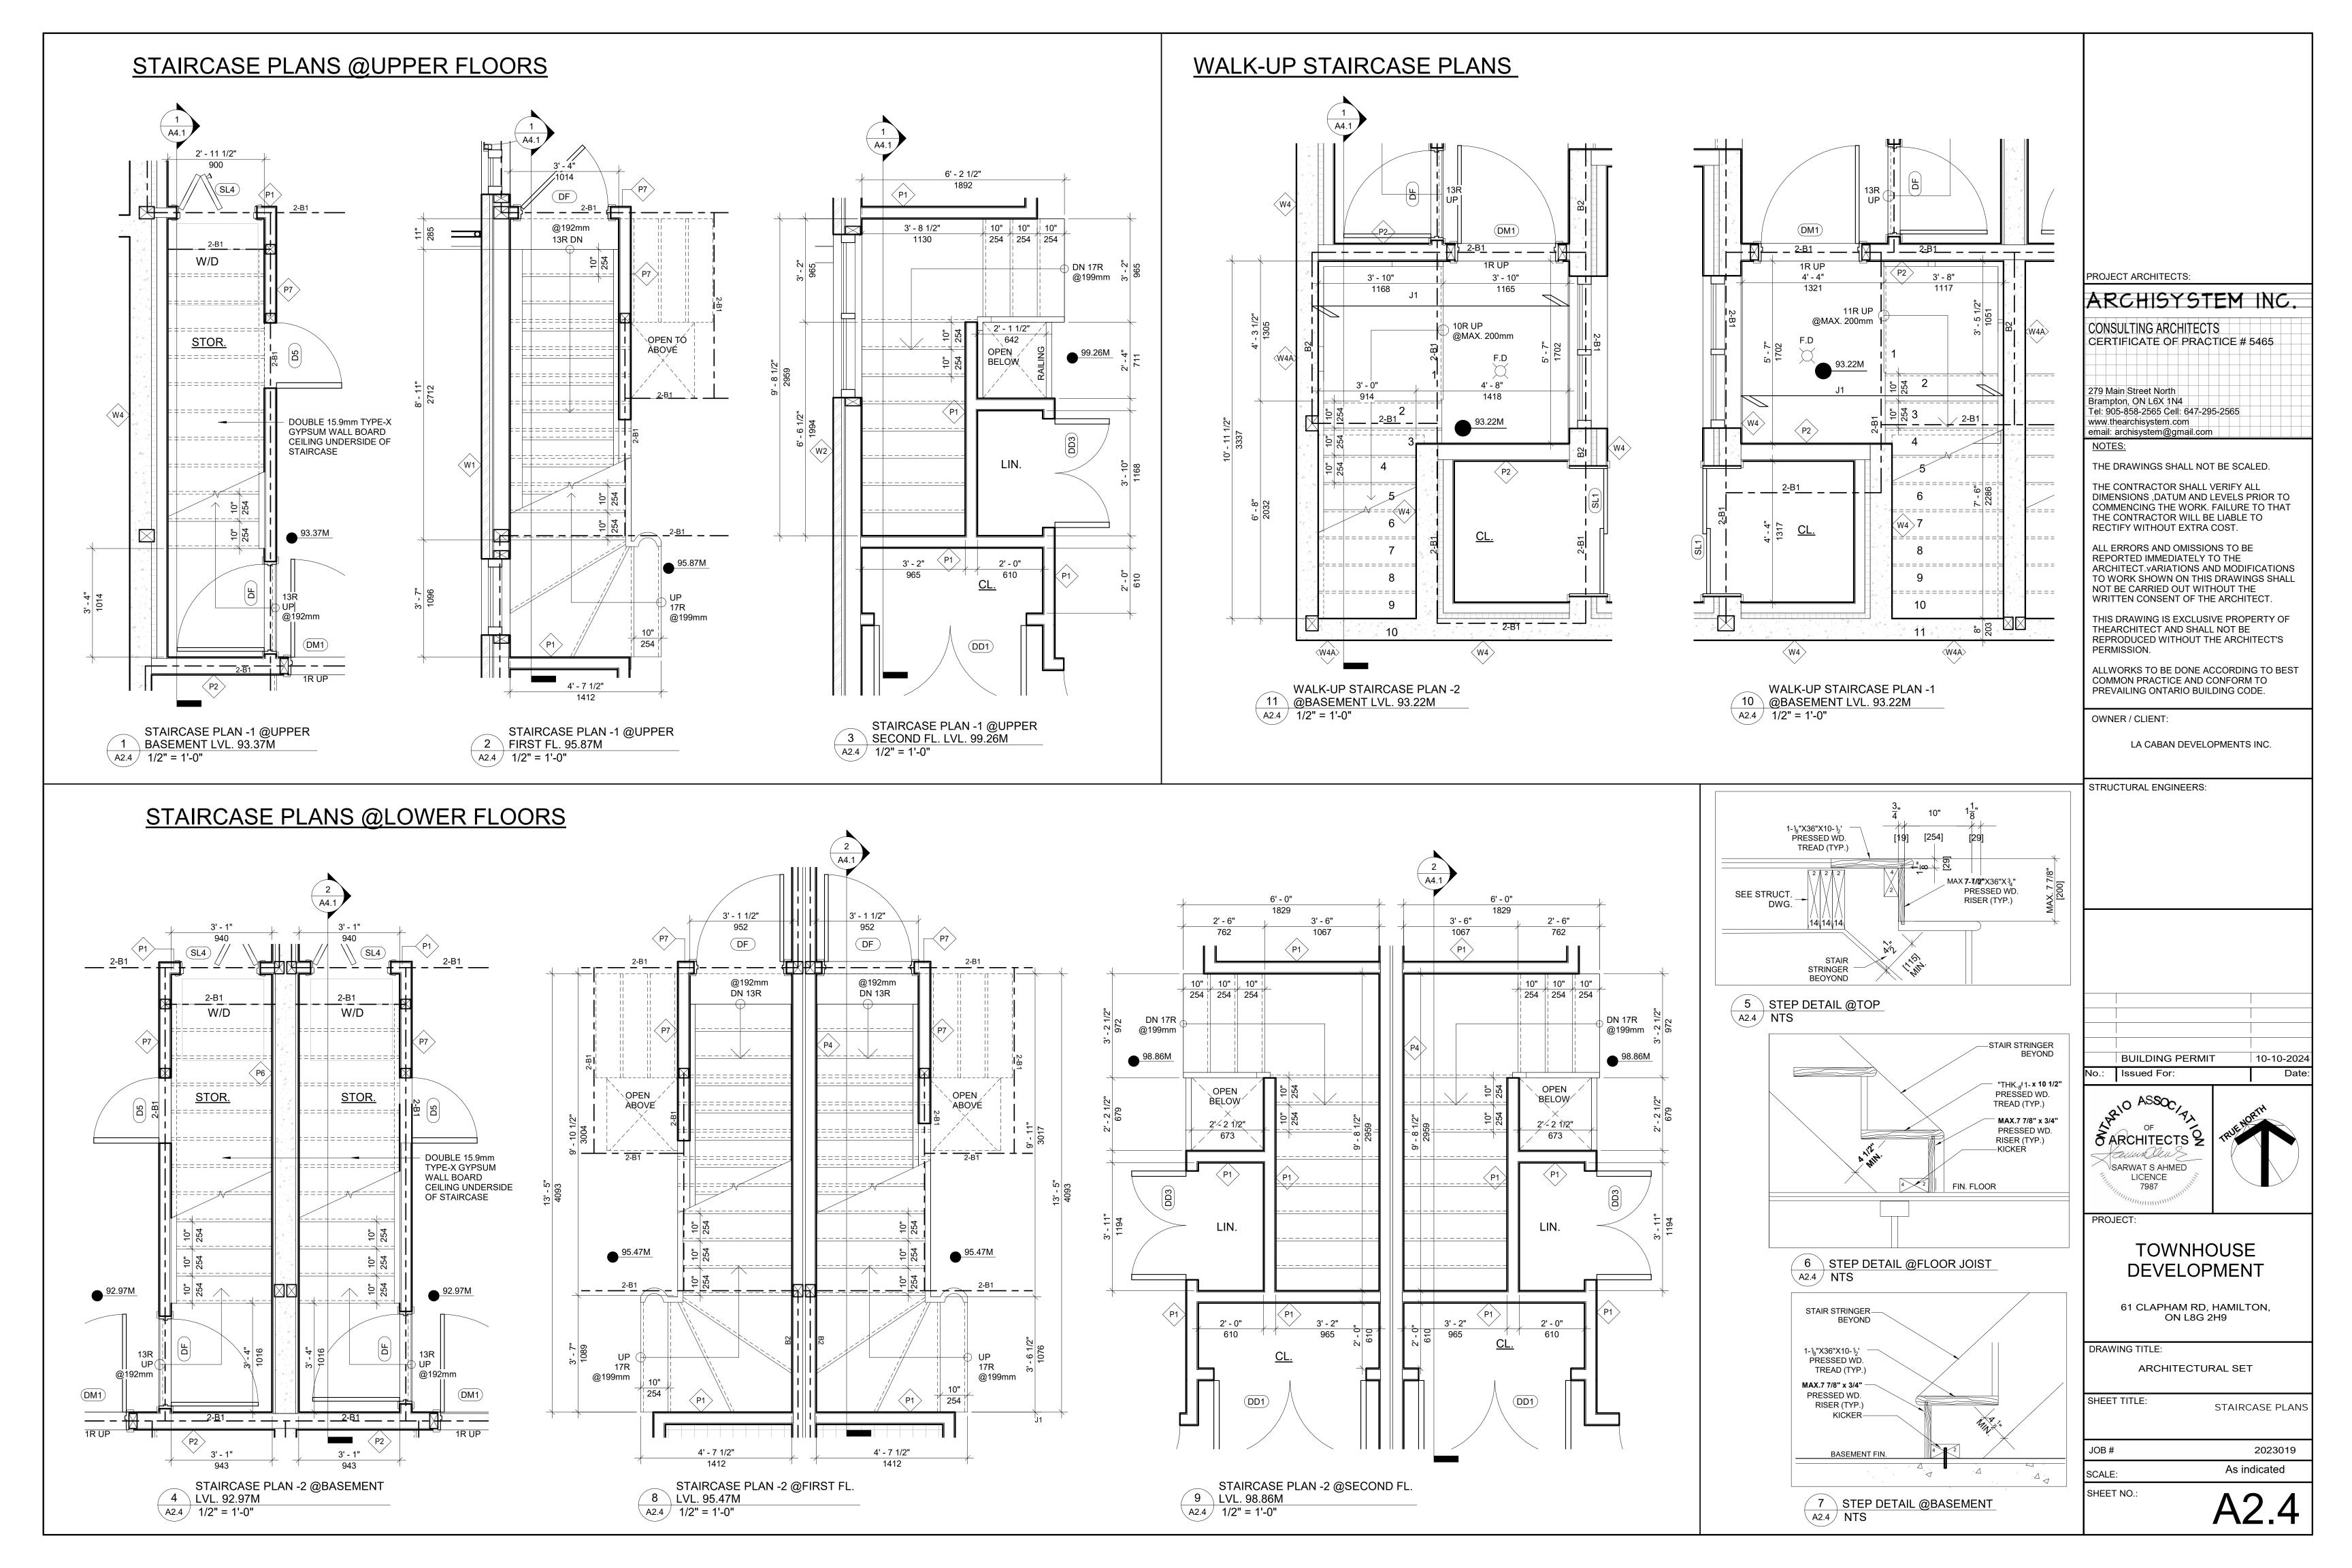
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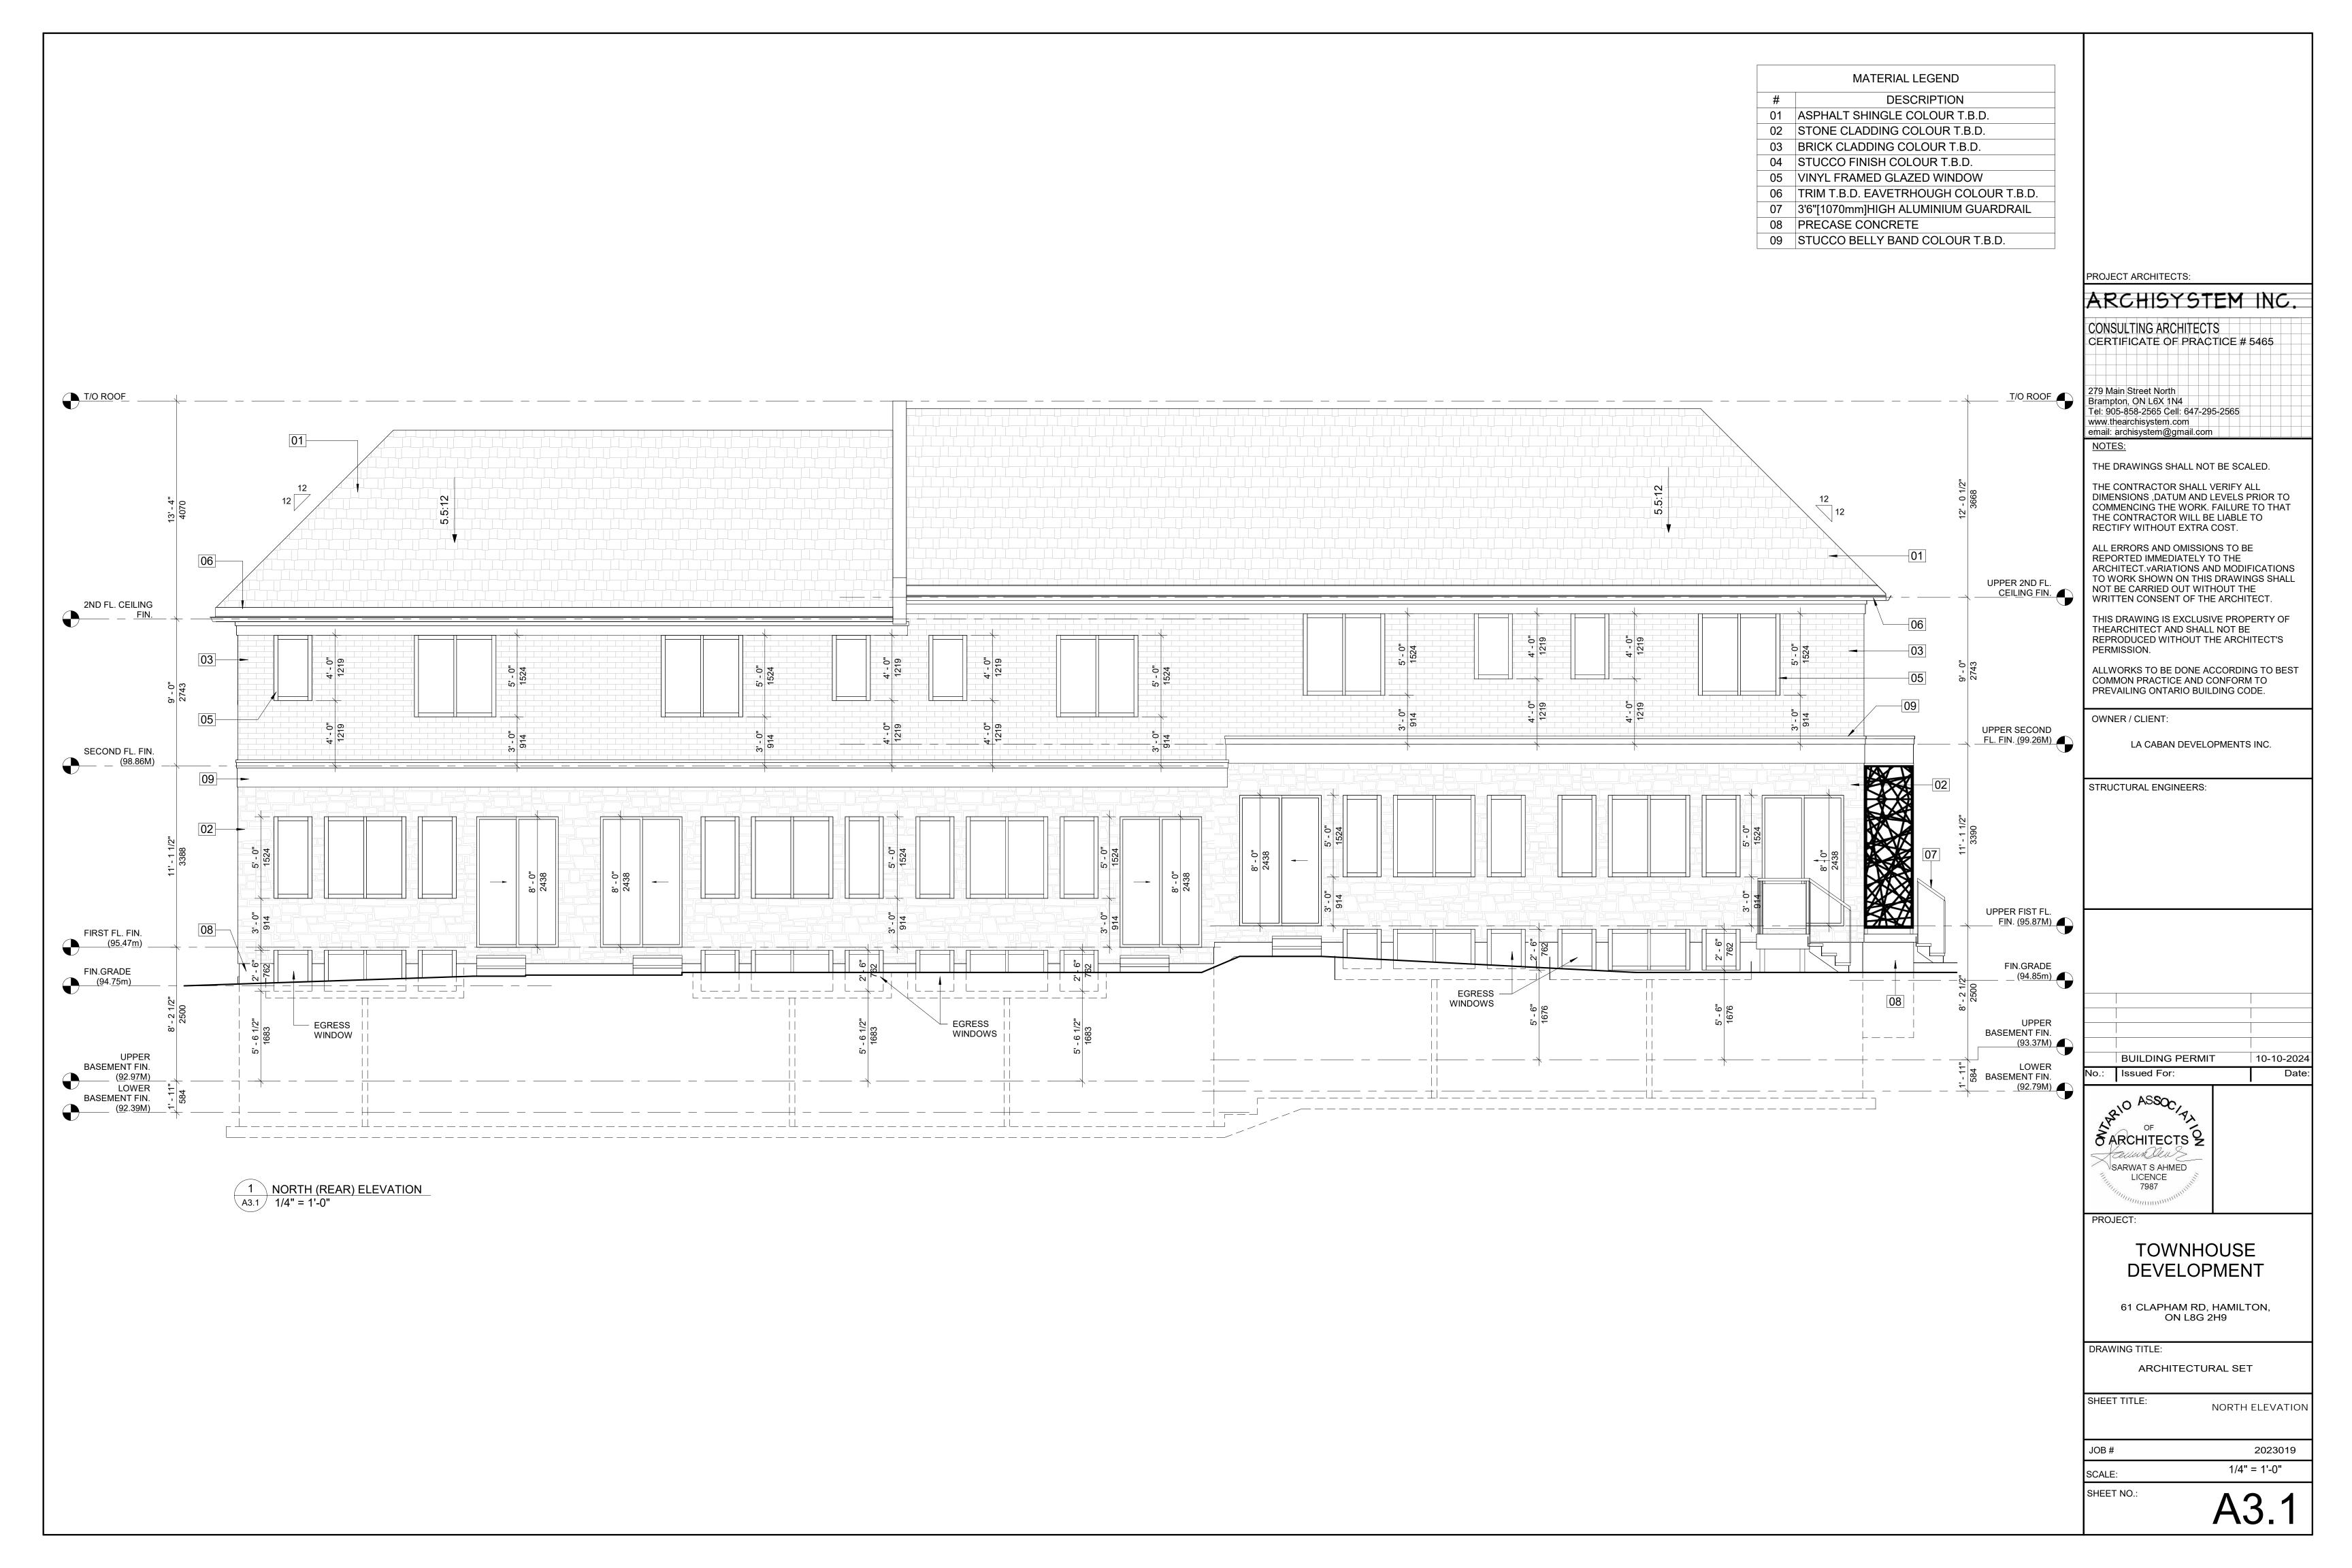
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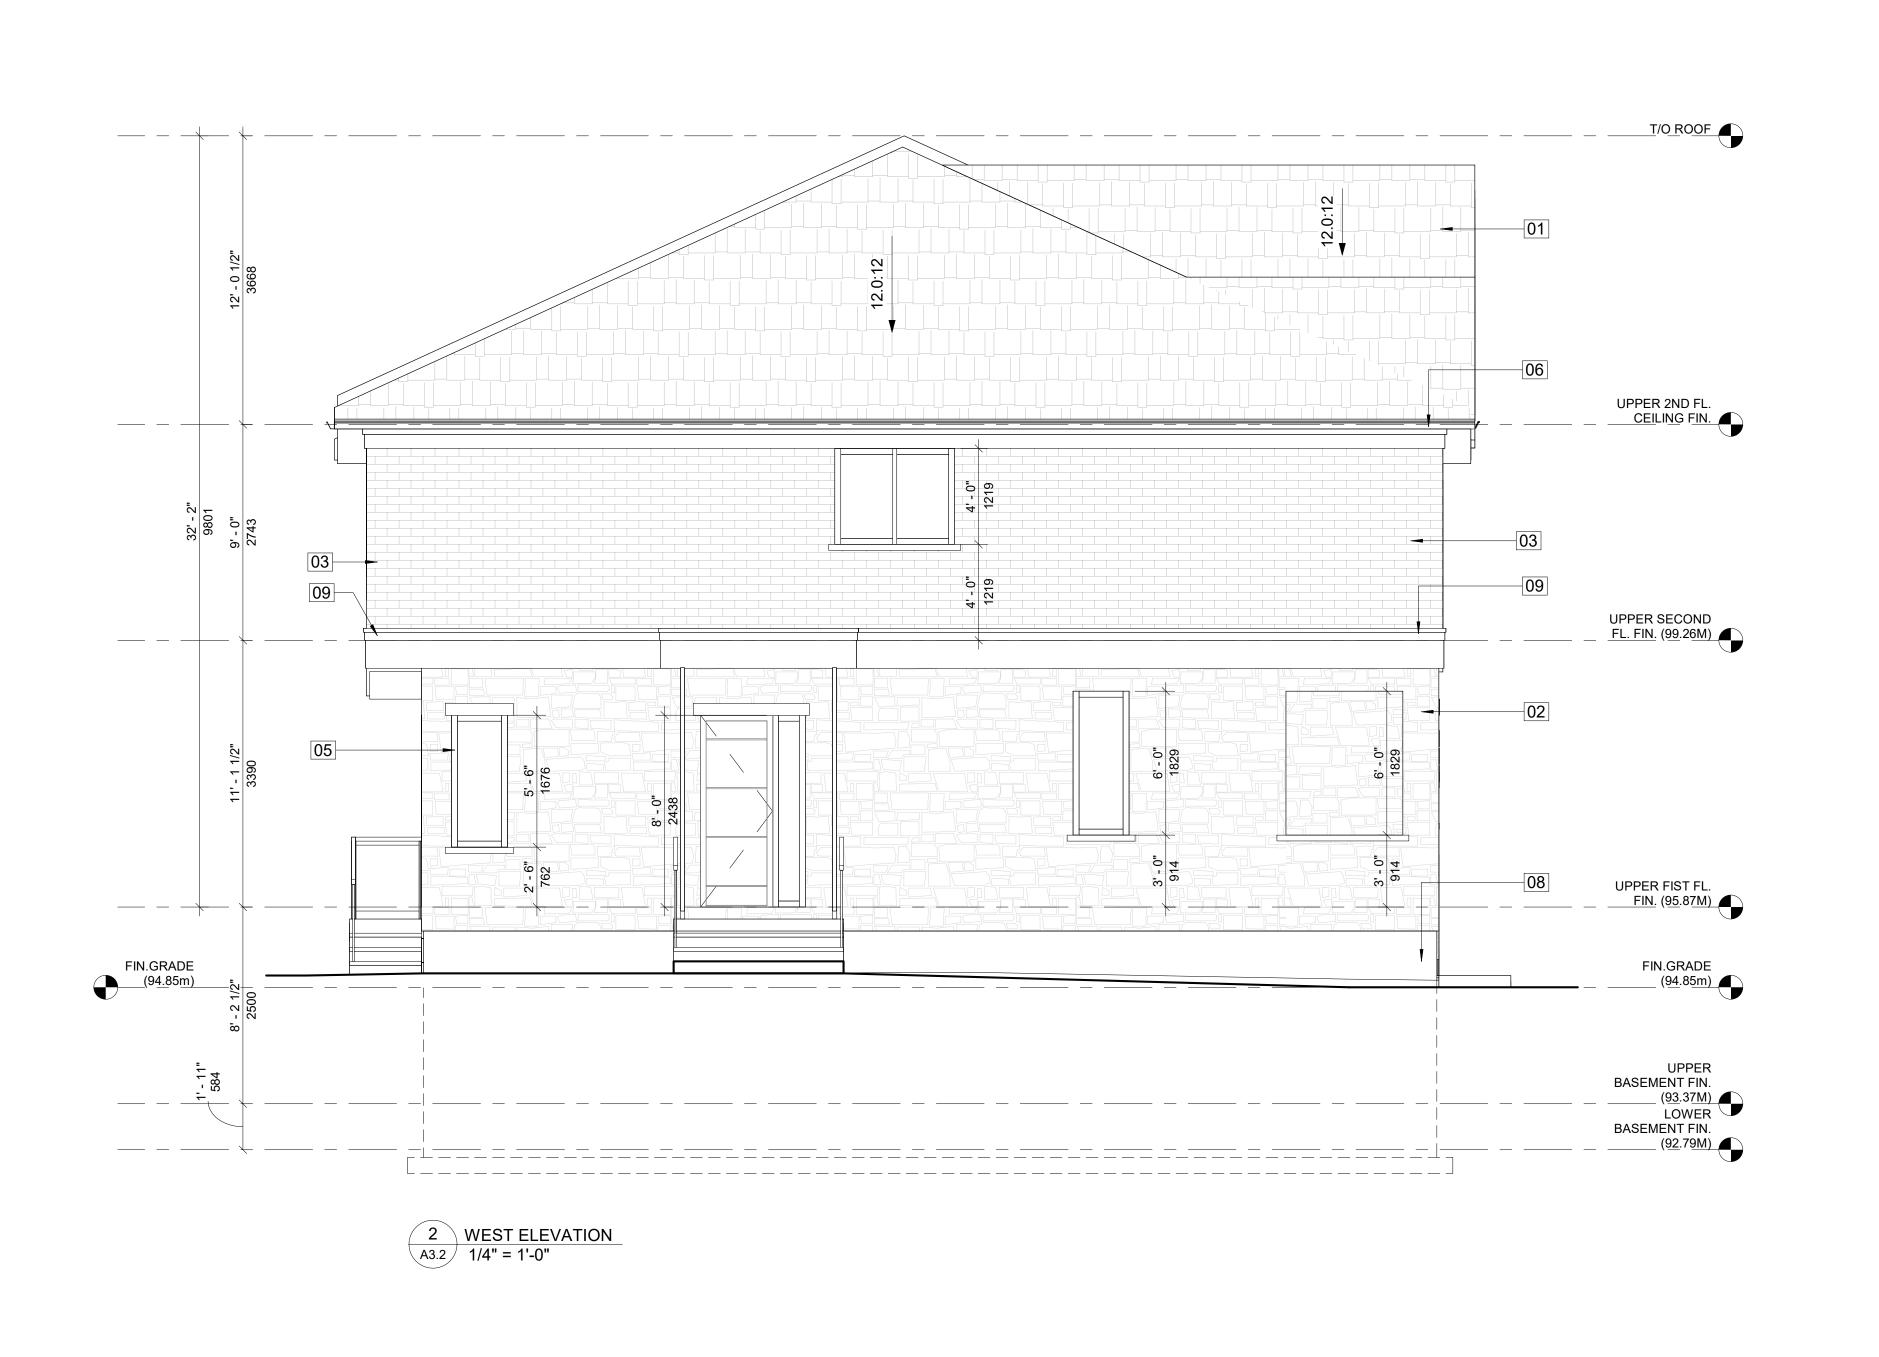
2023019 As indicated SCALE:









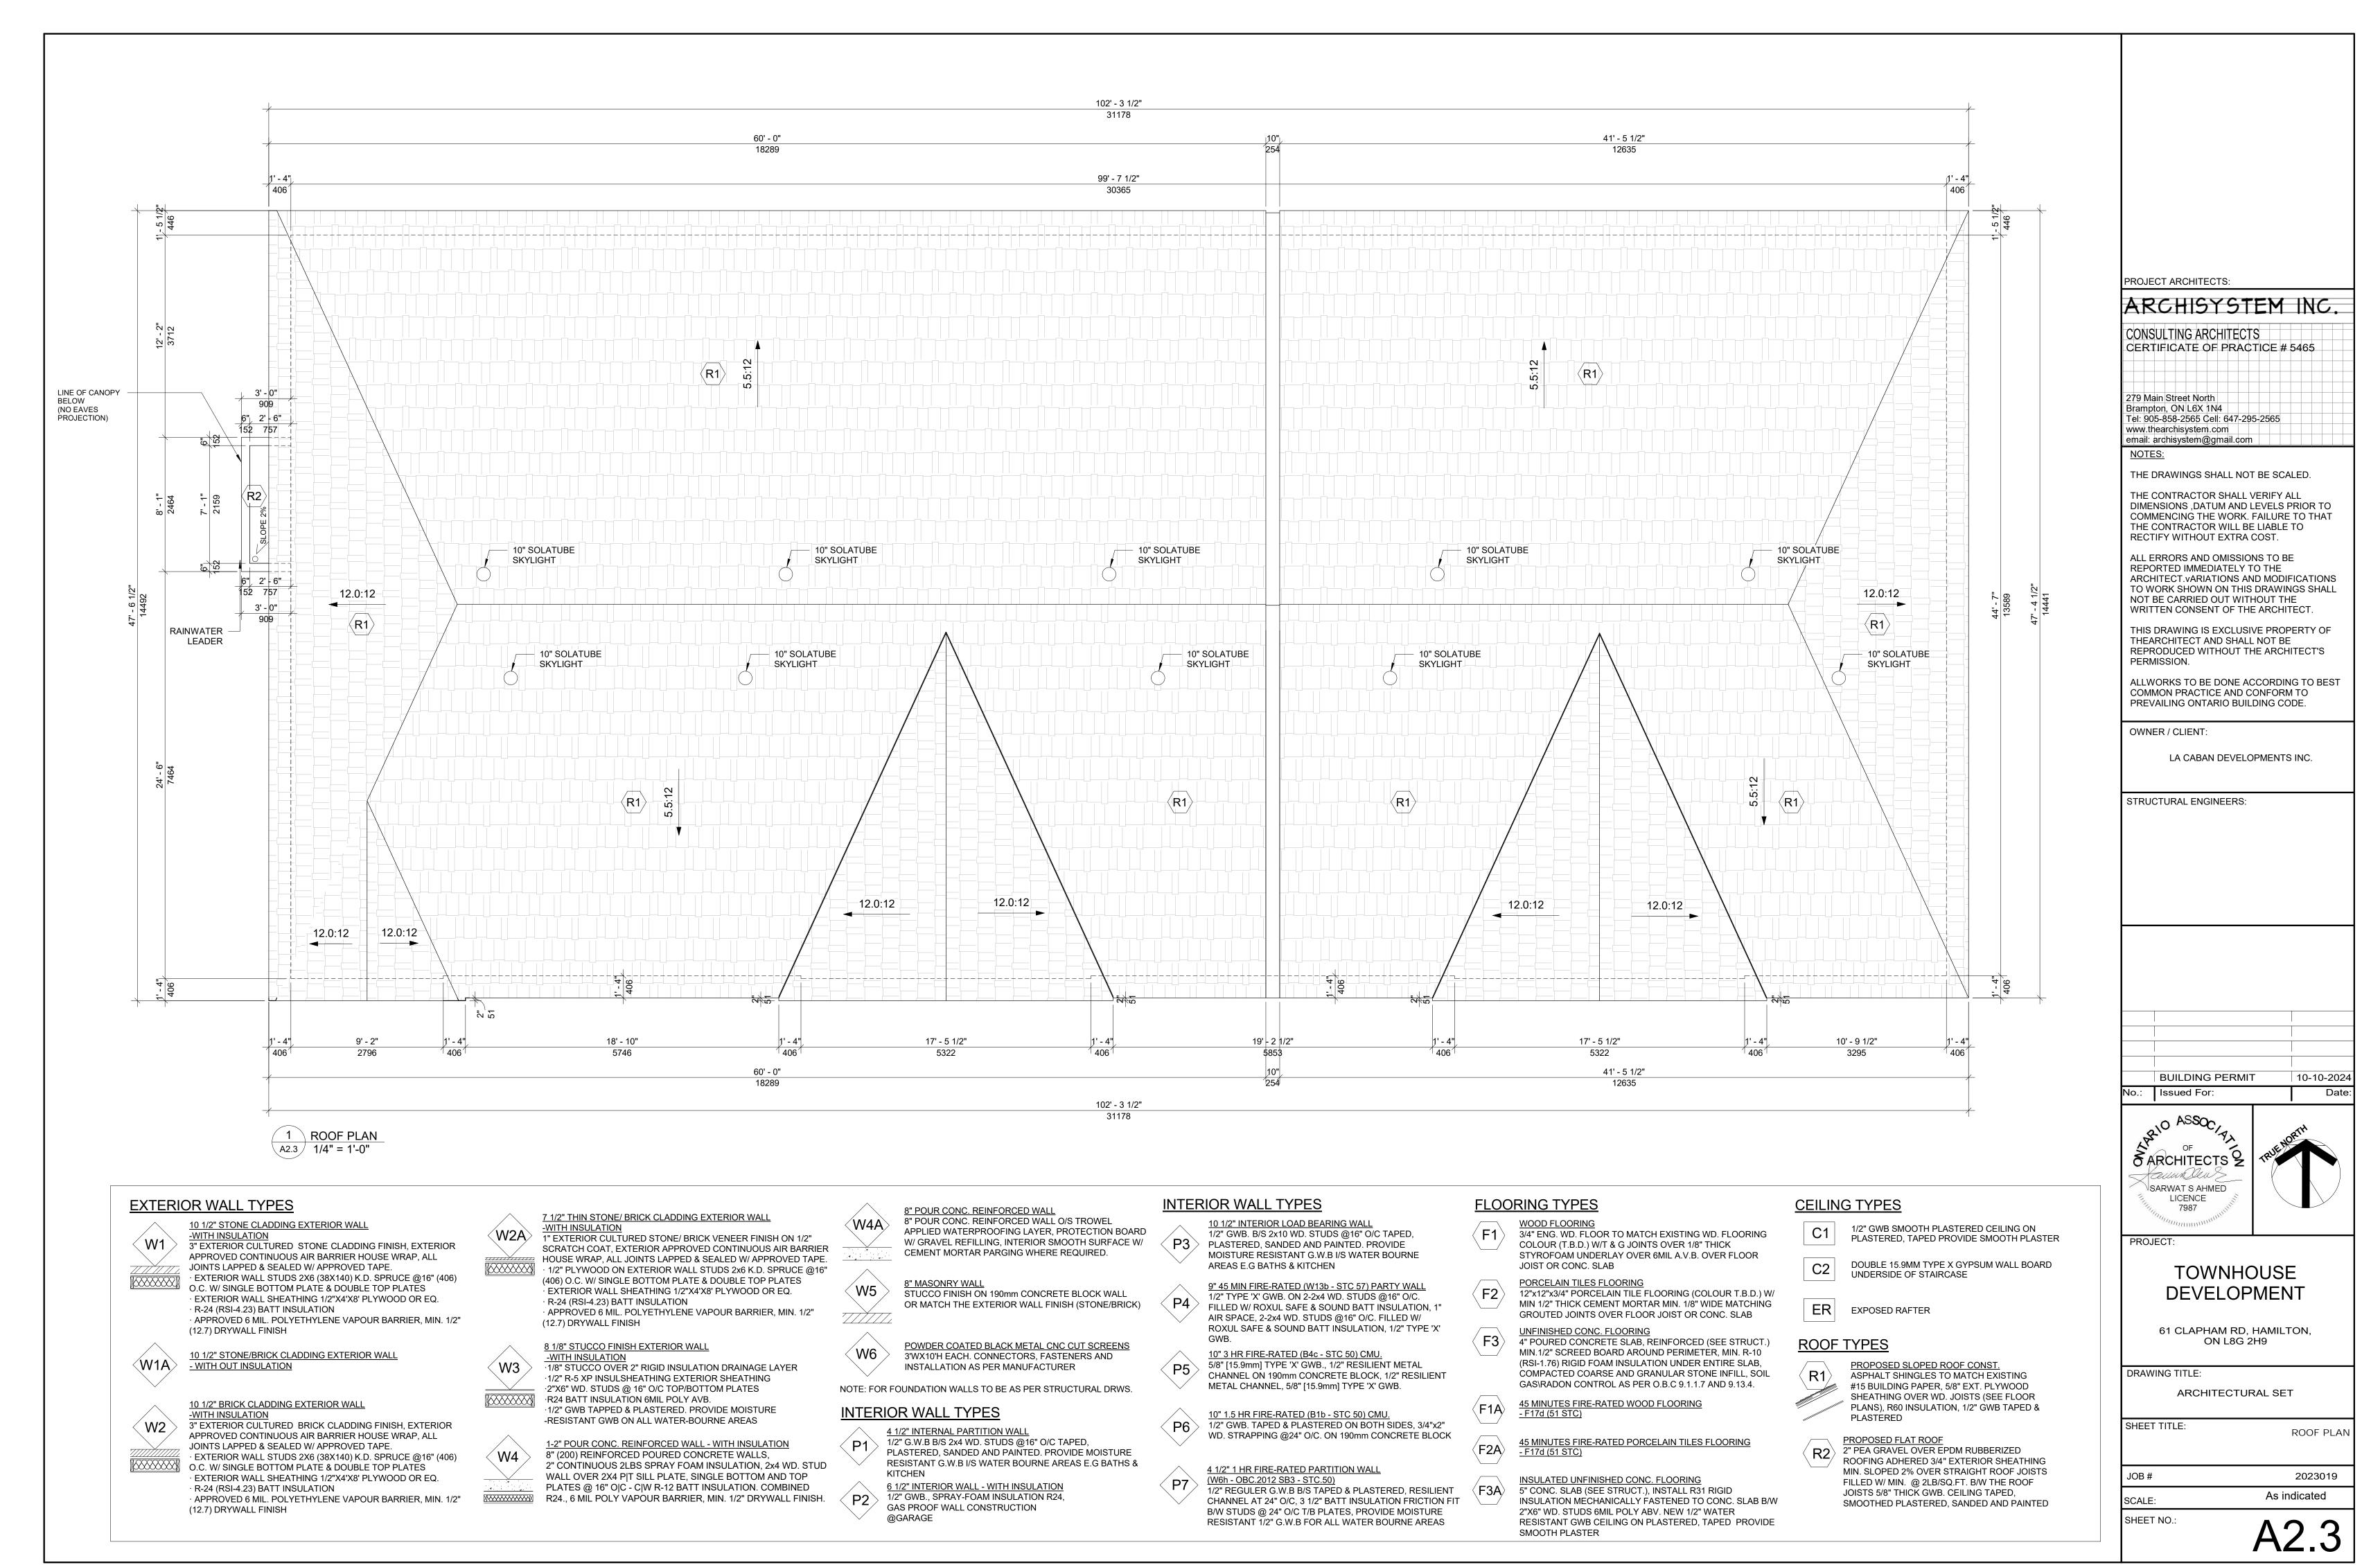

DESCRIPTION 01 ASPHALT SHINGLE COLOUR T.B.D. 02 STONE CLADDING COLOUR T.B.D.

03 BRICK CLADDING COLOUR T.B.D.

04 STUCCO FINISH COLOUR T.B.D. 05 VINYL FRAMED GLAZED WINDOW

06 TRIM T.B.D. EAVETRHOUGH COLOUR T.B.D.

07 3'6"[1070mm]HIGH ALUMINIUM GUARDRAIL

MATERIAL LEGEND

08 PRECASE CONCRETE

09 STUCCO BELLY BAND COLOUR T.B.D.

PROJECT ARCHITECTS:

ARCHISYSTEM INC.

CONSULTING ARCHITECTS CERTIFICATE OF PRACTICE # 5465

279 Main Street North Brampton, ON L6X 1N4 Tel: 905-858-2565 Cell: 647-295-2565 www.thearchisystem.com email: archisystem@gmail.com

NOTES:

THE DRAWINGS SHALL NOT BE SCALED.

THE CONTRACTOR SHALL VERIFY ALL DIMENSIONS ,DATUM AND LEVELS PRIOR TO COMMENCING THE WORK. FAILURE TO THAT THE CONTRACTOR WILL BE LIABLE TO RECTIFY WITHOUT EXTRA COST.

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ALLWORKS TO BE DONE ACCORDING TO BEST COMMON PRACTICE AND CONFORM TO PREVAILING ONTARIO BUILDING CODE.

OWNER / CLIENT:

LA CABAN DEVELOPMENTS INC.

STRUCTURAL ENGINEERS:

10-10-2024 BUILDING PERMIT No.: Issued For:

ARCHITECTS & Haun Deux SARWAT S AHMED LICENCE 7987

PROJECT:

TOWNHOUSE DEVELOPMENT

61 CLAPHAM RD, HAMILTON, ON L8G 2H9


ARCHITECTURAL SET

DRAWING TITLE:

SHEET TITLE: WEST ELEVATION

> 2023019 1/4" = 1'-0"

SCALE: SHEET NO.:

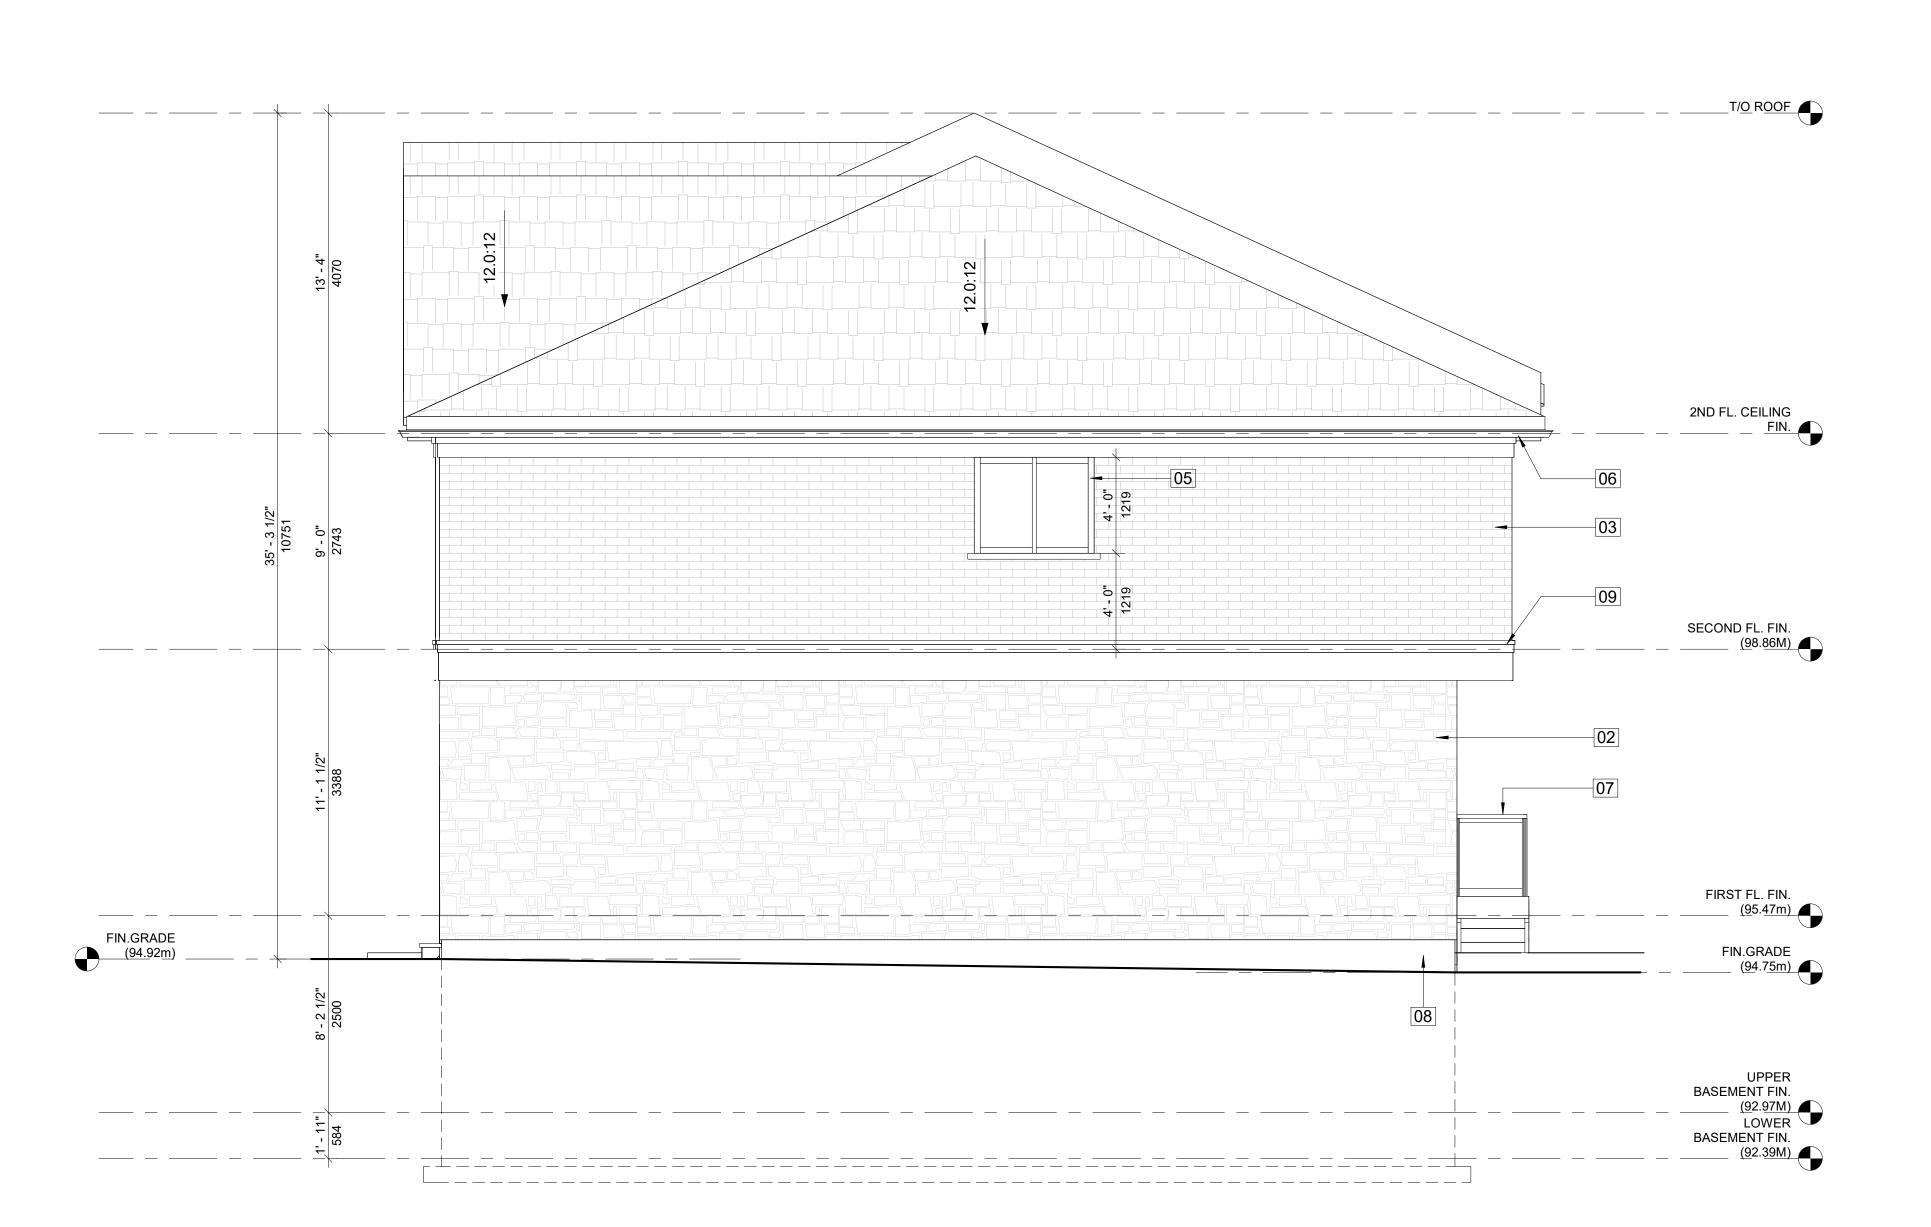

CALCULATION OF UNPROTECTED OPENINGS OBC 2012 (9.10.15.4)

= 89.54 SQ.M.

= 1.5 M

= 1.80 SQ.M. = 2.01%

= 7.16SQ.M. = 8%

TOTAL EXPOSED WALL AREA

L/H = 1.98

UNPROTECTED OPENING AREA LIMITING DISTANCE

%AGE ALLOWED @ 1.5M<100SQM

1 EAST ELEVATION A3.3 1/4" = 1'-0"



08 PRECASE CONCRETE

09 STUCCO BELLY BAND COLOUR T.B.D.

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BUILDING PERMIT 10-10-2024 No.: Issued For:

ARCHITECTS 2 Teun Deux SARWAT S AHMED LICENCE 7987

PROJECT:

TOWNHOUSE DEVELOPMENT

61 CLAPHAM RD, HAMILTON, ON L8G 2H9

DRAWING TITLE: ARCHITECTURAL SET

SHEET TITLE:

2023019

SHEET NO.:

As indicated

EAST ELEVATION



igg(1 igcap BUILDING SECTION - 1 A4.0 / 1/4" = 1'-0"

EXTERIOR WALL TYPES

10 1/2" STONE CLADDING EXTERIOR WALL

-WITH INSULATION

3" EXTERIOR CULTURED STONE CLADDING FINISH, EXTERIOR APPROVED CONTINUOUS AIR BARRIER HOUSE WRAP, ALL JOINTS LAPPED & SEALED W/ APPROVED TAPE. · EXTERIOR WALL STUDS 2X6 (38X140) K.D. SPRUCE @16" (406) O.C. W/ SINGLE BOTTOM PLATE & DOUBLE TOP PLATES

· EXTERIOR WALL SHEATHING 1/2"X4'X8' PLYWOOD OR EQ. · R-24 (RSI-4.23) BATT INSULATION · APPROVED 6 MIL. POLYETHYLENE VAPOUR BARRIER, MIN. 1/2" (12.7) DRYWALL FINISH



10 1/2" STONE/BRICK CLADDING EXTERIOR WALL

- WITH OUT INSULATION



10 1/2" BRICK CLADDING EXTERIOR WALL <u>-WITH INSULATION</u>

3" EXTERIOR CULTURED BRICK CLADDING FINISH, EXTERIOR APPROVED CONTINUOUS AIR BARRIER HOUSE WRAP, ALL JOINTS LAPPED & SEALED W/ APPROVED TAPE. · EXTERIOR WALL STUDS 2X6 (38X140) K.D. SPRUCE @16" (406) O.C. W/ SINGLE BOTTOM PLATE & DOUBLE TOP PLATES


· EXTERIOR WALL SHEATHING 1/2"X4'X8' PLYWOOD OR EQ. · R-24 (RSI-4.23) BATT INSULATION · APPROVED 6 MIL. POLYETHYLENE VAPOUR BARRIER, MIN. 1/2" (12.7) DRYWALL FINISH



7 1/2" THIN STONE/ BRICK CLADDING EXTERIOR WALL

-WITH INSULATION 1" EXTERIOR CULTURED STONE/ BRICK VENEER FINISH ON 1/2" SCRATCH COAT, EXTERIOR APPROVED CONTINUOUS AIR BARRIER HOUSE WRAP, ALL JOINTS LAPPED & SEALED W/ APPROVED TAPE. 1/2" PLYWOOD ON EXTERIOR WALL STUDS 2x6 K.D. SPRUCE @16" (406) O.C. W/ SINGLE BOTTOM PLATE & DOUBLE TOP PLATES · EXTERIOR WALL SHEATHING 1/2"X4'X8' PLYWOOD OR EQ. · R-24 (RSI-4.23) BATT INSULATION

· APPROVED 6 MIL. POLYETHYLENE VAPOUR BARRIER, MIN. 1/2"

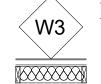

8 1/8" STUCCO FINISH EXTERIOR WALL <u>-WITH INSULATION</u>

(12.7) DRYWALL FINISH

·1/8" STUCCO OVER 2" RIGID INSULATION DRAINAGE LAYER ·1/2" R-5 XP INSULSHEATHING EXTERIOR SHEATHING ·2"X6" WD. STUDS @ 16" O/C TOP/BOTTOM PLATES ·R24 BATT INSULATION 6MIL POLY AVB. ·1/2" GWB TAPPED & PLASTERED. PROVIDE MOISTURE -RESISTANT GWB ON ALL WATER-BOURNE AREAS



1-2" POUR CONC. REINFORCED WALL - WITH INSULATION 8" (200) REINFORCED POURED CONCRETE WALLS,

2" CONTINUOUS 2LBS SPRAY FOAM INSULATION, 2x4 WD. STUD WALL OVER 2X4 P|T SILL PLATE, SINGLE BOTTOM AND TOP PLATES @ 16" O|C - C|W R-12 BATT INSULATION. COMBINED R24., 6 MIL POLY VAPOUR BARRIER, MIN. 1/2" DRYWALL FINISH.



8" POUR CONC. REINFORCED WALL 8" POUR CONC. REINFORCED WALL O/S TROWEL APPLIED WATERPROOFING LAYER, PROTECTION BOARD W/ GRAVEL REFILLING, INTERIOR SMOOTH SURFACE W/ CEMENT MORTAR PARGING WHERE REQUIRED.

8" MASONRY WALL STUCCO FINISH ON 190mm CONCRETE BLOCK WALL OR MATCH THE EXTERIOR WALL FINISH (STONE/BRICK)



POWDER COATED BLACK METAL CNC CUT SCREENS 3'WX10'H EACH. CONNECTORS, FASTENERS AND INSTALLATION AS PER MANUFACTURER

NOTE: FOR FOUNDATION WALLS TO BE AS PER STRUCTURAL DRWS.


INTERIOR WALL TYPES

4 1/2" INTERNAL PARTITION WALL 1/2" G.W.B B/S 2x4 WD. STUDS @16" O/C TAPED, PLASTERED, SANDED AND PAINTED. PROVIDE MOISTURE RESISTANT G.W.B I/S WATER BOURNE AREAS E.G BATHS & KITCHEN

6 1/2" INTERIOR WALL - WITH INSULATION 1/2" GWB., SPRAY-FOAM INSULATION R24, GAS PROOF WALL CONSTRUCTION @GARAGE

INTERIOR WALL TYPES

10 1/2" INTERIOR LOAD BEARING WALL 1/2" GWB. B/S 2x10 WD. STUDS @16" O/C TAPED, (P3) PLASTERED, SANDED AND PAINTED. PROVIDE MOISTURE RESISTANT G.W.B I/S WATER BOURNE AREAS E.G BATHS & KITCHEN

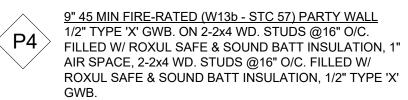

10" 3 HR FIRE-RATED (B4c - STC 50) CMU. 5/8" [15.9mm] TYPE 'X' GWB., 1/2" RESILIENT METAL CHANNEL ON 190mm CONCRETE BLOCK, 1/2" RESILIENT METAL CHANNEL, 5/8" [15.9mm] TYPE 'X' GWB.

10" 1.5 HR FIRE-RATED (B1b - STC 50) CMU. 1/2" GWB. TAPED & PLASTERED ON BOTH SIDES, 3/4"x2" WD. STRAPPING @24" O/C. ON 190mm CONCRETE BLOCK

4 1/2" 1 HR FIRE-RATED PARTITION WALL

(W6h - OBC.2012 SB3 - STC.50) 1/2" REGULER G.W.B B/S TAPED & PLASTERED, RESILIENT CHANNEL AT 24" O/C, 3 1/2" BATT INSULATION FRICTION FIT B/W STUDS @ 24" O/C T/B PLATES, PROVIDE MOISTURE RESISTANT 1/2" G.W.B FOR ALL WATER BOURNE AREAS

FLOORING TYPES

3/4" ENG. WD. FLOOR TO MATCH EXISTING WD. FLOORING COLOUR (T.B.D.) W/T & G JOINTS OVER 1/8" THICK STYROFOAM UNDERLAY OVER 6MIL A.V.B. OVER FLOOR JOIST OR CONC. SLAB

PORCELAIN TILES FLOORING 12"x12"x3/4" PORCELAIN TILE FLOORING (COLOUR T.B.D.) W/ MIN 1/2" THICK CEMENT MORTAR MIN. 1/8" WIDE MATCHING GROUTED JOINTS OVER FLOOR JOIST OR CONC. SLAB

UNFINISHED CONC. FLOORING 4" POURED CONCRETE SLAB, REINFORCED (SEE STRUCT.) MIN.1/2" SCREED BOARD AROUND PERIMETER, MIN. R-10 (RSI-1.76) RIGID FOAM INSULATION UNDER ENTIRE SLAB, COMPACTED COARSE AND GRANULAR STONE INFILL, SOIL GAS\RADON CONTROL AS PER O.B.C 9.1.1.7 AND 9.13.4.

<u> 15 MINUTES FIRE-RATED WOOD FLOORING</u>

<u>45 MINUTES FIRE-RATED PORCELAIN TILES FLOORING</u>

INSULATED UNFINISHED CONC. FLOORING 5" CONC. SLAB (SEE STRUCT.), INSTALL R31 RIGID INSULATION MECHANICALLY FASTENED TO CONC. SLAB B/W 2"X6" WD. STUDS 6MIL POLY ABV. NEW 1/2" WATER RESISTANT GWB CEILING ON PLASTERED, TAPED PROVIDE SMOOTH PLASTER

CEILING TYPES

1/2" GWB SMOOTH PLASTERED CEILING ON PLASTERED, TAPED PROVIDE SMOOTH PLASTER

DOUBLE 15.9MM TYPE X GYPSUM WALL BOARD UNDERSIDE OF STAIRCASE

ER EXPOSED RAFTER

ROOF TYPES



PROPOSED SLOPED ROOF CONST. ASPHALT SHINGLES TO MATCH EXISTING #15 BUILDING PAPER, 5/8" EXT. PLYWOOD SHEATHING OVER WD. JOISTS (SEE FLOOR PLANS), R60 INSULATION, 1/2" GWB TAPED & PLASTERED

R2 2" PEA GRAVEL OVER EPDM RUBBERIZED ROOFING ADHERED 3/4" EXTERIOR SHEATHING MIN. SLOPED 2% OVER STRAIGHT ROOF JOISTS FILLED W/ MIN. @ 2LB/SQ.FT. B/W THE ROOF

JOISTS 5/8" THICK GWB. CEILING TAPED,

SMOOTHED PLASTERED, SANDED AND PAINTED

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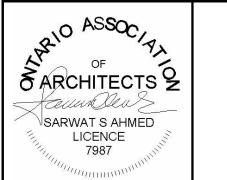
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OWNER / CLIENT:

LA CABAN DEVELOPMENTS INC.

STRUCTURAL ENGINEERS:

BUILDING PERMIT 10-10-2024 Issued For:



PROJECT:

TOWNHOUSE **DEVELOPMENT**

61 CLAPHAM RD, HAMILTON, ON L8G 2H9


DRAWING TITLE:

SHEET NO.


ARCHITECTURAL SET

SHEET TITLE: **BUILDING SECTION**

JOB# 2023019 As indicated SCALE:

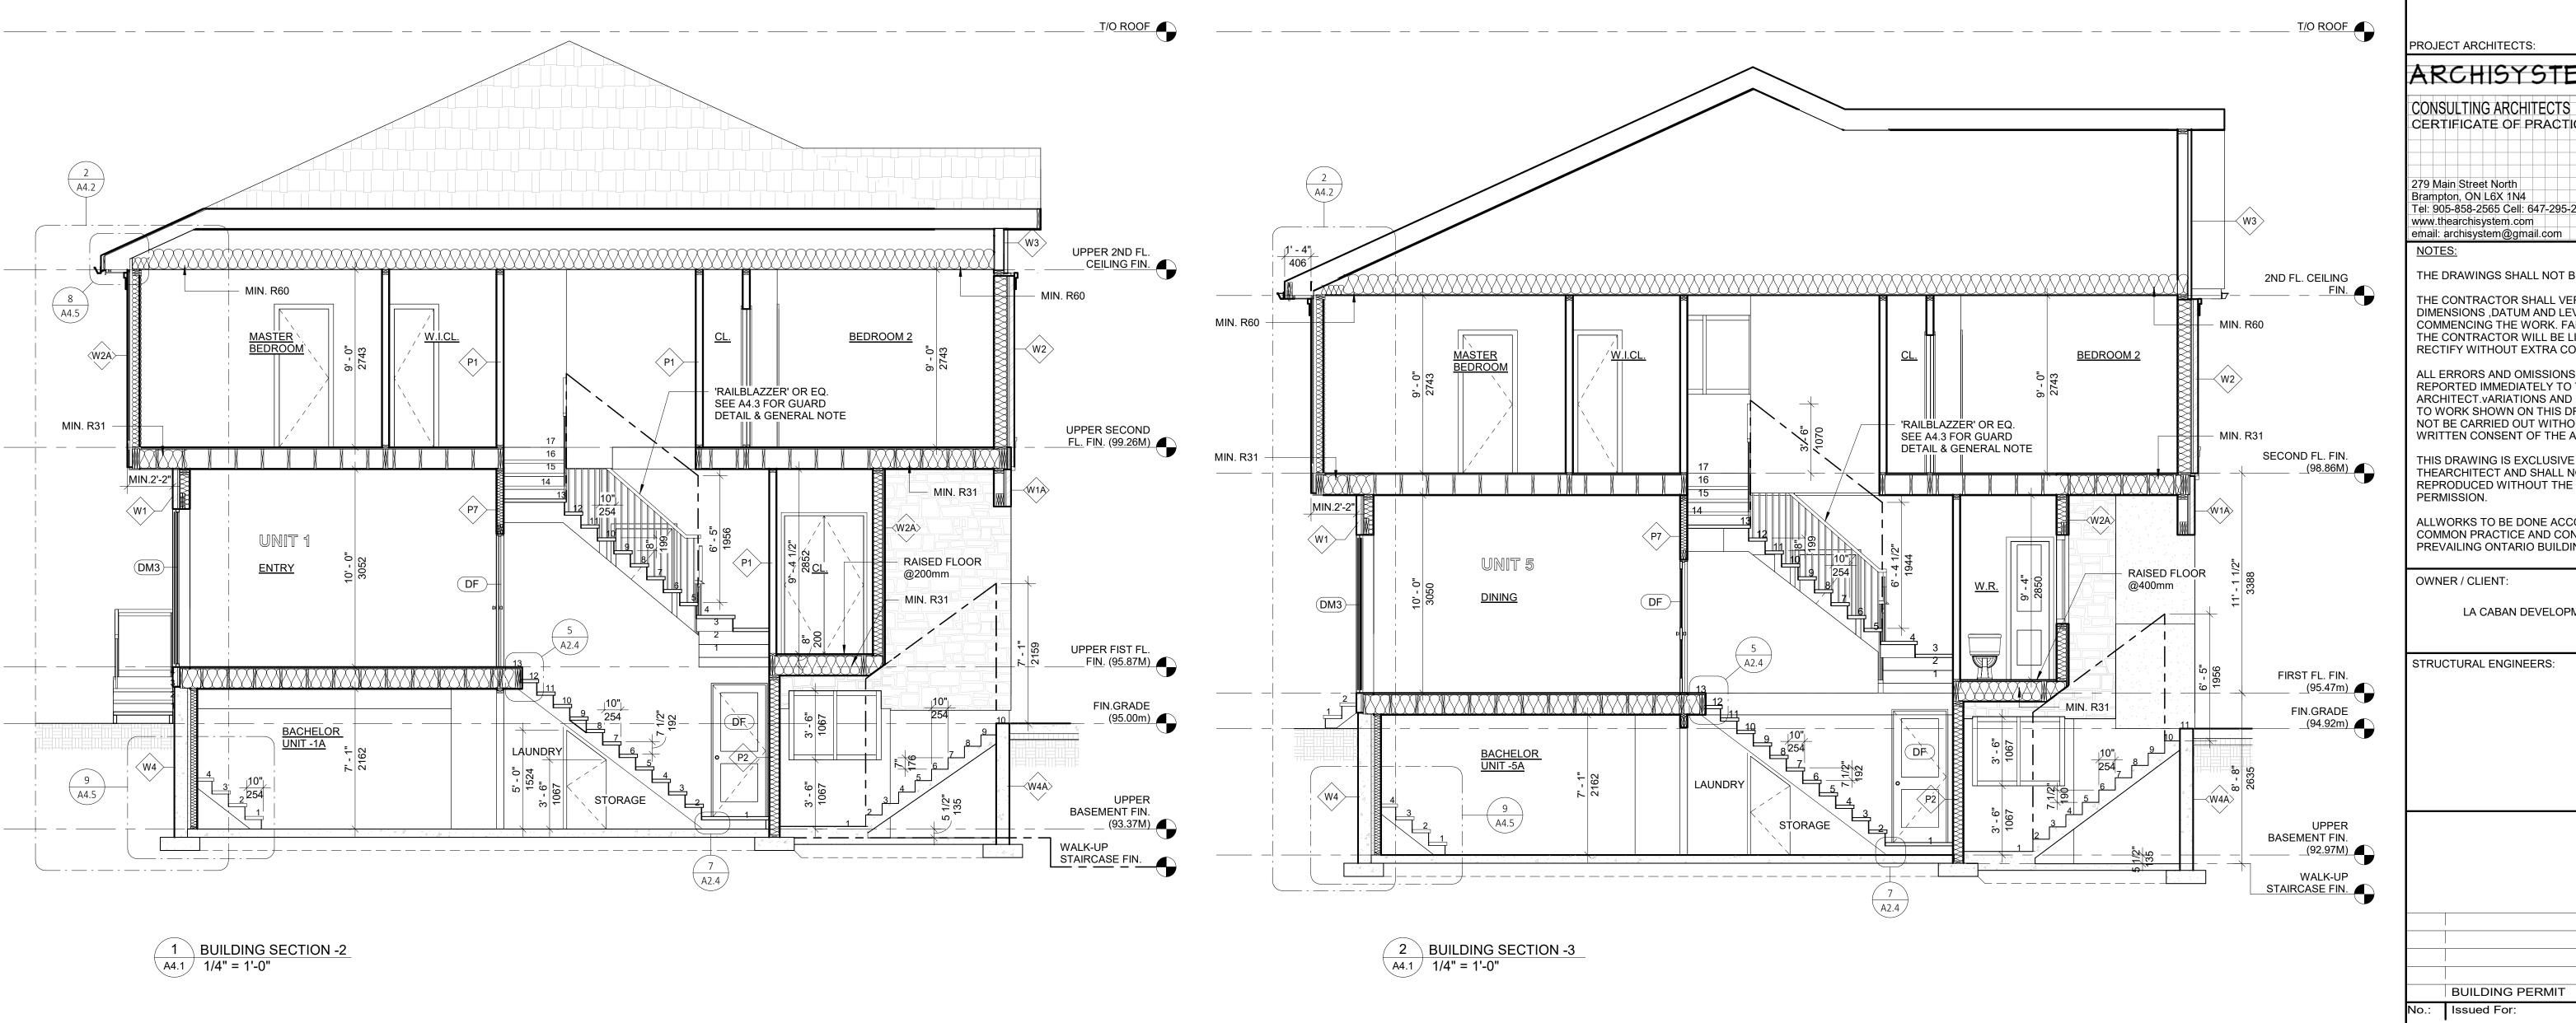

EXTERIOR WALL TYPES

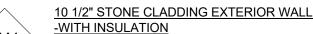

3" EXTERIOR CULTURED STONE CLADDING FINISH, EXTERIOR APPROVED CONTINUOUS AIR BARRIER HOUSE WRAP, ALL JOINTS LAPPED & SEALED W/ APPROVED TAPE. · EXTERIOR WALL STUDS 2X6 (38X140) K.D. SPRUCE @16" (406) O.C. W/ SINGLE BOTTOM PLATE & DOUBLE TOP PLATES

· EXTERIOR WALL SHEATHING 1/2"X4'X8' PLYWOOD OR EQ. · R-24 (RSI-4.23) BATT INSULATION · APPROVED 6 MIL. POLYETHYLENE VAPOUR BARRIER, MIN. 1/2" (12.7) DRYWALL FINISH



10 1/2" STONE/BRICK CLADDING EXTERIOR WALL

- WITH OUT INSULATION



10 1/2" BRICK CLADDING EXTERIOR WALL <u>-WITH INSULATION</u>

3" EXTERIOR CULTURED BRICK CLADDING FINISH, EXTERIOR APPROVED CONTINUOUS AIR BARRIER HOUSE WRAP, ALL JOINTS LAPPED & SEALED W/ APPROVED TAPE. · EXTERIOR WALL STUDS 2X6 (38X140) K.D. SPRUCE @16" (406) O.C. W/ SINGLE BOTTOM PLATE & DOUBLE TOP PLATES

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7 1/2" THIN STONE/ BRICK CLADDING EXTERIOR WALL

(12.7) DRYWALL FINISH

-WITH INSULATION 1" EXTERIOR CULTURED STONE/ BRICK VENEER FINISH ON 1/2" SCRATCH COAT, EXTERIOR APPROVED CONTINUOUS AIR BARRIER HOUSE WRAP, ALL JOINTS LAPPED & SEALED W/ APPROVED TAPE. · 1/2" PLYWOOD ON EXTERIOR WALL STUDS 2x6 K.D. SPRUCE @16" (406) O.C. W/ SINGLE BOTTOM PLATE & DOUBLE TOP PLATES · EXTERIOR WALL SHEATHING 1/2"X4'X8' PLYWOOD OR EQ. · R-24 (RSI-4.23) BATT INSULATION

· APPROVED 6 MIL. POLYETHYLENE VAPOUR BARRIER, MIN. 1/2"



·1/8" STUCCO OVER 2" RIGID INSULATION DRAINAGE LAYER ·1/2" R-5 XP INSULSHEATHING EXTERIOR SHEATHING ·2"X6" WD. STUDS @ 16" O/C TOP/BOTTOM PLATES ·R24 BATT INSULATION 6MIL POLY AVB. ·1/2" GWB TAPPED & PLASTERED. PROVIDE MOISTURE -RESISTANT GWB ON ALL WATER-BOURNE AREAS




1-2" POUR CONC. REINFORCED WALL - WITH INSULATION 8" (200) REINFORCED POURED CONCRETE WALLS,

2" CONTINUOUS 2LBS SPRAY FOAM INSULATION, 2x4 WD. STUD WALL OVER 2X4 P|T SILL PLATE, SINGLE BOTTOM AND TOP PLATES @ 16" O|C - C|W R-12 BATT INSULATION. COMBINED R24., 6 MIL POLY VAPOUR BARRIER, MIN. 1/2" DRYWALL FINISH.



8" POUR CONC. REINFORCED WALL 8" POUR CONC. REINFORCED WALL O/S TROWEL APPLIED WATERPROOFING LAYER, PROTECTION BOARD W/ GRAVEL REFILLING, INTERIOR SMOOTH SURFACE W/ CEMENT MORTAR PARGING WHERE REQUIRED.

8" MASONRY WALL STUCCO FINISH ON 190mm CONCRETE BLOCK WALL OR MATCH THE EXTERIOR WALL FINISH (STONE/BRICK)

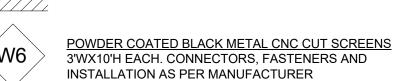

NOTE: FOR FOUNDATION WALLS TO BE AS PER STRUCTURAL DRWS.

INTERIOR WALL TYPES

4 1/2" INTERNAL PARTITION WALL

1/2" G.W.B B/S 2x4 WD. STUDS @16" O/C TAPED, PLASTERED, SANDED AND PAINTED. PROVIDE MOISTURE RESISTANT G.W.B I/S WATER BOURNE AREAS E.G BATHS & KITCHEN

6 1/2" INTERIOR WALL - WITH INSULATION 1/2" GWB., SPRAY-FOAM INSULATION R24, GAS PROOF WALL CONSTRUCTION @GARAGE

INTERIOR WALL TYPES

10 1/2" INTERIOR LOAD BEARING WALL 1/2" GWB. B/S 2x10 WD. STUDS @16" O/C TAPED, (P3) PLASTERED, SANDED AND PAINTED. PROVIDE MOISTURE RESISTANT G.W.B I/S WATER BOURNE AREAS E.G BATHS & KITCHEN

9" 45 MIN FIRE-RATED (W13b - STC 57) PARTY WALL 1/2" TYPE 'X' GWB. ON 2-2x4 WD. STUDS @16" O/C. FILLED W/ ROXUL SAFE & SOUND BATT INSULATION, 1" AIR SPACE, 2-2x4 WD. STUDS @16" O/C. FILLED W/ ROXUL SAFE & SOUND BATT INSULATION, 1/2" TYPE 'X'

10" 3 HR FIRE-RATED (B4c - STC 50) CMU. 5/8" [15.9mm] TYPE 'X' GWB., 1/2" RESILIENT METAL CHANNEL ON 190mm CONCRETE BLOCK, 1/2" RESILIENT METAL CHANNEL, 5/8" [15.9mm] TYPE 'X' GWB.

10" 1.5 HR FIRE-RATED (B1b - STC 50) CMU. 1/2" GWB. TAPED & PLASTERED ON BOTH SIDES, 3/4"x2" WD. STRAPPING @24" O/C. ON 190mm CONCRETE BLOCK

4 1/2" 1 HR FIRE-RATED PARTITION WALL

(W6h - OBC.2012 SB3 - STC.50) 1/2" REGULER G.W.B B/S TAPED & PLASTERED, RESILIENT CHANNEL AT 24" O/C, 3 1/2" BATT INSULATION FRICTION FIT B/W STUDS @ 24" O/C T/B PLATES, PROVIDE MOISTURE RESISTANT 1/2" G.W.B FOR ALL WATER BOURNE AREAS

FLOORING TYPES

3/4" ENG. WD. FLOOR TO MATCH EXISTING WD. FLOORING COLOUR (T.B.D.) W/T & G JOINTS OVER 1/8" THICK STYROFOAM UNDERLAY OVER 6MIL A.V.B. OVER FLOOR JOIST OR CONC. SLAB

PORCELAIN TILES FLOORING 12"x12"x3/4" PORCELAIN TILE FLOORING (COLOUR T.B.D.) W/ MIN 1/2" THICK CEMENT MORTAR MIN. 1/8" WIDE MATCHING GROUTED JOINTS OVER FLOOR JOIST OR CONC. SLAB

UNFINISHED CONC. FLOORING 4" POURED CONCRETE SLAB, REINFORCED (SEE STRUCT.) MIN.1/2" SCREED BOARD AROUND PERIMETER, MIN. R-10 (RSI-1.76) RIGID FOAM INSULATION UNDER ENTIRE SLAB, COMPACTED COARSE AND GRANULAR STONE INFILL, SOIL GAS\RADON CONTROL AS PER O.B.C 9.1.1.7 AND 9.13.4.

<u>45 MINUTES FIRE-RATED PORCELAIN TILES FLOORING</u>

INSULATED UNFINISHED CONC. FLOORING 5" CONC. SLAB (SEE STRUCT.), INSTALL R31 RIGID INSULATION MECHANICALLY FASTENED TO CONC. SLAB B/W 2"X6" WD. STUDS 6MIL POLY ABV. NEW 1/2" WATER RESISTANT GWB CEILING ON PLASTERED, TAPED PROVIDE SMOOTH PLASTER

CEILING TYPES

1/2" GWB SMOOTH PLASTERED CEILING ON PLASTERED, TAPED PROVIDE SMOOTH PLASTER

DOUBLE 15.9MM TYPE X GYPSUM WALL BOARD UNDERSIDE OF STAIRCASE

ER EXPOSED RAFTER

ROOF TYPES

PROPOSED SLOPED ROOF CONST.

ASPHALT SHINGLES TO MATCH EXISTING #15 BUILDING PAPER, 5/8" EXT. PLYWOOD SHEATHING OVER WD. JOISTS (SEE FLOOR PLANS), R60 INSULATION, 1/2" GWB TAPED & PLASTERED

SMOOTHED PLASTERED, SANDED AND PAINTED

R2 2" PEA GRAVEL OVER EPDM RUBBERIZED ROOFING ADHERED 3/4" EXTERIOR SHEATHING MIN. SLOPED 2% OVER STRAIGHT ROOF JOISTS FILLED W/ MIN. @ 2LB/SQ.FT. B/W THE ROOF JOISTS 5/8" THICK GWB. CEILING TAPED,

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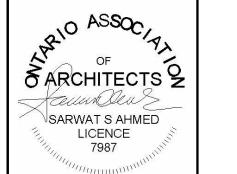
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STRUCTURAL ENGINEERS:

BUILDING PERMIT 10-10-2024

Issued For:



PROJECT:

SHEET NO.

TOWNHOUSE **DEVELOPMENT**


61 CLAPHAM RD, HAMILTON, ON L8G 2H9

DRAWING TITLE:

ARCHITECTURAL SET

SHEET TITLE: **BUILDING SECTIONS 2 &**

2023019 As indicated SCALE:

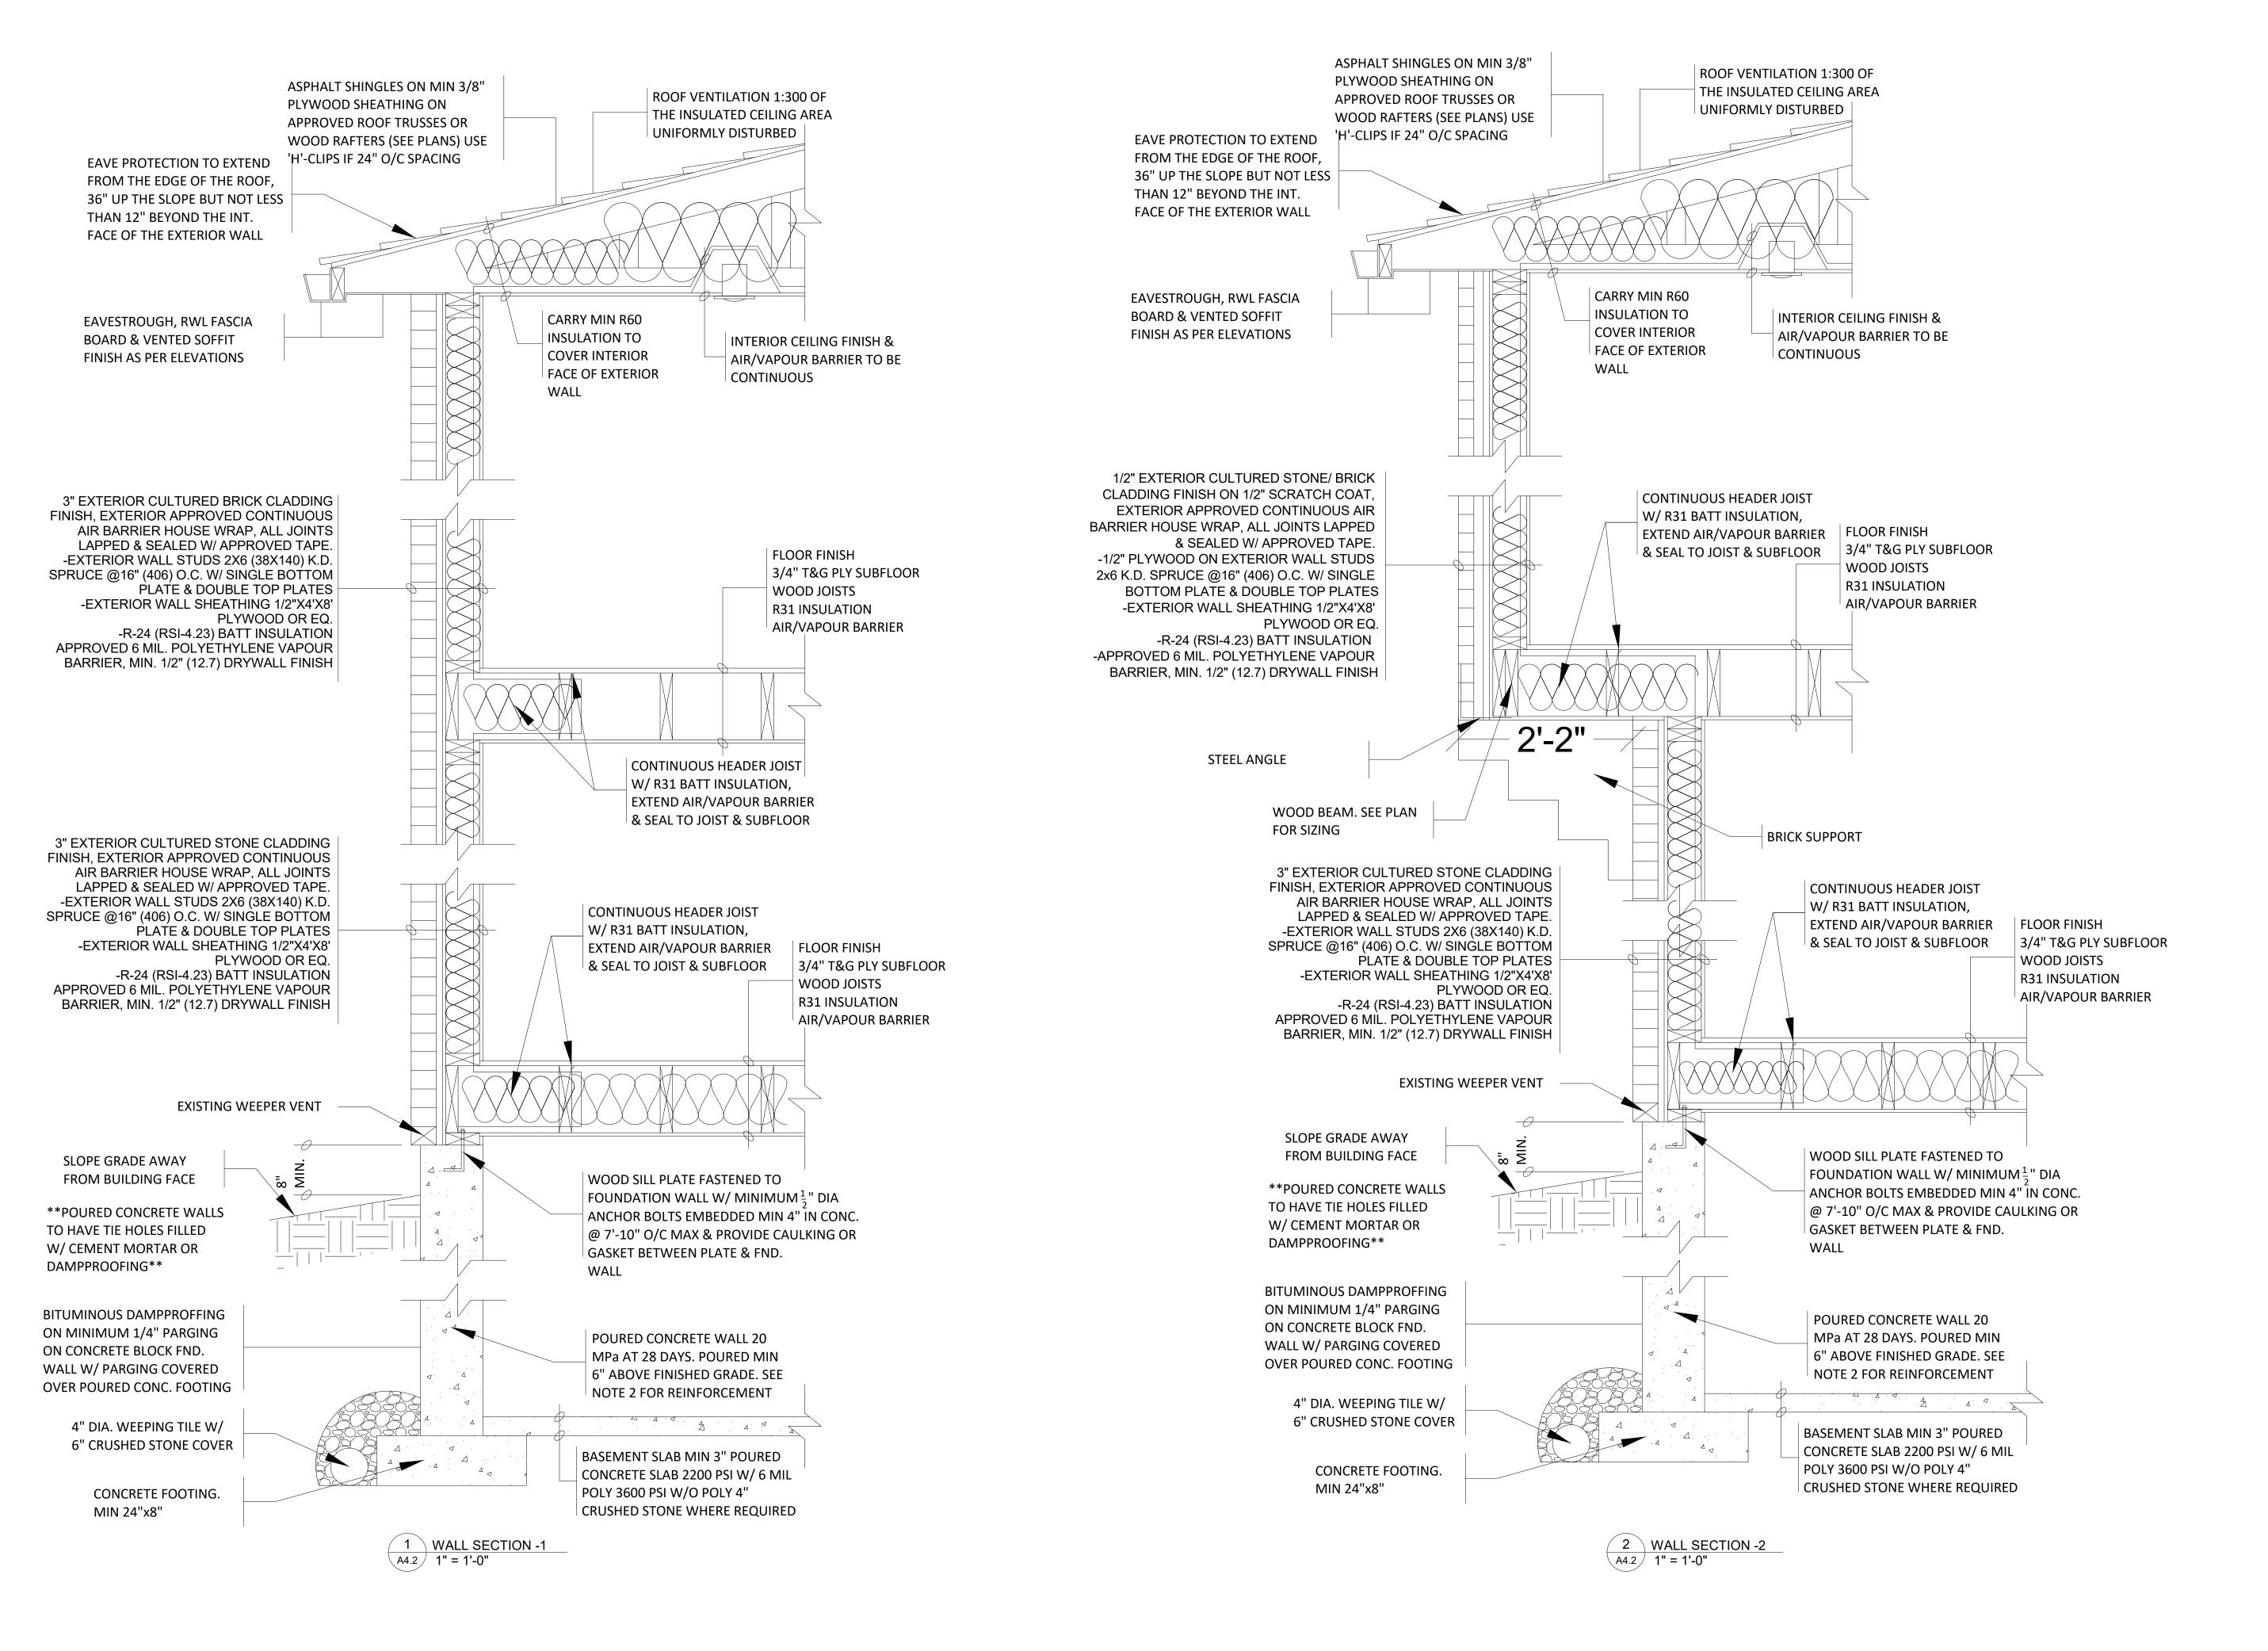

PROJECT ARCHITECTS:

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SIO ASSOCIAL OF & ARCHITECTS & Teun Deu √SARWAT S AHMED LICENCE 7987

PROJECT:

TOWNHOUSE **DEVELOPMENT**

61 CLAPHAM RD, HAMILTON, ON L8G 2H9

DRAWING TITLE:


SHEET TITLE:

SHEET NO.

ARCHITECTURAL SET

EXTERIOR WALI SECTIONS

JOB# 2023019 1" = 1'-0" SCALE:

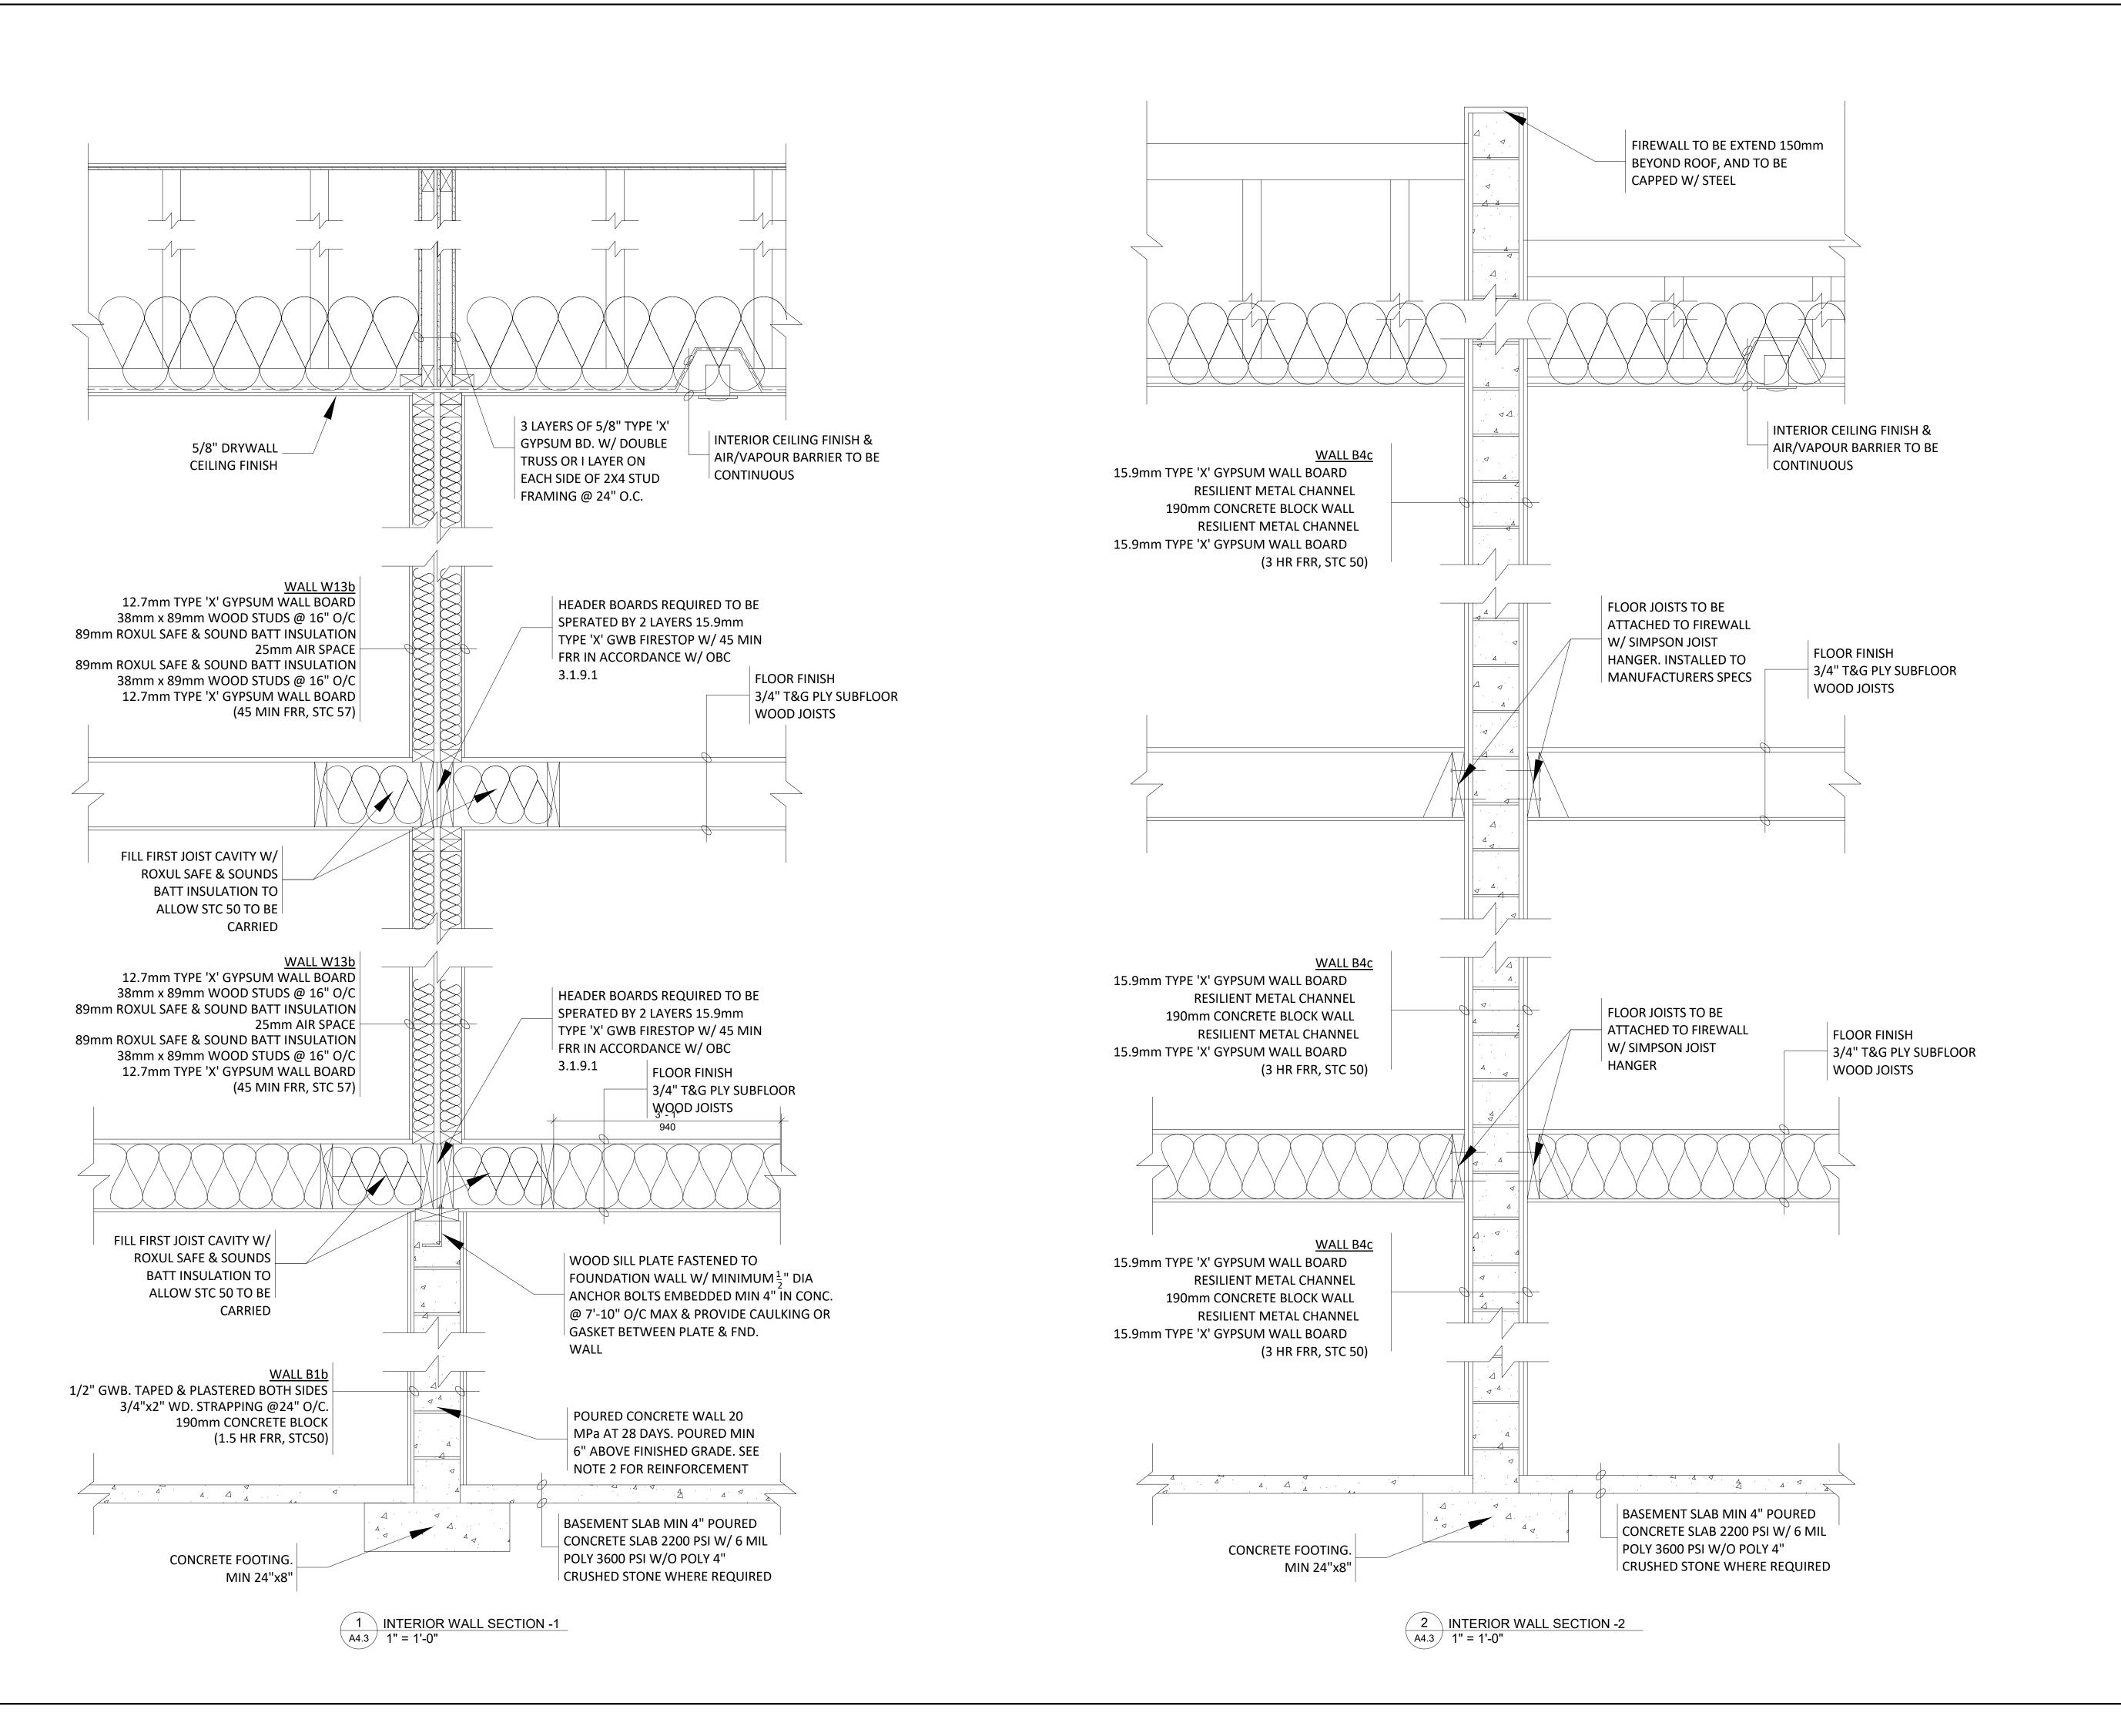

PROJECT ARCHITECTS:

ARCHISYSTEM INC.

CONSULTING ARCHITECTS
CERTIFICATE OF PRACTICE # 5465

279 Main Street North
Brampton, ON L6X 1N4
Tel: 905-858-2565 Cell: 647-295-2565

www.thearchisystem.com

email: archisystem@gmail.com

NOTES:

THE DRAWINGS SHALL NOT BE SCALED.

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OWNER / CLIENT:

LA CABAN DEVELOPMENTS INC.

STRUCTURAL ENGINEERS:

BUILDING PERMIT 10-10-2024
Issued For: Date

RIO ASSOCIAL



PROJECT:

TOWNHOUSE DEVELOPMENT

61 CLAPHAM RD, HAMILTON, ON L8G 2H9

DRAWING TITLE:

ARCHITECTURAL SET

SHEET NO.:

SHEET TITLE:


INTERIOR WALL
SECTIONS


JOB # 2023019 SCALE: 1" = 1'-0"

A4.3




- 1. A WORKMANSHIP AND MATERIAL SHALL BE IN ACCORDANCE WITHTHE ONTARIO BUILDING CODE AND REGULATIONS
- 2. MATERIAL SHALL BE AS FOLLOWS
- 2.1 CONCRETE 32MPa AT 2DAYS WITH 5%AIR ENTERTAINMENT REINFORCEMENT STEEL CBA 18M GRADE 400
- 2.2 REINFORCEMENT STEEL CSA G30 18M GRADE 400
- 2.3 GROUT HILTI HIT HY 200 OR EQUAL
- 2.4 BACKFILL TO BE OPS GRANULAR B1 OR SUITABLE **EXCAVATED MATERIAL**
- 3. ELECTRIC FEED FOR THE LIGHT TO E SEPARATE FROM ANY OTHER SWITCHED CIRCUIT
- 4. EXTERIOR DOOR SHALL CONFORM TO STANDARD AS PER OBC AND RESIST FORCE ENTRY
- 5. EMERGENCY WINDOW SHALL CONFIRM TO STANDARD AS PER OBC 9.9.10.1

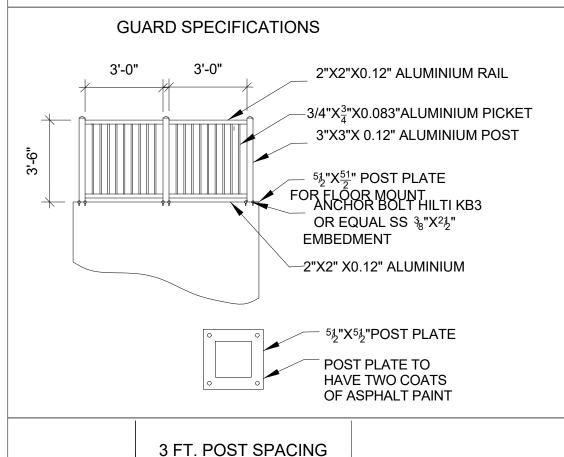


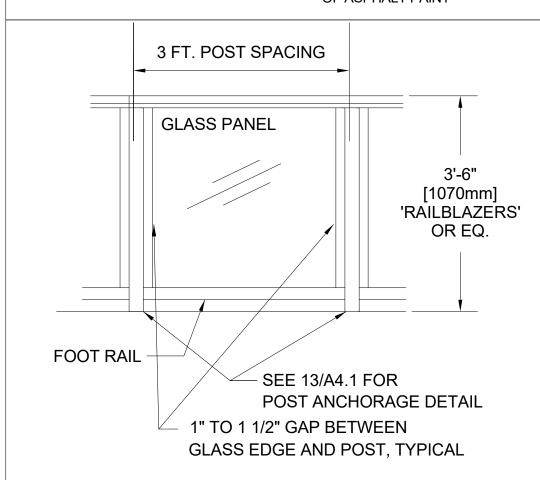


GUARD RAIL DETAIL NOTE & SPEC.

A4.4 NTS

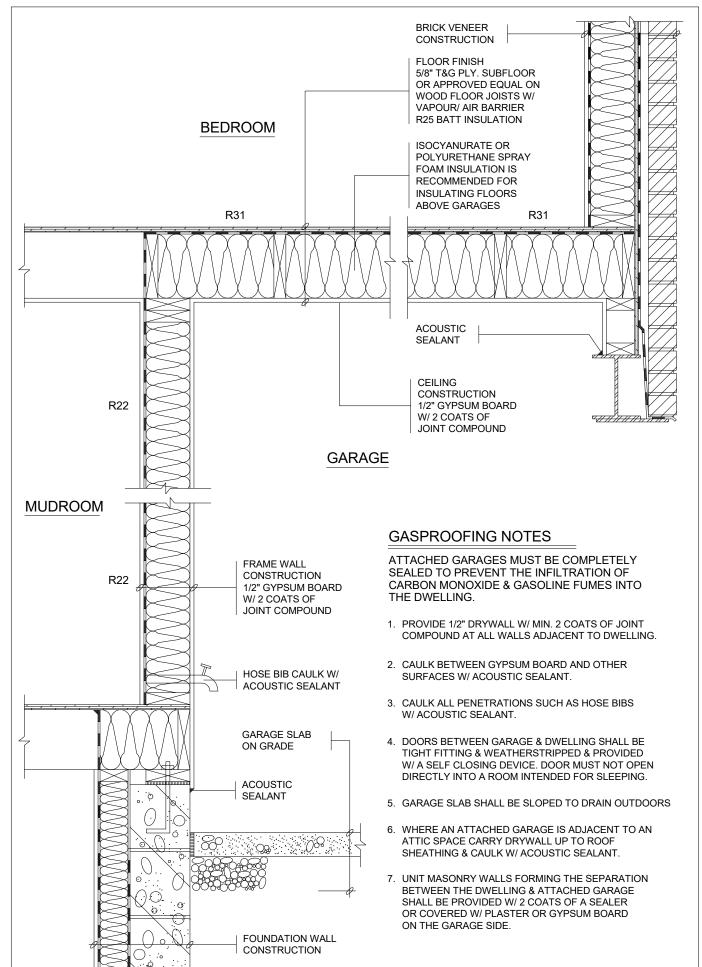

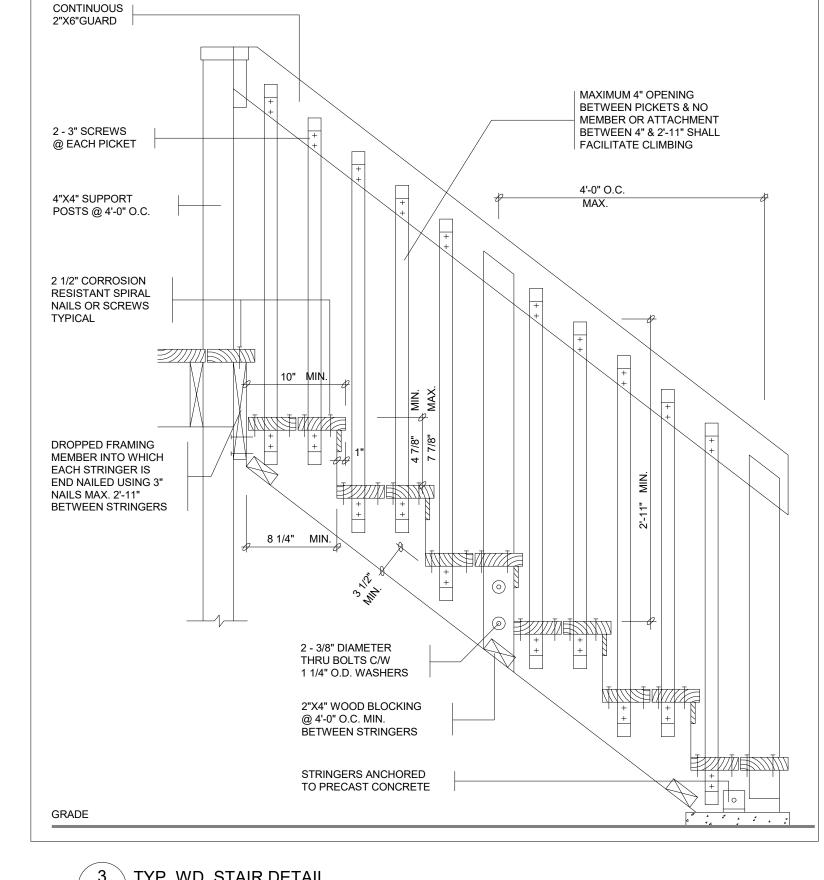

A4.4 / NTS

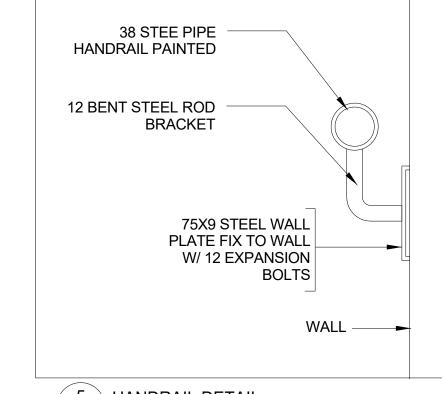

5 \ HANDRAIL DETAIL \A4.4 / NTS

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ARCHITECTS 2 Teun Deu SARWAT S AHMED LICENCE 7987

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TOWNHOUSE **DEVELOPMENT**

61 CLAPHAM RD, HAMILTON, ON L8G 2H9


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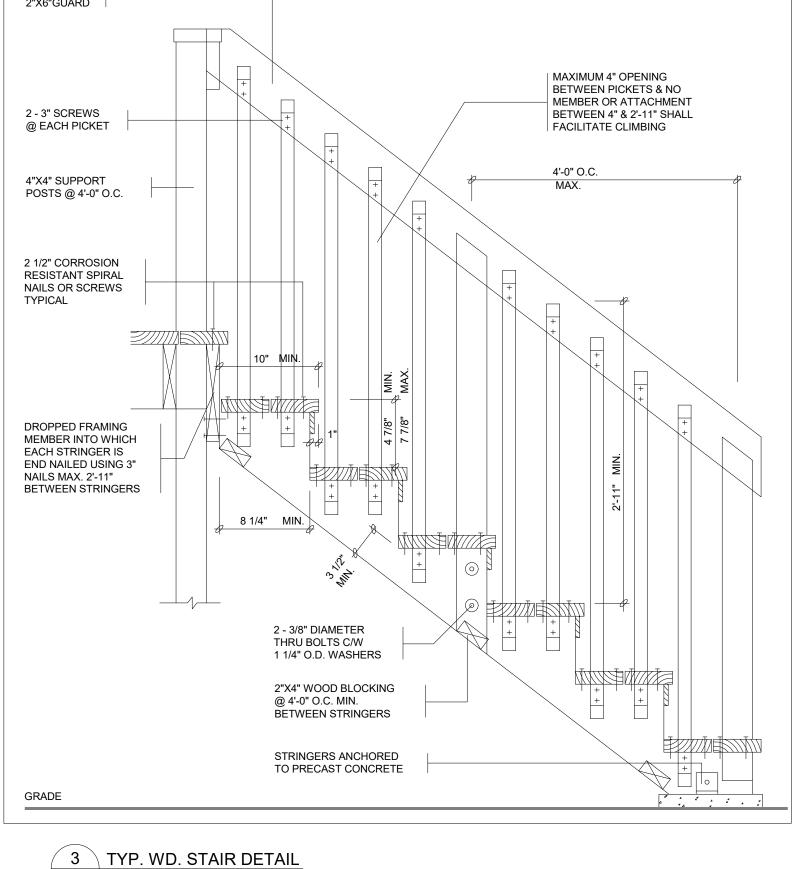
SHEET TITLE:

2023019


DETAILS

As indicated SHEET NO.




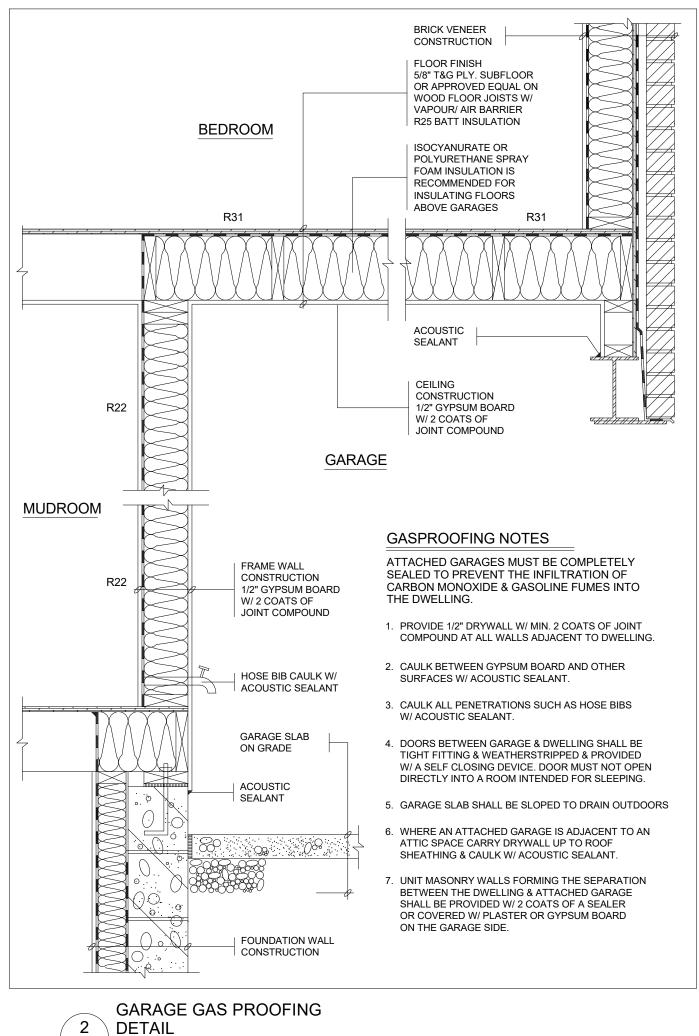



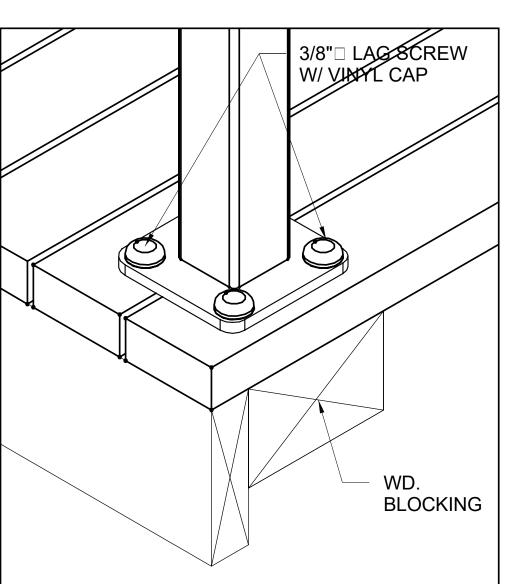





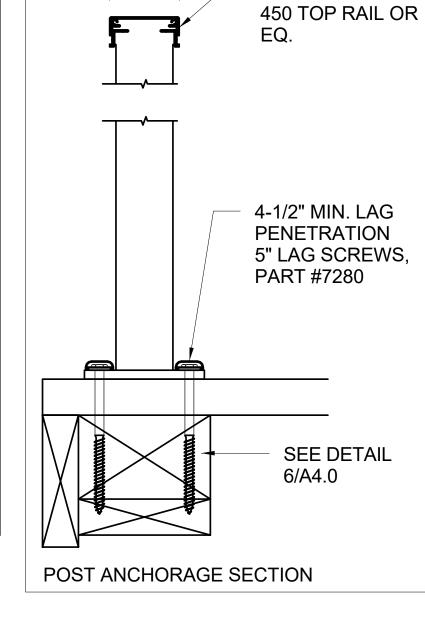


\ A4.4 / NTS


'FEENEY' SERIES

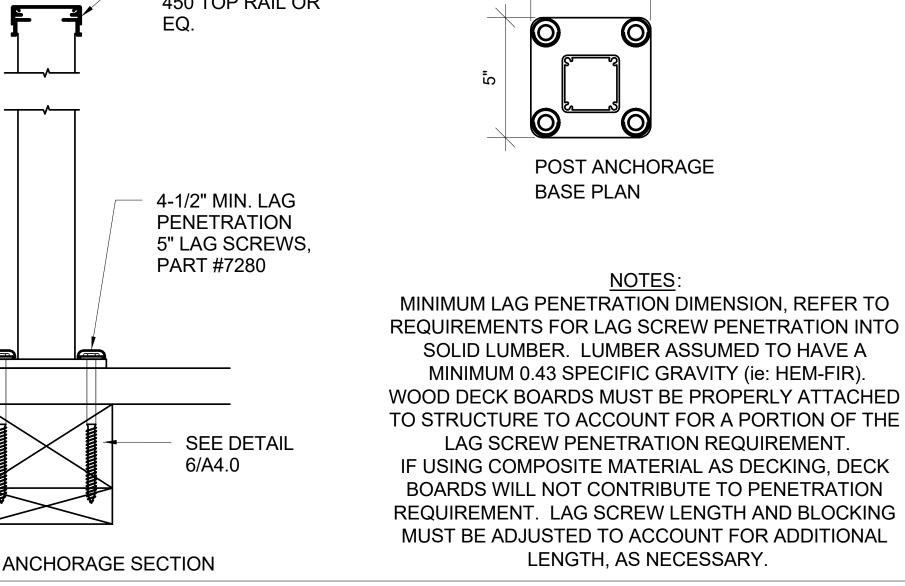

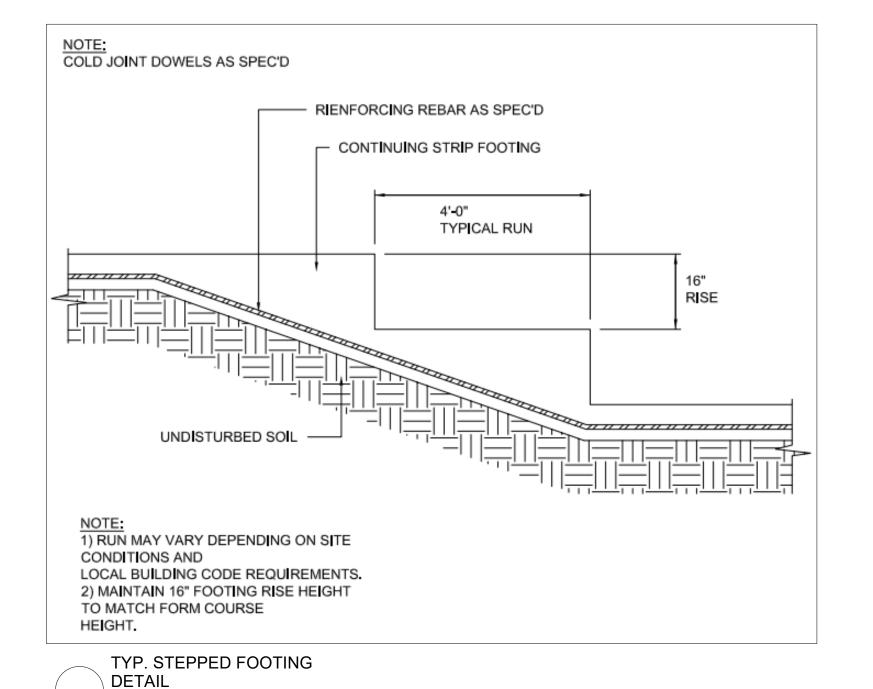


NTS

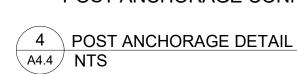

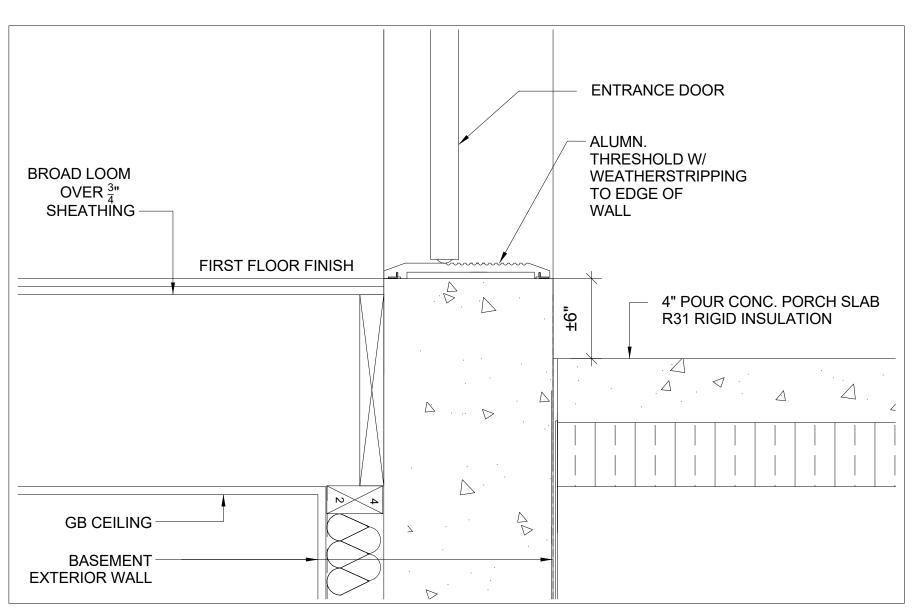



MAIN ENTRANCE PORCH

1 DETAIL A4.5 NTS

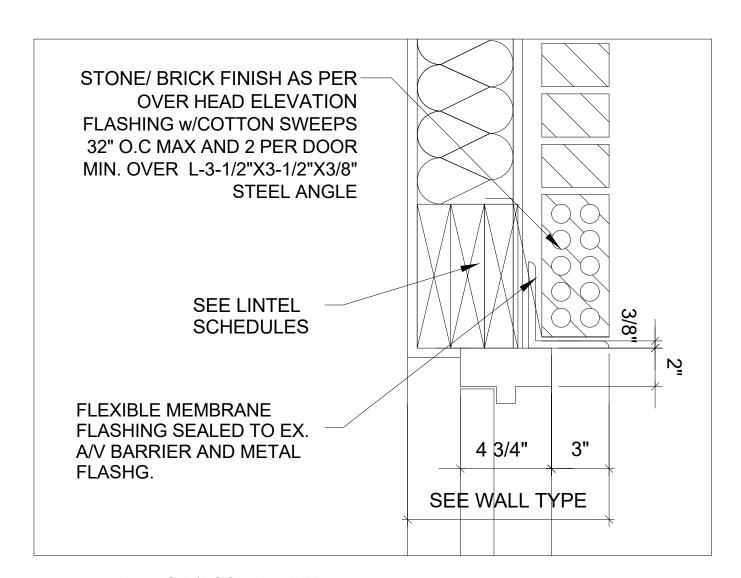



WINDOW/DOOR HEADER 2 DETAIL @ STONE/BRICK A4.5 NTS

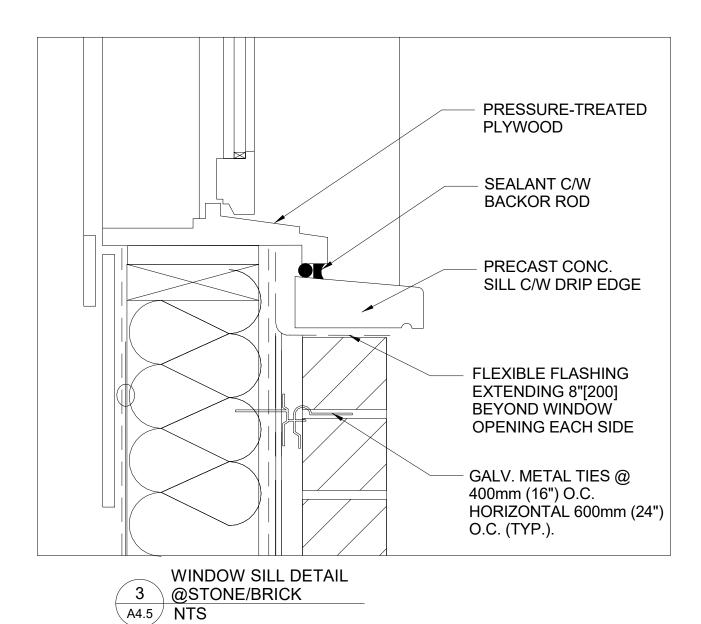

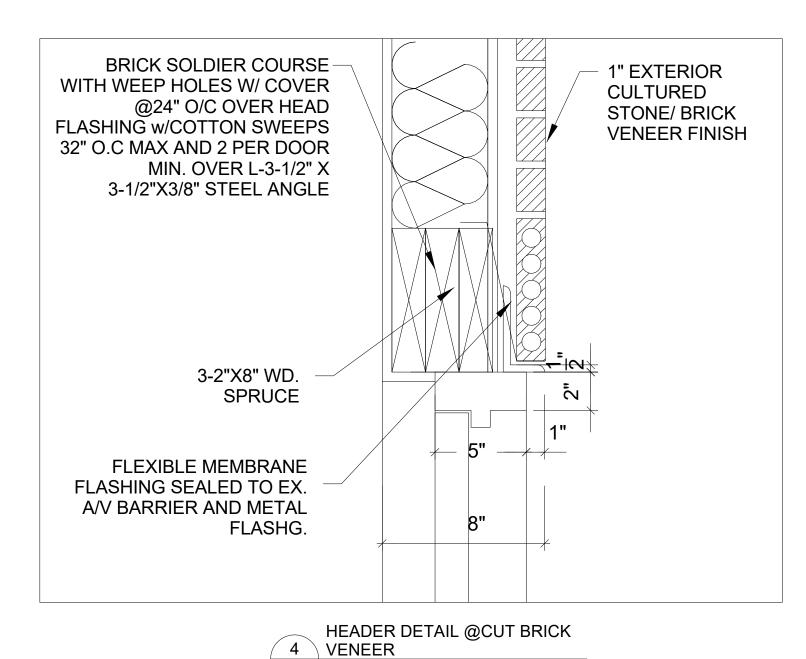


A4.5 NTS

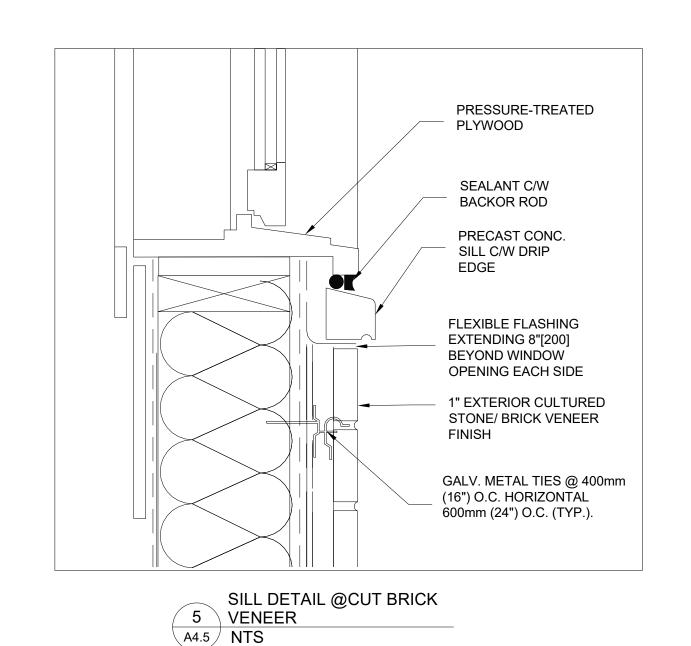

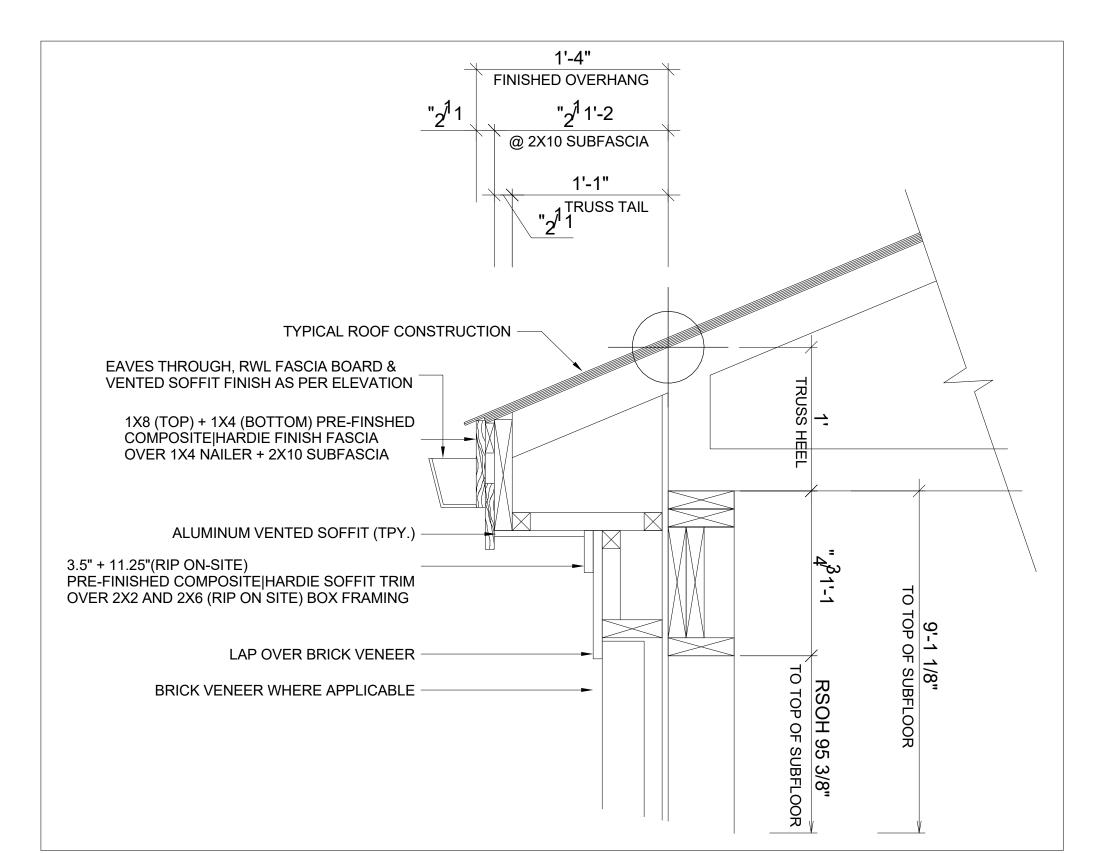

8 SOFFIT DETAILS NTS

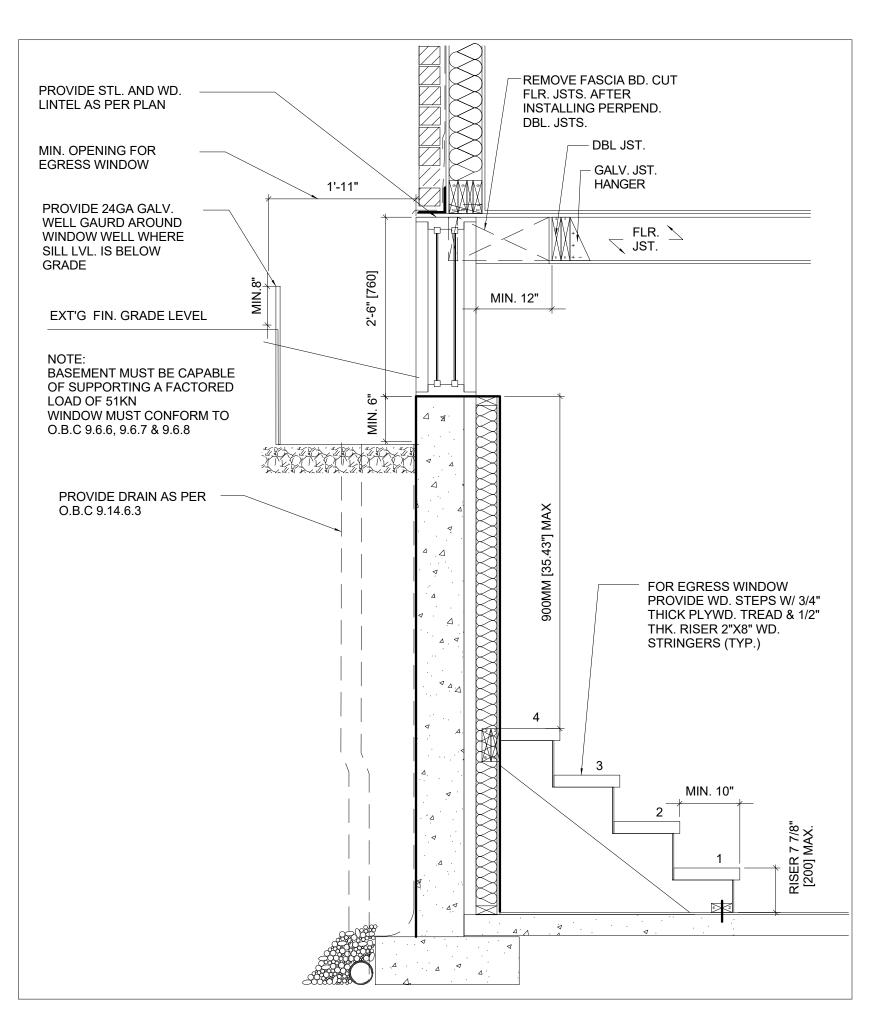

TYP. EGRESS WINDOW SECTION 9 DETAIL @BASEMENT A4.5 3/4" = 1'-0"

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TOWNHOUSE **DEVELOPMENT**

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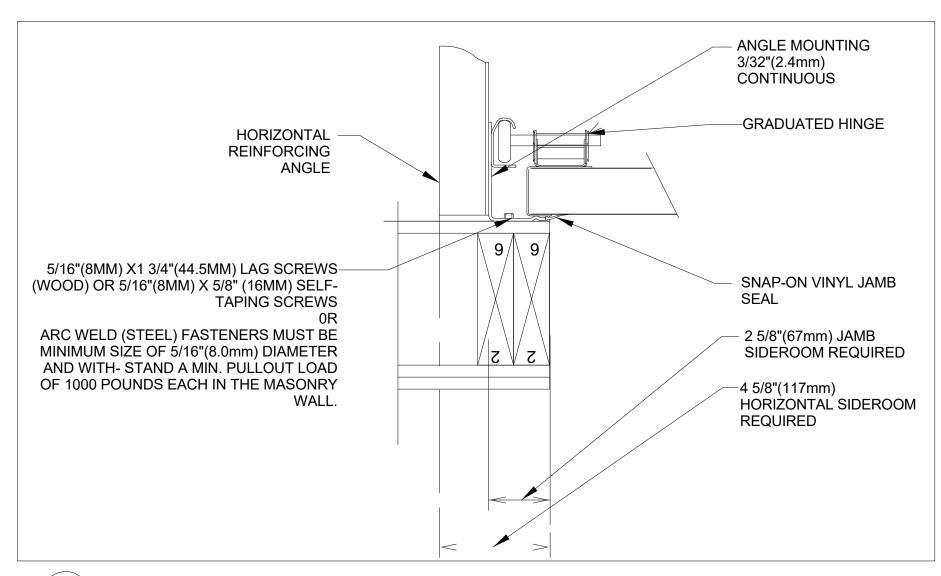
SHEET TITLE:

SHEET NO.


ARCHITECTURAL SET

JOB# 2023019 As indicated SCALE:


SECTIONAL DETAILS




1 GARAGE DOOR DETAIL NTS

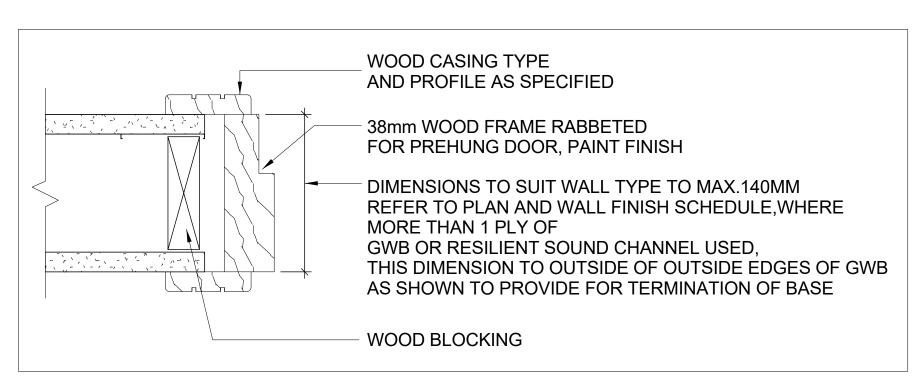


3 TYP. DOOR JAMB DETAIL A4.6 1/8" = 1'-0"

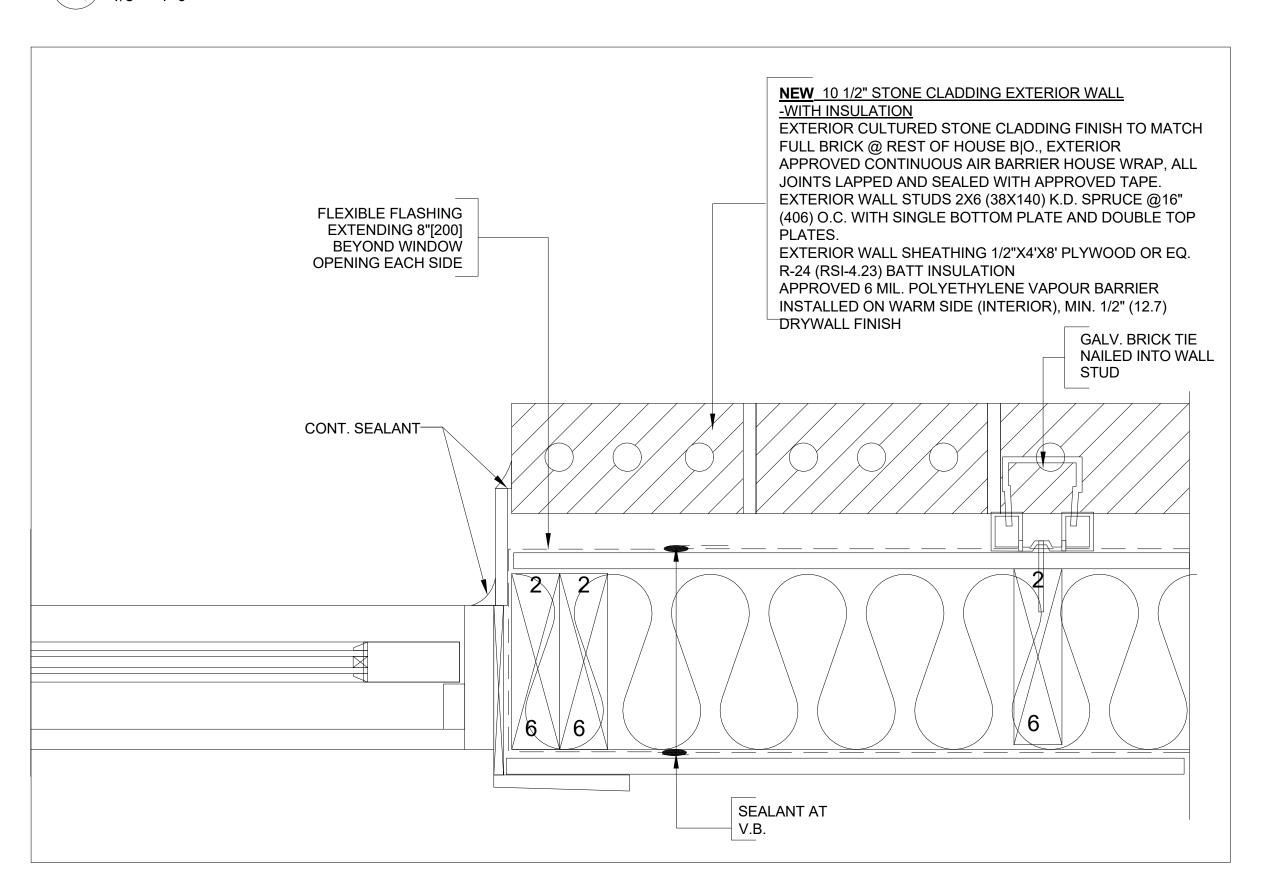

2 WINDOW PLAN DETAIL NTS

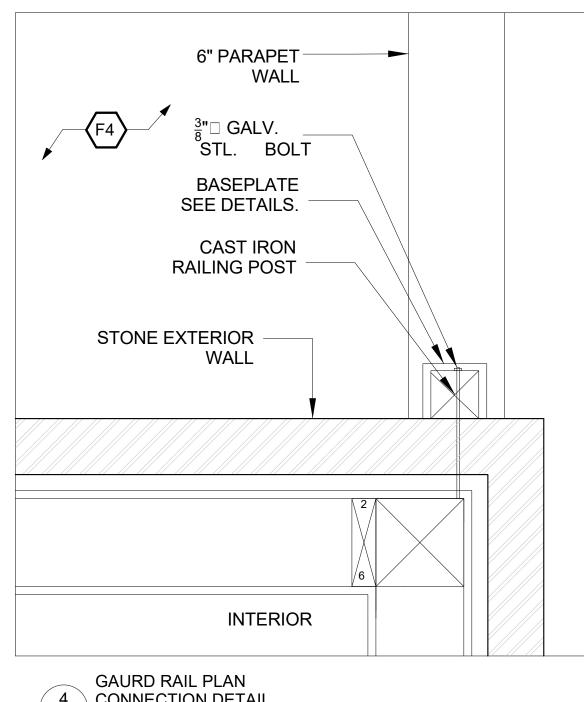

4 CONNECTION DETAIL
A4.6 NTS

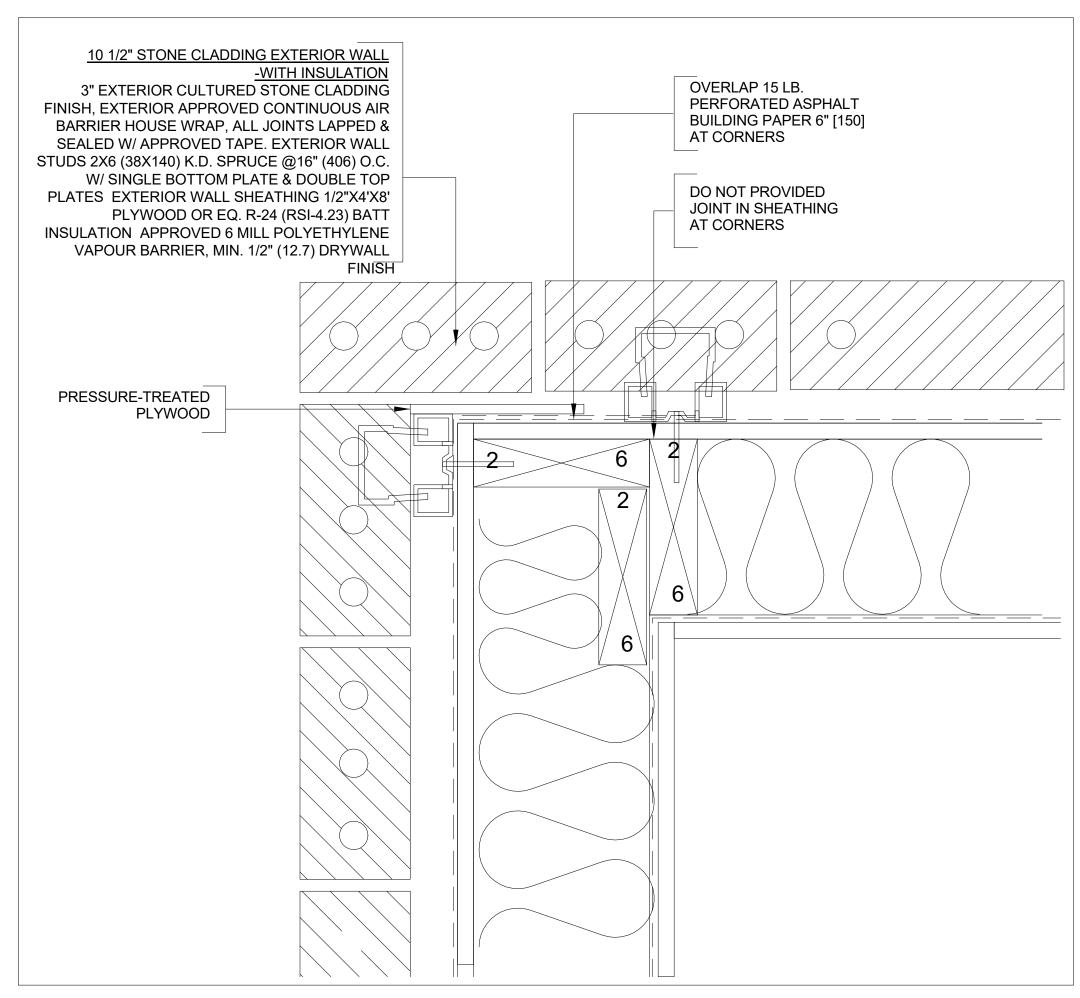

CONER PLAN DETAIL

5 @STONE/BRICK

A4.6 NTS

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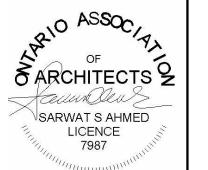
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TOWNHOUSE DEVELOPMENT

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ARCHITECTURAL SET

DRAWING TITLE:

SHEET TITLE:

JOB#


2023019

SCALE: SHEET NO.:


 $\Delta A \epsilon$

As indicated

PLAN DETAILS

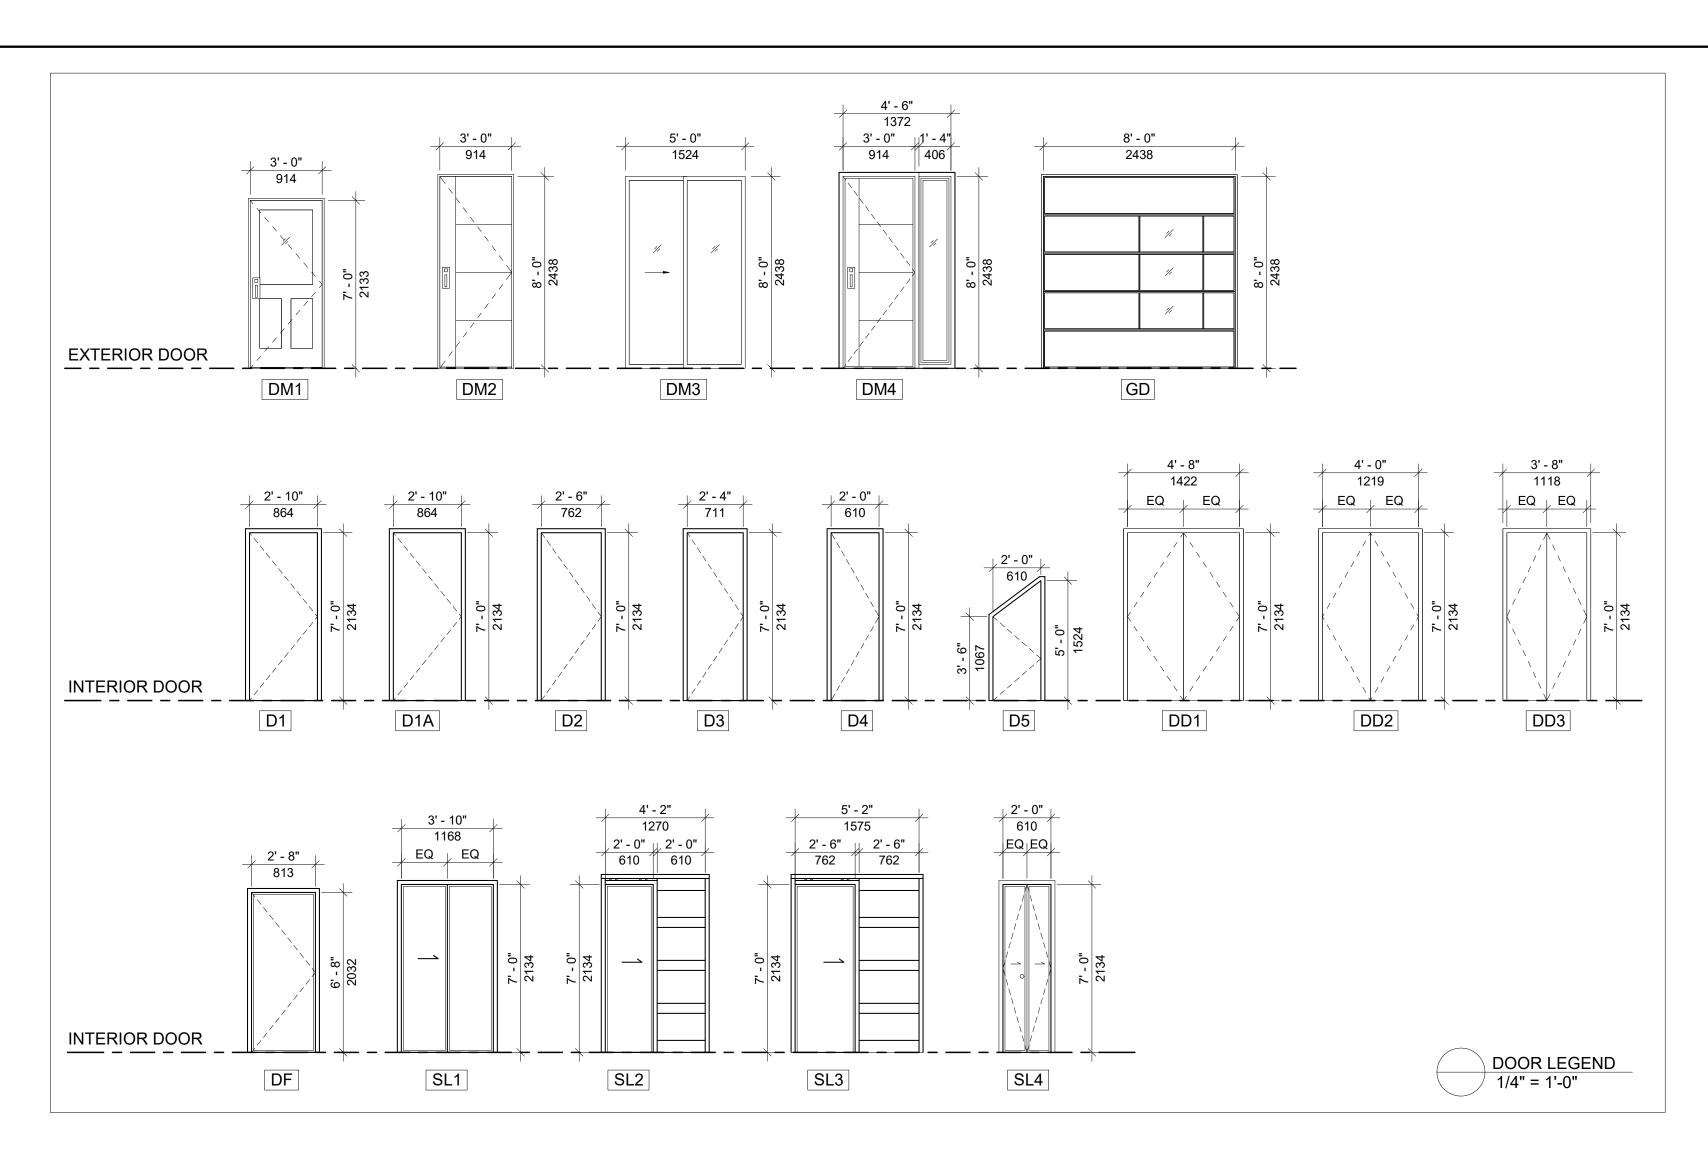

			DOOR SCHEDULES
Type Mark	Width	Height	Description
D1	2' - 10"	7' - 0"	INTERIOR TYPE PANELED DOOR WITH LATCHED LOCK, HINGES AND DOOR STOP
D1A	2' - 10"	7' - 0"	ALUMN. FRAME H.M INSULATED DOOR W/ LATCHED LOCK AT GARAGE WITH GAS-PROOF SEALAN
D2	2' - 6"	7' - 0"	INTERIOR TYPE PANELED DOOR WITH LATCHED LOCK, HINGES AND DOOR STOP
D3	2' - 4"	7' - 0"	INTERIOR TYPE PANELED DOOR WITH LATCHED LOCK, HINGES AND DOOR STOP
D4	2' - 0"	7' - 0"	INTERIOR TYPE PANELED DOOR WITH LATCHED LOCK, HINGES AND DOOR STOP
D5	2' - 0"	5' - 0"	STORAGE DOOR UNDER THE STAIRCASE
DD1	4' - 8"	7' - 0"	INTERIOR TYPE PANELED DOUBLE DOOR WITH LATCHED LOCK, HINGES AND DOOR STOP
DD2	4' - 0"	7' - 0"	INTERIOR TYPE PANELED DOUBLE DOOR WITH LATCHED LOCK, HINGES AND DOOR STOP
DD3	3' - 4"	7' - 0"	INTERIOR TYPE PANELED DOUBLE DOOR WITH LATCHED LOCK, HINGES AND DOOR STOP
DF	2' - 8"	6' - 8"	MIN. 20 MIN. FIRE-RATED INTERIOR TYPE DOOR W/ SELF-CLOSING DEVICE. EMERGENCY EXIT TYPE I/S LOCK
DM1	3' - 0"	7' - 0"	P.F. INSULATED METAL EXTERIOR SINGLE DOOR WITH FIXED GLAZED, COPPER HINGES DOOR LOCK ALUMN. THRESHOLD, WEATHER STRIPPING AND DOOR STOP
DM2	3' - 0"	8' - 0"	P.F. INSULATED METAL EXTERIOR SINGLE DOOR WITH FIXED GLAZED, COPPER HINGES DOOR LOCK ALUMN. THRESHOLD, WEATHER STRIPPING AND DOOR STOP
DM3	5' - 0"	8' - 0"	P.F. INSULATED METAL EXTERIOR SLIDING DOOR WITH FIXED GLAZED, COPPER HINGES DOOR LOCK ALUMN. THRESHOLD, WEATHER STRIPPING AND DOOR STOP
DM4	3' - 0"	8' - 0"	P.F. INSULATED METAL EXTERIOR SINGLE DOOR WITH 16"x 96" SIDE FIXED GLAZED WINDOW, COPPER HINGES DOOR LOCK ALUMN. THRESHOLD, WEATHER STRIPPING AND DOOR STOP
SL1	3' - 10"	7' - 0"	INTERIOR TYPE SLIDING DOOR WITH LATCHED LOCK, HINGES AND DOOR STOP
SL2	2' - 0"	7' - 0"	INTERIOR TYPE POCKET DOOR WITH LATCHED LOCK, HINGES AND DOOR STOP
SL3	2' - 6"	7' - 0"	INTERIOR TYPE POCKET DOOR WITH LATCHED LOCK, HINGES AND DOOR STOP
SL4	2' - 4"	7' - 0"	INTERIOR TYPE BI-FOLDING DOOR WITH LATCHED LOCK, HINGE
SL5	9' - 3"	8' - 0"	

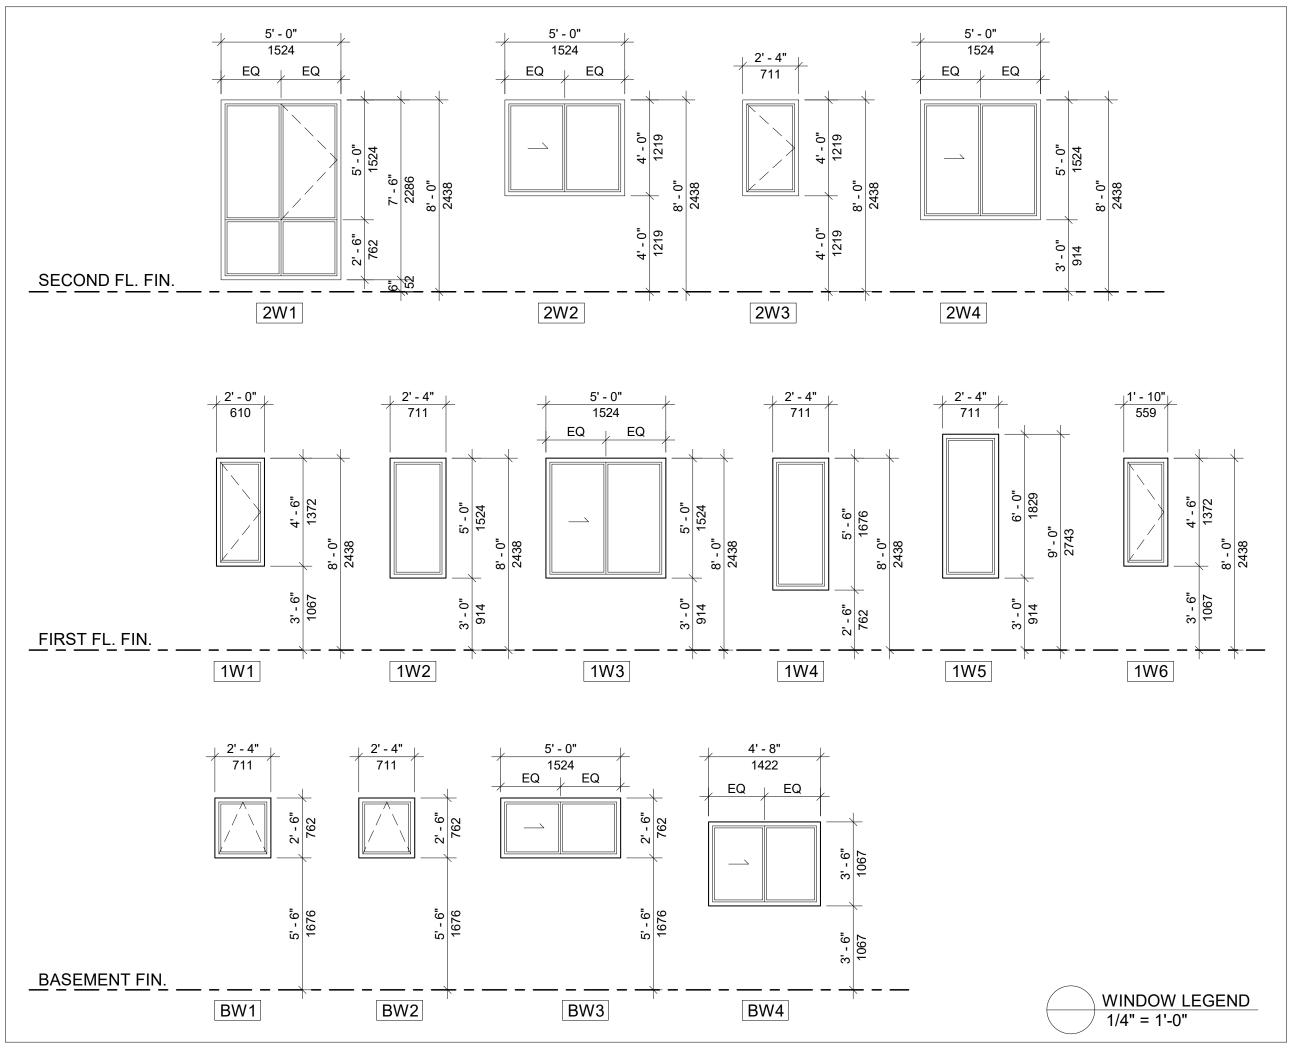

MARK	WIDTH	HEIGHT	DESCRIPTION	COUNT
FIRST FLO	OOR WINDO	WS		
1W1	1'-10"	4'-6"	ALUM. FRAME THERMOPAN DBL GLAZED WINDOW PROVIDE INSERT SCREEN AT OPERABLE PANEL.	5
1W2	2'-4"	5'-0"	DO.	10
1W3	5'-0"	5'-0"	DO.	5
1W4	2'-4"	5'-6"	DO.	1
1W5	2'-4"	6'-0"	DO.	1
1W6	2'-0"	4'-6"	DO.	1
SECOND	FLOOR WIN	DOWS		
2W1	5'-0"	7'-6"	ALUM. FRAME THERMOPAN DBL GLAZED WINDOW PROVIDE INSERT SCREEN AT OPERABLE PANEL.	10
2W2	5'-0"	4'-0"	DO.	2
2W3	2'-4"	4'-0"	DO.	5
2W4	5'-0"	5'-0"	DO.	5
BASEMEN	IT FLOOR W	INDOWS		
BW1	2'-4"	2'-6"	EGRESS WINDOW	5
BW2	2'-4"	2'-6"	ALUM. FRAME THERMOPAN DBL GLAZED WINDOW PROVIDE INSERT SCREEN AT OPERABLE PANEL.	5
BW3	5'-0"	2'-6"	DO.	5
BW4	4'-8"	3'-6"	DO.	5

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LICENCE
7987

PRO IFO

TOWNHOUSE DEVELOPMENT

61 CLAPHAM RD, HAMILTON, ON L8G 2H9

DRAWING TITLE:

ARCHITECTURAL SET

SHEET TITLE:

2023019

1/4" = 1'-0"

DOOR & WINDOW

SCALE: SHEET NO.:

A5.0

CARBON MONOXIDE ALARM/DETECTOR CONFORMING TO CAN/CGA-6.19 OR UL-2034 C.M.A

DAMPERED VENT MIN. 50CFM EF1

CABINET MTD. EXHAUST FAN POWERED BY ELECT. LIGHT SWITCH CONTD. TO O/S DAMPERED VENT MIN. 200 CFM EF2

CLG. MTD. EXHAUST FAN POWERED BY ELECT. LIGHT SWITCH CONTD. TO O/S

HVAC AIR GRILL AT WALL MAX. 5'-0" A.F.F.

RETURN-AIR GRILL AT MAX. 5'-0" A.F.F

120 VOLT DUPLEX RECEPTACLE

220 VOLT 20 AMP, OUTLET

120 VOLT DUPLEX RECEPTACLE WATERPROOF

WALL SWITCH

EMERGENCY LIGHT

CEILING MOUNTED LIGHT

RECESSED INCANDESCENT POT LIGHT

MECH. EXHAUST

ALL NEW ELECTRICAL SERVICES CONFORMING TO O.B.C.2012 SECTION 9.34

FLOOR DRAIN

PROPOSED H.C FLUSH DOOR U/N

STRUCTURAL DESIGN NOTES: **BEAM DESCRIPTION** ASSUMING BEARING CAPACITY OF SOIL = 120kPa

FOUND ALL FOOTINGS ON NATIVE UNDISTURBED B2 1-1/8 x 11-7/8 APA RIM BOARD PLUS STRUTURAL STEEL SHALL CONFORM TO CSA STANDARD CAN/CSA G40.20 G40.21 OR ASTM B3 11-7/8 PJI-40 SEE LUMBER

ALL REBARS SHALL CONFORM TO CAN/CSA G30.18-M92, MIN. YEILD STRENGTH 400 mPa MIN. LAP LENGTH =24XBAR DIA

ASTM A325 OR A490M

SEE LUMBER DRAWINGS

JOIST SCHEDULE

WD. POST SCHEDULE

P1 2-2 x 6 SPF

P2 3- 2 x 6 SPF

P3 4-2 x 6 SPF

P4 4-2 x 4 SPF

P5 3-2 x 4 SPF

P7 4-2 x 8 SPF

J1 11-7/8" PJI

BOLTS & BOLTS ASSEMBLY SHALL CONFORM TO NOTE: PLEASE SEE LUMBER. DWGS. FOR STRUCTURAL FLOOR FRAMING PLANS

> FOOTING DESCRIPTION F1 3'-0"x5'-0"x16" THE FOOTING REINFORCED WITH 5-15M

CONCRETE F2 24" WIDE X 8" TH. REINFORCED WITH 3-10M

CONTINUOUS BARS IN OTTOM BOTH WAYS TO BE POURED WITH 25MPA CONCRETE.

BAR BOTTOM BOTH WAYS AND POURED WITH 25MPA

B1 2.1 RIGIDLAM SP LVL. 1-3/4 x 11-7/8

LINTEL SCHEDULE LINTEL SIZE **OPENINGS UPTO 42" OPENINGS** 2-2 x 6 UPTO 66" OPENINGS 2-2 x 8 **UPTO 78" OPENINGS** 3-2 x 10 P6 4x4 SPF STAIRCASE POST **UPTO 90" OPENINGS** 3- 2 x 12

DUCT TYPE SMOKE DETECTOR

C1 2" DIA STEEL POST

THE AIR DUCT SMOKE DETECTOR SHALL BE A SYSTEM SENSOR INNOVAIRFLEX DNR OR EQ. INTELLIGENT NON-RELAY PHOTOELECTRIC DUCT SMOKE DETECTOR AND DNRW WATERTIGHT NEMA4 DUCT SMOKE DETECTOR. THE DETECTOR HOUSING SHALL BE UL LISTED PER UL 268A SPECIFICALLY FOR USE IN AIR HANDLING SYSTEMS. THE FLEXIBLE HOUSING OF THE DUCT SMOKE DETECTOR FITS BOTH SQUARE AND RECTANGULAR FOOTPRINTS. THE DETECTOR SHALL OPERATE AT AIR VELOCITIES OF 100 FT/MIN TO 4000 FT/MIN (0.5 M/SEC TO 20.32 M/SEC). THE UNIT SHALL BE CAPABLE OF PROVIDING A TROUBLE SIGNAL IN THE EVENT THAT THE SENSOR COVER IS REMOVED OR IMPROPERLY INSTALLED. IT SHALL BE CAPABLE OF LOCAL TESTING VIA MAGNETIC SWITCH OR REMOTE TESTING USING THE RTS451KEY/RTS151KEY REMOTE TEST STATION. TERMINAL CONNECTIONS SHALL BE OF THE STRIP AND CLAMP METHOD SUITABLE FOR 12-18 AWG WIRING. ELECTRICAL RATINGS THE INNOVAIRFLEX SAMPLING TUBE MAY BE INSTALLED FROM THE FRONT OR BACK OF THE DETECTOR. THE TUBE LOCKS SECURELY INTO PLACE AND CAN BE REMOVED BY RELEASING THE FRONT OR REAR LOCKING TAB.

1. GENERAL REQUIREMENTS

1. CONFORM TO REQUIREMENTS OF ALL AUTHORITIES HAVING JURISDICTION.

2. ALL MATERIALS SHALL BE FURNISHED AND ALL WORK SHALL BE PERFORMED IN STRICT ACCORDANCE WITH THE GRADES. OR STANDARDS OF MATERIALS. STANDARDS OF WORKMANSHIP AND MANUFACTURE'S SPECIFICATIONS LISTED OR MENTIONED.

3. CONTRACTOR TO VERIFY ALL DIMENSIONS AND SITE CONDITIONS AND REPORT ANY DISCREPANCIES TO THE ARCHITECT BEFORE COMMENCING THE WORK. CONTRACTOR TO VERIFY STRUCTURE OF WALLS. FLOOR AND CEILING AT NEW ENTRANCES, WINDOWS, CANOPY AND EXTERIOR CLADDING.

4. INSPECT THE EXISTING SITE AND NOTE ANY CONDITIONS WHICH WOULD AFFECT THE WORK. NO CLAIM FOR AN ADDITION TO THE CONTRACT AMOUNT WILL BE CONSIDERED RESULTING FROM FAILURE TO BECOME FAMILIAR WITH ALL, APPARENT EXISTING SITE CONDITIONS.

5. UNLESS OTHERWISE SPECIFIED. PROVIDE AND MAINTAIN ALL NECESSARY PROTECTION INCLUDING HOARDING, BARRICADES, WARNING LIGHTS AND SIGNS, BEFORE AND DURING DEMOLITION WORK.

6. PROTECT ALL MECHANICAL AND ELECTRICAL EQUIPMENT AND PIPING THAT IS TO REMAIN.

7. PROTECT ALL EXISTING FINISH SURFACES WHICH ARE NOT SUBJECT TO DEMOLITION.

8. MAINTAIN PROPER ACCESS TO PREMISES.

9. MAKE GOOD DAMAGE TO SUCH STRUCTURES RESULTING FROM WORK UNDER THIS SECTION AT NO COST TO OWNER.

10 EXERCISE CAUTION IN DISMANTLING OR DISCONNECTING WORK ADJACENT TO EXISTING WORK DESIGNATED TO REMAIN.

11. MAKE GOOD ANY DEMOLITION TO THE EXISTING WORK BEYOND THAT NECESSARY FOR CARRYING OUT NEW WORK, AT NO EXPENSE TO THE OWNER.

12. CARRY OUT DEMOLITION AS SCHEDULED. IN A ORDERLY AND CAREFUL MANNER.

13. AT COMPLETION OF WORK, THE PREMISES SHALL BE LEFT BROOM CLEAN

14. REPORT TO THE ARCHITECT AND INTERIOR DESIGNER ANY DISCREPANCIES BETWEEN ARCHITECTURAL AND INTERIOR DESIGN DRAWINGS. CONTRACTOR TO MAINTAIN AT THE JOB SITE AN UPDATED SET OF DRAWINGS AND RECORD ANY CHANGES TO BUILDING PERMIT DRAWINGS.

2. SITE WORK

 MAINTAIN PROPER ACCESS TO THE SITE. PROVIDE ADEQUATE PROTECTION TO CURBS, SIDEWALKS AND LIGHTS. MAKE GOOD ANY DAMAGE AT NO COST TO THE OWNER.

REMOVE FROM THE SITE AND LEGALLY DISPOSE OF ALL RUBBISH, AND SURPLUS MATERIALS RESULTING FROM THE WORK.

3. CONCRETE

CONCRETE MATERIALS SHALL CONFORM TO REQUIREMENTS OF CAN/CSA A23.1-M90, 266-M78

BEFORE COMMENCING WORK, ENSURE THAT SURFACES ARE ACCEPTABLE TO RECEIVE AND MAINTAIN CONCRETE FINISHING AND THAT SPECIFIED INSTALLATION WILL BE ACHIEVED.

3. PATCHING CONCRETE SHALL BE THOROUGHLY COMPACTED INTO PLACE AND FINISHED IN SUCH A MANNER AS TO MATCH ADJOINING CONCRETE. RUB DOWN TO GIVE UNIFORM, SMOOTH, FLUSH, MONOLITHIC SURFACE FREE OF ALL DEFECTS IN APPEARANCE TO ARCHITECTS APPROVAL.

4. MASONRY

MAINTAIN DIMENSIONS, LINES AND LEVELS OF EXISTING WORK.

2. TAKE SPECIAL CARE OF ERECTING BLOCK WALLS TO WHICH OTHER SECTIONS WILL APPLY FINISHES, TO ENSURE TOLERANCES REQUIRED OF FOLLOWING SECTIONS CAN BE MET WITH REASONABLE CONSTRUCTION PROCEDURES (E.G. THIN SET APPLICATION OF GRANITE TILES.)

3. ALL MASONRY SHALL BE PATCHED AND REPAIRED USING METHODS AND MATERIALS TO MATCH EXISTING WORK. 5. METALS

CONFORM TO REQUIREMENTS OF CAN/CSA-G40.21 & M92 (HOT DIP GALV. PARTS)

2. WORK TO BE EXECUTED BY FIRM THOROUGHLY FAMILIAR WITH LAWS, BY-LAWS AND REGULATIONS WHICH GOVERN, AND CAPABLE OF WORKMANSHIP OF BEST GRADE AND FIELD PRACTISE KNOWN TO BE RECOGNIZED MANUFACTURE'S SPECIALIZING IN THIS WORK.

PAINT PRIMER TO BE ZINC CHROMATE CONFORMING TO CGSB 1-6P-40D. FINISH COLOUR TO BE AS PER APPROVED SAMPLE BY INTERIOR DESIGNER.

6. WOOD AND PLASTICS

- MATERIALS SHALL BE CAREFULLY CHECKED, UNLOADED STORED AND HANDLED TO PREVENT DAMAGE. PROTECT MATERIALS WITH SUITABLE NON-STAINING WATERPROOF COVERINGS.
- SUPPLY ALL LABOUR, MATERIALS, EQUIPMENT, SERVICES AND PERFORM ALL OPERATIONS REQUIRED TO COMPLETE ALL ROUGH CARPENTRY WORK. TO THE
- ALL INTERIOR ROUGH CARPENTRY APPLIED TO WALLS, FLOORS, AND CEILING IS TO HAVE A FLAME SPREAD RATING OF 150 OR LESS.

FULL INTENT OF THE DRAWINGS AND AS HEREIN SPECIFIED.

- 7. THERMAL AND MOISTURE PROTECTION
- MAINTAIN EXISTING LEVELS OF INSULATION.
- 2 ALL MATERIALS AND METHODS USED IN APPLICATION SHALL BE IN STRICT ACCORDANCE WITH THE PRINTED INSTRUCTIONS OF THE MANUFACTURER
- INSTALL INSULATION TO MAINTAIN CONTINUITY OF THERMAL PROTECTION TO BUILDING ELEMENTS AND SPACES.
- 4. INSTALL LOOSE INSULATION IN LOCATIONS AND THICKNESS SHOWN, AND FOR PACKING WHERE REQUIRED TO MAINTAIN THE INTEGRITY OF THE THERMAL BARRIER. SEAL JOINTS TO PREVENT THE TRANSFER OF MOISTURE.
- 5. SEALANTS AND COLOUR TO BE SELECTED BY INTERIOR DESIGNER.
- CLEAN JOINTS AND SPACES TO BE CAULKED AND ENSURE THEY ARE DRY AND FREE OF DUST, LOOSE MORTAR, OIL, GREASE AND OTHER FOREIGN MATERIAL. CLEAN FERROUS MATERIALS OR RUST, MILL, SCALE AND FOREIGN MATERIALS BY WIRE BRUSHING, GRINDLING OR SANDING.
- UPON COMPLETION, REMOVE MASKING AND SEALANT SMEARS AND DROPPINGS FROMADJACENT AND OTHER SURFACES.
- 8. PATCH AND REPAIR EXISTING WORK, REQUIRED DUE TO THE WORK OF THE CONTACT. USE THE EXACT SAME METHODS AND MATERIALS TO MATCH THE EXISTING WORK. WHERE IT IS NOT POSSIBLE, SUBMIT PROPOSALS TO THE INTERIOR DESIGNER FOR APPROAVAL.
- CAULKING: PROVIDE CAULKING AS PER OBC 9.27.4 AT ALL EXPOSED JOINTS BETWEEN MASONRY TO WINDOWS, ROOFING, AND FLASHINGS.

8. DOORS AND WINDOWS

STEEL DOORS AND FRAMES:

SUBMIT SHOP DRAWINGS IN ACCORDANCE WITH GENERAL CONDITIONS, SHOW EACH TYPE OF FRAME. DOOR. HARDWARE BLANKING. REINFORCING TAPPING AND DRILLING ARRANGEMENTS. MÉTAL GAUGES, THICKNÉSS AND FINISHES. SUBMIT DOOR AND FRAME SCHEDULE IDENTIFYING EACH UNIT. APPROVAL TO BE MADE BY INTERIOR DESIGNER.

WOOD DOORS AND FRAMES:

TO ARCHITECTURAL WOODWORK MANUFACTURERS ASSOCIATION OF CANADA LATEST REVISIONS, FOR PREMIUM GRADE SPECIALTY DOORS.

SUBMIT SHOP DRAWINGS IN ACCORDANCE WITH GENERAL CONDITIONS ILLUSTRATING DOOR CONSTRUCTION FOR THE INTERIOR DESIGNER TO REVIEW

9. FINISHES

GYPSUM WALLBOARD:

- EXECUTE THE GYPSUM WALLBOARD WORK COMPLETE IN ALL RESPECTS AND FREE OF DEFECTS IN MATERIALS AND WORKMANSHIP AFFECTING APPEARANCE AND PERFORMANCE.
- EXAMINE AND CO-ORDINATE WORK WITH THE OTHER TRADES AND ENSURE THAT ANCHORS, GROUNDS, ELECTRICAL CONDUIT, WIRING AND MECHANICAL WORK, WHICH IS TO BE INSTALLED IN OR BEHIND WORK UNDER THIS CONTRACT HAS BEEN INSTALLED, TESTED AND APPROVED.
- CONFORM TO CURRENT C.S.A. STANDARDS A82.30 AND A82.31, EXEPT AS SPECIFIED OTHERWISE HEREIN.
- 4. FINISHED GYPSUM WALLBOARD SURFACES SHALL BE TRUE PLANES WITHIN 1/8 INCH WHEN CHECKED WITH 12 FEET STRAIGHT EDGE PLACED ANYWHERE ON THE SURFACE. SURFACES SHALL BE FREE FROM WAVES. IRREGULATIONS AND OTHER DEFECTS. VERTICAL SURFACES. PLUMB AND TRUE TO LINE. HORIZONTAL SURFACES

Brampton, ON L6X 1N4 Tel: 905-858-2565 Cell: 647-295-2565

email: archisystem@gmail.com

CONSULTING ARCHITECTS

PROJECT ARCHITECTS:

279 Main Street North

NOTES:

www.thearchisystem.com

THE DRAWINGS SHALL NOT BE SCALED.

ARCHISYSTEM INC.

CERTIFICATE OF PRACTICE # 5465

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ALLWORKS TO BE DONE ACCORDING TO BEST COMMON PRACTICE AND CONFORM TO PREVAILING ONTARIO BUILDING CODE.

OWNER / CLIENT:

LA CABAN DEVELOPMENTS INC.

STRUCTURAL ENGINEERS:

BUILDING PERMIT 10-10-2024 Issued For:



PROJECT:

SHEET TITLE:

JOB#

TOWNHOUSE **DEVELOPMENT**

61 CLAPHAM RD, HAMILTON, ON L8G 2H9

ARCHITECTURAL SET


DRAWING TITLE:

NOTES & LEGENDS

As indicated SCALE: SHEET NO.:

2023019

EXTERIOR WALL TYPES

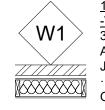

10 1/2" STONE CLADDING EXTERIOR WALL <u>-WITH INSULATION</u>

3" EXTERIOR CULTURED STONE CLADDING FINISH, EXTERIOR APPROVED CONTINUOUS AIR BARRIER HOUSE WRAP, ALL JOINTS LAPPED & SEALED W/ APPROVED TAPE.

· EXTERIOR WALL STUDS 2X6 (38X140) K.D. SPRUCE @16" (406) O.C. W/ SINGLE BOTTOM PLATE & DOUBLE TOP PLATES · EXTERIOR WALL SHEATHING 1/2"X4'X8' PLYWOOD OR EQ. R-24 (RSI-4.23) BATT INSULATION APPROVED 6 MIL. POLYETHYLENE VAPOUR BARRIER, MIN. 1/2"

10 1/2" STONE/BRICK CLADDING EXTERIOR WALL

-WITH INSULATION 3" EXTERIOR CULTURED BRICK CLADDING FINISH, EXTERIOR APPROVED CONTINUOUS AIR BARRIER HOUSE WRAP, ALL JOINTS LAPPED & SEALED W/ APPROVED TAPE. · EXTERIOR WALL STUDS 2X6 (38X140) K.D. SPRUCE @16" (406) O.C. W/ SINGLE BOTTOM PLATE & DOUBLE TOP PLATES EXTERIOR WALL SHEATHING 1/2"X4'X8' PLYWOOD OR EQ. R-24 (RSI-4.23) BATT INSULATION

7 1/2" THIN STONE/ BRICK CLADDING EXTERIOR WALL

1" EXTERIOR CULTURED STONE/ BRICK VENEER FINISH ON 1/2" SCRATCH COAT, EXTERIOR APPROVED CONTINUOUS AIR BARRIER HOUSE WRAP, ALL JOINTS LAPPED & SEALED W/ APPROVED TAPE. · 1/2" PLYWOOD ON EXTERIOR WALL STUDS 2x6 K.D. SPRUCE @16" (406) O.C. W/ SINGLE BOTTOM PLATE & DOUBLE TOP PLATES · EXTERIOR WALL SHEATHING 1/2"X4'X8' PLYWOOD OR EQ.

8 1/8" STUCCO FINISH EXTERIOR WALL -WITH INSULATION

·R24 BATT INSULATION 6MIL POLY AVB. 1/2" GWB TAPPED & PLASTERED. PROVIDE MOISTURE -RESISTANT GWB ON ALL WATER-BOURNE AREAS 1-2" POUR CONC. REINFORCED WALL - WITH INSULATION 8" (200) REINFORCED POURED CONCRETE WALLS,

2" CONTINUOUS 2LBS SPRAY FOAM INSULATION, 2x4 WD. STUD WALL OVER 2X4 P|T SILL PLATE, SINGLE BOTTOM AND TOP PLATES @ 16" O|C - C|W R-12 BATT INSULATION. COMBINED R24., 6 MIL POLY VAPOUR BARRIER, MIN. 1/2" DRYWALL FINISH.




8" POUR CONC. REINFORCED WALL 8" POUR CONC. REINFORCED WALL O/S TROWEL APPLIED WATERPROOFING LAYER, PROTECTION BOARD W/ GRAVEL REFILLING, INTERIOR SMOOTH SURFACE W/



P2`

8" MASONRY WALL STUCCO FINISH ON 190mm CONCRETE BLOCK WALL OR MATCH THE EXTERIOR WALL FINISH (STONE/BRICK)

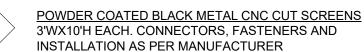


6 1/2" INTERIOR WALL - WITH INSULATION

1/2" GWB., SPRAY-FOAM INSULATION R24,

GAS PROOF WALL CONSTRUCTION

NOTE: FOR FOUNDATION WALLS TO BE AS PER STRUCTURAL DRWS.

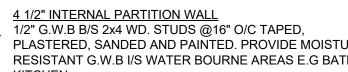


10 1/2" INTERIOR LOAD BEARING WALL


INTERIOR WALL TYPES

1/2" GWB. B/S 2x10 WD. STUDS @16" O/C TAPED, P3 PLASTERED, SANDED AND PAINTED. PROVIDE MOISTURE RESISTANT G.W.B I/S WATER BOURNE AREAS E.G BATHS & KITCHEN

9" 45 MIN FIRE-RATED (W13b - STC 57) PARTY WALL

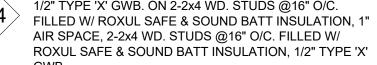

10" 3 HR FIRE-RATED (B4c - STC 50) CMU. 5/8" [15.9mm] TYPE 'X' GWB., 1/2" RESILIENT METAL CHANNEL ON 190mm CONCRETE BLOCK, 1/2" RESILIENT

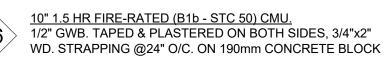

4 1/2" 1 HR FIRE-RATED PARTITION WALL (W6h - OBC.2012 SB3 - STC.50)

1/2" REGULER G.W.B B/S TAPED & PLASTERED, RESILIENT CHANNEL AT 24" O/C. 3 1/2" BATT INSULATION FRICTION FIT B/W STUDS @ 24" O/C T/B PLATES, PROVIDE MOISTURE RESISTANT 1/2" G.W.B FOR ALL WATER BOURNE AREAS

FLOORING TYPES


WOOD FLOORING 3/4" ENG. WD. FLOOR TO MATCH EXISTING WD. FLOORING COLOUR (T.B.D.) W/T & G JOINTS OVER 1/8" THICK STYROFOAM UNDERLAY OVER 6MIL A.V.B. OVER FLOOR JOIST OR CONC. SLAB

PORCELAIN TILES FLOORING 12"x12"x3/4" PORCELAIN TILE FLOORING (COLOUR T.B.D.) W/ MIN 1/2" THICK CEMENT MORTAR MIN. 1/8" WIDE MATCHING GROUTED JOINTS OVER FLOOR JOIST OR CONC. SLAB

UNFINISHED CONC. FLOORING 4" POURED CONCRETE SLAB, REINFORCED (SEE STRUCT.) MIN.1/2" SCREED BOARD AROUND PERIMETER, MIN. R-10 (RSI-1.76) RIGID FOAM INSULATION UNDER ENTIRE SLAB, COMPACTED COARSE AND GRANULAR STONE INFILL, SOIL GAS\RADON CONTROL AS PER O.B.C 9.1.1.7 AND 9.13.4.

45 MINUTES FIRE-RATED WOOD FLOORING



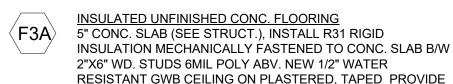

CEILING TYPES


1/2" GWB SMOOTH PLASTERED CEILING ON PLASTERED, TAPED PROVIDE SMOOTH PLASTER


UNDERSIDE OF STAIRCASE

DOUBLE 15.9MM TYPE X GYPSUM WALL BOARD





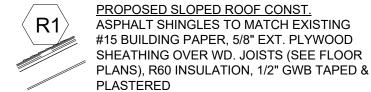

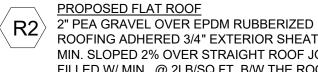

ROOFING ADHERED 3/4" EXTERIOR SHEATHING MIN. SLOPED 2% OVER STRAIGHT ROOF JOISTS FILLED W/ MIN. @ 2LB/SQ.FT. B/W THE ROOF JOISTS 5/8" THICK GWB. CEILING TAPED, SMOOTHED PLASTERED, SANDED AND PAINTED

- WITH OUT INSULATION

(12.7) DRYWALL FINISH

(12.7) DRYWALL FINISH

10 1/2" BRICK CLADDING EXTERIOR WALL

W4 APPROVED 6 MIL. POLYETHYLENE VAPOUR BARRIER, MIN. 1/2"

-WITH INSULATION

· R-24 (RSI-4.23) BATT INSULATION APPROVED 6 MIL. POLYETHYLENE VAPOUR BARRIER, MIN. 1/2" (12.7) DRYWALL FINISH

·1/8" STUCCO OVER 2" RIGID INSULATION DRAINAGE LAYER ·1/2" R-5 XP INSULSHEATHING EXTERIOR SHEATHING ·2"X6" WD. STUDS @ 16" O/C TOP/BOTTOM PLATES

CEMENT MORTAR PARGING WHERE REQUIRED.

INTERIOR WALL TYPES

@GARAGE


PLASTERED. SANDED AND PAINTED. PROVIDE MOISTURE RESISTANT G.W.B I/S WATER BOURNE AREAS E.G BATHS & KITCHEN


METAL CHANNEL, 5/8" [15.9mm] TYPE 'X' GWB. 10" 1.5 HR FIRE-RATED (B1b - STC 50) CMU.



F17d (51 STC)

RESISTANT GWB CEILING ON PLASTERED, TAPED PROVIDE SMOOTH PLASTER

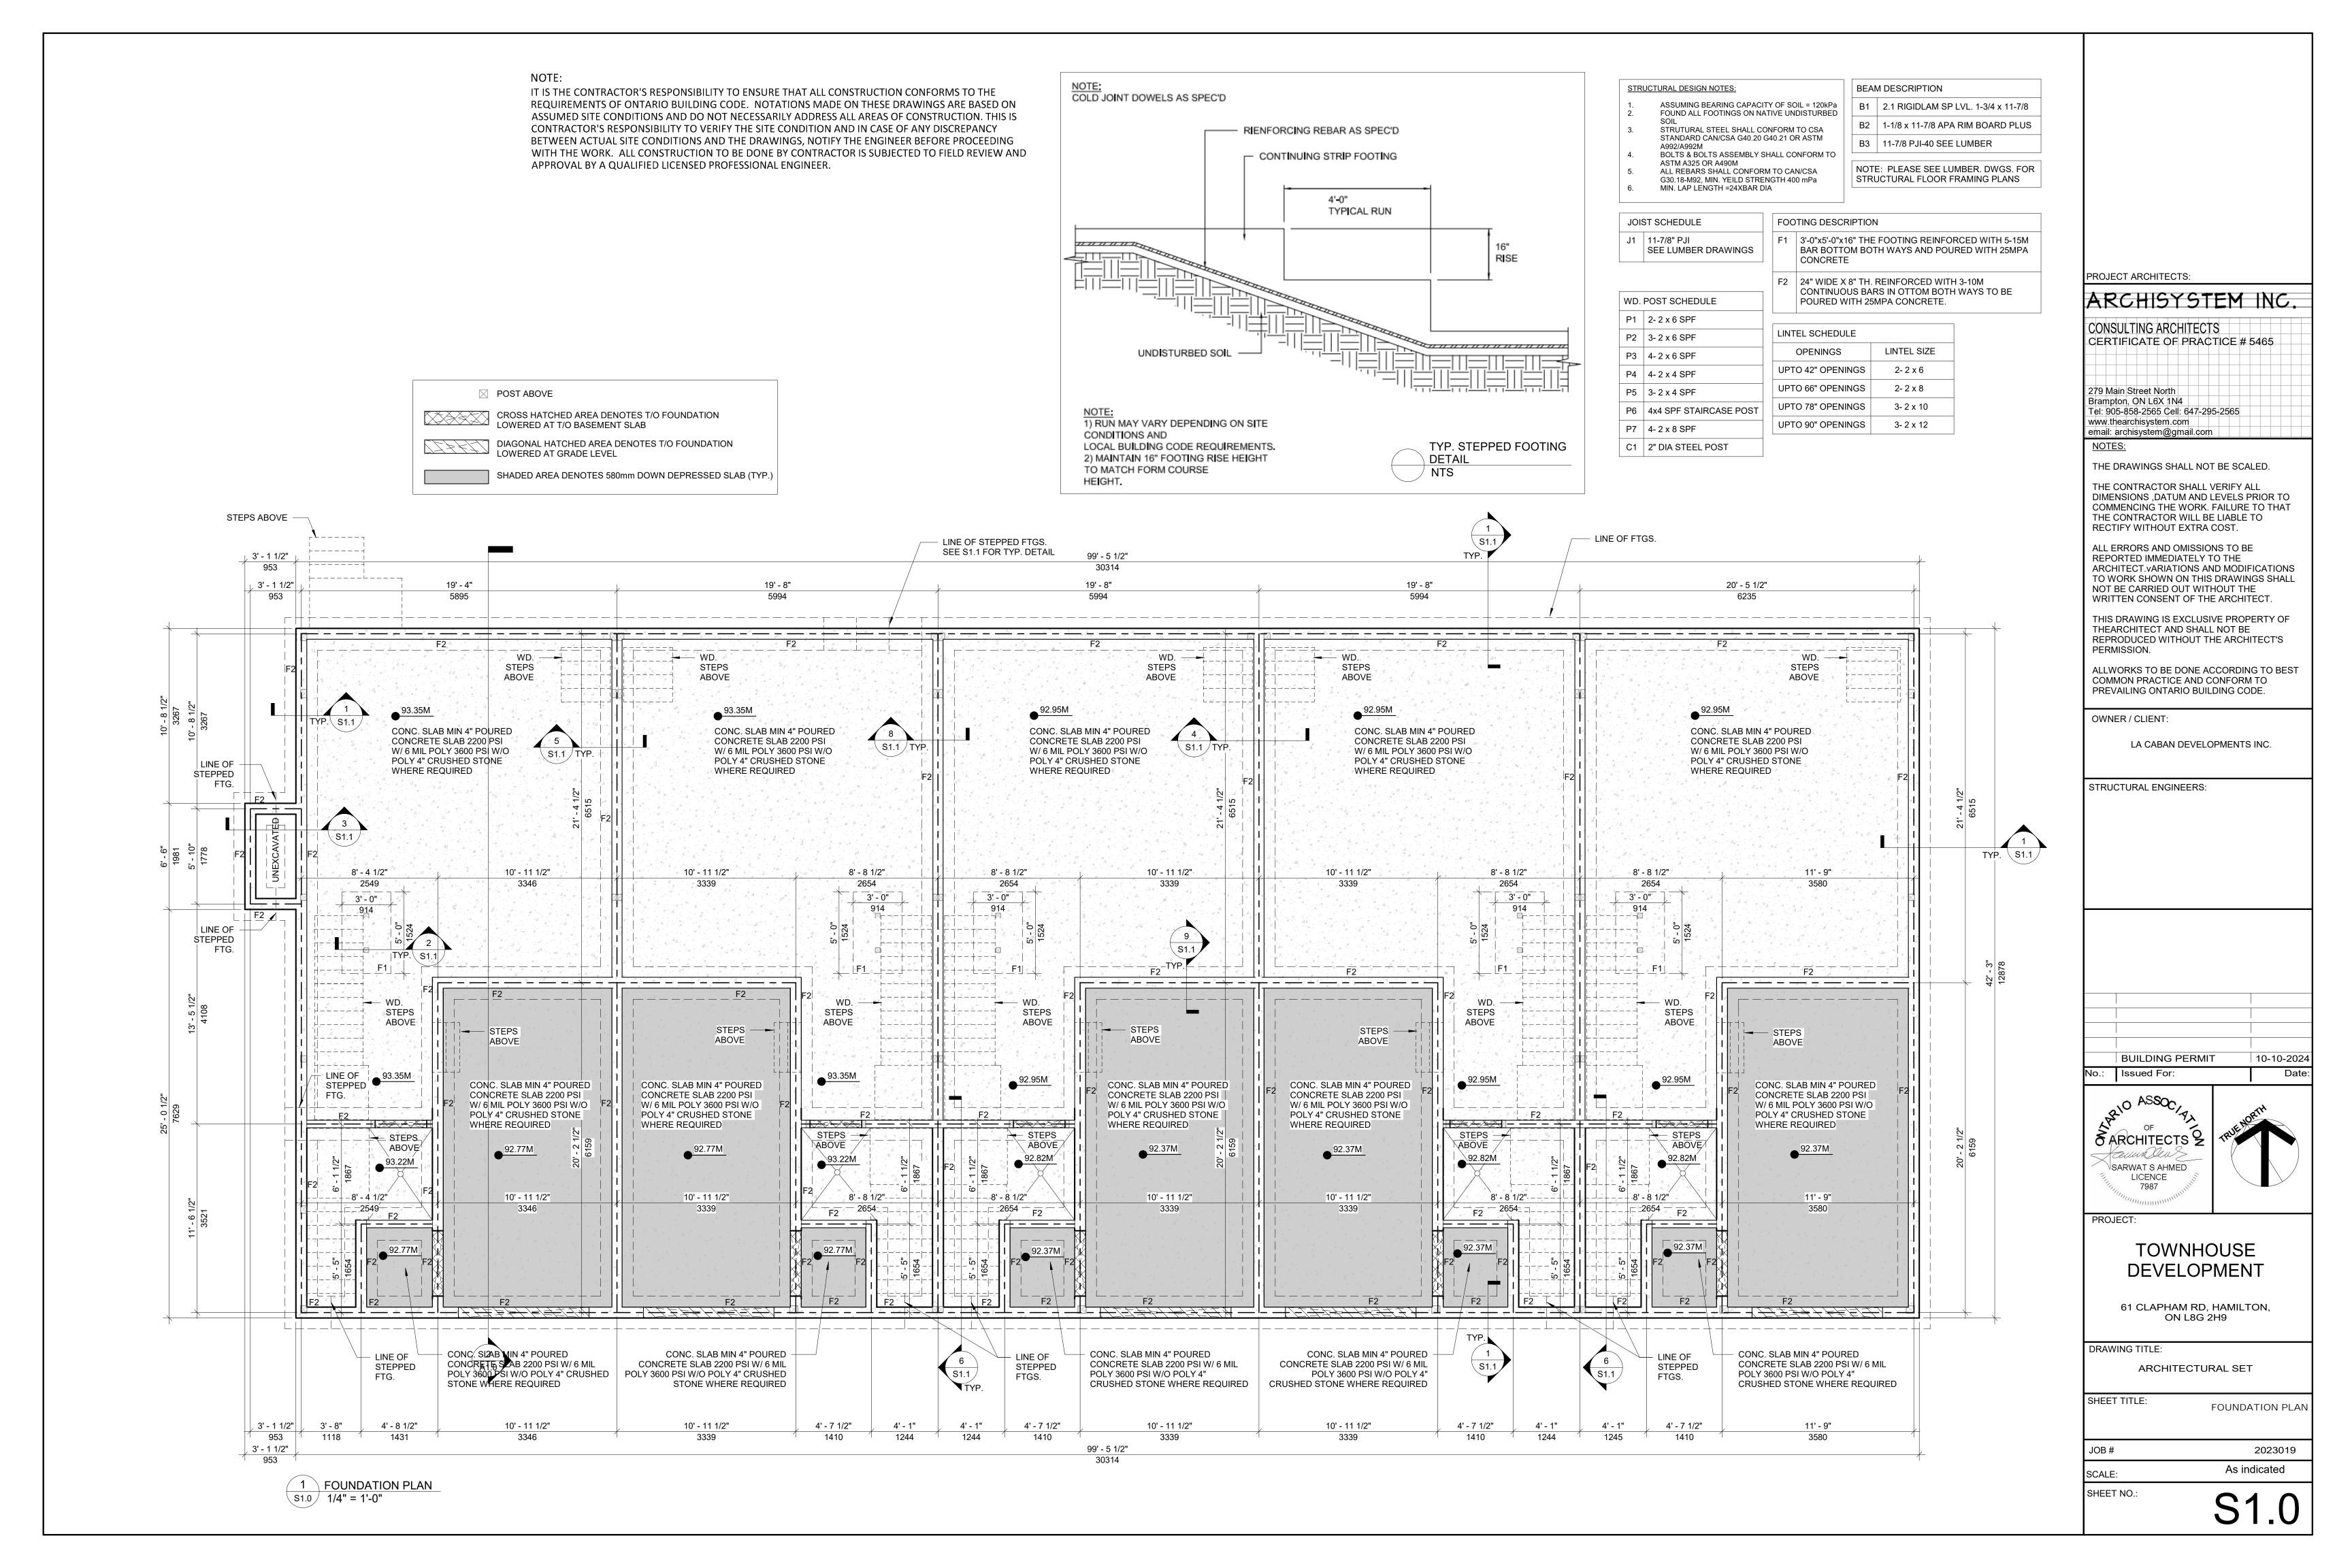

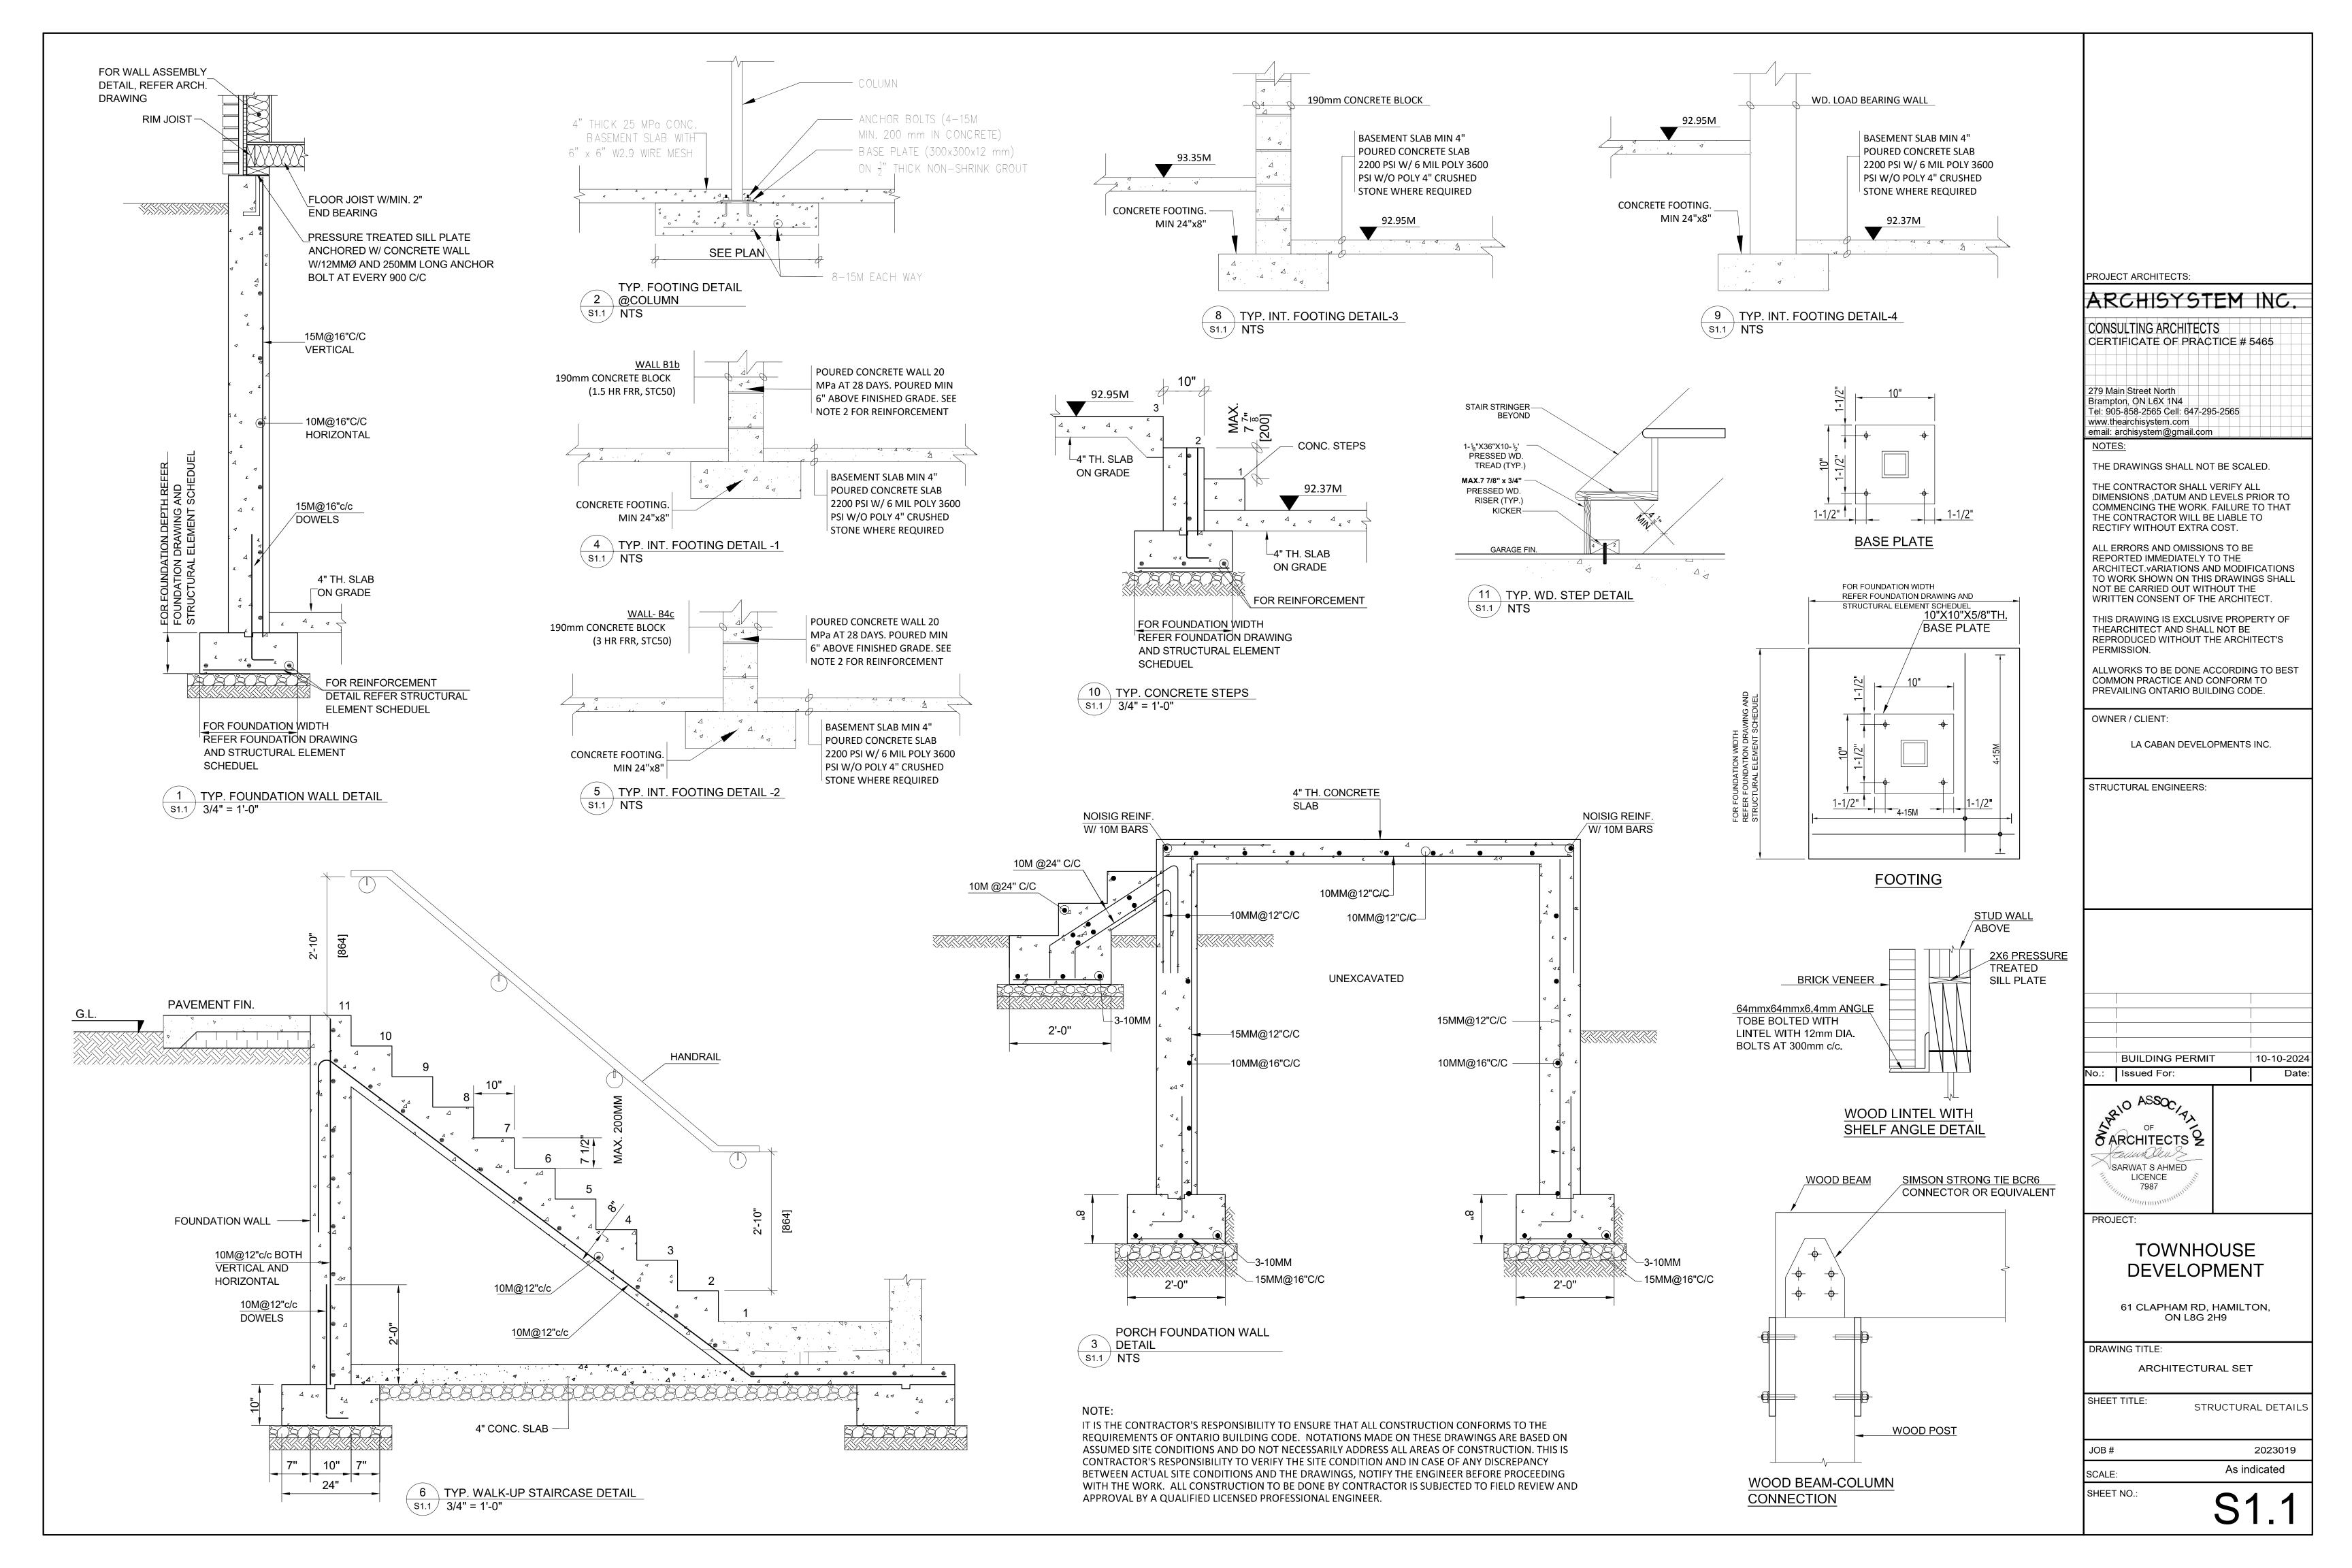



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STRUCTURAL DESIGN NOTES: 1. ASSUMING BEARING CAPACITY OF SOIL = 120kPa

ASSUMING BEARING CAPACITY OF SOIL = 120kPa
FOUND ALL FOOTINGS ON NATIVE UNDISTURBED
SOIL
STRUTURAL STEEL SHALL CONFORM TO CSA
STANDARD CAN/CSA G40.20 G40.21 OR ASTM
A992/A992M
BOLTS & BOLTS ASSEMBLY SHALL CONFORM TO
ASTM A325 OR A490M
ALL REBARS SHALL CONFORM TO CAN/CSA
G30.18-M92, MIN. YEILD STRENGTH 400 mPa

BEAM DESCRIPTION		
B1	2.1 RIGIDLAM SP LVL. 1-3/4 x 11-7/8	
B2	1-1/8 x 11-7/8 APA RIM BOARD PLUS	
В3	11-7/8 PJI-40 SEE LUMBER	

NOTE: PLEASE SEE LUMBER. DWGS. FOR

STRUCTURAL FLOOR FRAMING PLANS

JOIST SCHEDULE
J1 11-7/8" PJI

SEE LUMBER DRAWINGS

MIN. LAP LENGTH =24XBAR DIA


FOOTING DESCRIPTION

F1 3'-0"x5'-0"x16" THE FOOTING REINFORCED WITH 5-15M
BAR BOTTOM BOTH WAYS AND POURED WITH 25MPA
CONCRETE

WD. POST SCHEDULE

F2 24" WIDE X 8" TH. REINFORCED WITH 3-10M CONTINUOUS BARS IN OTTOM BOTH WAYS TO BE POURED WITH 25MPA CONCRETE.

P1	2-2 x 6 SPF			
P2	3- 2 x 6 SPF	LIN	TEL SCHEDULE	
P3	4- 2 x 6 SPF		OPENINGS	LINTEL SIZE
P4	4- 2 x 4 SPF	UP	TO 42" OPENINGS	2- 2 x 6
P5	3- 2 x 4 SPF	UP	TO 66" OPENINGS	2-2 x 8
P6	4x4 SPF STAIRCASE POST	UP	TO 78" OPENINGS	3- 2 x 10
		IID	TO 90" OPENINGS	3- 2 x 12
P7	4-2 x 8 SPF		TO 90 OI LININGS	J- Z X 1Z

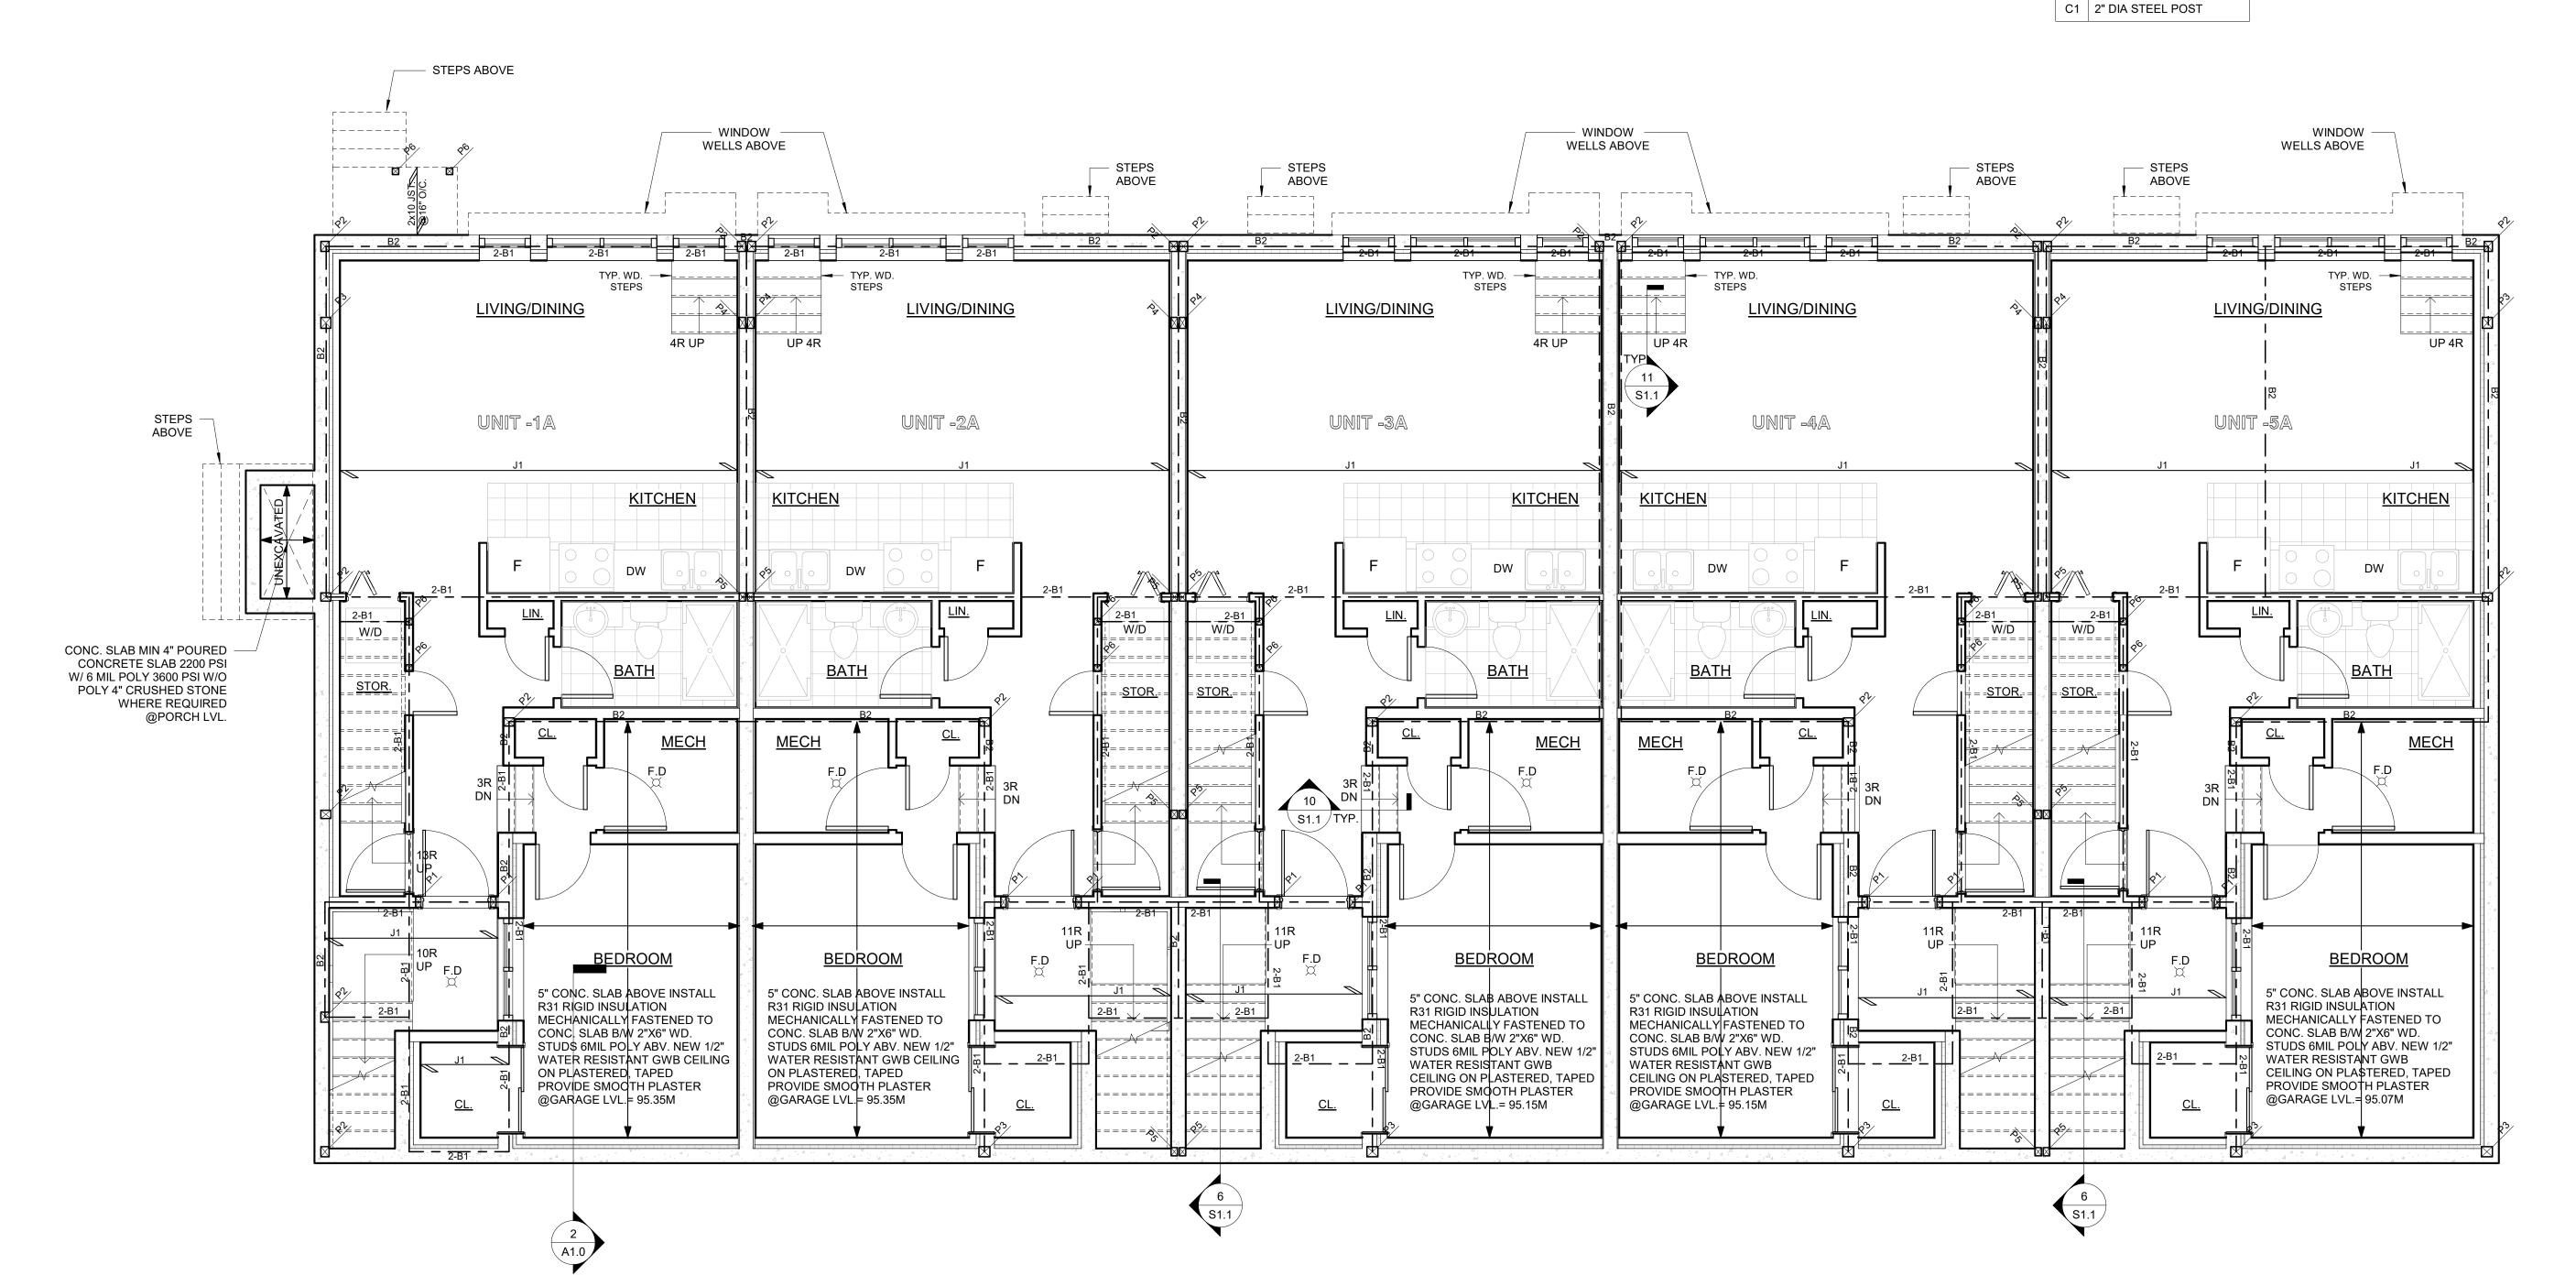

1 FIRST FLOOR FRAMING PLAN S2.0 1/4" = 1'-0" PROJECT ARCHITECTS:

ARCHISYSTEM INC.

CONSULTING ARCHITECTS
CERTIFICATE OF PRACTICE # 5465

279 Main Street North
Brampton, ON L6X 1N4
Tel: 905-858-2565 Cell: 647-295-2565
www.thearchisystem.com
email: archisystem@gmail.com

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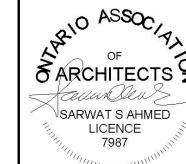
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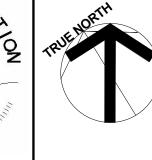
OWNER / CLIENT:

LA CABAN DEVELOPMENTS INC.

STRUCTURAL ENGINEERS:

BUILDING PERMIT 10-10-2024
No.: Issued For: Date





PROJECT:

TOWNHOUSE DEVELOPMENT

61 CLAPHAM RD, HAMILTON, ON L8G 2H9

DRAWING TITLE:

ARCHITECTURAL SET

SHEET TITLE: FIRST FLOOR FRAMING PLAN

JOB # 2023019

SCALE: 1/4" = 1'-0"

SHEET NO.:

S2 (

NOTE:

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STRUCTURAL DESIGN NOTES:

1. ASSUMING BEARING CAPACITY OF S

1. ASSUMING BEARING CAPACITY OF SOIL = 120kPa
2. FOUND ALL FOOTINGS ON NATIVE UNDISTURBED SOIL
3. STRUTURAL STEEL SHALL CONFORM TO CSA STANDARD CAN/CSA G40.20 G40.21 OR ASTM A992/A992M
4. BOLTS & BOLTS ASSEMBLY SHALL CONFORM TO ASTM A325 OR A490M

MIN. LAP LENGTH =24XBAR DIA

ALL REBARS SHALL CONFORM TO CAN/CSA G30.18-M92, MIN. YEILD STRENGTH 400 mPa BEAM DESCRIPTION

B1 2.1 RIGIDLAM SP LVL. 1-3/4 x 11-7/8

B2 1-1/8 x 11-7/8 APA RIM BOARD PLUS

B3 11-7/8 PJI-40 SEE LUMBER

NOTE: PLEASE SEE LUMBER. DWGS. FOR STRUCTURAL FLOOR FRAMING PLANS

JOIST SCHEDULE

J1 11-7/8" PJI SEE LUMBER DRAWINGS FOOTING DESCRIPTION

F1 3'-0"x5'-0"x16" THE FOOTING REINFORCED WITH 5-15M
BAR BOTTOM BOTH WAYS AND POURED WITH 25MPA
CONCRETE

CONTINUOUS BARS IN OTTOM BOTH WAYS TO BE

F2 24" WIDE X 8" TH. REINFORCED WITH 3-10M

POURED WITH 25MPA CONCRETE.

WD. POST SCHEDULE

P1 2-2 x 6 SPF
P2 3-2 x 6 SPF
P3 4-2 x 6 SPF
P4 4-2 x 4 SPF
P5 3-2 x 4 SPF
P6 4x4 SPF STAIRCASE POST
P7 4-2 x 8 SPF
C1 2" DIA STEEL POST

LINTEL SCHEDULE


OPENINGS
LINTEL SIZE

UPTO 42" OPENINGS
2- 2 x 6

UPTO 66" OPENINGS
2- 2 x 8

UPTO 78" OPENINGS
3- 2 x 10

UPTO 90" OPENINGS
3- 2 x 12

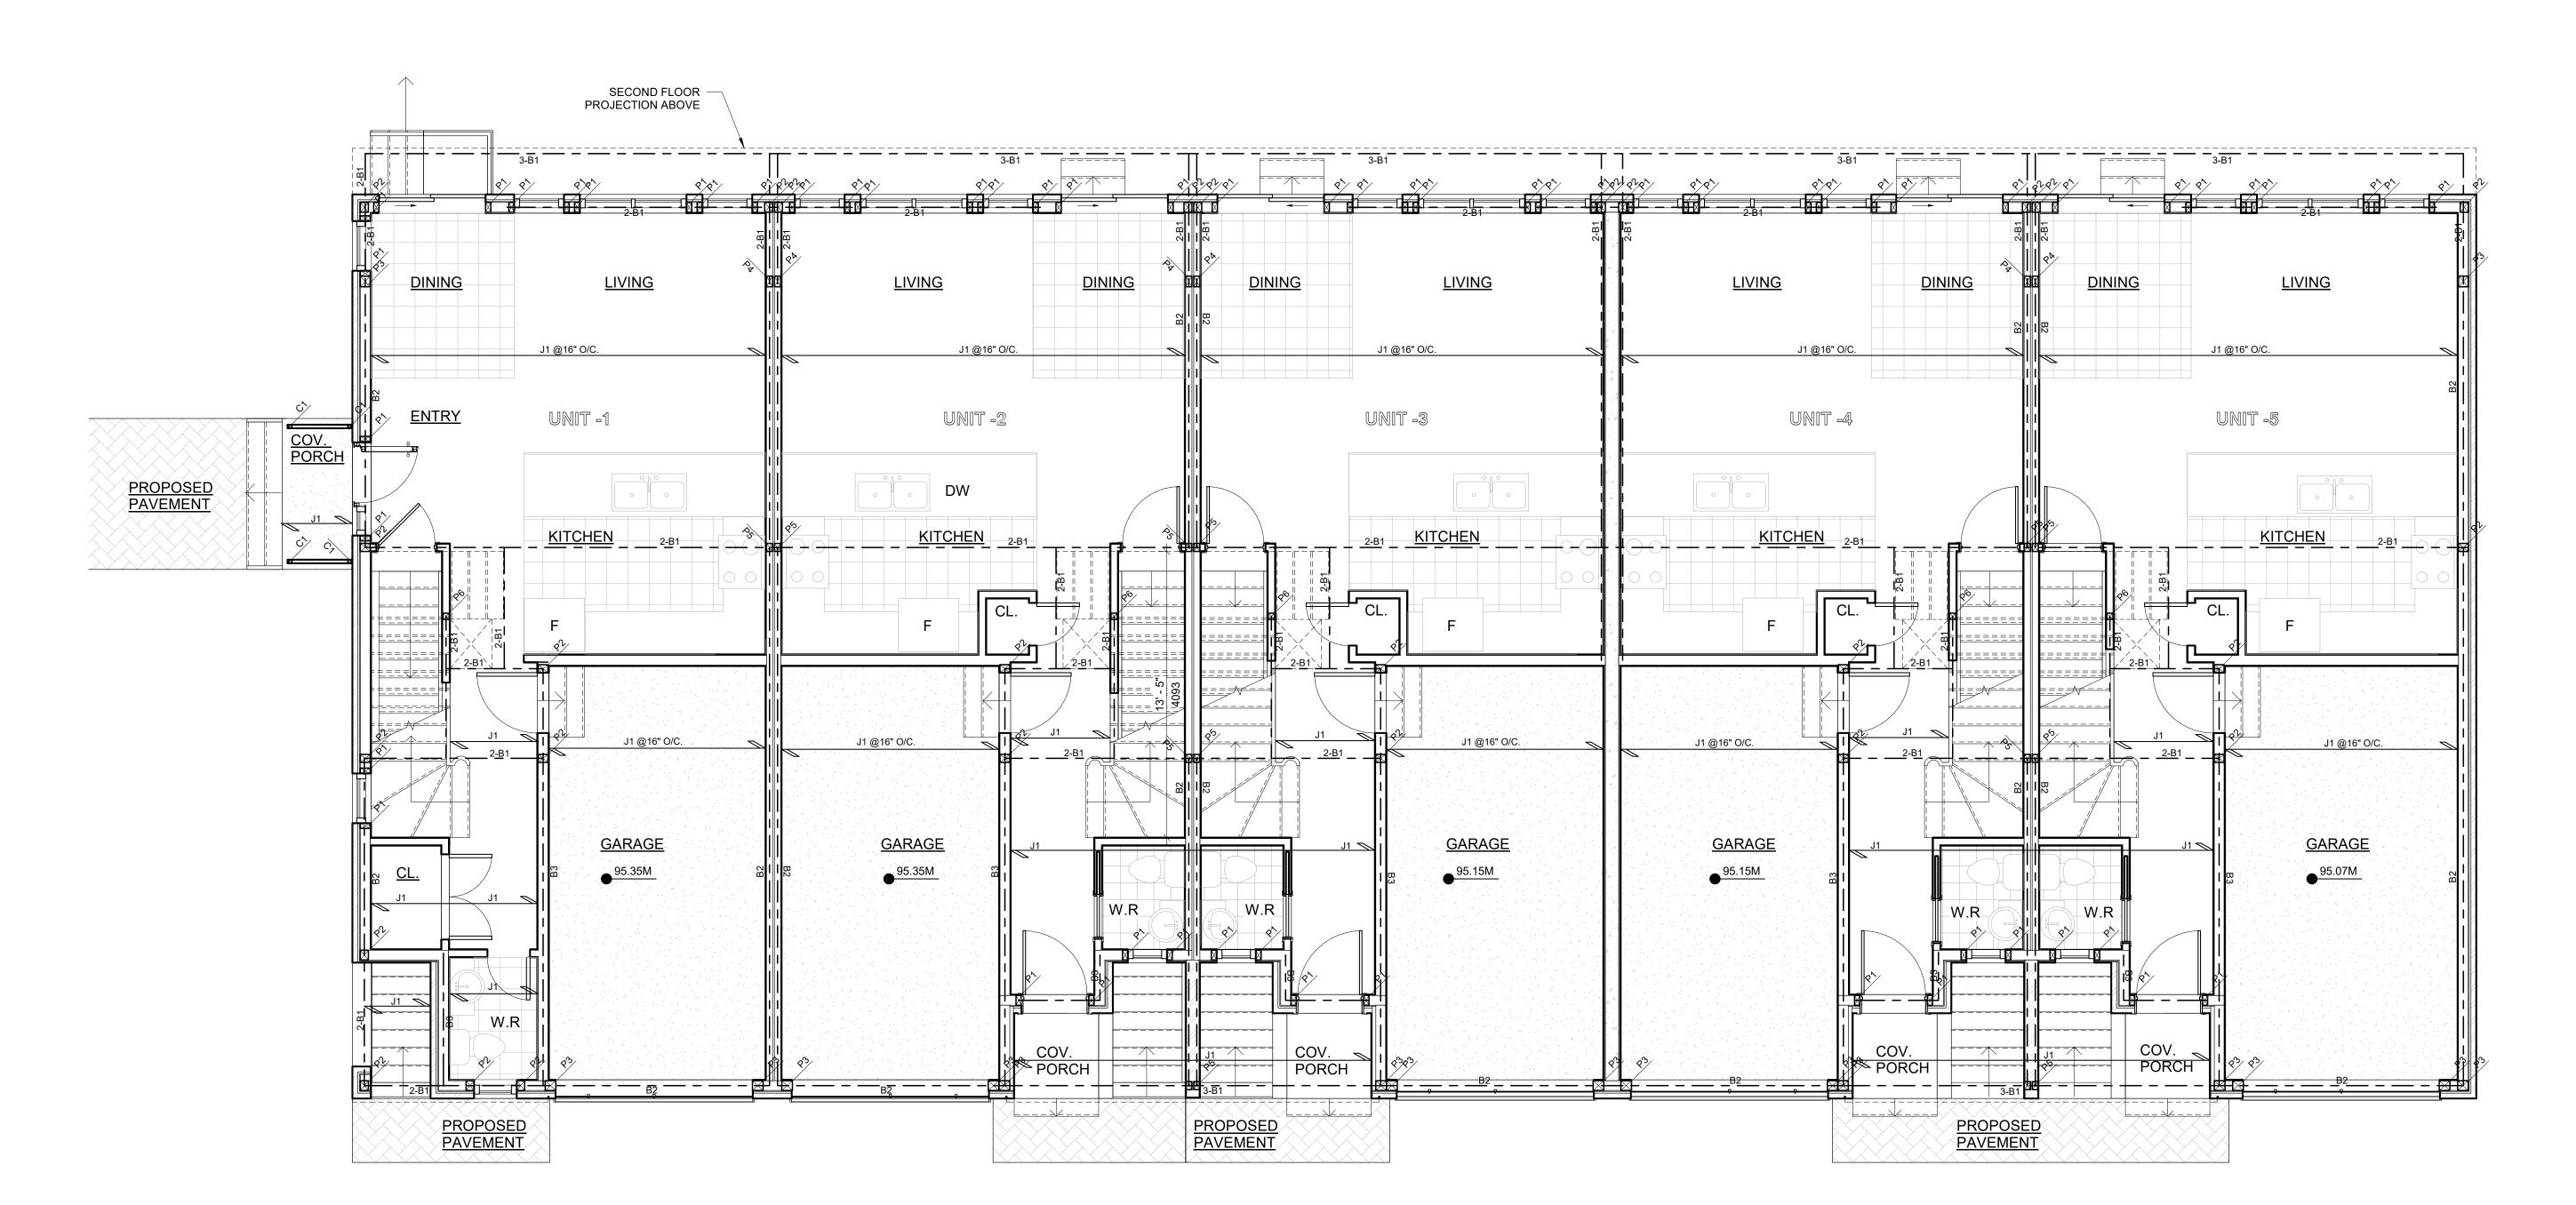

1 SECOND FLOOR FRAMING PLAN S2.1 1/4" = 1'-0" PROJECT ARCHITECTS:

ARCHISYSTEM INC.

CONSULTING ARCHITECTS
CERTIFICATE OF PRACTICE # 5465

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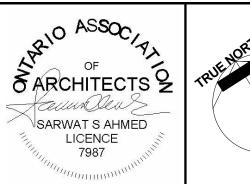
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OWNER / CLIENT:

LA CABAN DEVELOPMENTS INC.

STRUCTURAL ENGINEERS:

BUILDING PERMIT 10-10-2024
Issued For: Date



PROJECT:

TOWNHOUSE DEVELOPMENT

61 CLAPHAM RD, HAMILTON, ON L8G 2H9

DRAWING TITLE:

ARCHITECTURAL SET

SHEET TITLE:

SECOND FLOOR
FRAMING PLAN

JOB # 2023019

SCALE: 1/4" = 1'-0"

SHEET NO.:

S2.1

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STRUCTURAL DESIGN NOTES:

- ASSUMING BEARING CAPACITY OF SOIL = 120kPa
 FOUND ALL FOOTINGS ON NATIVE UNDISTURBED SOIL
 STRUTURAL STEEL SHALL CONFORM TO CSA STANDARD CAN/CSA G40.20 G40.21 OR ASTM A992/A992M
- A992/A992M
 BOLTS & BOLTS ASSEMBLY SHALL CONFORM TO
 ASTM A325 OR A490M
 ALL REBARS SHALL CONFORM TO CAN/CSA
 G30.18-M92, MIN. YEILD STRENGTH 400 mPa
 MIN. LAP LENGTH =24XBAR DIA

BEAM DESCRIPTION					
В1	2.1 RIGIDLAM SP LVL. 1-3/4 x 11-7/8				
B2	1-1/8 x 11-7/8 APA RIM BOARD PLUS				
В3	11-7/8 PJI-40 SEE LUMBER				
NOTE: PLEASE SEE LUMBER. DWGS. FOR					

STRUCTURAL FLOOR FRAMING PLANS


JOIST SCHEDULE FOOTING DESCRIPTION


J1 11-7/8" PJI SEE LUMBER DRAWINGS

WD. POST SCHEDULE

- F1 3'-0"x5'-0"x16" THE FOOTING REINFORCED WITH 5-15M BAR BOTTOM BOTH WAYS AND POURED WITH 25MPA CONCRETE
- F2 24" WIDE X 8" TH. REINFORCED WITH 3-10M CONTINUOUS BARS IN OTTOM BOTH WAYS TO BE POURED WITH 25MPA CONCRETE.

P1	2-2 x 6 SPF			
P2	3- 2 x 6 SPF	LINT	LINTEL SCHEDULE	
P3	4-2 x 6 SPF		OPENINGS	LINTEL SIZE
P4	4- 2 x 4 SPF	UPT	O 42" OPENINGS	2- 2 x 6
P5	3- 2 x 4 SPF	UPT	O 66" OPENINGS	2- 2 x 8
P6	4x4 SPF STAIRCASE POST	UPT	O 78" OPENINGS	3- 2 x 10
P7	4- 2 x 8 SPF	UPT	O 90" OPENINGS	3- 2 x 12
C1	2" DIA STEEL POST			

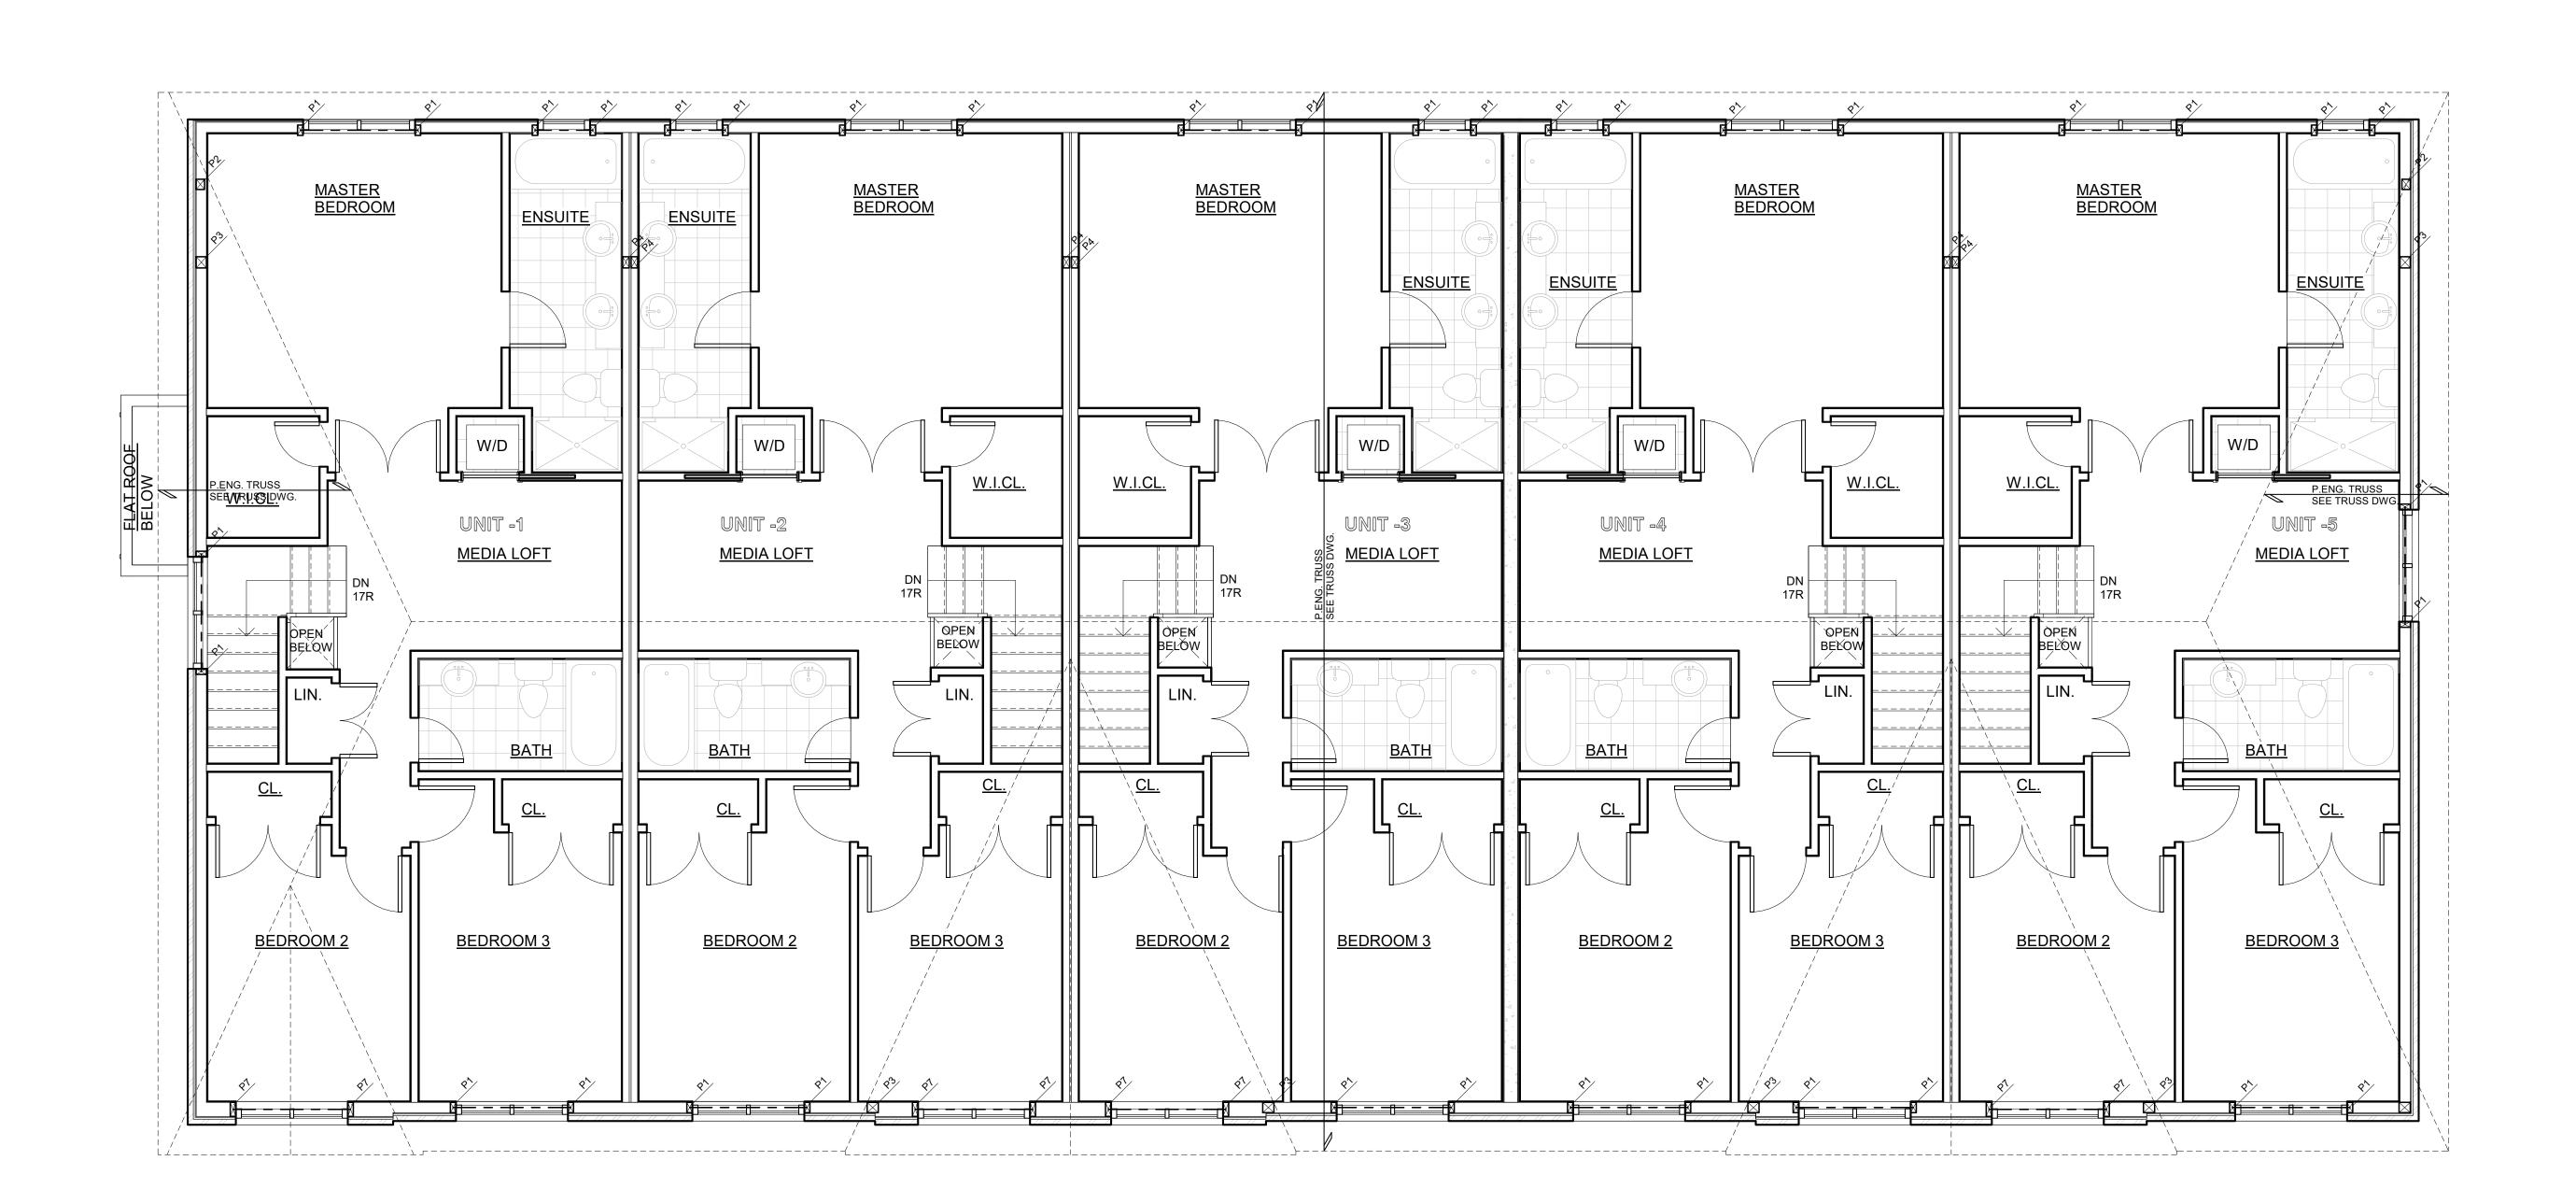

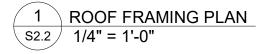

PROJECT ARCHITECTS:

ARCHISYSTEM INC.

CONSULTING ARCHITECTS
CERTIFICATE OF PRACTICE # 5465

279 Main Street North
Brampton, ON L6X 1N4
Tel: 905-858-2565 Cell: 647-295-2565
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NOTES:

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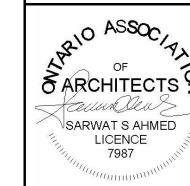
ALLWORKS TO BE DONE ACCORDING TO BEST COMMON PRACTICE AND CONFORM TO PREVAILING ONTARIO BUILDING CODE.

OWNER / CLIENT:

LA CABAN DEVELOPMENTS INC.

STRUCTURAL ENGINEERS:

BUILDING PERMIT 10-10-2024
No.: Issued For: Date





61 CLAPHAM RD, HAMILTON, ON L8G 2H9

DRAWING TITLE:

ARCHITECTURAL SET

SHEET TITLE:

OB# 2023019

SCALE: SHEET NO.:

S2.2

1/4" = 1'-0"

ROOF FRAMING PLAN

- 1.0 GENERAL
- 1.1 ALL DIMENSIONS AND SETTING OUT SHOWN IN STRUCTURAL DRAWINGS SHALL BE VERIFIED WTH ARCHITECTURAL DRAWINGS. IN CASE OF DISCREPANCY, NOTIFY THE ENGINEER PRIOR TO EXECUTION
- 2.0 MATERIALS
- 2.1 PROVIDE ONLY NEW STRUCTURAL MATERIALS IN ACCORDANCE WITH THE REFERENCE STANDARDS AND THE FOLLOWING. UNLESS OTHERWISE NOTED.
- 2.1.1 CONCRETE: CONFIRM TO THE REQUIREMENT OF CSA A23.1. AS PER OBC-2012, CLAUSE 9.3.1.6, MIN. 28 DAYS C COMPRESSIVE STRENGTH OF CONCRETE SHALL BE AS FOLLOWS,
- I = 25MPa for footings, basement walls and foundation walls
- II = 32MPa for garage floor and all other exterior floors
- III 20MPa for all interior floors
- IV 15MPa for all other applications - CONCRETE USED FOR GARAGE AND CARPET FLOORS AND EXTERIOR STEPS SHALL HAVE AIR ENTRAINMENT OF 5% TO 8
- 2.1.2 REINFORCEMENT: CONFORM TO CSA G30 SERIES. FY = 400 MPa FOR ALL REINFORCEMENT EXCEPT THAT FY = 386 MP FOR WELDED WIRE FABRIC. [PROVDE WELDED WIRE FABRIC IN FLAT SHEETS ONLY)
- ALL REINFORCEMENT IS TO BE BLACK EXCEPT WHERE THE SUFFIX C IS USED TO DESIGNATE EPOXY COATED REINFORCEMENT
- 2.1.3.1 ANGLES (L) TO CONFORM TO CAN/CSA-G40.20/640.21 GRADE 300W. 1.3.2 ALL 'W SECTION AND HSS SHALL CONFORM TO
 - CAN/CSA-G40.21 GRADE 350W. PROVIDE ONLY NEW STRUCTURAL MATERIALS IN ACCORDANCE WITH THE REFERENCE STANDARDS AND THE FOLLOWING. UNLESS OTHERWISE NOTED.
- 2.1.3.2 SHOP PAINT: TO CISC/CPMA 1-73A OR SSPC PAINT 15. 1.4.2 SHOP PRIMER: 10 CISC/CPMA STANDARD 2-75.
- 2.1.3.3 INORGANIC ZINC-RICH PRIMER: ZINC CLAD II AS SUPPLIED BY SHERWIN-WILLIAMS COMPANY (2 TO 4 MILS DRY FILM THICKNESS), OR APPROVED ALTERNATIVE.
- 2.1.3.4 EPOXY PAINT: MACROPOXY 646 FAST CURE EPOXY AS SUPPLIED BY SHERWIN-WILLIAMS MOTANY (4 TO 6 MILS DRY FILM THICKNESS) OR APPROVED ALTERNATIVE.
- 2.1.3.5 ANCHOR BOLTS: GRADE A307 CR 300W THREADED ROD CONFORMING TO CSA G40.21-M
- 2.1.3.6 SAWN LUMBER: SPRUCE PINE FIR (S-P-F), NO. ON DRAWINGS. CONFORM TO CSA-0141
- 2.1.3.7 TIMBER DECKING: SPRUCE PINE FIR (S-P-F). COMMERCIAL GRADE OR BETTER UNLESS NOTED ON DRAWINGS. CONFORM TO CSA-0141. ALL TIMBER USED IN OUTSIDE ENVIRONMENT SHALL BE PRESSURE TREATED. 1.11 STRUCTURAL COMPOSITE LUMBER: CONFORM TO CSA 046.
- 2.1.3.8 PLYWOOD: CONFORM TO CSA 0121 (DOUGLAS FIR PLYWOOD) OR TO CSA 0151 (CANADIAN SOFTWOOD PLYWOOD).
- 2.1.3.9 TIMBER I- JOISTS:. CONFORM TO CSA 086
- 3. FOUNDATIONS
- 3.1- SOIL BEARING CAPACITY FOR FOUNDATION DESIGN IS ASSUMED AS 100kPa. CONTRACTOR SHALL VERIFY THIS ASSUMED VALUE OF BEARING CAPACITY BY CARRYING OUT REQUIRED SOIL TESTS BEFORE POURING THE FOOTINGS. NOTIFY THE ENGINEER IF MIN. 100kPa IS NOT ACHIEVED AT FOUNDING ELEVATION OF FOOTINGS.
- 3.2- FOOTINGS SUBGRADE MUST BE INSPECTED BY EITHER A GOETECHNICAL ENGINEER OR A GEOTECHNICAL TECHNICIAN UNDER THE SUPERVISION OF GEOTECHNICAL ENGINEER TO ENSURE THE SUBGRADE CONDITIONS ARE COMPABTIBLE WITH THE FOUNDATION DESIGN REQUIREMENTS.
- 3.3- FOUNDATION EXPOSED TO WEATHERING AND IN UNHEATED AREA SHOULD HAVE AT LEAST 4'-0" OF EARTH COVER FOR PROTECTION AGAINST FROST ACTION.
- 3.4- THE SLAB ON GRADE FLOOR SLABS SHOULD BE PLACED ON A GRANULAR BASE 20CM THICK, CONSISTING OF 19MM CRUSHED GRANITE, OR EQUIVALENT.
- 3.5- PERIMETER AND FLOOR SUBDRAINS ENCASED IN FABRIC FILTER SHOULD BE INSTALLED AND CONNECTED TO A POSITIVE OUTLET AND THE FOUNDATION WALLS SHOULD BE DAMP PROOFED.
- 3.6- INSULATION IS REQUIRED FOR PROTECTION OF THE FOUNDATIONS FROM DAMAGE DUE TO FROST ACTION. REFER TO ARCHITECTURAL DRAWINGS FOR FOUNDATION INSULATION NOT SHOWN ON STRUCTURAL DRAWINGS.
- 3.7- DO NOT PLACE BACKFILL AGAINST WALLS RETAINING EARTH (OTHER THAN CANTILEVER RETAINING WALLS) UNTIL THE WALLS AND THE FLOOR CONSTRUCTION AT TOP AND BOTTOM OF THE WALLS HAVE BEEN CAST AND ATTAINED 100% OF THEIR DESIGN STRENGTH.
- 3.8 FOUNDATION INSULATION: EXTRUDED POLYSTYRENE WITH A MINIMUM COMPRESSIVE STRENGTH OF 0.24MPa UNLESS NOTED OTHERWISE 2 GRADE OR BETTER UNLESS NOTED
- 3.9 CARRY OUT BACKFILLING AGAINST FOUNDATION WALLS WHERE THERE IS GRADE ON BOTH SIDES IN SUCH A MANNER THAT THE LEVEL OF BACKFILLING ON ONE SIDE OF THE WALL IS NEVER MORE THAN 600 MM (2-0") DIFFERENT FROM THE LEVEL ON THE OTHER SIDE OF THE WALL. DO NOT COMPACT CLOSER THAN 1500 MM (6-0") FROM WALLS WITH HEAVY EQUIPMENT. USE LIGHT HAND CONTROLLED EQUIPMENT WITHIN 1800 MM (6-0") FROM WALLS.
- 4.0 CONCRETE
- 4.1 FOLLOW MANUFACTURER'S INSTRUCTIONS REGARDING INSTALLATION PROCEDURES AND MINIMUM EMBEDMENT OF ANCHORS. 4.2 ALL DOWELS SHALL HAVE MINIMUM EMBEDMENT EQUIVALENT TO THE STRAIGHT TENSION EMBEDMENT LENGTH OR 600 MM
- (2-0"), WHICHEVER IS GREATER, UNLESS NOTED OTHERWISE 4.3 REINFORCEMENT IDENTIFIED AS CONTINUOUS SHALL TERMINATE WITH STANDARD END HOOKS AND SHALL BE LAPPED WTH
- CLASS 'B TENSION LAP SPLICES. 4.2.1 CONCRETE COVER:
 - ALL CONCRETE CAST AGAINST EARTH IS TO HAVE 75 MM (3") COVER, UNO.
- 4.2.2 CURING CONCRETE
- 4.3.1 PROTECTION
- 4.3.2 CONFORM TO THE REQUIREMENTS OF CSA A23.1. PROTECT FRESHLY DEPOSITED CONCRETE FROM FREEZING. PREMATURE DRYING AND EXTREMES OF TEMPERATURE. MAINTAIN CONCRETE WTH MINIMAL MOISTURE LOSS AT A RELATIVELY CONSTANT TEMPERATURE FOR THE PERIOD OF TIME NECESSARY FOR THE HYDRATION OF THE CEMENT AND TO ACHIEVE THE SPECIFIED STRENGTH OF THE CONCRETE
- 4.3.3 PROVIDE SUFFICIENT INSULATION, AND HEAT AS NECESSARY TO PREVENT FREEZING OF FROST SUSCEPTIBLE SOIL WHICH LIES AGAINST STRUCTURAL ELEMENTS, IN PARTICULAR PROTECT SOIL BENEATH FOOTINGS AND BEHIND FOUNDATION WALLS UNTIL THE BUILDING IS COMPLETED.
- 4.3.4 CRACK REPAIR: PRIOR TO COMPLETION OF THE PROJECT AND IN ANY CASE NOT SOONER THAN 28 DAYS AFTER CONCRETE HAS BEEN PLACED. EXAMINE CONCRETE FLOOR SURFACES AND REPAIR ALL MAJOR CRACKS IN THEM. ROUT CRACKS OUT MTH MECHANICAL ROUTER TO 13 MM (%") SQUARE APPROXIMATE CROSS SECTION. THEN CLEAN AND FILL CRACKS IN SAME MANNER AS SAW CUTS IN SLAB ON GRADE.
- 4.3.5 THE CONTRACTOR SHALL ENSURE THAT REINFORCING STEEL IS ADEQUATELY BRACED AGAINST MOVEMENT DURING CONCRETE PLACING.
- 4.3.6 FABRICATE REINFORCEMENT IN ACCORDANCE WITH CAN/CSA A23.1 AND THE RSIC MANUAL OF STANDARD PRACTICE.
- 4.3.7 PERFORM FORMING OPERATIONS AND PLACE HARDWARE SO THAT FINISHED CONCRETE WILL BE WITHIN THE TOLERANCES SET OLUT IN CAN/CSA-A23.1.
- 4.3.8 AFTER A PERIOD OF AT LEAST 28 DAYS, FILL SAW-CUTS WITH MORTAR CONTAINING CEMENT, SAND AND LATEX BONDING AGENT ENSURE THAT JOINTS TO BE FILLED ARE CLEAN, DRY AND FREE OF FOREIGN MATTER.
- 5.0 WOOD WORKS
- 5.1 ALL FRAMING. BRIDGING, NAILING. PROTECTION, HARDWARE AND OTHER FRAMING DETAILS ARE TO BE IN ACCORDANCE WITH PART 9 OF THE 2012 ONTARIO BUILDING CODE.
- 5.2 ROOF SHEATHING TO BE 15.5mm th. (5/8"th.) EXTERIOR GRADE FIR PLYWOOD NAILED AT 150MM (6") C/C ALONG EDGES AND 300MM (12") C/C ON INTERMEDIATE FRAMING MEMBERS. PROVIDE 3MM (1/8") GAP BETWEEN SHEATHING PIECES U.N.O.
- 5.3 WND LOADS SHALL BE IN ACCORDANCE WITH THE 2012 ONTARIO BUILDING CODE. PROVIDE FRAMING ANCHORS TO RESIST UPLIFT AT EACH END OF EACH ROOF JOIST. ANCHORS TO HAVE A MINIMUM WORKING CAPACITY OF 0.5 kN (100 lbs) UNO.
- 5.4 UNLESS SPECIFICALLY NOTED OTHERWISE ON THE DRAWINGS, THE CONTRACTOR SHALL PROVIDE STANDARD SIMPSON STRONGTIE HARDWARE OR APPROVED EQUIVALENT FOR ALL JOIST HANGERS BEAM HANGERS BEAM SEATS, POST ANCHORS, ETC. 5.5 MEMBERS SHALL BE ALIGNED LEVEL AND PLUMB WITHIN A TOLERANCE OF 1 IN 500.

- 5.6 MAKE ADEQUATE PROVISIONS FOR ERECTION STRESSES AND FOR SUFFICIENT TEMPORARY BRACING TO KEEP THE STRUCTURAL FRAME PLUMB AND IN TRUE ALIGNMENT UNTIL THE COMPLETION OF THE ENTIRE FRAMING INCLUDING INSTALLATION OF THE FLOOR AND WALL SHEATHING.
- 5.7 FOR ALL BUILT UP BEAMS SUPPORTED ON TIMBER WALLS, SUPPORT BEAMS ON POSTS WITH AN EQUAL NUMBER OF LAMINATIONS UNLESS NOTED OTHERWISE.
- 5.8 ALL BUILT UP BEAMS. TO BE NAILED TOGETHER WITH TWO ROWS OF 59 mm (3 1/2") SPIRAL NAILS AT 200MM (8") C/C. STAGGERED ROWS TOP AND BOTTOM. DO NOT SPLICE MEMBERS BETWEEN SUPPORTS.
- 5.9 ALL BEAMS SUPPORTED ON TIMBER WALLS ARE TO BEAR ON BUILT UP POSTS OR BE CONNECTED TO OTHER BEAMS WITH METAL BEAM HANGERS. PRESSURE NAILING PLATES WILL NOT BE ACCEPTED.
- 5.10 BUILT UP POSTS OF 2 OR 3 PLY SHALL BE NAILED TOGETHER AT 150 mm (6) c/c STAGGERED UNLESS NOTED OTHERWISE.
- 5.11 PROVIDE 38x38 (2x2) DIAGONAL CROSS BRIDGING AT MAXIMUM 2100 mm (6'-11) c/c UNLESS NOTED OTHERWISE. FOR ALL SAWN JOIST LOCATIONS (UNLESS NOTED OTHERWISE ON DRAWINGS).
- 5.12 PROVIDE MINIMUM BEARING OF 50 mm (2) FOR ALL JOISTS.
- 5.13 PROVIDE MINIMUM BEARING OF 100 mm (4) FOR ALL BEAMS.
- 5.14 NO SAWN LUMBER SHALL BE NOTCHED OR DRILLED IN THE FIELD WITHOUT THE PERMISSION OF THE CONSULTANT.
- 5.15 WOOD IS NOT PERMITTED TO BEAR DIRECTLY ON MASONRY OR CONCRETE WITHOUT PROTECTION. PROVIDE EITHER PRESSURE TREATED WOOD OR A POLYETHYLENE SHEET BETWEEN THE WOOD AND MASONRY/CONCRETE
- 5.16 PROPOSED SCHEDULE OF WORK TO BE COORDINATED WITH ALL SUB TRADES, THE CONSULTANT AND OWNER.
- 5.17 PARALLAM BEAMS SHALL BE MANUFACTURED CONFORMING TO CAN/CSA-086.
- 5.18 UP TO THREE 44 mm (2) WIDE BEAMS MAY BE NAILED WITH 3 ROWS OF 89 mm (3 1/2") COMMON NAILS AT 300 mm (12") 0.C. EACH SIDE: FOUR OR MORE PLY BEAMS SHALL BE BOLTED WTH 2 ROWS OF 13 mm (1/2") DIAMETER BOLTS AT 300 mm (12") O.C. STAGGERED BETWEEN ROWS.
- 5.19 NO HOLE OR NOTCH IS PERMITTED WTHOUT PRIOR APPROVAL FROM THE STRUCTURAL ENGINEER AND THE SUPPLIER OF THE PARALLAM BEAMS
- 5.20 BEAMS SHALL BE INSTALLED CONFORMING TO THE MANUFACTURER'S INSTRUCTION FOR INSTALLATION
- 5.21 ALL BEAMS SHALL BE PROPERLY STORED ON SITE AND SHALL BE PROTECTED AGAINST EXTENDED EXPOSURE TO SUN AND WATER BY USING STOCKERS ADEQUATE TO KEEP PRODUCTS ABOVE GROUND AND OUT OF MUD AND WATER (APPROXIMATELY 3000 mm (10'-0) O.C.) AND BY COVERING THE PRODUCTS WITH POLY SHEETS
- **6.0 CONNECTION HARDWARE:**
- 6.1- ALL CONNECTORS SHALL BE CSA APPROVED.
- 6.2- INSTALL ALL CONNECTORS AS PER MANUFACTURER'S RECOMMENDATION.
- 6.3- ALL NAILS, SCREWS, BOLTS. AND WELDS FOR CONNECTORS TO BE USED SHALL BE AS PER MANUFACTURER'S RECOMMENDATION.
- 6.4- SILL PLATES FOR EXTERIOR WALLS AT CONCRETE OR MASONRY WALL SHALL USE 12MM (1/2") DIA ANCHOR BOLTS EMBEDDED MIN. 7" TO 48" CENTERS UNLESS NOTED OTHERWISE ON DRAWINGS.
- 7.0 WOOD FRAMING:
- 7.1- ALL INTERIOR LOAD BEARING WALL FRAMING SHALL BE 2X6 STUD O 12"C/C WTH SILL PLATE, DOUBLE TOP PLATE AND 2X6 BLOCKING AT MID HEIGHT UNLESS NOTED OTHERWISE ON DRAWINGS.
- 7.2- ALL INTERIOR NON-LOAD BEARING WALL FRAMING SHALL BE 2X4 STUDS @ 16"C/C.
- 7.3- ALL EXTERIOR WALLS TO BE CONSTRUCTED AS SHEAR WALLS. USE 2X6 @16"C/C STUD WALLS. SHEAR WALL PANELS TO BE MIN. 12MM (1/2") PLYWOOD SHEATHING ON OUTSIDE AND 12MM (1/2") GYPSUM BOARD ON INSIDE CONNECT WITH MIN. 3.25MM (1/8")X 63.5MM (2 1/2") LONG NAILS AT 100MM (4") C/C ALONG PANEL EDGES AND 150MM (6") C/C ALONG INTERMEDIATE FRAMIKNG MEMBERS. ALL SHEAR
- WALLS TO BE SHEATHED FROM TOP PLATE TO SILL PLATE. HORIZONTAL CONTINUOUS BLOCKING AT 1200MM (4'-0") C/C. 7.4- BOTTOM PLATE OF UPPER STORY SHEAR WALL TO BE CONNECTED TO THE FLOOR FRAMING. WHERE FLOOR FRAMING IS PROPERLY CONNECTED TO LOWER STORY SHEAR WALL. OVERSIZED SHEATHING PANELS MAY BE USED TO CONNECT UPPER STORY SHEAR WALLS TO LOWER STORY SHEAR WALLS THROUGH THE FLOOR RIM JOIST OR END JOIST. IN THIS CASE, SPACE MUST BE LEFT BETWEEN THE UPPER AND LOWER STORY SHEAR PANELS TO ACCOMMODATE MOVEMENT OF THE RIM JOIST
- AND NAILS STAGGERED TO PREVENT SPLITTING OF PLATES 7.5- ANY ALLOWABLE HOLES AND CUTS IN THE JOISTS ARE TO BE ONLY AS PER MANUFACTURER'S RECOMMENDATION.
- 7.6- WHEN 2 OR MORE LVL BEAM PLIES ARE FASTENED TOGETHER, CONTRACTOR TO STRICTLY FOLLOW MANUFACTURER'S RECOMMENDATION,
- 1- ALL TRUSS GIRDERS SHALL BE SUPPORTED ON 6x6 PSL POSTS TO FOUNDATION WALLS UNLESS NOTED OTHERWISE ON DRAWINGS
- 2- REQUIRED UPLIFT HARDWARE SHALL BE USED WHERE TRUSS DESIGNER SHOW UPLIFT FORCES. UPLIFT HARDWARE SHALL BE AS PER
- MANUFACTURER'S RECOMMENDATION. 3- ALL ROOF TRUSSES SHALL BE DESIGNED AND SUPPLIED BY TRUSS MANUFACTURER ALONG WITH PROFESSIONAL ENGINEER'S DESIGN LIABILITY.
- 4- ALL BRACING REQUIREMENT AND RECOMMENDATION FOR THE TRUSS SYSTEM ARE THE RESPONSIBILITY OF THE TRUSS DESIGN ENGINEER AND MANUFACTURER.
- 5- TRUSS MANUFACTURE/SUPPLIER/DESIGNER SHALL SUBMIT ENGINEERED SHOP DRAWINGS, ERECTION DRAWING AND DESIGN CALCULATIONS BEARING STAMP OF A PROFESSIONAL REGISTERED ENGINEER
- 6- THIS IS THE RESPONSIBILITY OF THE SUPPLIER TO SPECIFY ALL SUPPORTING HANGERS AND CONNECTION HARDWARE REQUIRED FOR THE
- INSTALLATION THE ROOF TRUSS. 9.1 DEFECTIVE MATERIALS AND WORK
- 9.1.1 WHERE EVIDENCE EXISTS THAT DEFECTIVE WORK HAS OCCURRED OR THAT WORK HAS BEEN CARRIED OUT INCORPORATING DEFECTIVE MATERIALS. THE CONSULTANT MAY HAVE TESTS. INSPECTIONS OR SURVEYS PERFORMED. ANALYTICAL CALCULATIONS OF STRUCTURAL STRENGTH MADE, AND THE LIKE IN ORDER TO HELP DETERMINE WHETHER THE WORK MUST BE CORRECTED OR REPLACED. TESTS. INSPECTIONS, SURVEYS, OR CALCULATIONS CARRIED OUT UNDER THESE CIRCUMSTANCES WILL BE MADE AT THE CONTRACTORS EXPENSE, REGARDLESS OF THEIR RESULTS, WHICH MAY BE SUCH THAT, IN THE CONSULTANTS OPINION, THE WORK MAY BE ACCEPTABLE
- 4.2.3 CURE ALL CONCRETE IN ACCORDANCE WITH CSA A23.1. THE CONCRETE SUPPLIERS REQUIREMENTS AND AS SPECIFIED HEREIN. 9.1.2 ALL TESTING SHALL BE CONDUCTED IN ACCORDANCE WITH THE REQUIREMENTS OF THE 2012 ONTARIO BUILDING CODE EXCEPT WHERE THIS WOULD, IN THE CONSULTANTS OPINION, CAUSE UNDUE DELAY OR GIVE RESULTS NOT REPRESENTATIVE OF THE REJECTED MATERIAL IN PLACE. IN THIS CASE. THE TESTS SHALL BE CONDUCTED IN ACCORDANCE WITH THE STANDARDS GIVEN BY THE CONSULTANT.
 - 9.1.3 MATERIALS OR WORK. WHICH FAIL TO MEET SPECIFIED, REQUIREMENTS, MAY BE REJECTED BY THE CONSULTANT WHENEVER FOUND AT ANY TIME PRIOR TO FINAL ACCEPTANCE OF THE WORK REGARDLESS OF PREVIOUS INSPECTION, SHALL BE PROMPTLY REMOVED AND REPLACED OR REPAIRED TO THE SATISFACTION OF THE CONSULTANT. AT NO EXPENSE TO THE OWNER.

DESIGN CODES AND LOADS:

- 1. STRUCTURAL DESIGN IS BASED ON NATIONAL BUILDING CODE OF CANADA, 2015 AND
- ONTARIO BUILDING CODE REGULATIONS, 2012.
- LOADS SHOWN ON STRUCTURAL DRAWINGS ARE UNFACTORED U.N.O.
- 3. DESIGN LOADS AS SHOWN ON STRUCTURAL DRAWINGS SHALL NOT BE EXCEEDED DURING CONSTRUCTION.
- 6. CLIMATIC LOADS (LOCATION: MISSISSAUGA, ONTARIO): 6.1.WIND PRESSURE ($\frac{1}{50}$): 0.35 kPa
- 6.2.SNOW LOAD ($\frac{1}{50}$): Ss = 1.1 kPa, Sr = 0.4 kPa
- 7. DESIGN LOADS (SERVICE):
- $7.1.LIVE\ LOAD = 40\ psf$
- 7.2.FLOOR DEAD LOAD = 22 psf
- 7.3.EXTERNAL WALL DEAD LOAD = 50 psf
- 7.4.PARTITION LOAD = 6 psf
- 7.5.ROOF DEAD LOAD =10 psf 7.6.SNOW LOAD = 21 psf
- 7.7.WIND LOAD = 7.5 psf

STRUCTURAL DESIGN NOTES:

JOIST SCHEDULE

SEE LUMBER DRAWINGS

J1 11-7/8" PJI

- ASSUMING BEARING CAPACITY OF SOIL = 120kPa FOUND ALL FOOTINGS ON NATIVE UNDISTURBED STRUTURAL STEEL SHALL CONFORM TO CSA
- STANDARD CAN/CSA G40.20 G40.21 OR ASTM BOLTS & BOLTS ASSEMBLY SHALL CONFORM TO
- ASTM A325 OR A490M ALL REBARS SHALL CONFORM TO CAN/CSA G30.18-M92, MIN. YEILD STRENGTH 400 mPa MIN. LAP LENGTH =24XBAR DIA
- B1 | 2.1 RIGIDLAM SP LVL. 1-3/4 x 11-7/8 B2 | 1-1/8 x 11-7/8 APA RIM BOARD PLUS B3 | 11-7/8 PJI-40 SEE LUMBER NOTE: PLEASE SEE LUMBER. DWGS. FOR

STRUCTURAL FLOOR FRAMING PLANS

BEAM DESCRIPTION

- FOOTING DESCRIPTION F1 3'-0"x5'-0"x16" THE FOOTING REINFORCED WITH 5-15M BAR BOTTOM BOTH WAYS AND POURED WITH 25MPA
- F2 24" WIDE X 8" TH. REINFORCED WITH 3-10M CONTINUOUS BARS IN OTTOM BOTH WAYS TO BE

WD. POST SCHEDULE			POURED WITH 25MPA CONCRETE.	
P1	2-2 x 6 SPF			
P2	3- 2 x 6 SPF	LINTEL SCHEDULE		
Р3	4-2 x 6 SPF	OPENINGS	LINTEL SIZE	
P4	4- 2 x 4 SPF	UPTO 42" OPENINGS	2- 2 x 6	
P5	3- 2 x 4 SPF	UPTO 66" OPENINGS	2- 2 x 8	
P6	4x4 SPF STAIRCASE POST	UPTO 78" OPENINGS	3- 2 x 10	
P7	4- 2 x 8 SPF	UPTO 90" OPENINGS	3- 2 x 12	

C1 | 2" DIA STEEL POST

IT IS THE CONTRACTOR'S RESPONSIBILITY TO ENSURE THAT ALL CONSTRUCTION CONFORMS TO THE REQUIREMENTS OF ONTARIO BUILDING CODE. NOTATIONS MADE ON THESE DRAWINGS ARE BASED ON ASSUMED SITE CONDITIONS AND DO NOT NECESSARILY ADDRESS ALL AREAS OF CONSTRUCTION. THIS IS CONTRACTOR'S RESPONSIBILITY TO VERIFY THE SITE CONDITION AND IN CASE OF ANY DISCREPANCY BETWEEN ACTUAL SITE CONDITIONS AND THE DRAWINGS, NOTIFY THE ENGINEER BEFORE PROCEEDING WITH THE WORK. ALL CONSTRUCTION TO BE DONE BY CONTRACTOR IS SUBJECTED TO FIELD REVIEW AND APPROVAL BY A QUALIFIED LICENSED PROFESSIONAL ENGINEER.

PROJECT ARCHITECTS:

ARCHISYSTEM INC.

CONSULTING ARCHITECTS CERTIFICATE OF PRACTICE # 5465

279 Main Street North Brampton, ON L6X 1N4 Tel: 905-858-2565 Cell: 647-295-2565

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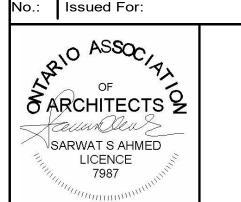
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OWNER / CLIENT

LA CABAN DEVELOPMENTS INC.

STRUCTURAL ENGINEERS:

BUILDING PERMIT 10-10-2024



PROJECT:

TOWNHOUSE

DEVELOPMENT

61 CLAPHAM RD, HAMILTON, ON L8G 2H9

DRAWING TITLE: ARCHITECTURAL SET

SHEET TITLE:

JOB# 2023019

SCALE: SHEET NO.:

As indicated

GENERAL NOTES

June 19, 2025

Submitted Digitally

Mr. Justin Leung Secretary-Treasurer Committee of Adjustment Planning and Economic Development Department City of Hamilton 71 Main Street West, 5th Floor Hamilton, ON L8P 4Y5

Dear Mr. Leung:

Re:

Minor Variance Application LaCaban Developments Inc.

61 Clapham Road City of Hamilton

Our File No.: 2015/15

On behalf of LaCaban Developments Inc., the purpose of this letter is to provide planning justification for the above noted Minor Variance Application ("Application") for the subject property located at 61 Clapham Road.

Purpose of Application

The purpose of the Application is to obtain minor variances necessary to facilitate the development of five (5) two-storey street townhouse dwellings and five (5) additional secondary dwelling units each within the principal dwelling. Individual driveway access for the units will be off of Catalina Drive.

Minor Variances Requested

Based on our review of the City zoning comments provided for the related Building Permit Application, the following minor variances are being requested:

- 1. To permit a minimum easterly side yard setback of 1.5 metres for Unit 5 whereas 2.0 metres is required (Section 10 F(4)(c)).
- 2. To permit an unenclosed porch within the side yard of Unit 1 whereas an unenclosed porch is only permitted within a required front yard or rear yard (Section 18(3)d)).

- 3. To permit a minimum driveway dimension of 2.8 metres x 5.5 metres for a secondary dwelling unit whereas 2.8 metres x 5.8 metres is required (Sections 18A(7) and Section 19).
- 4. To permit a minimum parking and loading space dimension of 3.0 metres x 5.5 metres for a secondary dwelling unit whereas 3.0 metres x 5.8 metres is required (Sections 18A(9) and Section 19).
- 5. To permit a minimum easterly side yard setback of 1.92 metres for the access driveway for secondary unit within Unit 5 whereas 3.0 metres is required (Sections 18A(25) and Section 19).

Planning Opinion

On November 9, 2016, City Council approved Zoning By-law No. 16-301 to facilitate the development of five (5) street townhouses on the subject property. The Holding Provision was subsequently removed on December 19, 2024 through By-law 24-239 following the execution of the required External Services Agreement and approval of a Functional Servicing Report. Through a further zoning review provided through the Building Permit Application, City staff identified zoning deficiencies that were not initially captured in Zoning By-law No. 16-301 as well as deficiencies related to the proposed secondary dwelling units.

The overall intent and purpose of the proposed development has not changed since the Council approval. At the rezoning stage, it was determined that proposed townhouse development conformed to the Urban Hamilton Official Plan (UHOP). Additionally, the *Planning Act* requires that every municipality provide for secondary dwelling units in their respective Official Plans and Zoning By-laws. The UHOP and implementing Zoning By-law No. 6593 (Section 19) contains policies and regulations for secondary dwelling units.

The proposed minor variances in my opinion maintain the general intent and purpose of the UHOP and Zoning By-law and satisfy the four (4) tests as set out in the Planning Act.

A review and analysis of the minor variances sought is outlined below.

Variances #1 and #5 apply to Unit #5 which is the most easterly townhouse unit. The proposed side yard setback reductions for the principal townhouse and secondary dwelling units and the access driveway are in my opinion, appropriate in this instance. The side yard in question is adjacent to an existing parking lot that presently serves the existing apartment building. In this scenario, there are no concerns with respect to land use compatibility or conflict with existing homeowners. It is anticipated that wood privacy fencing will be installed between the proposed townhouse and the existing parking lot to provide privacy for the future townhouse owner.

It is my opinion that these variances maintain the general intent and purpose of the Official Plan and Zoning By-law, are minor in nature and desirable for the appropriate

development and use of the land. Given the existing context, there will be no adverse impacts arising from the proposed variances seeking a reduced side yard setback.

Variance #2 applies to the proposed secondary unit within Unit #1 which is the most westerly townhouse unit situated at the corner of Clapham Road and Catalina Drive. Based on the corner lot condition, the owner is seeking relief for an unenclosed porch within a side yard whereas the Zoning By-law permits unenclosed porches only within the front and rear yards. The purpose of the unenclosed porch is to facilitate side yard access to the dwelling unit and will result in an improved design. It will also contribute to the aesthetics of the streetscape. The existing house presently fronts onto Clapham Road.

It is my opinion that the variance maintains the general intent and purpose of the Official Plan and Zoning By-law, is minor in nature and is desirable for the appropriate development and use of the land. There will be no adverse impact arising from the proposed variance to facilitate an unenclosed porch.

Variances #3 and #4 address the minimum driveway and loading space dimensions only for the proposed secondary dwelling units. In this case, the owner is seeking relief of 0.3 metres (1 foot) for the driveway and loading space length for the secondary dwelling units. The width of the driveway at 3.0 metres will meet and exceed the Zoning By-law standards. It should be noted that Zoning By-law 16-301 approved by Council provided relief for the garage and driveway dimensions for the townhouses. By-law 16-301 provides for a minimum dimension of a parking space of not less than 3.0 metres by 5.8 metres within a garage and 2.8 metres by 5.5 metres within a driveway. The same provisions, however, do not apply to secondary dwelling units, hence the need for these variances. It is my opinion that the variances are technical in nature and appropriate to accommodate secondary dwelling units. The relief will avoid the need to recess the garage within the townhouse unit to accommodate secondary dwelling units. The 5.5 metre length is more than sufficient to accommodate most vehicles. The variances continue to respect Council's approval of the Zoning By-law in 2016 which was premised on a driveway length of 5.5 metres.

It is my opinion that these variances maintain the general intent and purpose of the Official Plan and Zoning By-law, are minor in nature and desirable for the appropriate development and use of the land. The variances are technical in nature and will have no adverse impact on the surrounding neighbourhood.

Conclusions

In conclusion, it is my opinion that the minor variances requested satisfy the four (4) tests as set out in Section 45(1) of the *Planning Act*. The proposed variances will facilitate a townhouse development together with secondary dwelling units that will provide for an appropriate and compatible built form. The variances related to the secondary dwelling units help advance Provincial policy that supports more affordable housing units. The variances requested maintain the general intent and purpose of the UHOP as well as the implementing Zoning By-law, are minor in nature, and appropriate and desirable for the

use and development of the subject lands. There will be no adverse impact on the surrounding neighbourhood arising from the minor variances requested.

Yours truly,

WELLINGS PLANNING CONSULTANTS INC.

Glenn J. Wellings, MCIP, RPP

Copy: Tayo Omosehin, LaCaban Developments Inc.

Ross Defina, Project Architect

Authority: By-law No. 22-217

CM: August 12, 2022 Ward: 5

Bill No. 239

CITY OF HAMILTON BY-LAW NO. 24-239-PED

To Amend Former City of Hamilton Zoning By-law No. 6593 Respecting Lands Located at 61 Clapham Road, Hamilton

WHEREAS the Council of the City of Hamilton, in adopting Item 8 of Report 22-013 of the Planning Committee at its meeting held on the 12th day of August 2022, recommended that the Director of Planning and Chief Planner be authorized to pass a by-law to remove a Holding Symbol that forms part of any zone where the conditions have been met;

WHEREAS the City of Hamilton is the successor to certain area municipalities, including the former municipality known as the "The Corporation of the City of Hamilton" and is the successor to the former regional municipality, namely, "The Regional Municipality of Hamilton-Wentworth";

WHEREAS the *City of Hamilton Act*, 1999 provides that the Zoning By-laws of the former area municipalities continue in force in the City of Hamilton until subsequently amended or repealed by the Council of the City of Hamilton;

WHEREAS the Council of The Corporation of the City of Hamilton passed Zoning Bylaw No. 6593 (Hamilton) on the 25th day of July 1950, which by-law was approved by the Ontario Municipal Board by Order dated the 7th day of December 1951 (File No. P.F.C. 3821);

WHEREAS the conditions of Holding Provision for the lands located at 61 Clapham Road, Hamilton have been satisfied;

WHEREAS the Notice of Intention to Pass the Holding Removal By-law was issued on December 18th, 2024;

AND WHEREAS this By-law is in conformity with the Urban Hamilton Official Plan;

NOW THEREFORE the Director of Planning and Chief Planner of the City of Hamilton enacts as follows:

- 1. That Sheet No. 1193 of the District Maps, appended to and forming part of Zoning By-law No. 6593 (Hamilton) is amended by changing the zoning from the "RT-30/S-1738-'H'" (Street Townhouse) District, Modified, Holding to the "RT-30/S-1738" (Street Townhouse) District, Modified, on the lands the extent and boundaries of which are shown on Schedule "A" annexed hereto and forming part of this by-law.
- 2. That no building or structure shall be erected, altered, extended, or enlarged, nor shall any building or structure or part hereof be used, nor shall any land be used, except in accordance with the "RT-30/S-1738" (Street Townhouse) District, Modified, provisions.


3. That the Clerk is hereby authorized and directed to proceed with the giving of notice of the passing of this By-law, in accordance with the *Planning Act*.

PASSED this 19th day of December, 2024.

Anita Fabac

Acting Director of Planning and Chief Planner

ZAH-23-021

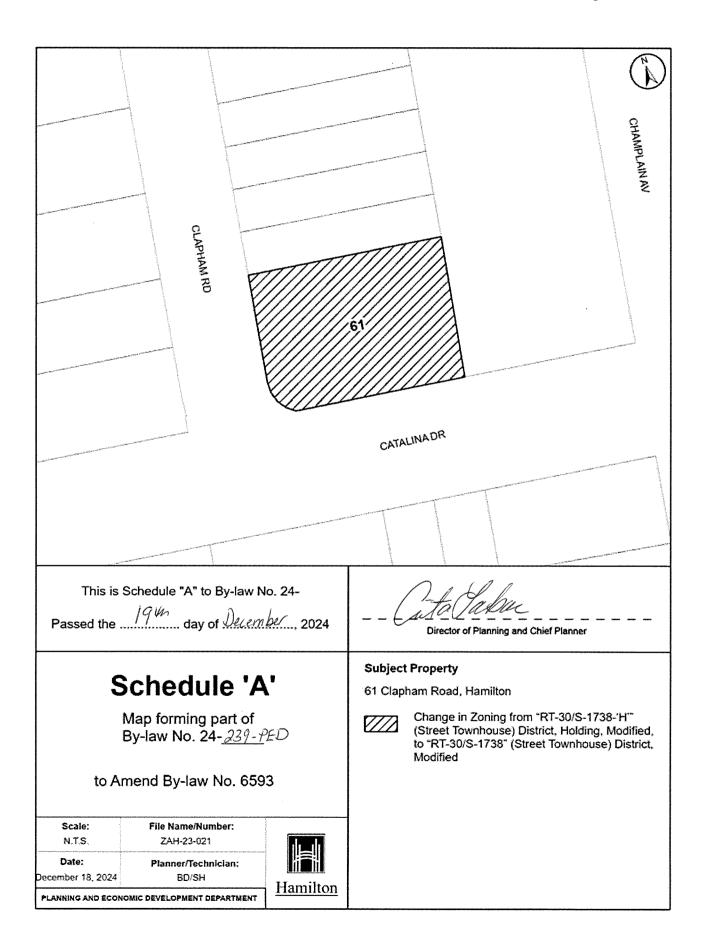



Planning Division 71 Main Street West, 5th Floor Hamilton, Ontario, L8P 4Y5 Phone: 905-546-2424 x2719 Fax: 905-546-4202

www.hamilton.ca

June 5, 2025

FILE: ZCR-24-115- 02 Kayla Medeiros ATTENTION OF: (905) 546-2424 TELEPHONE NO: **EXTENSION:** 5867

SARWAT A SYED

Re: APPLICABLE LAW REVIEW - ZONING BYLAW COMPLIANCE REVIEW PRESENT ZONE: RT-30-H/S-1738 (STREET TOWNHOUSE-HOLDING)

ADDRESS: 61 CLAPHAM ROAD, HAMILTON

An Applicable Law Review respecting zoning bylaw compliance has been completed and the following comments are provided.

COMMENTS:

- 1. This application is to facilitate the construction of a two-storey Street Townhouse Dwelling consisting of five (5) dwelling units, each having individual driveway access off Cataline Drive. The application is also proposing five (5) additional secondary dwelling units, located within each principle dwelling unit and having access through the basement.
- 2. This application has been made in support of a building permit application. This review is based on a Revision submitted May 29, 2025.
- 3. The subject property is zoned RT-30-H/S-1738 (Street Townhouse- Holding) within Hamilton Zoning By-law 6593, which permits street townhouse dwellings. The proposed use of a secondary dwelling unit within a street townhouse dwelling unit is permitted.
- 4. A Street Townhouse Dwelling shall mean the following:
 - (a) in which all single family dwelling units front on a public street, and
 - (b) which do not share any yards, driveways, common open space and parking and manoeuvring space.

The applicant shall confirm that the proposed development is consistent with the definition of Street Townhouse Dwelling, as provided in Hamilton Zoning By-law 6593.

- 5. This property is deemed as a corner lot. Front lot line is defined as the following:
 - "... with reference to a corner lot shall mean either of the boundary lines along a street at the option of the owner, provided that where one of such boundary lines along a street is chosen as the front lot line, the other shall be considered as a side lot line; and with reference to a through lot shall mean and include each of the two shorter boundary lines along streets."

- Based on the site plan submitted it appears that Catalina Drive is considered the front lot line and Clapham Road is considered the side lot line.
- 6. The lands are subject to a holding provision. The holding contains specific conditions required to be satisfied before development can occur on the subject lands. Therefore, the proposed development is not permitted until such time that the "H" holding is successfully removed through an amendment to the By-Law.
- Please note that this review is based on the assumption that the individual lots identified on the site plan have been established through a successful Part Lot Control Application. Additional review will be required should individual lots not be created.
- 8. Construction of the proposed development is subject to the issuance of a building permit in the normal manner.
- 9. Demolition of any existing buildings or structures are subject to the issuance of a demolition permit in the normal manner.
- 10. All new signs proposed for this development must comply with the regulations contained within Hamilton Sign By-law 10-197. A building permit(s) is required for all signage.
- 11. The designer shall ensure that the fire access route conforms to the Ontario Building Code.
- 12. The proposed development has been reviewed and compared to the standards of the "RT-30" zoning district under Hamilton Zoning By-law 6593, as indicated in the following chart:

By-Law Section	Required By By-Law	Provided	Conforming/ Non- Conforming
	SECTION 10F: RT-30-H/S-1738 (\$ (and amending by	•	
Permitted Uses [Section 10F (2)a) of Hamilton Zoning By-law 6593]	A Street Townhouse Dwelling or Street Townhouse Dwellings.	Street Townhouse Dwelling, with five (5) additional dwelling units within each principal unit.	Conforms
Height Requirements [Section 10F(3) of Hamilton Zoning By-law 6593]	No building shall exceed three (3) storeys, and no structure other than a building shall exceed 11.0m in height.	Two (2) Storey, 10.9 metres	Conforms
Minimum Front Yard [Section 10F(4)(a) of Hamilton Zoning By- law 6593 & as amended by By-law 16-301]	A front yard depth of not less than 3.0m. A front yard of a depth of not less than 5.5 metres	5.50 metres	Conforms
Minimum Rear Yard [Section 10F(4)(b) of Hamilton Zoning By- law 6593 & as amended by By-law 16-301]	A rear yard of a depth not less than 7.5m. A minimum rear yard of a depth of not less than 6.5 metres for the first storey and 5.8 metres for the second storey	6.5 metres	Conforms

Minimum Side Yard [Section 10F(4)(c) of Hamilton Zoning By- law 6593]	Except as provided in clause (d), a side yard abutting a wall that is not a party wall, along each side lot line of a width of not less than; i) 1.2m for a street townhouse dwelling, not exceeding one storey in height ii) 2.0m for a street townhouse dwelling, not exceeding two (2) storeys in height iii) 2.5m for a street townhouse dwelling, not exceeding three (3) storeys in height	ii)Westerly side lot line: 2.31m Easterly side lot line: 1.50m *Non-Conforming for easterly lot line PARKING FOR MAIN FLOOR UNIT. GARAGE = 95.07M T. SECOND UNIT 5A 3.00 PROPOSED DRIVEWAY PARKING FOR 555	NON- CONFORMING
Minimum Side Yard [Section 10F(4)(d)(i) of Hamilton Zoning By- law 6593 & as amended by By-law 16-301]	A side yard abutting a wall that is not a party wall, along each side lot line of a width of not less than; i) 3.0m, for each dwelling unit for which a garage or carport is not provided as either attached to or as an integral part of the street townhouse dwelling.		
	i) side yard abutting a wall that is not a party wall along each side lot line of a width of not less than 1.2 metres on the easterly side lot line and 1.4 metres on the westerly side lot line	Westerly side lot line: 2.31m Easterly side lot line: 1.50m	Conforms
Distance Between Buildings [Section 10F(5) of Hamilton Zoning By-	There shall be provided and maintained where there is more than one building on a lot, a distance between buildings	Only one building is proposed	Not Applicable
law 6593]	a) not exceeding one storey in height, of not less than 2.5m		
	b) not exceeding two storeys in height, of not less than 3.5m		
	c) not exceeding three storeys in height, of not less 5.0m		

Intensity of Use [Section 10F(6) of Hamilton Zoning By- law 6593 & as amended by By-law 16-301]	i) a lot area not less than 180- square metres for each single family dwelling ii) a width of not less than 6.0m- for each dwelling unit. A lot area not less than 149 square metres for each single family dwelling unit and not less than 200 square metres for the end units	Unit 1: 201.9 square metres Unit 2: 149.6 square metres Unit 3: 149.6 square metres Unit 4: 149.6 square metres Unit 5: 200.0 square metres Note: Unit 1 and Unit 5 are considered end units	Conforms
Dwelling Unit Placement [Section 10F(9) of Hamilton Zoning By-law 6593]	Not more than eight single family dwelling units shall be attached in a continuous row.	Maximum five (5) units are attached in a row.	Conforms
Visual Barrier [as amended by By- law 16-301]	A visual barrier shall be provided along the easterly and northerly property boundaries which shall be between 1.5 metres to 2.2 metres in height.	A visual barrier (fence) at a heigh of 2 metres has been provided along the northerly property boundary. Note: Applicant shall ensure the fence is provided along the entire easterly property boundary.	Conforms
	Section 18 – Supplementary Requ	irements and Modifications	
Yard Encroachments	b) A canopy, cornice, eaves or gutter may project,	i) provided	Conforms
[Section 18(3) of Hamilton Zoning By-law 6593]	i) into a required front yard not more than 1.5m provided that no such projection shall be closer to the street line than 1.5m	ii) provided iii) 1.10m along easterly side yard	
	ii) into a required rear yard not more than 1.5m, and		
	iii) into a required side yard not more than one-half the width, or 1.0m, whichever is lesser.		
	c) An open fire escape or stairway may project into a required <u>rear</u> yard not more than 1.0m.	<u>Unit 1</u> : 6.5m	Conforms
		<u>Units 2 - Unit 5</u> : 5.99m	
	indirection of the time that every	Note: Applicant shall dimension setback from proposed stairway to rear yard	
	d) A roofed-over or screened but otherwise unenclosed porch at the first storey level, including eaves and gutters, may project into a required front yard or rear yard to a distance of not more than 3.0m, and every such projecting porch shall be distance	Unit 1: Rear yard: 6.5m Side yard: 1.46m Setback of stairs located along Clapham Road has not been shown.	NON- CONFORMING

Accessory	at least 1.5m from the front lot line. Accessory buildings shall not be	Note: Unit 1 covered porch cannot encroach into the required side yard Units 2 – Unit 5: Setback for covered porch has not been dimensioned on site plan. dimensioned on plan (no issue) Accessory buildings are	Conforms
Buildings [as amended by By-law 16-301]	permitted for any street townhouse units.	not proposed as per the submitted site plan.	
	Section 19 – Residential Con	version Requirements	
Secondary Dwelling Unit and Secondary Dwelling Unit — Detached in all Residential Districts [Section 19 (1) of Hamilton Zoning By- law 6593]	(ii) Parking shall be provided in accordance with Section 18(A) of this By-law and the following: (a) No additional parking space shall be required for either a Secondary Dwelling Unit or a Secondary Dwelling Unit - Detached, provided the required parking spaces which existed on May 12, 2021 for the existing dwelling shall continue to be provided and maintained; 1. Notwithstanding Section 19.(1) (ii) (a), one parking space shall be required for a Secondary Dwelling Unit - Detached if it	New construction, therefore parking will be required.	Applicant to Note
	constitutes the fourth Dwelling Unit on a lot		
	(b) Notwithstanding Section 18A.(14a) and 18A.(14h) (i), a maximum of two parking spaces for a Secondary Dwelling Unit and/or Secondary Dwelling Unit - Detached may be provided in the required Front Yard; and,	One (1) parking space is provided in garage and second parking spaces is provided on driveway.	Conforms
	(c) In addition to Section 18A.(31), the surface of a parking space and access driveway may include permeable pavers.	Applicant to note	Applicant to Note
Secondary Dwelling Unit [Section 19 (1) (1) of Hamilton Zoning By- law 6593]	(i) A maximum of one Secondary Dwelling Unit shall be permitted within a Single Detached Dwelling, a Semi-Detached Dwelling, or a Street Townhouse Dwelling on a divided or undivided lot and shall not result in a change to the defined dwelling type on the lot	A maximum of one secondary dwelling unit is proposed in each unit within the street townhouse dwelling	Conforms
	(ii) All the regulations of this By- law applicable to the existing dwelling shall continue to apply unless specifically provided in Section 19.(1).1.	Applicant to note	Applicant to Note

	(iii) A Secondary Dwelling Unit shall contain a maximum of two bedrooms.	A maximum of one bedroom is proposed in each secondary dwelling unit	Conforms
	(iv) There shall be no outside stairway above the first floor other than a required exterior exit.	Not proposed	Conforms
	(v) A maximum of one entrance shall be permitted on the front façade of a dwelling containing a Secondary Dwelling Unit.	A maximum of one entrance is proposed in each street townhouse dwelling	Conforms
	(a) Notwithstanding Section 19.(1).1 (v), one additional entrance may be located on the front façade of a dwelling for lots identified in Schedule "P" of Section 22.		
Minimum Number of Required Parking Spaces [Section 18A(1)(a) of Hamilton Zoning By-	TABLE 1: Street Townhouse Dwelling requires one (1) parking space per dwelling unit.	Parking space appears to be proposed in garage of each townhouse dwelling. Applicant shall label on site	Appears to Conform
Minimum Number of Required Parking Spaces [Section 18A(1)(a) of Hamilton Zoning By- law 6593]	TABLE 1: Secondary Dwelling Unit requires one (1) parking space per dwelling unit.	plan. Parking spaces appears to be provided on the driveway of each townhouse dwelling, however, does not meet minimum parking size. Applicant shall label on site plan.	See below
Manoeuvring Space [Section 18A(1)(f) of Hamilton Zoning By- law 6593 & as amended by By-law 16-301]	Table 6, the minimum required manoeuvring space shall not apply	Not applicable as per amending bylaw 16-301	Conforms/Not Applicable
Minimum Parking Space Size [Section 18A(7) of Hamilton Zoning By- law 6593 & as amended by By-law 16-301]	The minimum dimensions of a parking space shall not be less than 3.0 metres by 5.8 metres within a garage and 2.8 metres by 5.5 metres within a driveway.	Driveway: 3.0 m x 5.50m Garage: 3.10m x 5.92m This Section conforms, r it's still noted as unconformation	• 1
[Section 18A(7b) of Hamilton Zoning By-law 6593]	Where a dwelling is constructed with an attached garage, then the finished level of the garage floor shall be a minimum of 0.3 metres above grade	0.30 metres	Conforms
[Section 18A(9) of Hamilton Zoning By- law 6593]	Required parking space, loading space and manoeuvring space shall be provided and maintained only on the lot on which the principle use, building or structure is located.	Parking space located on driveway does not meet the minimum size of 3.0 metres by 5.8 metres	NON- CONFORMING

			,
[Section 18A(10) of Hamilton Zoning By- law 6593]	Sufficient space additional to required parking space shall be provided and maintained on the same lot on which the parking space is located, in such a manner as to enable each and every parking space to be unobstructed and freely and readily accessible from within the lot, without moving any vehicle on the lot or encroaching on any designated parking or loading space.	Parking spaces are located in driveway as unobstructed and freely accessible from within the lot.	Conforms
Required Parking Space	Except for single family dwellings, two family dwellings and three	As per site statistic chart:	Conforms
[Section 18A (14a) of Former Hamilton Zoning By-law 6593]	family dwellings erected prior to the 14th day of December 1971, no part of a required parking space for a single family dwelling, two family dwelling or three family dwelling in a residential district shall be located in a required front yard and not less than 50% of the gross area of the front yard shall be used for a landscaped area excluding concrete, asphalt, gravel, pavers, or other similar materials.	Unit 1: 58.16% Unit 2: 50.03% Unit 3: 50.03% Unit 4: 50.03% Unit 5: 61.67%	
[Section 18A(21) of Hamilton Zoning By- law 6593]	All required parking spaces and manoeuvring spaces shall have access by means of one or more access driveways,	Parking space is accessed by driveway located on the lot.	Conforms
	a) located on the lot; or		
	b) located partly on the lot in the case of a mutual driveway; or		
	c) by means of a right of way.		
[Section 18A(22) of Hamilton Zoning Bylaw 6593] Note: By-law 16-301 states that notwithstanding Section 18A(1)(f) and Table 6, the minimum required manoeuvring space shall not apply		Maneuvering appears to be free and clear of obstruction.	Conforms
[Section 18A(24) of Hamilton Zoning By- law 6593]	Every parking area for a use where;	Each unit has one driveway and 2.8 metres provided	Conforms
-	a) There are five or less parking spaces shall have not less than one access driveway or mutual driveway, having a width of at least 2.8m.		
[Section 18A(25) of Hamilton Zoning By-	Where a townhouse dwelling, maisonette dwelling or multiple	Northerly property zoned DE- 2/S-48A and easterly	NON- CONFORMING

law 6593]	dwelling is adjacent to a residential district that does not permit such uses, every access driveway to the townhouse dwelling, maisonette dwelling or multiple dwelling shall be located not less than 3.0 metres from the common boundary between the district in which the townhouse dwelling, maisonette dwelling or multiple dwelling is located and the district that does not permit such uses.	property is zoned DE-3. Both zones do not permit street townhouses. Unit 5: 1.92m to the easterly property line.	
[Section 18A(29) of Hamilton Zoning By- law 6593]	Where a parking space for a townhouse dwelling is covered and attached to or enclosed within a dwelling unit, the entrance to the parking space shall be located not less than 6.0m from the entrance to the individual driveway.	1.70 metres has been provided for all Units	Conforms
[Section 18A(30) of Hamilton Zoning By- law 6593]	A permanent durable and dustless surface that is graded, drained, and paved with concrete or asphalt or a combination of concrete and asphalt shall be provided and maintained for every parking area, manoeuvring space, loading space and access driveway.	Concrete driveway proposed	Conforms
[Section 18A(31) of Hamilton Zoning By- law 6593]	A gravel or similar surface or other suitable paving shall be provided and maintained for every parking space and access driveway accessory to a single family dwelling, a two family dwelling, and to street townhouse dwellings each having separate access driveways.	Concrete driveway proposed	Conforms

Yours truly

Layla Medeiros



Committee of Adjustment

City Hall, 5th Floor, 71 Main St. W., Hamilton, ON L8P4Y5

Phone: (905) 546-2424 ext. 4221

Email: cofa@hamilton.ca

APPLICATION FOR A MINOR VARIANCE/PERMISSION

UNDER SECTION 45 OF THE PLANNING ACT

1. APPLICANT INFORMATION

		_		-
	NAME	MAILING	ADDRESS	
Registered Owners(s)	LaCaban Developments Inc	c.		
Applicant(s)	Ross Defina			
Agent or Solicitor	Ross Defina			
.2 Primary contact		☑ Applicant		☐ Owner ☑ Agent/Solicitor
.3 Sign should be s	ent to	☑ Applicant		☐ Owner☑ AgentSolicitor
.4 Request for digital	al copy of sign	☑ Yes*	□ No	
If YES, provide e	email address where sign	n is to be sent		
.5 All corresponden	ice may be sent by emai	I	☑ Yes*	□ No
(if applicable). O	nail must be included for nly one email address s es not guarantee all corre	ubmitted will	result in the vo	oiding of this service.
.6 Payment type		☐ In person ☑ Cheque		☐ Credit over phone*
			*Must provi	ide number above

2. LOCATION OF SUBJECT LAND

2.1 Complete the applicable sections:

Municipal Address	61 Clapham Road, Hamilton, On. L8G 2H9		
Assessment Roll Number			
Former Municipality	City of Hamilton		
Lot	28	Concession	3
Registered Plan Number		Lot(s)	
Reference Plan Number (s)		Part(s)	

116	rait(s)
2.2	Are there any easements or restrictive covenants affecting the subject land?
	☐ Yes ☑ No If YES, describe the easement or covenant and its effect:
3.	PURPOSE OF THE APPLICATION
	ditional sheets can be submitted if there is not sufficient room to answer the following estions. Additional sheets must be clearly labelled
All c	dimensions in the application form are to be provided in metric units (millimetres, metres, hectares,)
3.1	Nature and extent of relief applied for:
	 To permit a reduced easterly side yard setback. To permit a unenclosed porch encroachment into the westerly side yard. To permit a reduced minimum driveway dimensions. To permit a reduced access driveway easterly side yard setback.
	☐ Second Dwelling Unit
3.2	Why it is not possible to comply with the provisions of the By-law?
	1. Proposed easterly side yard is 1.5m where 2.0m is required. Section 10F(4)(c). 2. Unenclosed porch at unit #1 is with the westerly side yard. By-law only permit a porch with a front or rear yard. Section 18(3)(d). 3. Proposed driveway dimension is 3.0mx5.5m whereas 3.0mx5.8m is required for a secondary dwelling unit. Sections 18A(7) and Section 19. 4. Proposed parking and loading space dimension is 3.0mx5.5m whereas 3.0mx5.8m is required for a secondary dwelling unit. Sections 18A(9) and Section 19. 5. Proposed access driveway (unit #5) is 1.92m whereas 3.0m is required for a secondary dwelling unit. Sections 18A(25) and Section 19.
3.3	Is this an application 45(2) of the Planning Act. ☐ Yes ☑ No
	If ves. please provide an explanation:

4. DESCRIPTION OF SUBJECT LAND AND SERVICING INFORMATION

4.1 Dimensions of Subject Lands:

Lot Frontage	Lot Depth	Lot Area	Width of Street
24.94m	34.44m	850.70m2	

	buildings and structur ce from side, rear and		r the subject lands:	
Existing:				
Type of Structure	Front Yard Setback	Rear Yard Setback	Side Yard Setbacks	Date of Construction
Single Family Residential	6.12m	17.94m	3.02m	01/01/1955
Shed #1	n a	19.27m	1.65m	
Shed #2	n a	8.13m		
Proposed:		<u> </u>		
Type of Structure	Front Yard Setback	Rear Yard Setback	Side Yard Setbacks	Date of Construction
5 Unit Townhouse	5.5m	6.5m	1.5m	
4.3. Particulars of a sheets if neces Existing:	•	tures on or proposed	for the subject lands (attach additional
Type of Structure	Ground Floor Area	Gross Floor Area	Number of Storeys	Height
Main House	103.37	103.37	1	5.84
Shed #1	5.2	5.2	1	
Shed #2	11.4	11.4	1	
Proposed:				
Type of Structure	Ground Floor Area	Gross Floor Area	Number of Storeys	Height
5 Unit Townhouse	291.6	704.7	2	10.757
 4.4 Type of water supply: (check appropriate box) publicly owned and operated piped water system privately owned and operated individual well 4.5 Type of storm drainage: (check appropriate boxes) publicly owned and operated storm sewers swales 		☐ lake or other ☐ other means ☐ ditches ☐ other means	s (specify)	

4.6	Type of sewage disposal proposed: (check appropriate box)				
	 ✓ publicly owned and operated sanitary sewage ✓ system privately owned and operated individual ✓ septic system other means (specify) 				
4.7	Type of access: (check appropriate box) ☐ provincial highway ☐ municipal road, seasonally maintained ☐ municipal road, maintained all year				
4.8	Proposed use(s) of the subject property (single detached dwelling duplex, retail, factory etc.):				
	5 Unit Townhouse Residential				
4.9	9 Existing uses of abutting properties (single detached dwelling duplex, retail, factory etc.):				
	Single Family Detached Residential				
7	HISTORY OF THE SUBJECT LAND				
7.1	Date of acquisition of subject lands: June 15, 2015				
7.2	·				
7.3	Existing use(s) of the subject property: (single detached dwelling duplex, retail, factory etc) Single Detached Residential				
7.4	Length of time the existing uses of the subject property have continued: Unknown				
7.5	5 What is the existing official plan designation of the subject land?				
	Rural Hamilton Official Plan designation (if applicable): N/A				
	Rural Settlement Area: N/A				
	Urban Hamilton Official Plan designation (if applicable) Neighbourhoods				
	Please provide an explanation of how the application conforms with the Official Plan. Neighbourhoods designation permits townhouses.				
7.6	What is the existing zoning of the subject land? RT-30/S-1738				
7.8	Has the owner previously applied for relief in respect of the subject property? (Zoning By-lawAmendment or Minor Variance) ✓ Yes □ No				
	If yes, please provide the file number: ZAC-16-018				

7.9	Is the subject property the subject of a current application for consent under Section 53 of the			
	Planning Act?	☐Yes	☑ No	
	If yes, please provide the file number:			
8	ADDITIONAL INFORMATION			
8.1	Number of Dwelling Units Existi	ng: <u>1</u>		
8.2	Number of Dwelling Units Propo	osed: 10		
8.3	Additional Information (please include separate sheet if needed):			
	5 Unit Townhouse with legal basement apartments.			

11.1 All Applications ✓ Application Fee ✓ Site Sketch ✓ Complete Application form ✓ Signatures Sheet 11.4 Other Information Deemed Necessary ✓ Cover Letter/Planning Justification Report Authorization from Council or Director of Planning and Chief Planner to submit application for Minor Variance Minimum Distance Separation Formulae (data sheet available upon request) Hydrogeological Assessment Septic Assessment Archeological Assessment ☐ Noise Study ☐ Parking Study

COMPLETE APPLICATION REQUIREMENTS