COMMITTEE OF ADJUSTMENT



City Hall, 5th floor, 71 Main Street West, Hamilton, ON L8P 4Y5
Telephone (905) 546-2424, ext. 4221

E-mail: cofa@hamilton.ca

NOTICE OF PUBLIC HEARING Minor Variance

You are receiving this notice because you are either:

- Assessed owner of a property located within 60 metres of the subject property
- Applicant/agent on file, or
- Person likely to be interested in this application

APPLICATION	A-25:122	SUBJECT	12 Melbourne Street, Hamilton
NO.:		PROPERTY:	
ZONE:	'R1a' (Low Density Residential	ZONING BY-	Hamilton Zoning By-law 05-200
	- Small Lot)	LAW:	

APPLICANTS: Owner: David and Lesley Jesseau

Agent: Tyler Malone

The following variances are requested:

- 1.A minimum 0.9 metre side yard setback shall be permitted instead of the minimum required 1.2 metre setback.
- 2.No Landscape Strip shall be required to be provided within the required side yard adjacent to an Additional Dwelling Unit – Detached whereas a Landscape Strip is required.
- 3.A maximum building height of 7.0 metres shall be provided for the Additional Dwelling Unit Detached, instead of the maximum permitted height of 6.0 metres.
- 4.A maximum gross floor area of 95.0 square metres shall be provided for the Additional Dwelling Unit Detached whereas a maximum gross floor area of 75.0 square metres is permitted.
- 5.A maximum combined lot coverage of all buildings on a lot containing an Additional Dwelling Unit Detached shall be 47% instead of the maximum permitted lot coverage of 45%.
- 6.A total of two (2) parking spaces shall be permitted to be maintained with a hard surface material instead of the requirement that any parking provided beyond that which is required shall be maintained with permeable material.

PURPOSE & EFFECT: To permit the construction of an Additional Dwelling Unit - Detached within the rear yard of the existing Single Detached Dwelling.

Notes:

A-25:122

- Details were not provided to determine the minimum landscaped area provided. Additional variances may be required for the landscaped area if compliance with Section 15.2.2.1.h) cannot be achieved.
- ii. Details were not provided to determine the extent of the potential eave and gutter encroachment. Additional Variances may be required if compliance with Section 4.33.2.d) cannot be achieved.

This Notice must be posted by the owner of any land which contains seven or more residential units so that it is visible to all residents.

This application will be heard by the Committee as shown below:

DATE:	Thursday, August 14, 2025
TIME:	1:55 p.m.
PLACE:	Via video link or call in (see attached sheet for details)
	City Hall Council Chambers (71 Main St. W., Hamilton)
	To be streamed (viewing only) at
	www.hamilton.ca/committeeofadjustment

For more information on this matter, including access to drawings illustrating this request and other information submitted:

- Visit <u>www.hamilton.ca/committeeofadjustment</u>
- Visit Committee of Adjustment staff at 5th floor City Hall, 71 Main St. W., Hamilton

PUBLIC INPUT

Written: If you would like to submit written comments to the Committee of Adjustment you may do so via email or hardcopy. Please see attached page for complete instructions, written comments must be received no later than noon August 12, 2025

Orally: If you would like to speak to this item at the hearing you may do so via video link, calling in, or attending in person. Please see attached page for complete instructions, registration to participate virtually must be received no later than noon August 13, 2025

FURTHER NOTIFICATION

If you wish to be notified of future Public Hearings, if applicable, regarding A-25:122, you must submit a written request to cofa@hamilton.ca or by mailing the Committee of Adjustment, City of Hamilton, 71 Main Street West, 5th Floor, Hamilton, Ontario, L8P 4Y5.

If you wish to be provided a Notice of Decision, you must attend the Public Hearing and file a written request with the Secretary-Treasurer by emailing cofa@hamilton.ca or by mailing the Committee of Adjustment, City of Hamilton, 71 Main Street West, 5th Floor, Hamilton, Ontario, L8P 4Y5.



Subject Lands

DATED: July 28, 2025

Justin Leung, Secretary-Treasurer Committee of Adjustment Information respecting this application is being collected under the authority of the Planning Act, R.S.O., 1990, c. P. 13. All comments and opinions submitted to the City of Hamilton on this matter, including the name, address, and contact information of persons submitting comments and/or opinions, will become part of the public record and will be made available to the Applicant and the general public, and may include posting electronic versions.



COMMITTEE OF ADJUSTMENT

City Hall, 5th floor, 71 Main Street West, Hamilton, ON L8P 4Y5

Telephone (905) 546-2424, ext. 4221

E-mail: cofa@hamilton.ca

PARTICIPATION PROCEDURES

Written Submission Ahead of the Meeting

Members of the public who wish to provide input without speaking at the Hearing may submit written comments in advance of the meeting. Comments must be received by 12:00 p.m. (noon) on the date listed on the Notice of Public Hearing.

How to Submit Written Comments:

By Email:

Send to: cofa@hamilton.ca

By Mail:

Committee of Adjustment City of Hamilton 71 Main Street West, 5th Floor Hamilton, Ontario L8P 4Y5

All written comments received will be made available to the Committee and the public by the Tuesday prior to the Hearing.

Oral Submissions During the Hearing

Interested members of the public, agents, and owners may provide oral comments on Committee of Adjustment Hearing items either virtually via Webex (computer or phone) or by attending in person.

Speaking Time Limit:

All participants providing oral submissions, either in person or virtually are limited to a maximum of 5 minutes to speak. This is to ensure all parties have an equal opportunity to be heard and that the meeting runs efficiently.

In-Person Oral Submissions

To participate in person, attend Council Chambers on the date and time listed in the Notice of Public Hearing. You will be required to provide your name and address for the record. It is recommended you arrive at least 10 minutes prior to the scheduled start time.

A-25:122

Virtual Oral Submissions

To participate virtually, you must register by 12:00 p.m. (noon) on the date listed on the Notice of Public Hearing. To register, email cofa@hamilton.ca with the following information:

- Committee of Adjustment file number
- Hearing date
- Name and mailing address of each person wishing to speak
- Method of participation (phone or video), and, if applicable, the phone number to be used
- Each person must register separately

Registered participants will receive a Webex link one business day before the Hearing. Only those registered will be called upon to speak.

Presentations

All presentations are permitted at the discretion of the Committee.

Virtual Presentations:

Presenters participating virtually may be granted permission to share their screen during the Hearing. A copy of the presentation must be submitted to cofa@hamilton.ca no later than 12:00 p.m. (noon) on the business day prior to the Hearing. The submission must be one document in PDF format only.


In-Person Presentations:

Presenters attending in person may be granted permission to use the presentation screen. Presentations must be brought on a USB device and opened by the owner/applicant. A copy of the presentation must also be sent to cofa@hamilton.ca by 12:00 p.m. (noon) on the business day prior to the Hearing in PDF format as a single document. Handouts are permitted only if the same content can be displayed on the presentation screen.

Additional Notes

- Webex (video) participation requires a compatible computer or smartphone. The necessary application must be downloaded in advance.
- It is the interested party's responsibility to ensure their device is functional and compatible prior to the Hearing.

For any questions, contact staff at cofa@hamilton.ca or call 905-546-2424 ext. 4221.

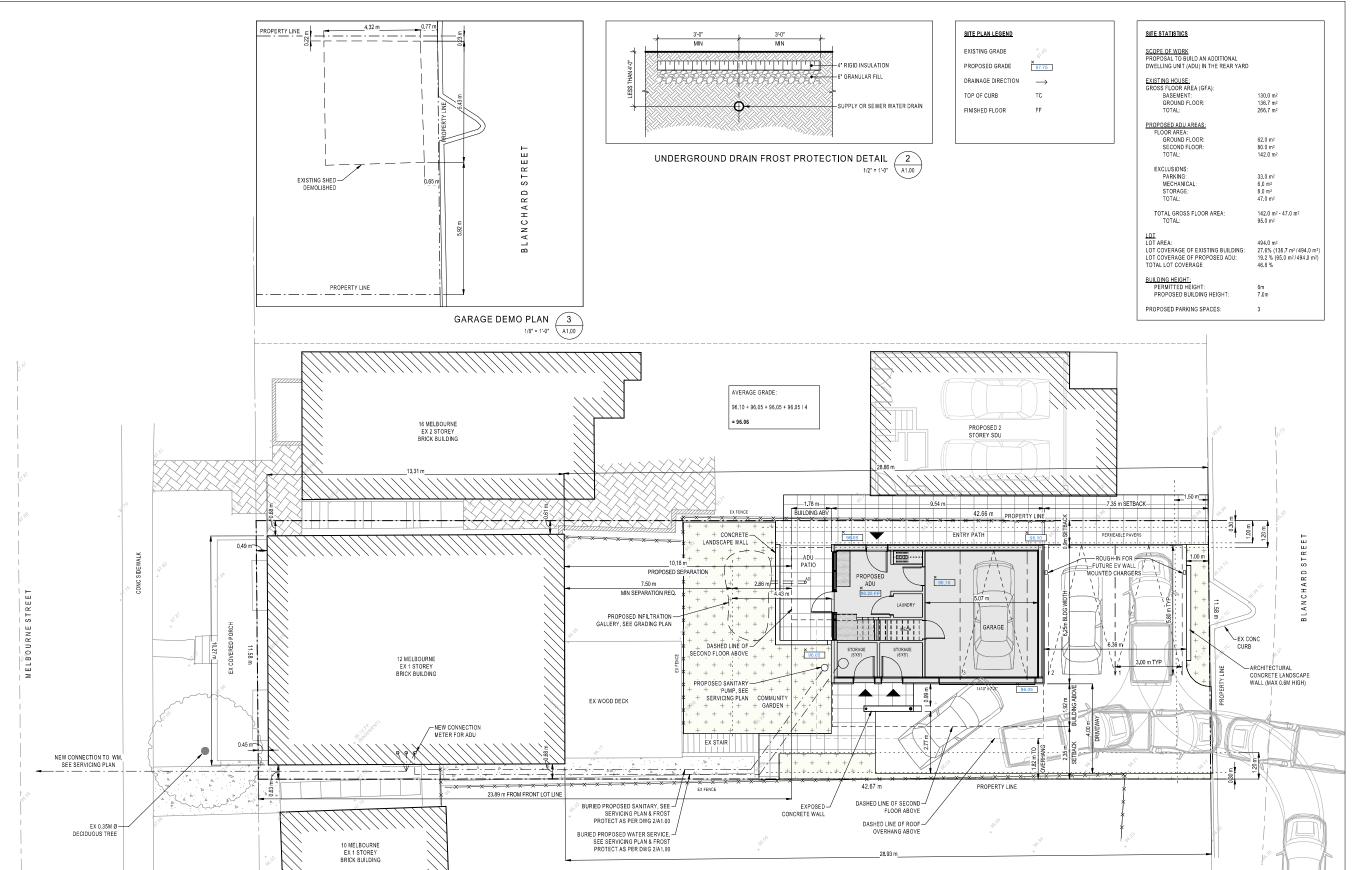

- These Contract Documents are the property of the Architect. The Architect bears no responsibility for the interpretations of these documents by the Contractor. Upon written application the Architect will provide written and graphic clarification or supplementary information regarding the inlent of the Contract Documents. The Architect will review Shop Drawings ubmitted by the Contractor for design conformance only.

 2. Drawings are not to be scaled for construction. Contractor to
- Drawings are not to be scaled for construction. Contractor to verify all existing conditions and dimensions required to perform the Work and report any discrepancies with the Contract Documents to the Architect before commencing work.
- Positions of exposed or finished mechanical or electrical devices, fittings, and fixtures are indicated on the Architectural drawings. The locations shown on the Architectural drawings govern over the Mechanical and Electrical drawings. Those items not clearly located will be located as directed by the Architect.



 Issued For Minor Variance
 2025/06/03

 Issued For Progress
 2025/05/08

 Issued For Coordination
 2025/05/05

 Issued For Progress
 2025/01/21

lo. Description

TOMS + MCNALLY

Date

301-41 King William Street | Hamilton | Ontario | L8R 1A2 | 289 768 2211

www.toms-mcnally.ca

12 MELBOURNE ADDITIONAL DWELLING UNIT

12 MELBOURNE STREET, HAMILTON, ON

SITE PLAN


Project No.: 24030
Scale: 1/8" = 1'-0"
Drawn By: MM
Checked By: GM

12 MELBOURNE ADDITIONAL DWELLING UNIT

12 MELBOURNE STREET, HAMILTON, ON


ARCHITECT

TOMS + MCNALLY DESIGN INC 145 KING STREET EAST HAMILTON, ON L8N 1B1

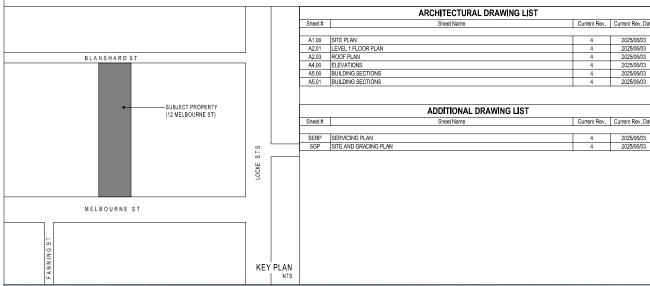



LEGEND

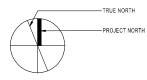





DOOR



SCR1 ___

SCREEN TYPE TAG

WALL / PARTITION TYPE TAG



CEILING TYPE TAG



DOOR NUMBER TAG



DRAWING NOTE TAG



GRIDLINE IDENTIFICATION (ALPHA / NUMERIC - VERT / HORIZ



BUILDING SECTION REFERENCE

— DETAIL NUMBER

— SHEET NUMBER











ONTARIO BUILDING CODE DATA MATRIX PART 9 - HOUSING AND SMALL BUILDINGS OBC REFERENCE [1] Name of Practice Toms + McNally Design Inc Address 1 145 King St Fast Hamilton, ON, L8N 1B1 Address 2 Philip Toms Contact Name of Project 12 Melbourne Additional Dwelling Unit Location/Address 12 Melbourne Street Hamilton Ontario 9.00 BUILDING CODE VERSION O.Rea. 332/12 LAST AMENDMENT O Reg. 163/24 Contruction of a 2 storey additional dwelling in the rear yard of 12 Melbourne St 9.02 OCCUPANCY CLASSIFICATION OCCUPANCY 9.10.2. 9.03 SUPERIMPOSED MAJOR OCCUPANCIES NO 9.10.2.3. 9.04 BUILDING AREA (m²) TOTAL [A] 1.4.1.2. Additional Dwelling Unit 95.0 TOTAL 95.0 95.0 TOTAL [A] 1.4.1.2

33.00

14.00

80.00

Proposed increase size of water service

HEAVY TIMBER CONSTRUCTION NO

BASED ON

Permitted

Permitted Combustible

Permitted Combustible

SB-12 Prescriptive Compliance Packages

Zone 1 (< 5000 Degree Days)

234.0

EBF
AREA L.D. (m²) % U.O. FRR TYPE CLADDING TYPE 9.10.15.

No of sleeping rooms

OCCUPANCY TYPE

30.0%

6.7%

GROSS ABOVE GRADE

33.0

14.0

15.0

80.0

9.10.20.

[A] 1.1.2.2.(2)

3.1.17.

9.5.2.

9.10.1.3.

7.00 (m) ABOVE GRADE [A] 1.4.1.2. 9.10.4.

(PERSONS)

Combustible Permitted

Combustible Permitted

FENESTRATION

14.4%

#DIV/0!

Ground Floor Garage

Ground Floor Mechanical & Storag

STOREYS ABOVE GRADE

STOREYS BELOW GRADE

[provide e: [provide explanation here]

7 35

4.45

2.35

45.0

64.0

1 STREET(S)

RESTRICTIONS Combustible Permitted

Second Floor Living Space

COMPLIANCE OPTION:

CLIMATIC ZONE

FENESTRATION

VERTICAL (W+D) SKYLIGHTS

SPACE HEATING FUEL
COMPLIANCE PACKAGE

PROJECT DESIGN CONDITIONS

Second Floor Living Space

9.07 BUILDING HEIGHT

9.08 NUMBER OF STREETS/ FIRE FIGHTER ACCESS

9.11 WATER SERVICE/ SUPPLY IS ADEQUATE

9.12 CONSTRUCTION TYPE

9.14 OCCUPANT LOAD

9.15 BARRIER-FREE DESIGN

9.18 SPATIAL SEPARATION

9.20 ENERGY EFFICIENCY

9.21 NOTES

Ontario Building Code Data Matrix, Part 9

9.16 HAZARDOUS SUBSTANCES

RESIDENTIAL

9.13 POST-DISASTER BUILDING

4	Issued For Minor Variance
3	Issued For Progress
2	Issued For Coordination
1	Issued For Progress
No.	Description

GENERAL NOTES:

These Contract Documents are the property of the Architect.
 The Architect bears no responsibility for the interpretations of

these documents by the Contractor. Upon written application the Architect will provide written and graphic clarification or

Documents. The Architect will review Shop Drawings submitted by the Contractor for design conformance only.

Drawings are not to be scaled for construction. Contractor to verify all existing conditions and dimensions required to perform the Work and report any discrepancies with the Contract Documents to the Architect before commencing work.

Positions of exposed or finished mechanical or electrical devices, fittings, and fixtures are indicated on the Architectural drawings. The locations shown on the Architectural drawings govern over the Mechanical and Electrical drawings. Those

items not clearly located will be located as directed by the

supplementary information regarding the intent of the Contract

TOMS + MCNALLY

DESIGN | ARCHITECTURE | URBANISM | CONSTRUCT

301-41 King William Street | Hamilton | Ontario | L8R 1A2 | 289 768 2211 www.toms-mcnally.ca


12 MELBOURNE ADDITIONAL DWELLING UNIT

12 MELBOURNE STREET, HAMILTON, ON

COVER

Project No.: 24030
Scale: As indicated
Drawn By: MM
Checked By: GM

H06-13 4:27:22 PM

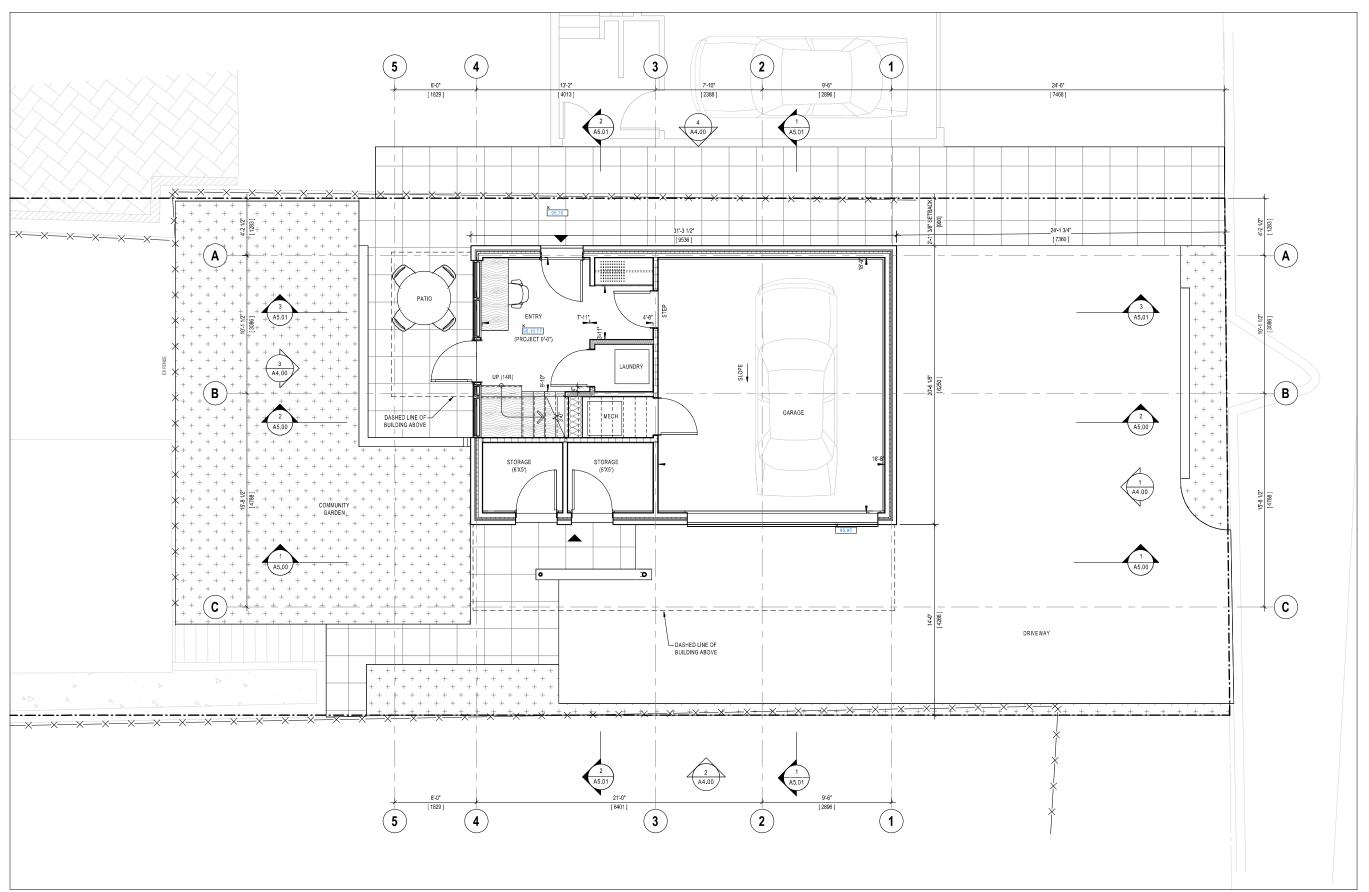

- GENERAL NOTES:

 1. These Contract Documents are the property of the Architect. The Architect bears no responsibility for the interpretations of these documents by the Contractor. Upon written application the Architect will provide written and graphic clarification or supplementary information regarding the intent of the Contract Documents. The Architect will review Shop Drawings submitted by the Contractor for design conformance only.

 2. Drawings are not to be scaled for construction. Contractor to verify all existing conditions and dimensions required to perform the Work and report any discrepancies with the Contract Documents to the Architect before commencing work.

 3. Positions of exposed or finished mechanical or electrical devices, fittings, and fixtures are indicated on the Architectural drawings. The locations shown on the Architectural drawings. The locations shown on the Architectural drawings. Those items not clearly located will be located as directed by the Architect.



Issued For Minor Variance Issued For Progress
Issued For Coordination
Issued For Progress

Description

2025/05/08 2025/05/05 2025/05/05 2025/01/21

Date

TOMS + MCNALLY


301-41 King William Street | Hamilton | Ontario | L8R 1A2 | 289 768 2211 www.toms-mcnally.ca

12 MELBOURNE ADDITIONAL DWELLING UNIT

12 MELBOURNE STREET, HAMILTON, ON

LEVEL 1 FLOOR PLAN

Project No.: 24030 1/4" = 1'-0" Drawn By: MM GM Checked By:

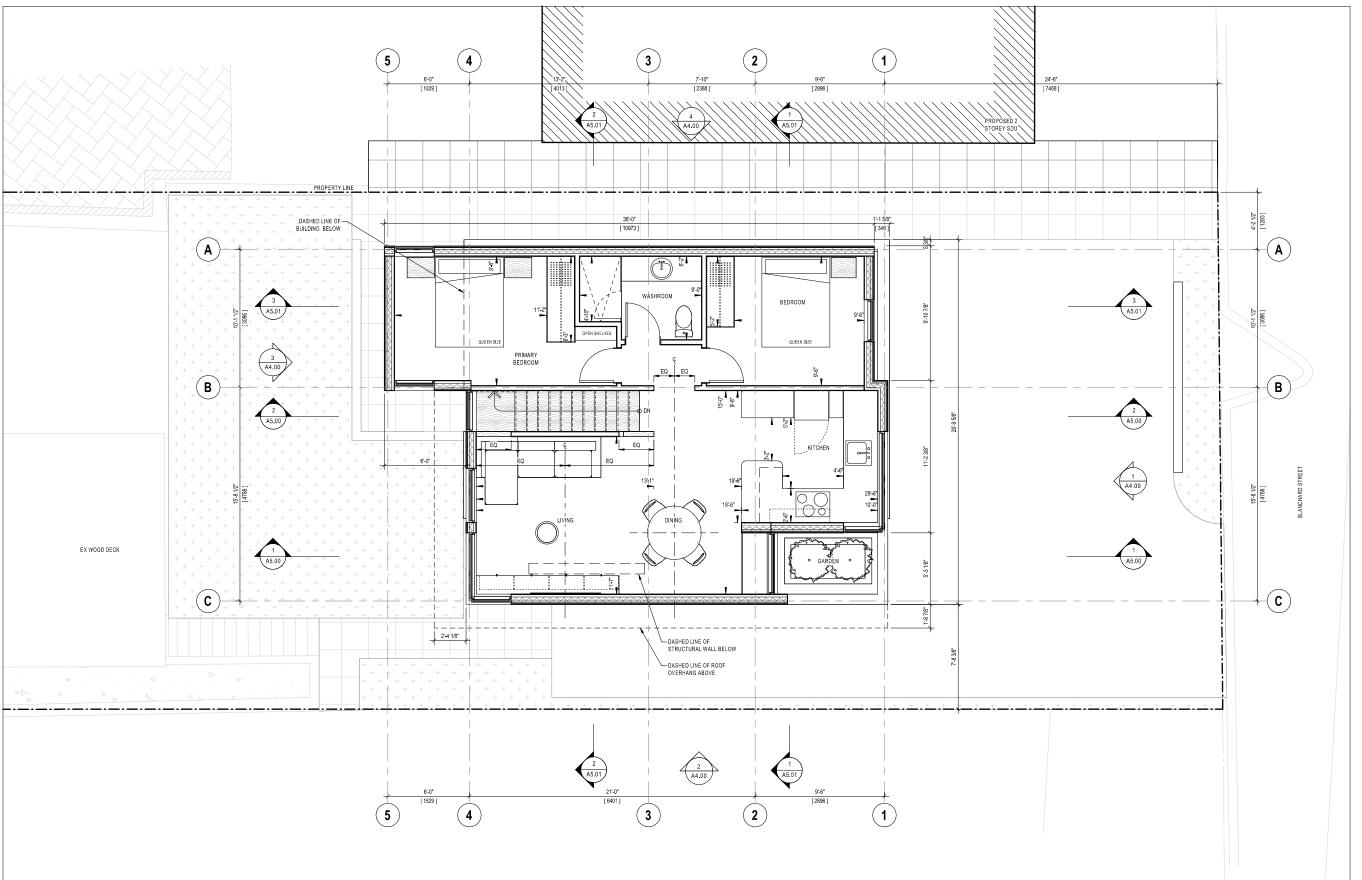

- GENERAL NOTES:

 1. These Contract Documents are the property of the Architect. The Architect bears no responsibility for the interpretations of these documents by the Contractor. Upon written application the Architect will provide written and graphic clarification or supplementary information regarding the intent of the Contract Documents. The Architect will review Shop Drawings submitted by the Contractor for design conformance only.

 2. Drawings are not to be scaled for construction. Contractor to verify all existing conditions and dimensions required to perform the Work and report any discrepancies with the Contract Documents to the Architect before commencing work.

 3. Positions of exposed or finished mechanical or electrical devices, fittings, and fixtures are indicated on the Architectural drawings. The locations shown on the Architectural drawings. The locations shown on the Architectural drawings. Those items not clearly located will be located as directed by the Architect.



Issued For Minor Variance Issued For Progress
Issued For Coordination
Issued For Progress

2025/06/03 2025/05/08 2025/05/05 2025/01/21

TOMS + MCNALLY


301-41 King William Street | Hamilton | Ontario | L8R 1A2 | 289 768 2211 www.toms-mcnally.ca

12 MELBOURNE ADDITIONAL DWELLING UNIT

12 MELBOURNE STREET, HAMILTON, ON

LEVEL 2 FLOOR PLAN

Project No.: 24030 1/4" = 1'-0" Drawn By: Author Checker Checked By:

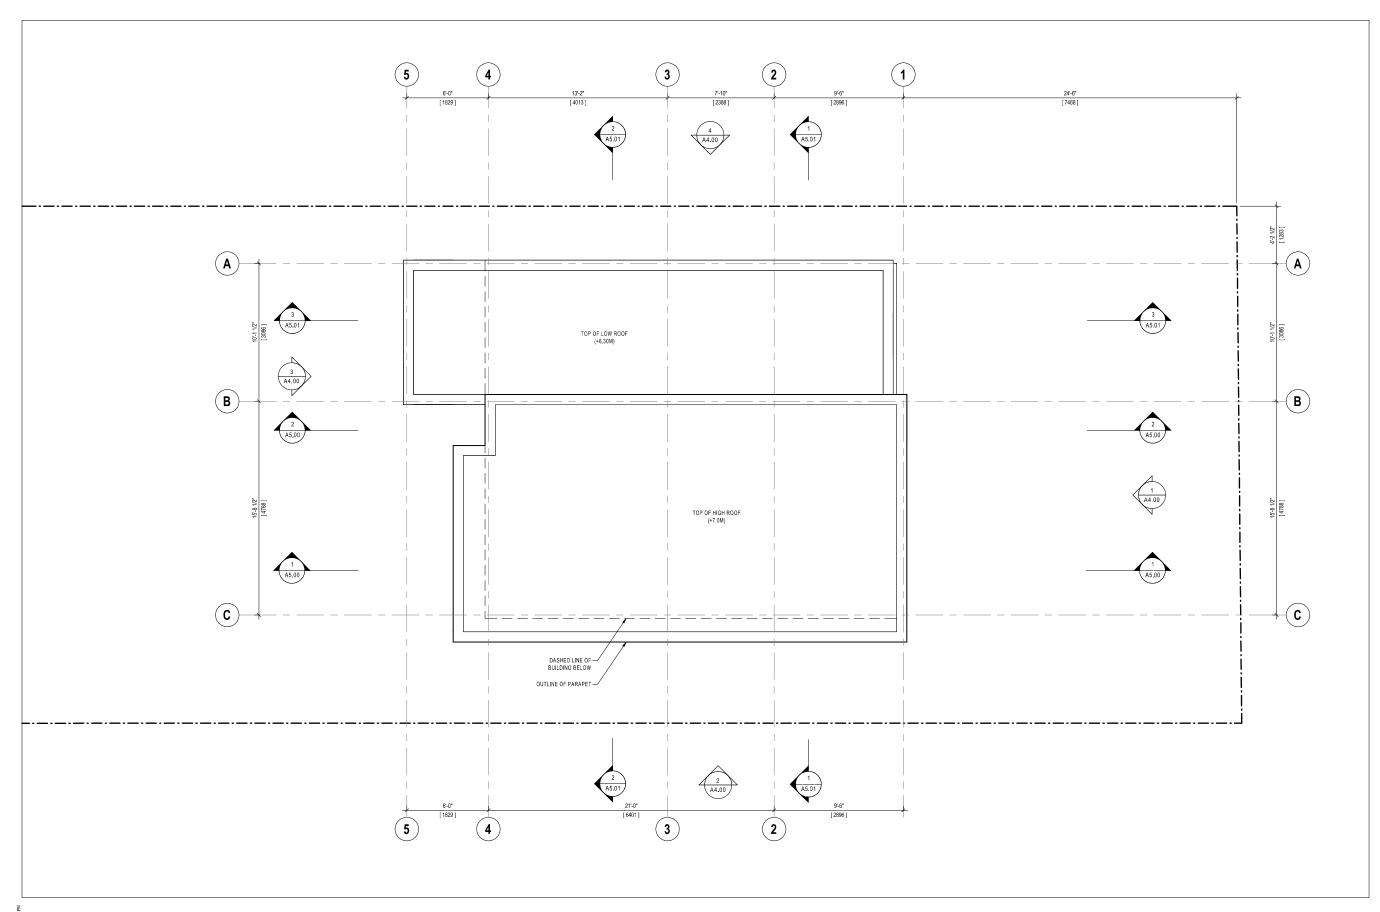

- GENERAL NOTES:

 1. These Contract Documents are the property of the Architect. The Architect bears no responsibility for the interpretations of these documents by the Contractor. Upon written application the Architect will provide written and graphic clarification or supplementary information regarding the intent of the Contract Documents. The Architect will review Shop Drawings submitted by the Contractor for design conformance only.

 2. Drawings are not to be scaled for construction. Contractor to verify all existing conditions and dimensions required to perform the Work and report any discrepancies with the Contract Documents to the Architect before commencing work. Positions of exposed or finished mechanical or electrical devices, fittings, and fixtures are indicated on the Architectural drawings. The locations shown on the Architectural drawings govern wover the Mechanical and Electrical drawings. Those items not clearly located will be located as directed by the Architect.



Issued For Minor Variance Issued For Progress
Issued For Coordination
Issued For Progress

2025/06/03 2025/05/08 2025/05/05 2025/01/21 Description

TOMS + MCNALLY


301-41 King William Street | Hamilton | Ontario | L8R 1A2 | 289 768 2211 www.toms-mcnally.ca


12 MELBOURNE ADDITIONAL DWELLING UNIT

12 MELBOURNE STREET, HAMILTON, ON

ROOF PLAN

Project No.: 24030 Scale: 1/4" = 1'-0" Drawn By: MM Checked By: GM

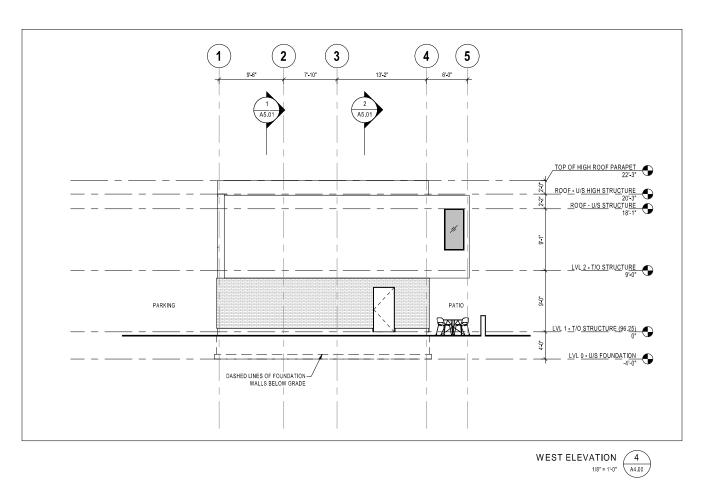

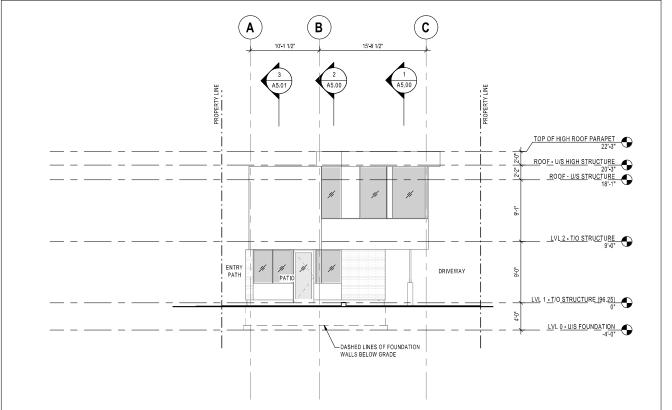

GENERAL NOTES:

1. These Contract Documents are the property of the Architect.
The Architect bears no responsibility for the interpretations of these documents by the Contractor. Upon written application the Architect will provide written and graphic clarification or supplementary information regarding the intent of the Contract Documents. The Architect will review Shop Drawings submitted by the Contractor for design conformance only.

2. Drawings are not to be scaled for construction. Contractor to verify all existing conditions and dimensions required to perform the Work and report any discrepancies with the Contract Documents to the Architect before commencing work.

3. Positions of exposed or finished mechanical or electrical devices, fittings, and fixtures are indicated on the Architectural drawings. The locations shown on the Architectural drawings. The locations shown on the Architectural drawings. The locations also devices the Architectural drawings in the Architectural drawing and the Contract of the Architectural drawing in the Archi

SOUTH ELEVATION 3 1/8" = 1'-0"

NORTH ELEVATION 1/8" = 1"-0" A4.00

Description

TOMS + MCNALLY

Issued For Minor Variance

Issued For Progress
Issued For Coordination Issued For Progress

2025/05/08 2025/05/05 2025/05/05 2025/01/21

Date

301-41 King William Street | Hamilton | Ontario | L8R 1A2 | 289 768 2211 www.toms-mcnally.ca

12 MELBOURNE ADDITIONAL DWELLING


12 MELBOURNE STREET, HAMILTON, ON


ELEVATIONS

UNIT

Project No.: 24030 Scale: 1/8" = 1'-0" Drawn By: MM Checked By: GM

A4.00

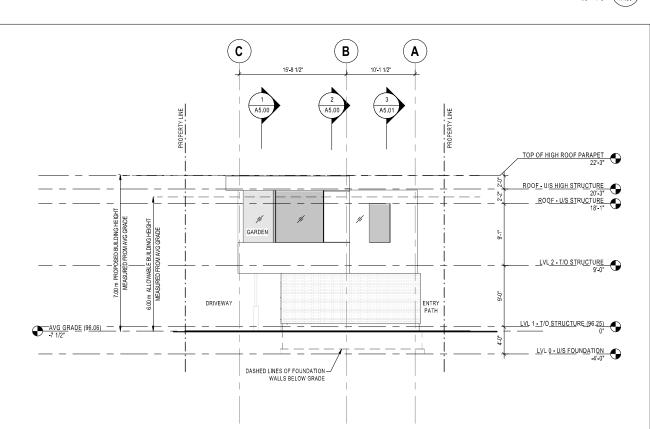

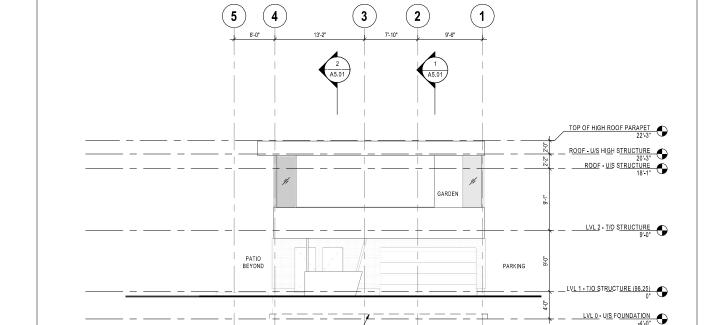


DASHED LINES OF FOUNDATION -




EAST ELEVATION 2

1/8" = 1"-0"

A4.00

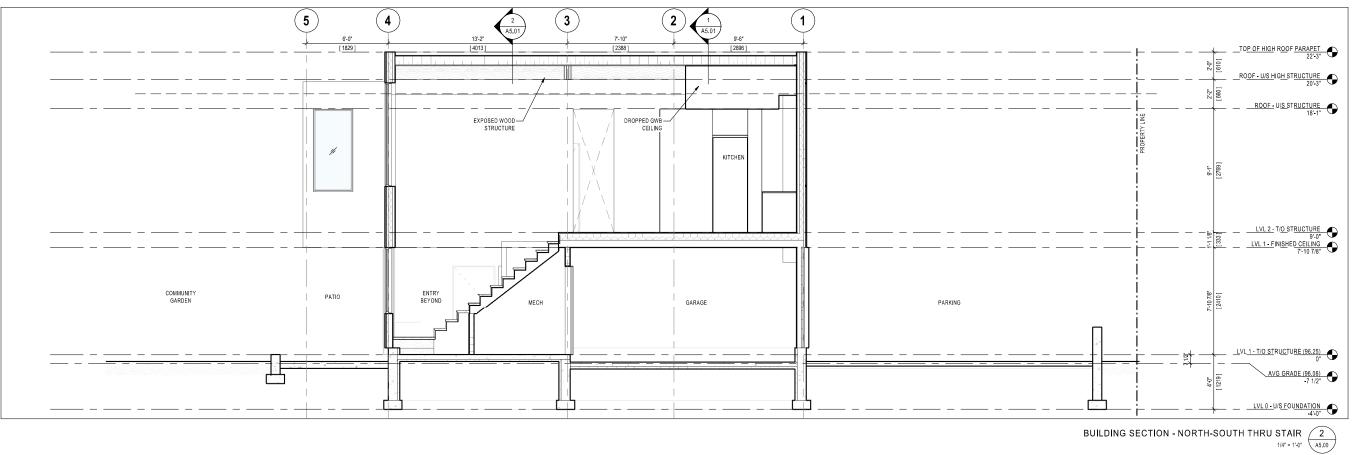

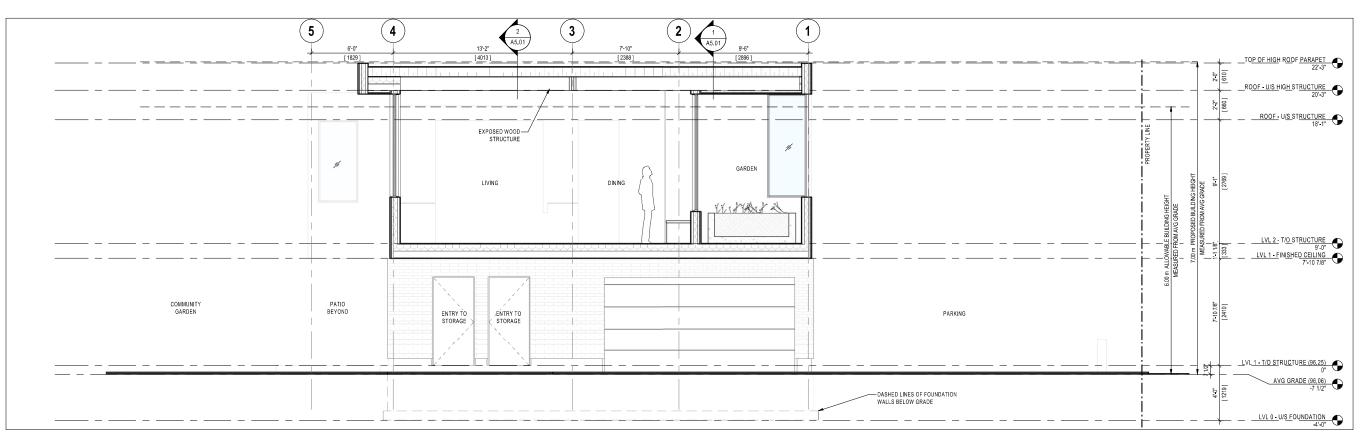

BUILDING SECTION - NORTH-SOUTH THRU LIVING & DINING 1/4" = 1'-0" A5.00

GENERAL NOTES:

- GENERAL NOTES:

 1. These Contract Documents are the property of the Architect. The Architect bears no responsibility for the interpretations of these documents by the Contractor. Upon written application the Architect will provide written and graphic clarification or supplementary information regarding the intent of the Contract Documents. The Architect will review Shop Drawings submitted by the Contractor for design conformance only.

 2. Drawings are not to be scaled for construction. Contractor to verify all existing conditions and dimensions required to perform the Work and report any discrepancies with the Contract Documents to the Architect before commencing work.

 3. Positions of exposed or finished mechanical or electrical devices, fittings, and fixtures are indicated on the Architectural drawings. The locations shown on the Architectural drawings. Those items not clearly located will be located as directed by the Architect.

2025/06/03 2025/05/08 2025/05/05 2025/01/21 Issued For Minor Variance Issued For Progress
Issued For Coordination
Issued For Progress Date Description

TOMS + MCNALLY


301-41 King William Street | Hamilton | Ontario | L8R 1A2 | 289 768 2211 www.toms-mcnally.ca

12 MELBOURNE ADDITIONAL DWELLING UNIT

12 MELBOURNE STREET, HAMILTON, ON


BUILDING SECTIONS

Project No.: 24030 Scale: 1/4" = 1'-0" Drawn By: MM GM Checked By:

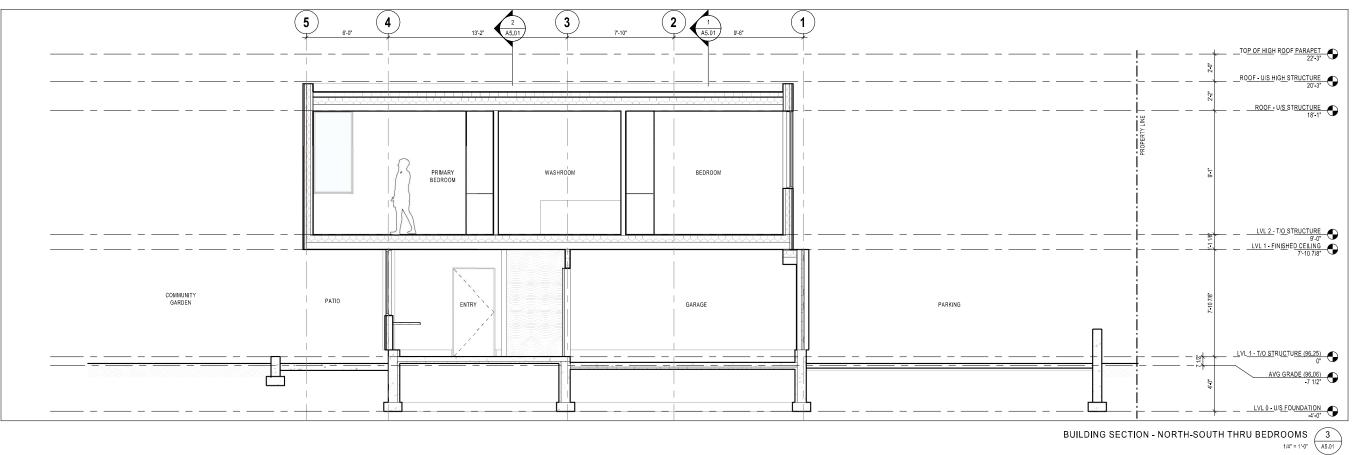


LVL 0 - U/S FOUNDATION 4'-0"

BUILDING SECTION - EAST-WEST

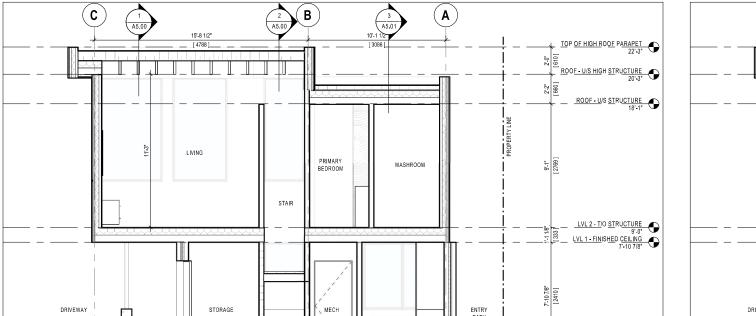

 (A)

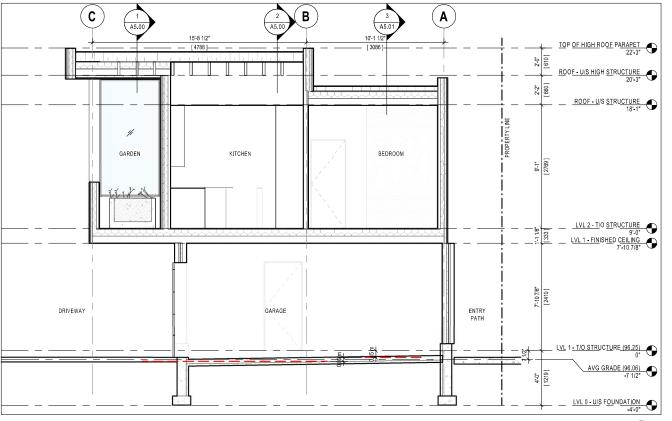

GENERAL NOTES:

- GENERAL NOTES:

 1. These Contract Documents are the property of the Architect. The Architect bears no responsibility for the interpretations of these documents by the Contractor. Upon written application the Architect will provide written and graphic clarification or supplementary information regarding the intent of the Contract Documents. The Architect will review Shop Drawings submitted by the Contractor for design conformance only.

 2. Drawings are not to be scaled for construction. Contractor to verify all existing conditions and dimensions required to perform the Work and report any discrepancies with the Contract Documents to the Architect before commencing work,

 3. Positions of exposed or finished mechanical or electrical devices, fittings, and fixtures are indicated on the Architectural drawings. The locations shown on the Architectural drawings. Those items not clearly located will be located as directed by the Architect.

Issued For Minor Variance 2025/05/08 2025/05/05 2025/05/05 2025/01/21 Issued For Progress
Issued For Coordination Issued For Progress Date Description

TOMS + MCNALLY

301-41 King William Street | Hamilton | Ontario | L8R 1A2 | 289 768 2211 www.toms-mcnally.ca

12 MELBOURNE ADDITIONAL DWELLING UNIT

12 MELBOURNE STREET, HAMILTON, ON

BUILDING SECTIONS

Project No.: 24030 Scale: 1/4" = 1'-0" Drawn By: MM GM Checked By:

(c)

GENERAL NOTES

1. THES/THESE SHAPE IS /ARE NOT TO BE USED FOR CONSTRUCTION UNITL. SEALED BY THE DRONGER AND

1. THES/THESE SHAPE OF CONSTRUCTION ON THE DRONGER.

1. THES/THESE SHAPE OF CONSTRUCTION ON THE DRONGER

1. THES/THESE SHAPEN OF THE SERFECTION OF THE SHAPEN WITHOUT THE WRITTEN

1. THES/THESE THESIS (SAREN OF THE SERFECTION OF THE UTILITY OF THE WRITTEN

1. RECONSTRUCTION DRANNESS ARE FUNDAMEND AS THE SET AVAILABLE INFORMATION. THE CONTRACTOR

CONTRACTOR DRANNESS ARE FUNDAMEND AS THE SET AVAILABLE INFORMATION. THE CONTRACTOR

1. SHESS ALBESTS DEPOSITION OF THE SET AVAILABLE INFORMATION. THE CONTRACTOR

CONTRACTOR SHALL ASSIME LIABILITY FOR THE ACCOUNT OF MORE SHAPEN OF THE SHAPEN OF TH

STANDARDS.

14. SERVINDS CONTRACTOR TO MAINTAIN A "COMPINED TRENCH CONDITION" IN ALL SEMER AND WATERMAIN NOSIGLALIDOUS TRENCHES.

15. THE SITE SERVINDS CONTRACTOR SHALL TERMINATE ALL SERVICES 1.0m FROM THE BUILDING FACE.

16.NO BUSSTION ULL BE FERMITIED.

SCHERS

1. STORM SEWERS
1. CONSTRUCTION OF STORM SEWERS SHALL BE IN ACCORDANCE WITH CITY STANDARDS & SECONCATIONS (LATEST EDITION) AND MINISTRY OF ENVIRONMENT (MOE) GUIDELINES (LATEST EDITION).

EDITION).

B. COMER AND BECOMEN MATERIAL FOR PUC PIPE SHALL BE GRANULAR "A" MATERIAL AS PER OPSD 802.010 OR 802.013.

C. PUC PIPE ME MILE STEAM COLISTRUCTION PROCEDURES AS PER CITY SPECIFICATIONS. DE ALL SEMENTS TO SESSION TO MOSON INSPECTION.

L. M.L. SEMENTS TO BE FLUISSED PROPER TO MOSO INSPECTION.

F. STORM SEMENTS 50 DEF FLUISSED PROPER TO MOSON INSPECTION.

C. PROPOSED PRIVATE ECRAL TO! CATON BASINS (RCMS*) ARE TO BE AS PER OPSD 705.010.

COMPLETE WITH REPOCALE FRAME AND GRATELAS PER OPS 00.0120. CRUZA I COT ACTO HASANS ARE TO BE SAMPLESS.

ARE 10 BE SUMPLES ARE TO BE TESTED FOR DEPLECTION (MANOREL PASSAGE) AFTER INSTALLATION.

A LIL INC SEMENS ARE TO BE TESTED FOR DEPLECTION (MANOREL PASSAGE) AFTER INSTALLATION.

2. STORM AND SANTIARY PRIVATE DRAINS SHALL BE IN ACCORDANCE WITH CITY STANDARDS &
SPECEPCA HONS (LATEST EDITION) AND MINISTRY OF ENVIRONMENT (MCC) DUBLENES (LATEST
SPECIAL REPORT OF BETS EDITION) AND MINISTRY OF ENVIRONMENT (MCC) DUBLENES (LATEST
STORM PRE-SHALL BE WHITE AND SANTIARY SHALL BE ANY COLOUR OTHER HAM WHITE BOOD
MANROW, AT 120 OF SANTIARY PRIVATE DRAINS SHALL BE CHANDLAR "A" INSTALLED AS PER
COOPER AND REDIGNAL WHITE AND SANTIARY SHALL BE PARTID BRICE.

C. COOPER AND REDIGNAL WHITE AND SANTIARY SHALL BE PARTID BRICE.

E. TOP OF SANTIARY PRIVATE DRAINS OF E. 20X.

E. TOP OF SANTIARY PRIVATE DRAINS AT STREET LINE TO BE 2.2M (MN.) BELOW CENTERINE ROAD
BEYANDON AT THAT POINT OR AS DETAILED.

E. STANDAMENTER LEADERS SANTIARY PRIVATE DRAINS AT STREET LINE TO BE 2.2M (MN.) BELOW CENTERINE ROAD
BEYANDON AT THAT POINT OR AS DETAILED.

E. BULINDA WEARNIET LEADERS STEAM HOT BE CONNECTED TO THE STORM PRIVATE DRAIN BUT
SHALL DISCURRED TO LANDSCAPED SURFACES VIA SYSTAM PRIVATE DRAIN BUT
SHALL DISCURRED TO THE STORM PRIVATE DRAINS. THE SANTIARY CHILD PRE-SHALL EXTEND

A MINISMAN OF ISSUMM ABOVE, THE PROPOSED GRADE AT THE DRAILING (D SANTIE PER SHALL EXTEND

A MINISMA OF ISSUMM ABOVE THE PROPOSED GRADE AT THE DRAILING (D SANTIE SENTEN).

I. IT HE APPLICATELY OWNER INTERESTS TO MENSEL A PRIVATION OF A SITE'S ASSISTENCE SENTES. STEEL

MAPPLICANE ENTIRE PLANK REQUIREMENT, AND IS IN GOOD WERRING ORDER. SENTES SENTES STEEL

MAPPLICANE ENTIRE PLANK REQUIREMENT, AND IS IN GOOD WERRING ORDER. SENTES STEELS STEEL

MAPPLICANE ENTIRE PLANK REQUIREMENT, AND IS IN GOOD WERRING ORDER. SENTES STEELS STEEL

MAPPLICANT SENTES SENTES.

MATERIAL THE APPLICATION OF A STEEL SHALL FOR MANNEY OF AN INSPECTION FEEL.

WATERMANS AND MATER SERVICES

1. WATER SERVICES

A. CONSTRUCTION OF PRIVATE WATER SERVICES SHALL BE IN ACCORDANCE WITH CITY STANDARDS & SPECIECATIONS (LATEST EDITION) AND MINISTRY OF ENVIRONMENT (MOE) GUIDELINES (LATEST EDITION).

EDITION:

BETTOOL THIS CALLS LEVINON AND WINDOWS OF DEVENTMENT CANDOOD FROM THE SET OF T

600. E. ALL VALVE BOXES TO BE SET TO PROPOSED GRADES.

COMPACTION REQUIREMENTS

UNESS OFFERMER MOTED OR DIRECTED BY THE GEDECHNICAL CONSULTANT, THE FOLLOWING SHALL

AND STATEMENT OF THE CONTROL OF THE GEDECHNICAL CONSULTANT, THE FOLLOWING SHALL

AND STATEMENT OF THE CONTROL OF THE CONT

SILTATION AND EROSION CONTROL
ASILTATION CONTROL BARRERS SHALL BE PLACED AS DETAILED.
BALL SILTATION CONTROL MEASURES SHALL BE CLEARED AND MAINTAINED AFTER
EACH RAINFALL AS DIRECTED AND 10 THE SATISFACTION OF THE OF CITYTOWN
AND/OR THE CONSERVATION AUTHORITY.
CADDITIONAL SILT CONTROL LOCATIONS MAY BE REQUIRED AS DETERMINED BY THE
ENGINEER, THE CITYTOWN AND/OR THE CONSERVATION AUTHORITY.

RESTORATIONS


ALL TRENCH EXCAVATION WITHIN EXISTING ROAD ALLOWANCES SHALL BE BACKFILLED WITH GRANULAR "A", COMPACTED TO 98& SPD. PAYEMENT BACKFILLED WITH GRANULAR "A", COMPACTED TO 98& SPD. PAYEMENT BALL BOULEVARDS TO BE RESTORED WITH #I NURSERY SOO ON 100mm MINIMUM THICK SELECT TOPSOIL.


C.EEDDING MATERIALS TO BE AS PER FORM 600. COMPACTION TO BE AS PER FORM 900.


REMOVALS & ABANDONMENTS


1. COMPLETELY REMOVE ABANDONED SEWER/WATERMAIN WHERE POSSIBLE AND/OR AS DIRECTED BY THE CITY OF HAMILTON. IF MAINS TO BE ABANDONED IN PLACE, FOLLOW GPSS SID.

2. WHERE ABANDONING A WATER SERVICE CONNECTION OR WATERMAIN CONNECTED TO A LIVE MAIN, THE PREFERRED METHOD IS TO REMOVE THE CURB STOP AND STEM, SHUT OFF MAIN STOP AND DISCONNECTION WATER SERVICE AT MAIN STOP.

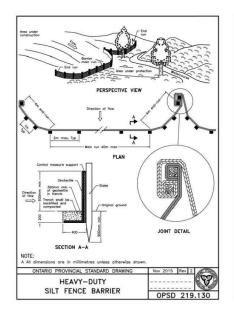

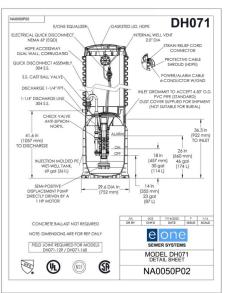

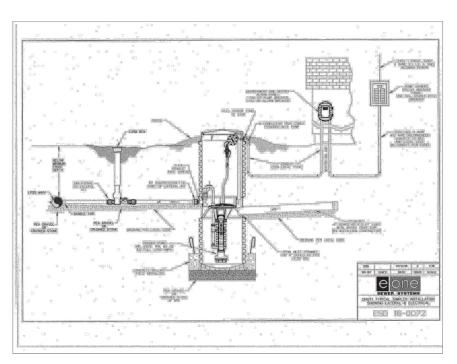

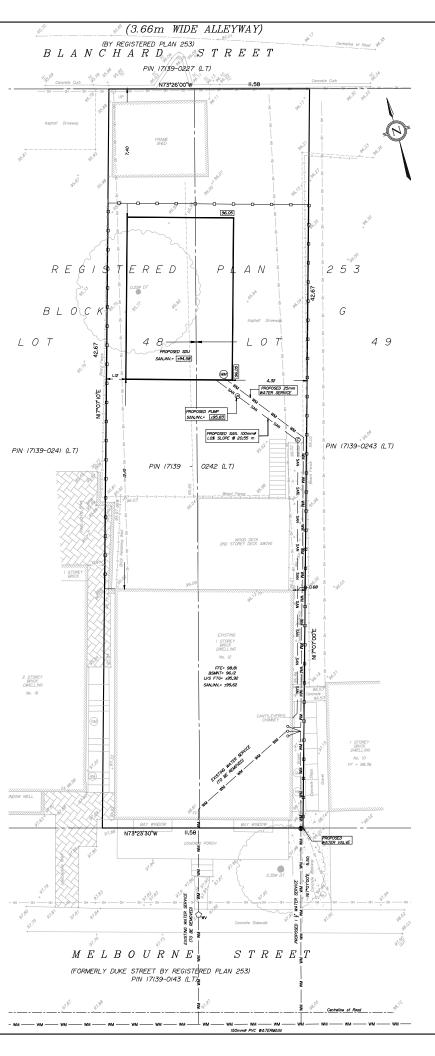




ADDRESS: 12 MELBOURNE STREET, HAMILTON

SERVICING PLAN OF PART OF LOT 48 & 49 BLOCK G REGISTERED PLAN 253 CITY OF HAMILTON

BARICH GRENKIE SURVEYING LTD. A DIVISION OF GEOMAPLE COPYRIGHT 2025

DISTANCES AND CO-ORDINATES SHOWN ON THIS PLAN ARE IN METRES AND CAN BE CONVERTED TO FEET BY DIVIDING BY 0.3048

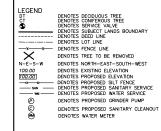

ELEVATIONS ARE REFERRED TO THE CANADIAN GEODETIC VERTICAL DATUM CGVD-1928:1978) AND ARE DERIVED FROM CITY OF HAMILTON BENCHMARK No. 07720020012 HAVING AN ELEVATION OF 84.543 m.

- 1							
- [1 05/20/2025			ISSUED AS PER ARCHITECT'S REQUEST			
- [0 01/23/2025		GF	ISSUED FOR REVIEW			
	NO. DATE			BY	REVISIONS		
	DESIGN		GF	CHK'D	DJ	DATE	
	DRAWN		GF	CHK'D	DJ	MAY 20,2025	



APPROVALS



24-3290

Barich Grenkie	DWN	BY:
Surveying Ltd. PROFESSIONAL SURVEYORS AND ENGINEERS 101 HWY No. 8 (2ND PLOOR) - STONEY CREEK, ON	CHK	BY:
(985) 682-6767 A DIVISION OF GEOMAPLE	JOB	No.

DAVID JESSEAU

PROPOSED SERVICING PLAN 12 MELBOURNE STREET, HAMILTON

SERVICING PLAN

PROJECT No. 24-3290 SERP 24-3290

GENERAL NOTES

1. THES/THESE SHAPE IS /ARE NOT TO BE USED FOR CONSTRUCTION UNITL. SEALED BY THE DRONGER AND

1. THES/THESE SHAPE OF CONSTRUCTION ON THE DRONGER.

1. THES/THESE SHAPE OF CONSTRUCTION ON THE DRONGER

1. THES/THESE SHAPEN OF THE SERFECTION OF THE SHAPEN WITHOUT THE WRITTEN

1. THES/THESE THESIS (SAREN OF THE SERFECTION OF THE UTILITY OF THE WRITTEN

1. RECONSTRUCTION DRANNESS ARE FUNDAMEND AS THE SET AVAILABLE INFORMATION. THE CONTRACTOR

CONTRACTOR DRANNESS ARE FUNDAMEND AS THE SET AVAILABLE INFORMATION. THE CONTRACTOR

1. SHESS ALBESTS DEPOSITION OF THE SET AVAILABLE INFORMATION. THE CONTRACTOR

CONTRACTOR SHALL ASSIME LIABILITY FOR THE ACCOUNT OF MORE SHAPEN OF THE SHAPEN OF TH

CONTRACIONE SPINAL ASSUME LIMENTET FOR ANY DIMANE, TO DESTRING VERNES.

5. THE PLAN INDOMARNAY MACH PROS SUPPLY OF HEADON DEBANES MAYER MACH PROVIDED TO THE STEE FLAN.

5. THE PLAN INDOMARNAY MACH PROS SUPPLY OF HEADON DEBANES MAYER AND THE PLAN DEBANES.

5. THE STEE FLAN.

6. THE STEE FLAN.

6. HINDROM A REPORTUL OF THESE DEBANES SEE FOR MATERIAL AND COMPLIANCE WITH CITY/TOWN STANDARDS AND PROVIDED AND STANDARDS ONLY. APPROVAL WITH HIS PLANS OF THE WERKS SEE THE CITY/TOWN STANDARDS AND PROVIDED AND STANDARDS ONLY. APPROVAL HIS HOSPICATION OF THE WERKS SEE THE CITY/TOWN STANDARDS AND PROVIDED AND THE STANDARD AND THE PLAN DESCRIPTION OF THE PLAN

STANDARDS.
14. SERVICING CONTRACTOR TO MAINTAIN A "CONFINED TRENCH CONDITION" IN ALL SEWER AND WATERMAIN INSTALLATION TRENCHES.
15. THE SITE SERVICING CONTRACTOR SHALL TERMINATE ALL SERVICES 1.0m FROM THE BUILDING FACE.
16. NO BUSTING WILL GE PERMITTED.

STMERS

1. STORM SEWERS

A CONSTRUCTION OF STORM SEWERS SHALL BE IN ACCORDANCE WITH CITY STANDARDS & SECPECATIONS (LATEST EDITION). AND MINISTRY OF DEVIRONMENT (MCE) SUBGLINES (LATEST EDITION).

EDITION).

EDITION).

EDITION OF ECONOM WATERIAL FOR PIVE PIPE SHALL BE GRANULAR "A MATERIAL AS PER OPSO 802.010 OR 802.013.

FOR PIPE WATER TO BE WIND INSPECTION.

D. ALL SPERS TO BE WIND INSPECTION.

D. ALL SPERS TO BE WIND INSPECTION.

ON INSPECTION.

D. ALL SPERS TO BE WIND INSPECTION.

ON INSPECTION.

FOR SPECTION STATEMENT OF THE PIPE CSA BIB2.2, SIR-35.

C PROPOSED PRIVATE FOR A LOT CATON BASINS (RCG*5) ARE TO BE AS PER OPSO 705.010.

OWNHETE WIND REDICALE FRAME AND GRATE AS PER OP SO 400.202. FARE ALTO CATON BASINS (ARE TO BE SAMPLESS.)

ARE TO BE SIMPLESS.

ARE 10 BE SUMPLES ARE TO BE TESTED FOR DEPLECTION (MANOREL PASSAGE) AFTER INSTALLATION.

A LIL INC SEMENS ARE TO BE TESTED FOR DEPLECTION (MANOREL PASSAGE) AFTER INSTALLATION.

2. STORM AND SANTIARY PRIVATE DRAINS SHALL BE IN ACCORDANCE WITH CITY STANDARDS &
SPECEPCA HONS (LATEST EDITION) AND MINISTRY OF ENVIRONMENT (MCC) DUBLENES (LATEST
SPECIAL REPORT OF BETS EDITION) AND MINISTRY OF ENVIRONMENT (MCC) DUBLENES (LATEST
STORM PRE-SHALL BE WHITE AND SANTIARY SHALL BE ANY COLOUR OTHER HAM WHITE BOOD
MANROW, AT 120 OF SANTIARY PRIVATE DRAINS SHALL BE CHANDLAR "A" INSTALLED AS PER
COOPER AND REDIGNAL WHITE AND SANTIARY SHALL BE PARTID BRICE.

C. COOPER AND REDIGNAL WHITE AND SANTIARY SHALL BE PARTID BRICE.

E. TOP OF SANTIARY PRIVATE DRAINS OF E. 20X.

E. TOP OF SANTIARY PRIVATE DRAINS AT STREET LINE TO BE 2.2M (MN.) BELOW CENTERINE ROAD
BEYANDON AT THAT POINT OR AS DETAILED.

E. STANDAMENTER LEADERS SANTIARY PRIVATE DRAINS AT STREET LINE TO BE 2.2M (MN.) BELOW CENTERINE ROAD
BEYANDON AT THAT POINT OR AS DETAILED.

E. BULINDA WEARNIET LEADERS STEAM HOT BE CONNECTED TO THE STORM PRIVATE DRAIN BUT
SHALL DISCURRED TO LANDSCAPED SURFACES VIA SYSTAM PRIVATE DRAIN BUT
SHALL DISCURRED TO THE STORM PRIVATE DRAINS. THE SANTIARY CHILD PRE-SHALL EXTEND

A MINISMAN OF ISSUMM ABOVE, THE PROPOSED GRADE AT THE DRAILING (D SANTIE PER SHALL EXTEND

A MINISMA OF ISSUMM ABOVE THE PROPOSED GRADE AT THE DRAILING (D SANTIE SENTEN).

I. IT HE APPLICATELY OWNER INTERESTS TO MENSEL A PRIVATION OF A SITE'S ASSISTENCE SENTES. STEEL

MAPPLICANE ENTIRE PLANK REQUIREMENT, AND IS IN GOOD WERRING ORDER. SENTES SENTES STEEL

MAPPLICANE ENTIRE PLANK REQUIREMENT, AND IS IN GOOD WERRING ORDER. SENTES STEELS STEEL

MAPPLICANE ENTIRE PLANK REQUIREMENT, AND IS IN GOOD WERRING ORDER. SENTES STEELS STEEL

MAPPLICANT SENTES SENTES.

MATERIAL THE APPLICATION OF A STEEL SHALL FOR MANNEY OF AN INSPECTION FEEL.

WAIERMANS AND WAIER SERVICES

1. MATHE SERVICES

A CONSTRUCTION OF PRIVATE WATER SERVICES SHALL BE IN ACCORDANCE WITH CITY STANDARDS & SPECIFICATIONS (LATEST EDITION) AND MINISTRY OF ENVIRONMENT (MOE) GUIDELINES (LATEST EDITION).

EDITION,

SERVICE AND AN ARROWS SERVICE AND AND ARROWS SUFFICIENT CANDOOL OF PROCESSION MASS
BE PROVIDED AS PER THE FOLLOWING REQUIREMENTS:

EL HANDAM OF ONE HICK 20X ANDE SAULE BE RESTAULD FOR EVERY 1000-00 OF TRACER WRE;

E. DOE HICK 20X ANDE SAULE BE RESTAULD FOR EVERY 1000-00 OF TRACER WRE;

E. DOE HICK 20X ANDE SAULE BE RESTAULD FOR EVERY COPY.

E. BEDUER, P. LUNG, CAP. JOINT RESTRAINT, COMPAN, E. CONNECTED TO THE FOR PIEC.

C. WATER SERVICE TO BE ZERM DIA. THE K: SOTT COPPER AS PER WM—207.01 OR AS DETAILED.

DEFAULUR EDITION AS PER WM—207.01 AND WM—200.22 TO BE CRAMULAR TO' AS PER FORM

E.O. ALL WALVE BOXES TO BE SET TO PROPOSED GRADES.

COMPACION SECUREMENTS
UNILESS OTHERWISE MOTED OR DIRECTED BY THE GEDICONNICAL CONSULTANT, THE FOLLOWING SHALL
MAIL REDIONE AND BASAFFILL MATTERIAL. ROAD SUB-GRADES AND GENERALLY ALL
MAITERIAL USED FOR LOT GRADING AND FILL SECTIONS, ETC., SHALL BE
COMPACTED TO MIN. 1988 TSP. ALL MATERIAL ASHALL BE LACED IN LAVERS NOT
EXCEEDING 300mm LEFES.
ALL GRADULAR ROAD BASE MATERIALS SHALL BE COMPACTED TO 38% SPD.
C-FOR ALL SERVERS AND WATERMANS IN PILL SECTIONS, THE COMPACTION SHALL
BE CERTIFIED AY GEOTECHACLE MONERER PRIOR TO LANNO 67 PIPE.


SILTATION AND EROSION CONTROL
ASILTATION CONTROL BARRERS SHALL BE PLACED AS DETAILED.
BALL SILTATION CONTROL MEASURES SHALL BE CLEARED AND MAINTAINED AFTER
EACH RAINFALL AS DIRECTED AND 10 THE SATISFACTION OF THE OF CITYTOWN
AND/OR THE CONSERVATION AUTHORITY.
CADDITIONAL SILT CONTROL LOCATIONS MAY BE REQUIRED AS DETERMINED BY THE
ENGINEER, THE CITYTOWN AND/OR THE CONSERVATION AUTHORITY.


RESTORATIONS
A-ALL TRENCH EXCAVATION WITHIN EXISTING ROAD ALLOWANCES SHALL BE
BACKFILLED WITH GRANULAR "A", COMPACTED TO 98& SPD. PAVEMENT
BESTORATION SHALL BE PERFORMED AS PER RO-100.01 & 100.02.
BESTORATION SHALL BE PERFORMED AS PER RO-100.01 & 100.02.
THICK SELECT TOPSOIL BESTORED WITH # HUNGERY SOO OF 100mm MINIMUM
THICK SELECT TOPSOIL BESTORED WITH # HUNGERY SOO OF 100mm MINIMUM
CLEEDING MATERIALS TO BE AS PER FORM 600. COMPACTION TO BE AS PER FORM
901


REMOVALS & ABANDONMENTS

1. COMPLETELY REMOVE ABANDONED SEWER/WATERMAIN WHERE POSSIBLE AND/OR AS DIRECTED BY THE CITY OF HAMILTON. IF MAINS TO BE ABANDONED IN PLACE, FOLLOW GPSS SID.

2. WHERE ABANDONING A WATER SERVICE CONNECTION OR WATERMAIN CONNECTED TO A LIVE MAIN, THE PREFERRED METHOD IS TO REMOVE THE CURB STOP AND STEM, SHUT OFF MAIN STOP AND DISCONNECTION WATER SERVICE AT MAIN STOP.

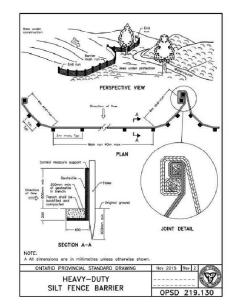

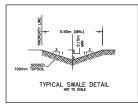

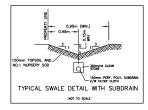



MUNICIPAL ADDRESS						
12 MELBOURNE STREE LEGAL DESCRIPTION	12 MELBOURNE STREET, HAMILTON LEGAL DESCRIPTION					
PART OF LOT 48 &	49 BLOCK G F	REGISTERED				
PLAN 253 IN THE CITY OF HA	PLAN 253 IN THE CITY OF HAMILTON					
	ZONING LOW DENSITY RESIDENTIAL-SMALL LOT (R1a) SECONDARY DWELLING UNIT					
SITE STATISTICS BYLAW PROPOSED						
LOT AREA	270 m²	494.08 m ²				
FRONT YARD SETBACK	4.0 m	7.40				
REAR YARD SETBACK*	7.5 m	12.10 m				
SIDE YARD SETBACK(W)	1.2 m	1.12 m				
SIDE YARD SETBACK(E)	1.2 m	4.32 m				
HEIGHT(PEAK OF ROOF)	6.0 m	6.98 m				

MUNICIPAL ADDRESS

BUILDING HEIGHT TO BE CALCULATED TO DETERMINE A MINIMUM REAR YARD OR A MINIMUM SIDE YARD REQUIREMENT, BUILDING HEIGHT SHALL MEAN THE VERTICAL DISTANCE BETWEEN THE LOWEST THINSHED GRADE ELEVATION ALONG VERTICAL DISTANCE SET OF SUIZ DISTANCE HE WAS ALONG THE BUILDING AND THE HORIZONTAL EXTENSION OF THE UPPERMOST FOINT OF THE BUILDING.


LOWEST PROPOSED GRADE= 96.05

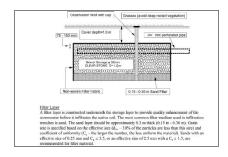

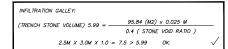

(3.66m WIDE ALLEYWAY)

B L A N C H A R D S T R E E T

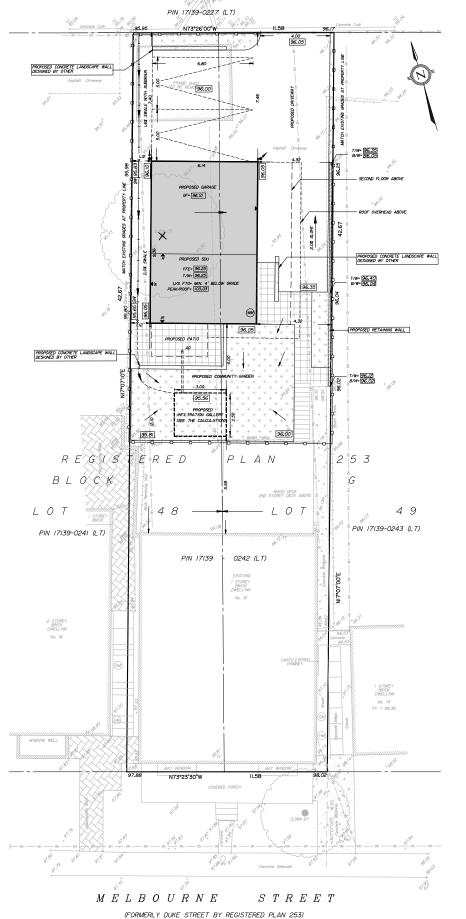

PIN 17/39-0/43 (LT)

g8 05 Centreline of Road g8



ADDRESS: 12 MELBOURNE STREET, HAMILTON

PART OF LOT 48 & 49 BLOCK G REGISTERED PLAN 253 CITY OF HAMILTON

BARICH GRENKIE SURVEYING LTD. A DIVISION OF GEOMAPLE © COPYRIGHT 2025 METRIC

DISTANCES AND CO-ORDINATES SHOWN ON THIS PLAN ARE IN METRES AND CAN BE CONVERTED TO FEET BY DIVIDING BY 0.3048

LEGEND DENOTES DECIDUOUS TREE DENOTES CONIFEROUS TREE DENOTES SERVICE VALVE DENOTES SUBJECT LANDS BOUNDARY DENOTES DEED LINE DENOTES LOT LINE DENOTES LOT LINE

DENOTES FENCE LINE
DENOTES TREE TO BE I

N-E-S-W
DENOTES NORTH FOR DENOTES TREE TO BE REMOVED DENOTES IREE TO BE REMOVED
DENOTES NORTH-EAST-SOUTH-WEST
DENOTES EXISTING ELEVATION
DENOTES PROPOSED ELEVATION
- DENOTES PROPOSED SILT FENCE 100.00 DENOTES WATER METER

B/W T/W SW

SITE GRADING PLAN OF

FFE T/W DENOTES DOWN SPOUT WITH SPLASH PAD
DENOTES PROPOSED FINISH FLOOR ELEVATION
DENOTES PROPOSED TOP OF FOUNDATION WALL—6" ABOVE GRADE
DENOTES PROPOSED UNDERSIDE OF FOOTING ELEVATION
WALL—6" ABOVE GRADE U/S FTG (MIN. 4' BELOW GRADE)
DENOTES PROPOSED PEAK OF ROOF FROM TOP OF FOUNDATION WAL PEAK/ROOF

DENOTES PROPOSED BOTTOM OF RETAINING WALL DENOTES PROPOSED TOP OF RETAINING WALL

FLEVATIONS ARE REFERRED TO THE CANADIAN GEODETIC VERTICAL DATUM

(CGVD-1928:1978) AND ARE DERIVED FROM CITY OF HAMILTON BENCHMARI No. 07720020012 HAVING AN ELEVATION OF 84.543 m.

1	05/20/2	2025	GF	ISSUED A	S PER AR	CHITECT'S	REQUEST
0 05/05/2025 GF		GF	ISSUED FOR REVIEW				
NO.	DATE		BY		REV	ISIONS	
	ESIGN		GF	CHK'D	RH	DATE	
0	RAWN		GF	CHK'D	RH	MAY	20,2025





Barich Grenkie Surveying) Ltd.
PROFESSIONAL EURVEYORS AND ENGINEERS
301 HWY No. 8 (2ND PLODE): STONEY CREEK, ON
(965) 662-6767

CHK BY: MF JOB No. 24-3290

DWN BY: GF

DAVID JESSEAU

PROPOSED SERVICING PLAN 12 MELBOURNE STREET, HAMILTON

SITE AND GRADING PLAN

PROJECT No RAWING No. 24-3290 SGP



June 18, 2025

Committee of Adjustment City of Hamilton 71 Main Street West, 5th Floor Hamilton, Ontario, L8P 4Y5

Re: Application for Minor Variance(s) to 12 Melbourne Street, Hamilton, ON.

To Whom It May Concern,

On behalf of our client, we are pleased to submit this application for Minor Variance for the property mentioned above. The proposed development seeks to introduce a new residential unit within the City of Hamilton, contributing to the ongoing need for increased housing, that is both functional but also sensitive to the existing neighbourhood.

The variances requested are modest in nature and are primarily intended to enhance the livability of the proposed unit—supporting better layouts, improved natural light, and more usable interior and exterior spaces. These adjustments are in keeping with the intent of the Zoning By-law and Official Plan, and we believe they represent a balanced approach to intensification that aligns with the City's goals for sustainable growth.

The following is a list of Zoning Provisions from the Zoning By-law No. 05-200, along with requests for Minor Variance's being made by this application. Please read the following in tandem with the submitted drawings:

Zoning Provision (By-Law No. 05-200)	Requested Variance(s)
4.33.2 d) A minimum 1.2 metre setback shall be provided from the interior Side Lot Line and Rear Lot Line.	Reduce to 0.9 metre setback from Side Lot Line on West Side Lot Line.
4.33.2 h) A maximum height of 6.0 metres shall be permitted.	Increase the permitted height to 7.0m
4.33.2 i) The maximum gross floor area shall not exceed the lesser of 75 square metres or the gross floor area of the principal dwelling.	Increase the maximum maximum gross floor area to 93.0 square metres

5.1 a)v) Unless otherwise regulated in this By-Law, parking spaces and aisles, giving direct access to abutting parking spaces, excluding driveways extending directly from the street, shall be subject to the following: Reduce the setback to parking and width of planting strip to 1.0m from the street line.

- a) Shall not be located within 3.0 metres of a street line
- b) Shall provide a 3.0 metre wide planting strip being required permanently maintained between the street line and the said parking spaces or aisle

We appreciate your consideration of this application and look forward to continuing to work collaboratively with City staff throughout the process.

Yours truly,

Philip Toms, OAA



Committee of Adjustment

City Hall, 5th Floor, 71 Main St. W., Hamilton, ON L8P4Y5

Phone: (905) 546-2424 ext. 4221

Email: cofa@hamilton.ca

APPLICATION FOR A MINOR VARIANCE/PERMISSION

UNDER SECTION 45 OF THE PLANNING ACT

1. APPLICANT INFORMATION

	NAME	MAILING ADDRESS	
Registered Owners(s)	David + Lesley		
	Jessean		
Applicant(s)	Tyler Malone		
Agent or Solicitor	established as class	ity labelled	Phone:
II daneraj - s. o. 1900 -	in are to l	rovided in metric enits (E-mail:
.2 Primary contact	and the production	☑ Applicant	☐ Owner ☐ Agent/Solicitor
.3 Sign should be s	ent to	☑ Applicant	☐ Owner ☐ AgentSolicitor
.4 Request for digital	al copy of sign	☑ Yes* ☐ No	
If YES, provide e	email address where si	gn is to be sent	101
.5 All corresponden	ice may be sent by em	ail ☑ Yes*	□No
(if applicable). O	nly one email address	or the registered owner(s) submitted will result in the respondence will sent by	voiding of this service.
.6 Payment type		☐ In person☐ Cheque	Credit over phone*

2. LOCATION OF SUBJECT LAND

2.1 Complete the applicable sections:

Municipal Address	12 Melbourne Street		
Assessment Roll Number	010091566400000		
Former Municipality	City of Hamilton		
Lot	48 & 49	Concession	
Registered Plan Number	253	Lot(s)	48 & 49
Reference Plan Number (s)		Part(s)	

2.2	Are there any easements or restrictive covenants affecting the subject land?
	☐ Yes ☑ No If YES, describe the easement or covenant and its effect:
3.	PURPOSE OF THE APPLICATION
	ditional sheets can be submitted if there is not sufficient room to answer the following estions. Additional sheets must be clearly labelled
All c etc.)	dimensions in the application form are to be provided in metric units (millimetres, metres, hectares,)
3.1	Nature and extent of relief applied for:
	This application is intending to improve the functionality and livability of a new two bedroom unit, by seeking relief on certain Zoning provisions as highlighted in the Cover Letter.
	☑ Second Dwelling Unit ☐ Reconstruction of Existing Dwelling
3.2	Why it is not possible to comply with the provisions of the By-law?
	The provisions of the By-law limit the ability to create an Additional Dwelling unit that provides a higher quality of livable space.
3.3	Is this an application 45(2) of the Planning Act. ☑ Yes □ No
	If yes, please provide an explanation:
	The application is looking for minor variances, as noted above, related to the provisions

4. DESCRIPTION OF SUBJECT LAND AND SERVICING INFORMATION

4.1 Dimensions of Subject Lands:

Lot Frontage	Lot Depth	Lot Area	Width of Street
11.58m	42 . 67m	494.0m2	9.2m

of Section 4.33.2 of the City of Hamilton Zoning By-Law

	buildings and structur ce from side, rear and		r the subject lands:	
Existing:				
Type of Structure	Front Yard Setback	Rear Yard Setback	Side Yard Setbacks	Date of Construction
Single Detached Dwelling	0.45m	28 . 94m	0.68m (West), 0.68m (East)	01/11/1930
Proposed:				
Type of Structure	Front Yard Setback	Rear Yard Setback	Side Yard Setbacks	Date of Construction
Additional Dwelling Unit - Detached	23.89m	7.35m	1.0m (West), 2.35m (East)	
4.3. Particulars of a sheets if neces Existing:	•	tures on or proposed	for the subject lands (attach additional
Type of Structure	Ground Floor Area	Gross Floor Area	Number of Storeys	Height
Single Detached Dwelling 136.7m2		266.7m2	1 with Basement	4.5m
Proposed:	_	_		
Type of Structure	Ground Floor Area	Gross Floor Area	Number of Storeys	Height
Additional Dwelling Unit - Detached	60m2	93m2	2	6.97m
 4.4 Type of water supply: (check appropriate box) ☑ publicly owned and operated piped water system ☐ privately owned and operated individual well 4.5 Type of storm drainage: (check appropriate boxes) ☑ publicly owned and operated storm sewers ☐ swales 			☐ lake or other ☐ other means ☐ ditches ☐ other means	s (specify)

4.6	rype of sewage disposal proposed: (check appropriate box) ☑ publicly owned and operated sanitary sewage ☐ system privately owned and operated individual ☐ septic system other means (specify)
4.7	Type of access: (check appropriate box) ☐ provincial highway ☐ municipal road, seasonally maintained ☐ municipal road, maintained all year ☐ municipal road, maintained all year
4.8	Proposed use(s) of the subject property (single detached dwelling duplex, retail, factory etc.): Single Detached Dwelling
4.9	Existing uses of abutting properties (single detached dwelling duplex, retail, factory etc.): Single Detached Dwelling
7	HISTORY OF THE SUBJECT LAND
7.1	Date of acquisition of subject lands: Nov 1, 2021
7.2	Previous use(s) of the subject property: (single detached dwelling duplex, retail, factory etc) Single Detached Dwelling
7.3	Existing use(s) of the subject property: (single detached dwelling duplex, retail, factory etc) Single Detached Dwelling
7.4	Length of time the existing uses of the subject property have continued: The property has been rented out since March 2018
7.5	What is the existing official plan designation of the subject land?
	Rural Hamilton Official Plan designation (if applicable): Not Applicable
	Rural Settlement Area: No
	Urban Hamilton Official Plan designation (if applicable) Neighbourhoods
	Please provide an explanation of how the application conforms with the Official Plan. This application does not intend to change the land use
7.6	What is the existing zoning of the subject land? R1a
7.8	Has the owner previously applied for relief in respect of the subject property? (Zoning By-lawAmendment or Minor Variance) ☐ Yes ☑ No
	If yes, please provide the file number: R1a

Planning Act?	□Y	es	✓ No	
If yes, please provide	the file number:			
ADDITIONAL INFO	RMATION			
Number of Dwelling	Units Existing:	2	_	
Number of Dwelling	Units Proposed:	1	_	
Additional Informatio	n (please include	separate sh	eet if needed):	
	its. The intent of	this applicati	ion is to allow f	vith a basement) that or a third dwelling unit

11. COMPLETE APPLICATION REQUIREMENTS 11.1 All Applications Application Fee Site Sketch Complete Application form

	☐ Site Sketch
	Complete Application form
	☐ Signatures Sheet
11.4	Other Information Deemed Necessary
	Cover Letter/Planning Justification Report
	Authorization from Council or Director of Planning and Chief Planner to submit application for Minor Variance
	☐ Minimum Distance Separation Formulae (data sheet available upon request)
	Hydrogeological Assessment
	Septic Assessment
	Archeological Assessment
	☐ Noise Study
	☐ Parking Study