#### **COMMITTEE OF ADJUSTMENT**



City Hall,  $5^{\text{th}}$  floor, 71 Main Street West, Hamilton, ON L8P 4Y5

E-mail: cofa@hamilton.ca

# NOTICE OF PUBLIC HEARING Minor Variance

#### You are receiving this notice because you are either:

- Assessed owner of a property located within 60 metres of the subject property
- Applicant/agent on file, or
- Person likely to be interested in this application

APPLICATION NO.:	SC/A-24:46	SUBJECT PROPERTY:	10 Redhaven Crt., Stoney Creek
ZONE:	R5 (Residential)	ZONING BY-	Zoning By-law former City of
		LAW:	Stoney Creek 3692-92, as Amended

**APPLICANTS:** Owner: D. Danks

Agent: A. Venneri

The following variances are requested:

1. A minimum rear yard setback of 5.5m shall be provided instead of the minimum required rear yard setback of 7.5m

**PURPOSE & EFFECT:** To permit a new one-storey addition in the rear yard of the existing Semi-Detached Dwelling.

#### Notes:

This Notice must be posted by the owner of any land which contains seven or more residential units so that it is visible to all residents.

This application will be heard by the Committee as shown below:

DATE:	Tuesday, April 9, 2024
TIME:	2:45 p.m.
PLACE:	City Hall Council Chambers (71 Main St. W., Hamilton)

For more information on this matter, including access to drawings illustrating this request and other information submitted:

- Visit www.hamilton.ca/committeeofadjustment
- Visit Committee of Adjustment staff at 5th floor City Hall, 71 Main St. W., Hamilton

#### SC/A-24:46

#### **PUBLIC INPUT**

**Written**: If you would like to submit written comments to the Committee of Adjustment you may do so via email or hardcopy. Comments can be submitted by emailing cofa@hamilton.ca or by mailing the Committee of Adjustment, City of Hamilton, 71 Main Street West, 5th Floor, Hamilton, Ontario, L8P 4Y5. Written comments must be received no later than noon **April 5, 2024** 


**Orally**: If you would like to speak to this item at the hearing you may do so by attending in person. Interested members of the public, agents, and owners who wish to participate in person may attend Council Chambers on the date and time listed on the Notice of Public Hearing. Please note, you will be required to provide your name and address for the record. It is advised that you arrive no less than 10 minutes before the time of the Public Hearing.

#### **FURTHER NOTIFICATION**

If you wish to be notified of future Public Hearings, if applicable, regarding SC/A-24:46, you must submit a written request to <a href="mailton.ca">cofa@hamilton.ca</a> or by mailing the Committee of Adjustment, City of Hamilton, 71 Main Street West, 5th Floor, Hamilton, Ontario, L8P 4Y5.


If you wish to be provided a Notice of Decision, you must attend the Public Hearing and file a written request with the Secretary-Treasurer by emailing <a href="mailton.ca">cofa@hamilton.ca</a> or by mailing the Committee of Adjustment, City of Hamilton, 71 Main Street West, 5th Floor, Hamilton, Ontario, L8P 4Y5.



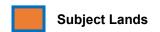

DATED: March 21, 2024

Jamila Sheffield, Secretary-Treasurer Committee of Adjustment Information respecting this application is being collected under the authority of the Planning Act, R.S.O., 1990, c. P. 13. All comments and opinions submitted to the City of Hamilton on this matter, including the name, address, and contact information of persons submitting comments and/or opinions, will become part of the public record and will be made available to the Applicant and the general public, and may include posting electronic versions.

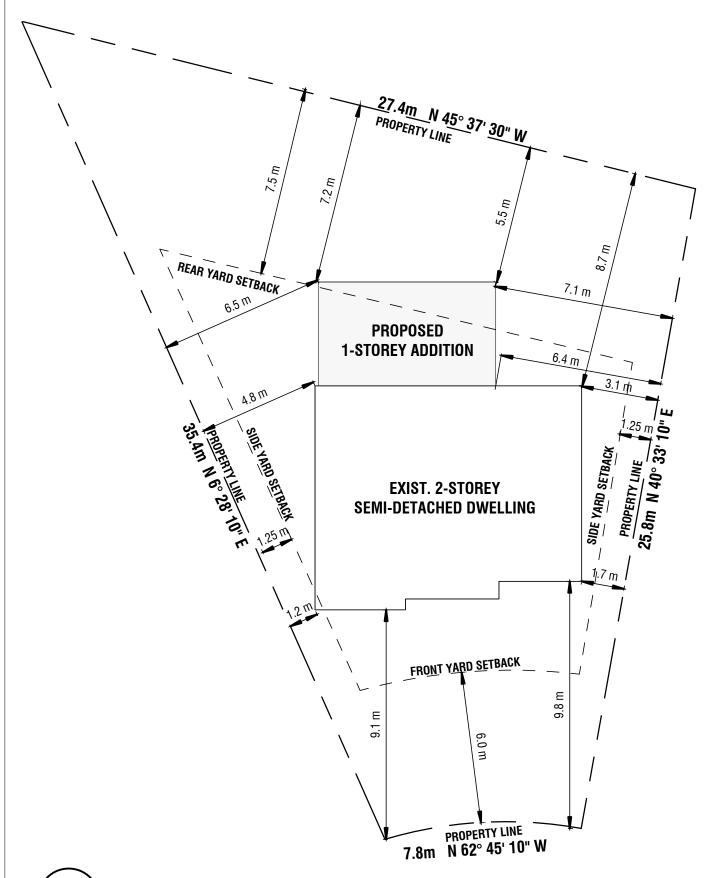

#### PROPOSED REAR ADDITION TO EXISTING DETACHED DWELLING

STATISTICS

10 REDHAVEN COURT, STONEY CREEK ZONED "R5" (CITY OF STONEY CREEK ZONING BY-LAW 3692-92) LOT AREA: 480.23 m<sup>2</sup> (5,169.17 ft<sup>2</sup>)

LOT COVERAGE

AREA: 480.23 m<sup>2</sup> (5,169.17 ft<sup>2</sup>) MAX PERMITTED: 40%

EXISTING AREA: 87.7 m<sup>2</sup> (944 ft<sup>2</sup>) EXISTING COVERAGE: 87.7 m<sup>2</sup> / 480.23 m<sup>2</sup>  $(944 \text{ ft}^2 / 5,169.171 \text{ ft}^2) = 18.3\%$ 

PROPOSED BUILDING AREA: 29.0 m<sup>2</sup> (312 ft<sup>2</sup>) PROPOSED COVÉRAGE: 29.0 m<sup>2</sup> / 480.23 m<sup>2</sup>  $(312 \text{ ft}^2 / 5,169.17 \text{ ft}^2) = 6\%$ 

TOTAL BUILDING AREA: 116.7 m<sup>2</sup> (1256 ft<sup>2</sup>) TOTAL COVERAGE: 116.7 m<sup>2</sup> / 480.23 m<sup>2</sup>  $(1256ft^2 / 5,169.17 ft^2) = 24.3\%$ 

MAX PERMITTED: 11.0 m (36' - 1 5/64") PROPOSED: 4.4 m (14'- 5" ft)

WEST SIDE YARD REQUIRED: 1.25 m (4' - 1 7/32") PROPOSED: 4.8 m (15' - 8 31/32")

EAST SIDE YARD REQUIRED: 1.25 m (4' - 1 7/32") PROPOSED: 6.4 m (21' - 0")

REAR YARD REQUIRED: 7.5 m (24' - 7 9/32") PROPOSED: 5.5 m (18' - 0")

**VARIANCE REQUIRED TO PERMIT A** REAR YARD SETBACK OF 5.5m

**EXISTING HOUSE AREA STATS** EXIST. BASEMENT: 94.79 m<sup>2</sup> (1020.3 ft<sup>2</sup>) EXIST. MAIN FLOOR: 89.45 m<sup>2</sup> (962.8 ft<sup>2</sup>) EXIST. SECOND FLOOR: 98.82 m<sup>2</sup> (1063.7 ft<sup>2</sup>)

PROPOSED ADDITION AREA STATS PROP. ADDITION: 29.0 m<sup>2</sup> (312 ft<sup>2</sup>)



PROJECT NORTH TRUE NORTH

**PROJECT:** 

10 REDHAVEN CT.


A. VENNERI


2024.02.10


PROPOSED SITE **PLAN** 

AS INDICATED

PROPOSED SITE PLAN

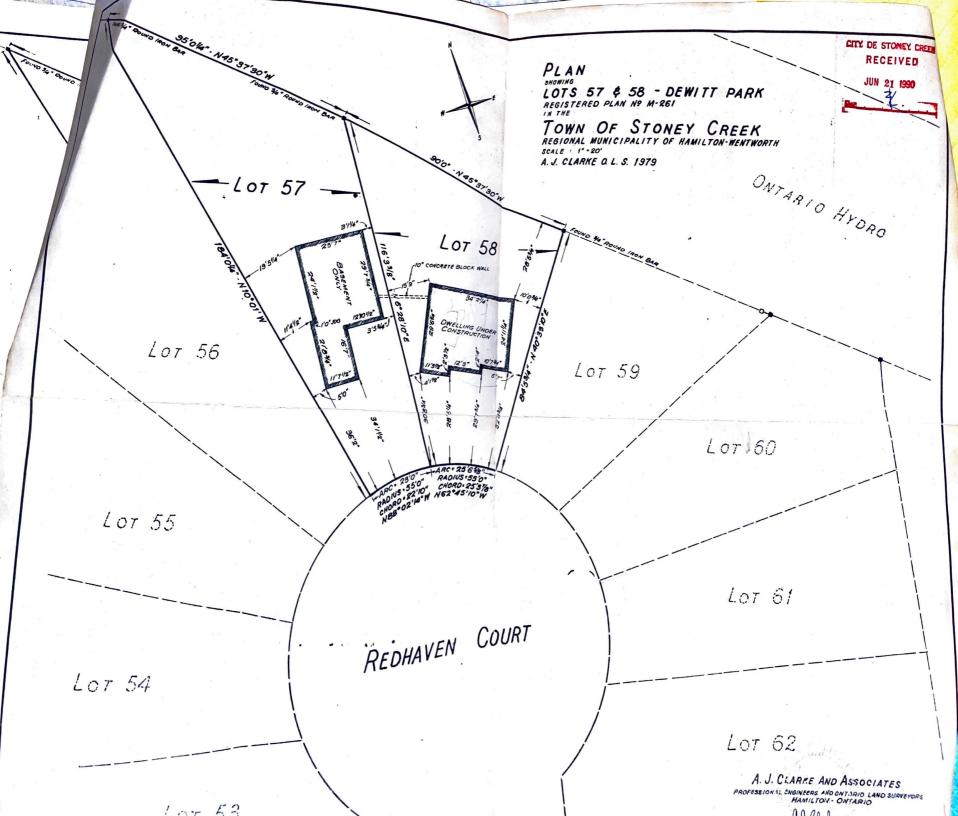


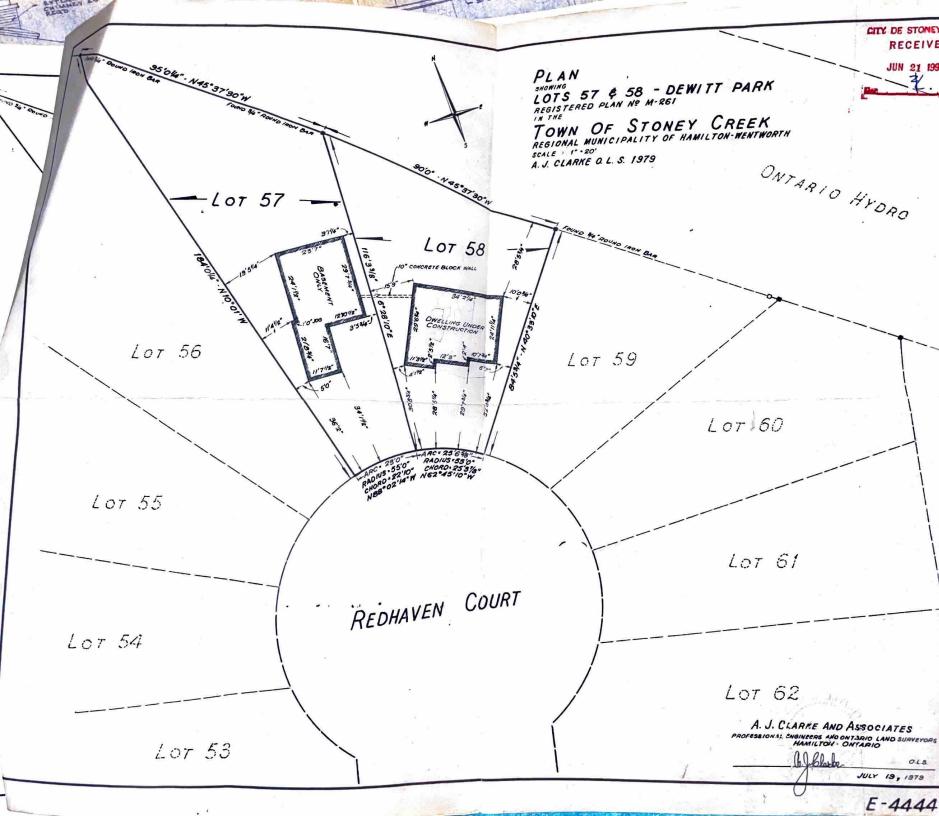

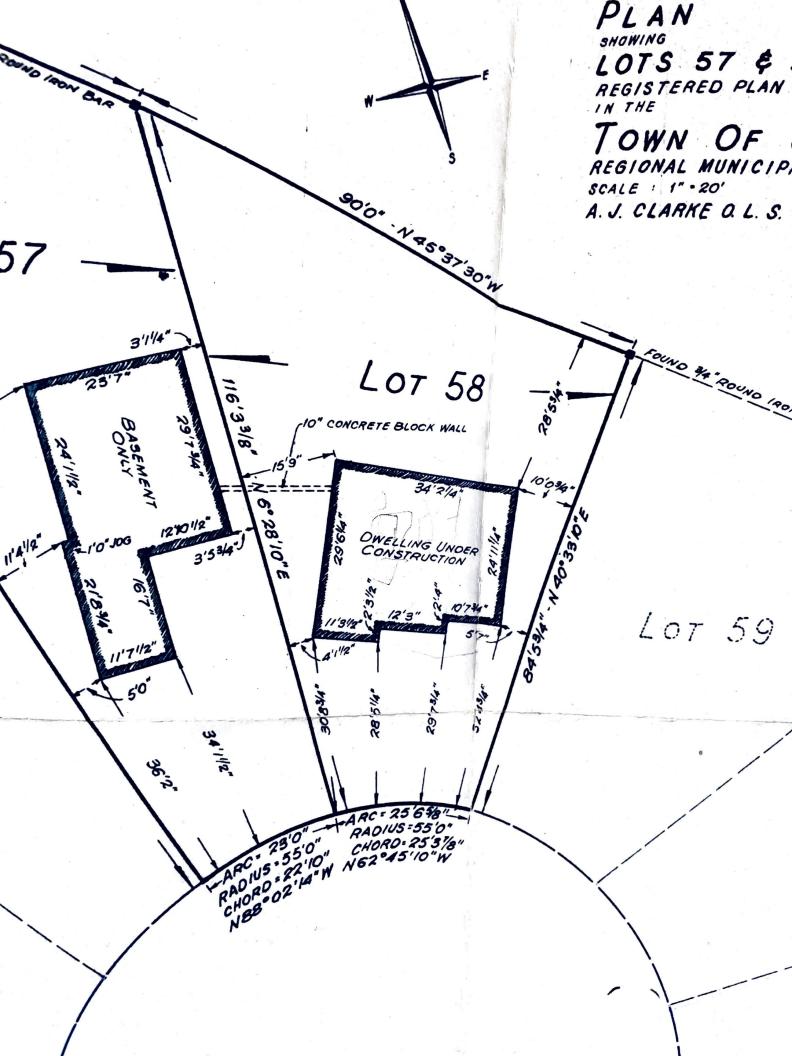

.N45°37'30"W FOUND 44 ROO LOT 58 70.55 116'33/8 10" CONCRETE BLOCK WALL BASEMEN "N 40.33/0" 34'2/4 16.28'10"1 12701/2" OWELLING UNDER CONSTRUCTION 3'53/4') 10' 100 2/844 6 10'734" LOT 04/53/4" 12'3" 11'31/2 11'71/2" 5'0 28,912 36.5° APC 23'0" RADIUS 55'0"
RADIUS 55'0" CHORO 25'3%
RADIUS 22'10" N62°45'10"W
RADIUS 22'14"W N62°45'10"W
RADIUS 22'14"W N62°45'10"W RADIUS : 55'0" CHORD: 25'3%8"

SASEMENT 15,9 34'2/4" N 6° 28'10" E 24'11/2" 29.64 12101/2" OWELLING UNDER CONSTRUCTION 3'5344") 10'73 9 12'3" 3/12 11'71/2" - 50 30'8% 5 38 36.25 ARC = 25 6 48" RADIUS = 55'0" RADIUS: 55'0" 23'0 CHORO 22'10" CHORD : 25'3 1/8" N62°45'10"W NBB-02-14"W N

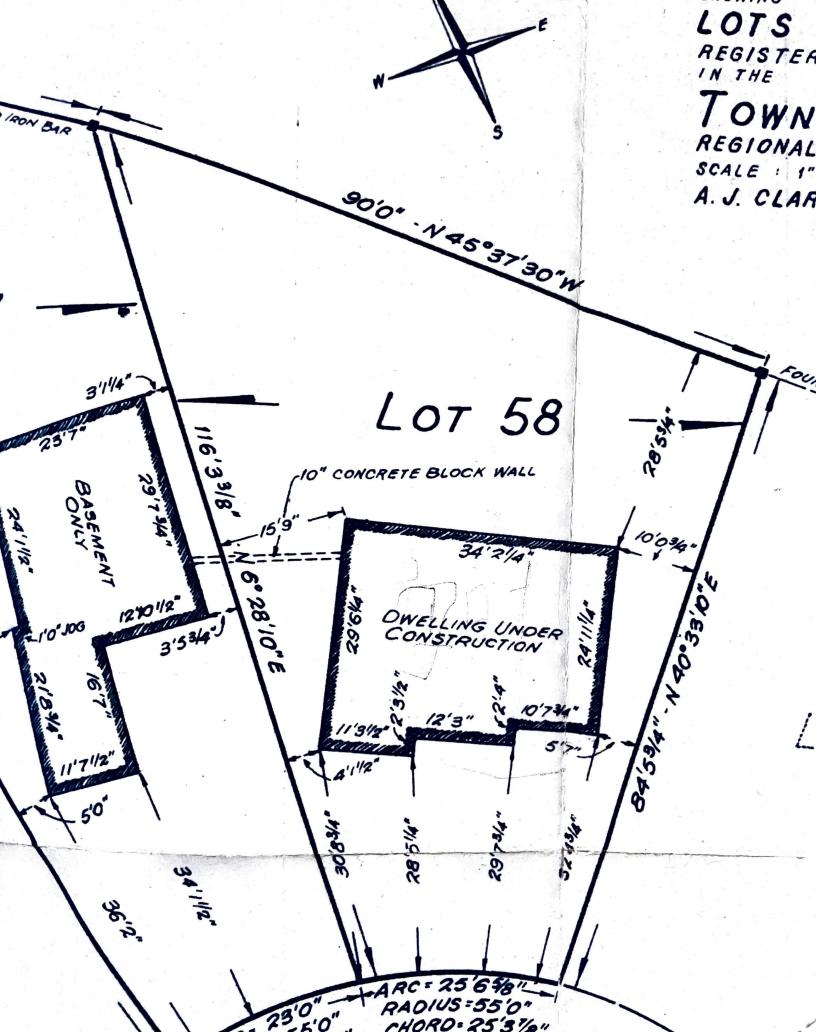



PERSPECTIVE 1







**REAR VIEW** 





DJECT NORTH	TRUE NOR
N	N

# GENERAL NOTES:

1) ALL CONTRACTORS AND/OR TRADES SHALL REVIEW ALL PLANS & REPORT ANY DISCREPANCIES PRIOR TO CONSTRUCTION.
2) DO NOT SCALE DRAWINGS.
3) USE ONLY LATEST REVISED DRAWINGS.
5) DRAWINGS ARE THE PROPERTY OF THE DESIGNER. ANY UNAUTHORIZED USE IS PROHIBITED.

NO.	DATE:	REVISION
1	2023.12.04	EXISTING CONDITIONS

2 2024.01.07 PRELIM DESIGN #1

3 2024.01.18 PRELIM DESIGN #2
4 2024.02.05 STRUCTURAL REVIEW

5 2024.02.10 ISSUED FOR VARIANCE

DRAWING LIST				
SHEET NUMBER	SHEET NAME			
A0	RENDERINGS			
A1	SITE PLAN, SCHEDULES & NOTES			
A2	GENERAL NOTES			
A3	EXISTING FLOOR PLANS			
A4	EXISTING ELEVATIONS - EAST AND NORTH			
A5	EXISTING ELEVATIONS - SOUTH AND WEST			
A6	PROPOSED BASEMENT PLAN			
A7	PROPOSED MAIN FLOOR PLAN			
A8	PROPOSED ELEVATIONS - EAST AND NORTH			
А9	PROPOSED ELEVATIONS - SOUTH AND WEST			
A10	PROPOSED BUILDING SECTION 1			

#### PROJECT

# 10 REDHAVEN CT.

D.L.

2024.02.10


RENDERINGS

AS NOTE

1/11

**A0** 

10 REDHAVEN COURT, STONEY CREEK - PROPOSED REAR ADDITION

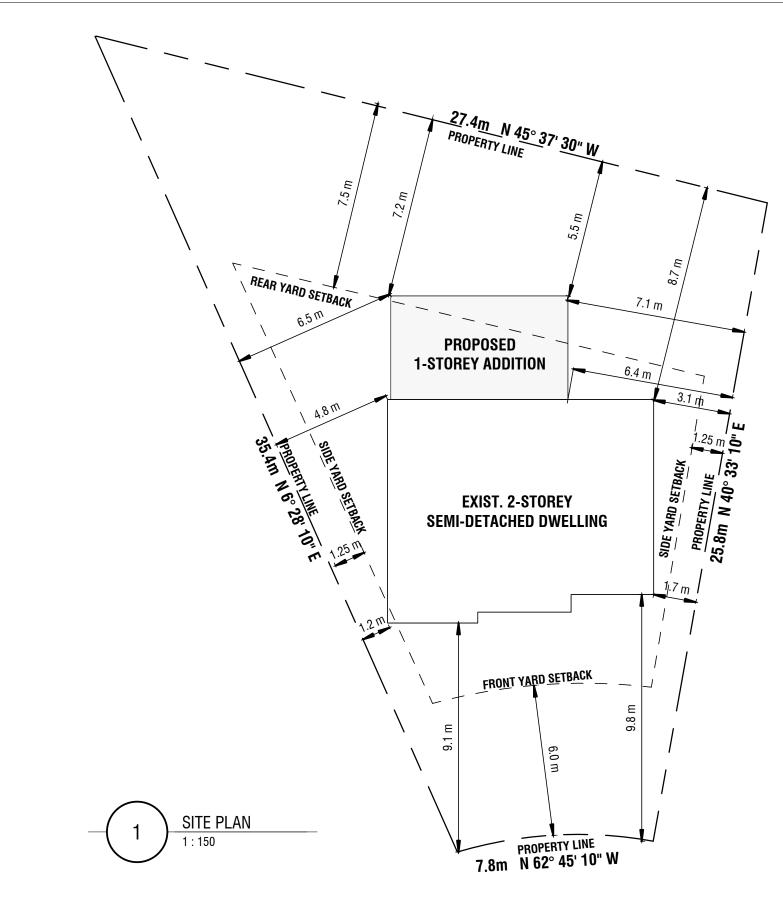

#### PROPOSED REAR ADDITION TO **EXISTING DETACHED DWELLING**

10 REDHAVEN COURT, STONEY CREEK ZONED "R5" (CITY OF STONEY CREEK ZONING BY-LAW 3692-92) LOT AREA: 480.23 m<sup>2</sup> (5,169.17 ft<sup>2</sup>)

# **EXISTING HOUSE AREA STATS**

EXIST. BASEMENT: 94.79 m<sup>2</sup> (1020.3 ft<sup>2</sup>) EXIST. MAIN FLOOR: 89.45 m<sup>2</sup> (962.8 ft<sup>2</sup>) EXIST. SECOND FLOOR: 98.82 m<sup>2</sup> (1063.7 ft<sup>2</sup>)

PROPOSED ADDITION AREA STATS PROP. ADDITION: 29.0 m<sup>2</sup> (312 ft<sup>2</sup>)

A.B. = AIR BARRIER

ALUM. = ALUMINUM

BLKG = BLOCKING

BSMNT = BASEMENT

C.L. = CENTRE-LINE

CONT. = CONTINUOUS

CONC. = CONCRETE

CLG HT = CEILING HEIGHT

CLG TRANS. = CEILING

C/W: COMPLETE WITH

DIA = DIAMETER

E.F. = EXHAUST FAN

DBL PLT = DOUBLE PLATE

D.J. OR DBL JST = DOUBLE JOIST

TRANSITION

DN = DOWN

COV. = COVERED

COL = COLUMN

CANT'L = CANTILEVERED

CATH. CLG = CATHEDRAL CEILING

BTM = BOTTOM

AFF = ABOVE FINISH FLOOR

**LOT COVERAGE** AREA: 480.23 m<sup>2</sup> (5,169.17 ft<sup>2</sup>)

**EXISTING AREA**:

29.0 m<sup>2</sup> (312 ft<sup>2</sup>)

PROPOSED COVERAGE: 29.0 m<sup>2</sup> / 480.23 m<sup>2</sup>

**TOTAL BUILDING AREA**: 116.7 m<sup>2</sup> (1256 ft<sup>2</sup>) TOTAL COVERAGE: 116.7 m<sup>2</sup> / 480.23 m<sup>2</sup>  $(1256ft^2 / 5,169.17 ft^2) = 24.3\%$ 

FD'N = FOUNDATION

FL.=FLUSH

VENTILATOR

INSULATED

CODE

HEADER

MTL = METAL

FTG = FOOTING

F.F. = FINISHED FLOOR

GALV = GALVANIZED

HOR = HORIZONTAL

GWB = GYPSUM WALLBOARD

HSS = HOLLOW STRUCTURAL

HWT = HOT WATER TANK

HRV = HEAT RECOVERY

INSUL. = INSULATION OR

N.T.S. = NOT TO SCALE

LVL = LAMINATED VENEER

O.B.C. = ONTARIO BUILDING

P.E.H. = PRE-ENGINEERED

PRE FIN. = PRE-FINISHED

P.E.B. = PRE-ENGINEERED BEAM

# HEIGHT

MAX PERMITTED: 11.0 m (36' - 1 5/64") PROPOSED: 4.4 m (14'- 5" ft)

**WEST SIDE YARD** REQUIRED: 1.25 m (4' - 1 7/32") PROPOSED: 4.8 m (15' - 8 31/32")


EAST SIDE YARD REQUIRED: 1.25 m (4' - 1 7/32") PROPOSED: 6.4 m (21' - 0")

**REAR YARD** 

REQUIRED: 7.5 m (24' - 7 9/32") PROPOSED: 5.5 m (18' - 0") **VARIANCE REQUIRED TO PERMIT** A REAR YARD SETBACK OF 5.5m


# WALL SCHEDULE

1/2" GYPSUM WALL BOARD

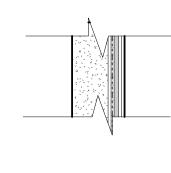


<u>P1 - NEW EXTERIOR SIDING WALL</u> NEW SIDING AS SELECTED BY OWNER VERT. FURRING STRIPS @16" O.C. 1" XPS RIGID INSULATION (MIN. R5 ci DELTA-VENT SA AIR & WATER-RESISTENT BARRIER

OR APPROVED EQUAL (VAPOUR PERMEABLE) 1/2" PLYWOOD SHEATHING 2" x 4" WOOD STUDS @ 16" O.C. c/w 3 1/2" 2LB CLOSED CELL SPRAY FOAM (MIN. R19)

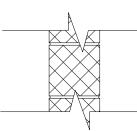


EP1 - EXISTING CONCRETE BLOCK FOUNDATION

**WALL TO REMAIN** 

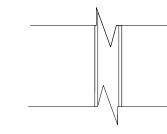


**EP2 - EXISTING INTERIOR WALL TO REMAIN** 

EXIST. GYPSUM WALL BOARD EXIST. WOOD STUDS EXIST. GYPSUM WALL BOARD

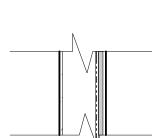

**EP3 - EXISTING EXTERIOR SIDING WALL TO REMAIN** 

EXIST. SIDING EXIST. SHEATHING EXIST. WOOD STUDS EXIST. INSULATION EXIST. GYPSUM WALL BOARD

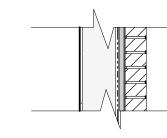


**EP4 - EXISTING EXTERIOR BRICK WALL TO REMAIN** EXIST. BRICK

EXIST. SHEATHING EXIST. WOOD STUDS EXIST. INSULATION

EXIST. GYPSUM WALL BOARD

# **FLOOR SCHEDULE**

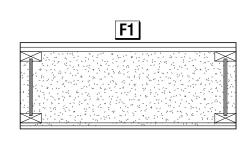

**NEW MAIN FLOOR SYSTEM** 

NEW FLOOR FINISH (T.B.D) NEW 3/4" T&G PLYWOOD GLUED & SCREWED TO NEW 2" x 8" JOISTS @16" O.C. c/w 2LB CLOSED CELL SPRAY FOAM (MIN. R31)

NEW 1/2" P.T. PLYWOOD c/w WRB

**EXISTING MAIN FLOOR SYSTEM** EXIST. FLOOR FINISH EXIST. PLYWOOD

EXIST. 2" x 8" @ 16" O.C. JOISTS

# **ROOF SCHEDULE**

# R1 ROOF TRUSS ASSEMBLY

40 YEAR ASHALT SHINGLES ICE & WATER SHIELD PROTECTIVE MEMBRANE BY W.R. GRACE OR APPROVED EQUAL FROM EDGE OF ROOF EXTENDING A MIN. DISTANCE OF 5' - 0" UP THE ROOF SLOPE TO A LINE NOT LESS THAN 1' - 0" PAST THE INSIDE FACE OF THE EXTERIOR WALL

INSTALL MEMBRANE UP VALLEYS MIN. 1' - 6" UP SLOPE EACH WAY TYP. 1/2" PLYWOOD W/ H-CLIPS

APPROVED ENGINEERED TRUSSES @ 24" O.C. UNVENTED ROOF c/w 2LB CLOSED CELL SPRAY FOAM (MIN. R31) 1/2" GYPSUM BOARD CEILING FINISH

#### ROOF TRUSS NOTES:

Mark

EW3

EW5

EW6

EW7

EW11

EW12

EW13

EW14

EW15

EW16

EW17

EW18

W2

WIDTH

24"

28"

44"

44"

40"

40"

56'

22 1/2"

36"

22 1/2"

22 1/2"

WINDOWS IN ACCORDANCE W/ OBC 9.7

BE PROVIDED WITH:

USE OF TOOLS, AND

14"

14"

66"

66"

34"

56"

56"

48"

44"

44"

72"

72"

46 1/2"

46 1/2"

NOTE: CONTRACTOR TO CONFIRM FRAME MATERIAL AND SIZES.

MAX. SILL HEIGHT OF 3' - 3" (1000mm) ABOVE FLOOR.

SHALL APPLY TO THE OPENABLE PORTION OF THE WINDOW.

TRANSPARENT OPENINGS IN WINDOW IN ACCORDANCE W/ OBC 9.7.2.3.

THE REQUIREMENTS FOR RESISTANCE TO FORCED ENTRY (OBC 9.7.5.3)

46 1/2"

CONTRACTOR TO CHECK AND VERIFY ALL TRUSS INFORMATION INCLUDING BUT NOT LIMITED TO PITCH, OVERHANGS, HEEL HEIGHT AND SPACING & PRIOR TO

CONTRACTOR TO REPORT ANY DISCREPANCIES TO THE DESIGNER PRIOR TO FABRICATION OF THE TRUSSES.

TRUSS CONFIGURATION INFORMATION SHOWN IN IHE BUILDING SECTION IS NOT TO BE USED FOR CONSTRUCTION AS IT IS PROVIDED FOR CONTEXT ONLY. PRE-ENGINEERED WOOD ROOF TRUSSES TO BE DESIGNED & ENGINEERED BY TRUSS

WINDOW SCHEDULE

EXISTING TO BE REMOVED

EXISTING TO BE REMOVED

EXISTING TO REMAIN

1. EXCEPT WHERE A DOOR ON THE SAME FLOOR LEVEL AS THE BEFROOM PROVIDES DIRECT

• EACH SUCH WINDOW SHALL PROVIDE AN INDIVIDUAL AN UNOBSTRUCTED OPEN

2. EXCEPT FOR BASEMENT AREAS, THE WINDOW DESCRIBED IN SENTENCE 1. SHALL HAVE A

3. WHEN SLIDING WINDOWS ARE USED, THE MIN. DIMENSION DESCRIBED IN SENTENCE 1.

4. 5% OF FLOOR AREA OF BEDROOMS AND 10% OF LIVING AND DINING ROOMS TO EQUAL

5. WINDOWS LOCATED WITHIN 6' - 7" (2m) OF ADJACENT GROUND LEVEL SHALL CONFORM TO

ACCESS TO THE EXTERIOR, EVERY FLOOR LEVEL CONTAINING A BEDROOM IN A SUITE SHALL

• AT LEAST 1 OUTSIDE WINDOW THAT CAN BE OPENED FROM THE INSIDE WITHOUT THE

PORTION HAVING A MIN. AREA OF 3.8 s.f. (0.35m<sup>2</sup>) WITH NO DIMENSION LESS THAN 15"

PROPOSED SIDE WINDOW

PROPOSED REAR WINDOW

PROPOSED REAR WINDOW

PROPOSED SKYLIGHT BY VELUX OR SIMILAR

PROPOSED SKYLIGHT BY VELUX OR SIMILAR

COMMENTS

TRUSS SHOP DRAWINGS MUST BE SEALED BY P.ENG (PEO) AND SUBMITTED TO DESIGNER FOR REVIEW PRIOR TO FABRICATION.

#### ENERGY EFFICIENCY COMPLIANCE DESIGN

**USING TABLE 3.1.1.11** THERMAL PERFORMACE REQUIREMENTS FOR ADDITIONS TO EXISTING BUILDINGS (ZONE 1) COMPLIANCE PACKAGE <u>ADDITIONS</u> **CEILING WITH ATTIC SPACE: R60** 

CEILING WITHOUT ATTICE SPACE: R31 • EXPOSED FLOOR: R31 WALLS ABOVE GRADE: R19+5ci BASEMENT WALLS: R20 ci OR R12+10ci | • ENTIRE SLAB: R10 • EDGE OF SLAB: R10 WINDOWS & SLIDING GLASS DOORS: max U-VALUE 0.28

RATIO OF WINDOWS, SKYLIGHTS & GLASS AREA OF WALLS: 2810 sq.ft AREA OF WINDOWS, SKYLIGHTS & GLASS: 270 sq.ft RATIO (%): 9.6%

ITEM

ED2

ED4

ED5

ED6

ED7

ED8

ED9

ED12

ED13

ED14

ED15

ED16

ED18

ED19

SIZES SELECTED.

WIDTH

4' - 7"

2' - 8"

2' - 8"

2' - 8"

2' - 8"

6' - 4"

2' - 8"

2' - 8"

9' - 0"

2' - 2"

2' - 8"

2' - 8"

5' - 0"

2' - 8"

5' - 0"

2' - 8"

2' - 8"

1' - 10"

2' - 8"

5' - 2"

2' - 8"

6' - 4"

DOORS IN ACCORDANCE W/ OBC 9.7

# EXISTING WALL ASSEMBLY TO BE REMOVED SOLID SAWN WOOD COLUMN (SEE STRUCTURAL MEMBERS SCHEDULES) ASSEMBLY ABOVE DIMENSION FROM CENTRE LINE(S) OF STRUCTURAL CENTRE LINE OF HORIZONTAL STRUCTURAL MEMBEF POINT LOAD FROM ABOVE INTERCONNECTED SMOKE ALARM WITH A VISUAL EXHAUST FAN TO VENT DIRECTLY TO EXTERIOR

COMMENTS

36" EXTERIOR DOOR w/ 16" SIDELITE

EXISTING TO REMAIN

EXISTING TO REMAIN EXISTING TO REMAIN

EXISTING TO REMAIN

EXISTING TO REMAIN

EXISTING TO REMAIN

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EXISTING TO REMAIN

EXISTING TO REMAIN

EXISTING TO REMAIN

EXISTING TO REMAIN

**EXISTING TO REMAIN** 

EXISTING TO BE REMOVED

FLOOR DRAIN

DOOR SCHEDULE

6' - 10"

6' - 6"

6' - 4"

6' - 4"

6' - 0"

5' - 10"

6' - 10"

6' - 8"

7' - 0"

6' - 11"

6' - 8"

6' - 8"

6' - 8"

6' - 8"

6' - 8"

6' - 8"

6' - 8"

6' - 7"

6' - 8"

6' - 8"

7' - 6"

NOTES: ACTUAL DOOR SIZES AND DOOR MATERIALS SELECTED MAY VARY FROM

REFER TO FLOOR PLANS AND ELEVATIONS FOR ROUGH OPENING DIMENSIONS.

• DOORS TO BE RESISTANT TO FORCED ENTRY IN CONFORMANCE TO OBC 9.7.5.2

SCHEDULE. CONTRACTOR SHALL CONFIRM ACTUAL SIZES. CONTRACTOR SHALL CONFIRM

CONTRACTOR SHALL CONFIRM ROUGH OPENING SIZES ARE SUITABLE FOR ACTUAL DOOR

WITH OWNER ACTUAL DOOR MATERIAL, DOOR STYLE, AND GLASS DESIGN SELECTIONS.

6' - 10"

SPOT ELEVATION

SYMBOLS & LINE TYPES LEGEND

**VENNERI** DESIGN STUDIO



PROJECT NORTH TRUE NORTH

# **GENERAL NOTES**

1) ALL CONTRACTORS AND/OR TRADES SHALL REVIEW ALL PLANS & REPORT ANY DISCREPANCIES PRIOR TO CONSTRUCTION. 2) DO NOT SCALE DRAWINGS. 3) USE ONLY LATEST REVISED DRAWINGS 5) DRAWINGS ARE THE PROPERTY OF THE DESIGNER. ANY UNAUTHORIZED USE IS PROHIBITED.

NO. DATE: REVISION 1 2023.12.04 EXISTING CONDITIONS

2 | 2024.01.07 | PRELIM DESIGN #1

3 |2024.01.18 | PRELIM DESIGN #2 4 | 2024.02.05 | STRUCTURAL REVIEW

5 |2024.02.10 | ISSUED FOR VARIANCE

#### **DRAWING LIST** SHEET NUMBER SHEET NAME A0 RENDERINGS A1 SITE PLAN, SCHEDULES & A2 GENERAL NOTES EXISTING FLOOR PLANS **EXISTING ELEVATIONS - EAST** AND NORTH A5 EXISTING ELEVATIONS - SOUTH AND WEST A6 PROPOSED BASEMENT PLAN PROPOSED MAIN FLOOR PLAN PROPOSED ELEVATIONS - EAST AND NORTH

PROPOSED ELEVATIONS -

SOUTH AND WEST

# STRUCTURAL MEMBERS SCHEDULES

NOT ALL MEMBERS LISTED ARE USED ON THIS BUILDING. REFER TO PLANS TO DETERMINE LOCATION, LENGTHS, AND QUANTITY OF SPECIFIED MEMBERS. MEMBERS SPECIFIED ARE SIZED TO MINIMUM OBC / DESIGN REQUIREMENTS. ANY CHANGE IN SPECIES / GRADE MUST BE REVIEWED BY THE DESIGNER. CONTRACTOR SHALL NOT SUBSTITUTE WITH SMALLER MEMBERS WITH ADDITIONAL PLYS UNLESS REVIEWED BY THE DESIGNER.

# **WOOD LINTEL SCHEDULE**

2-PLY WOOD MEMBERS: 3-PLY WOOD MEMBERS: **WL-1**: 2 - 2" x 6" **WL-5**: 3 - 2" x 6" **WL-2**: 2 - 2" x 8" **WL-6**: 3 - 2" x 8" **WL-3**: 2 - 2" x 10" **WL-7**: 3 - 2" x 10" **WL-4**: 2 - 2" x 12" **WL-8**: 3 - 2" x 12"

TOTAL EAST ADDITION WALL AREA: 13 m<sup>2</sup> (140 sq.ft.) GLAZED AREA PROVIDED: 1.7 m<sup>2</sup> (18 sq.ft.)

PROPOSED WEST ELEVATION- USING INDIVIDUAL **PORTIONS WITH A SKEWED PROPERTY LINE** UNPROTECTED OPENINGS - OBC 9.10.15.4

TOTAL WEST WALL AREA: 69.7 m<sup>2</sup> (750 sq.ft.) MAX AGG. AREA PERMITTED: 18% TOTAL WEST ADDITION WALL AREA: 13 m<sup>2</sup> (140 sq.ft.) GLAZED AREA PERMITTED: 2.3 m<sup>2</sup> (25.2sq.ft.) GLAZED AREA PROVIDED: 2.1 m<sup>2</sup> (22 sq.ft.)

<u>LINTEL NOTES:</u>

WOOD LINTEL WITH SPANS LESS THAN 9' -10" (3m) REQUIRE 11/2" (38mm) MIN. BEARING LENGTH AT EACH END. SPANS GREATER THAN 9' - 10" REQUIRE A MIN. 3" (16nm) BEARING LENGTH.

WHERE NOTED, LINTELS MUST BEAR UPON ENTIRE WIDTH OF BUILT-UP COLUMNS INDICATED WITH ADDITONAL TRIMMER STUD FASTENED TO COLUMN AS PER TYPICAL ROUGH OPENING FRAMING.

#### **RADON GAS MITIGATION NOTE:**

NEW CONSTRUCTION SHALL COMPLY WITH 9.13.4. SOIL GAS CONTROL IN THE FORM OF 15 MIL POLYETHYLENE VAPOUR BARRIER UNDER THE CONC. FLOOR SLAB, LAPPED NOT LESS THAN 300mm, c/w SEALING ALONG THE PERIMETER OF THE SLAB AND ALL PENETRATIONS USING FLEXIBLE SEALANT

#### WOOD COLUMN SCHEDULE **LAMINATED VENEER LUMBER** (LVL) SCHEDULE

**BUILT-UP WOOD MEMBERS: LVL-1**: 2 - 1 3/4" x 5 1/4" **LVL-2**: 2 - 1 3/4" x 9 1/4" **LVL-3**: 3 - 1 3/4" x 9 1/2" **LVL-4**: 2 - 1 3/4" x 11 7/8" **LVL-5**: 3 - 1 3/4" x 11 7/8" **LVL-6**: 5 - 1 3/4" x 11 7/8"

COLUMN

WHERE COLUMNS ARE NOT LOCATED IN A LOAD BEARING WALL THEY SHALL BE CENTERED ON PAD FOOTINGS BELOW.

**HELICAL PILE SCHEDULE** 

(MIN. 6'-0" BELOW GRADE)

H1 - 23/8"Ø GOLIATHTECH HELICAL PILE PROVIDE MIN. COMPRESSIVE RESISTANCE FORCE OF 4500lbs w/ 500 LBS-FT OF APPLIED TORQUE. PROVIDE SADDLE TO EXTEND TO U/S OF BEAM

H2 - 2<sup>3/8</sup> GOLIATHTECH HELICAL PILE

PROVIDE MIN. COMPRESS/VE RESISTANCE FORCE OF 6750lbs w/ 1250 LBS-FT OF APPLIED TORQUE. PROVIDE SADDLE TO EXTEND TO U/S OF BEAM (MIN. 6'-0" BELOW GRADE)

H3 - 2<sup>3/8</sup>"Ø GOLIATHTECH HELICAL PILE

PROVIDE MIN. COMPRESS/VE RESISTANCE FORCE OF 9000lbs w/ 2000 LBS-FT OF APPLIED TORQUE. PROVIDE SADDLE TO EXTEND TO U/S OF BEAM (MIN. 6'-0" BELOW GRADE)

HELICAL PILES SHALL BE INSTALLED TO APPROPRIATE DEPTH BASED ON SUITABLE BEARING STRATUM CORRESPONDING TORQUE IN ACCORDANCE w/ GOLIATHTECH SPECIFICATIONS.

ABOVE GROUND HEIGHT OF ALL HELICAL PILES ARE < 0.3m UNLESS OTHERWISE NOTED

A10 PROPOSED BUILDING SECTION 1

PROJECT:

10 REDHAVEN CT


2024.02.10

SITE PLAN, **SCHEDULES &** NOTES

AS NOTED

2/11

**A1** 

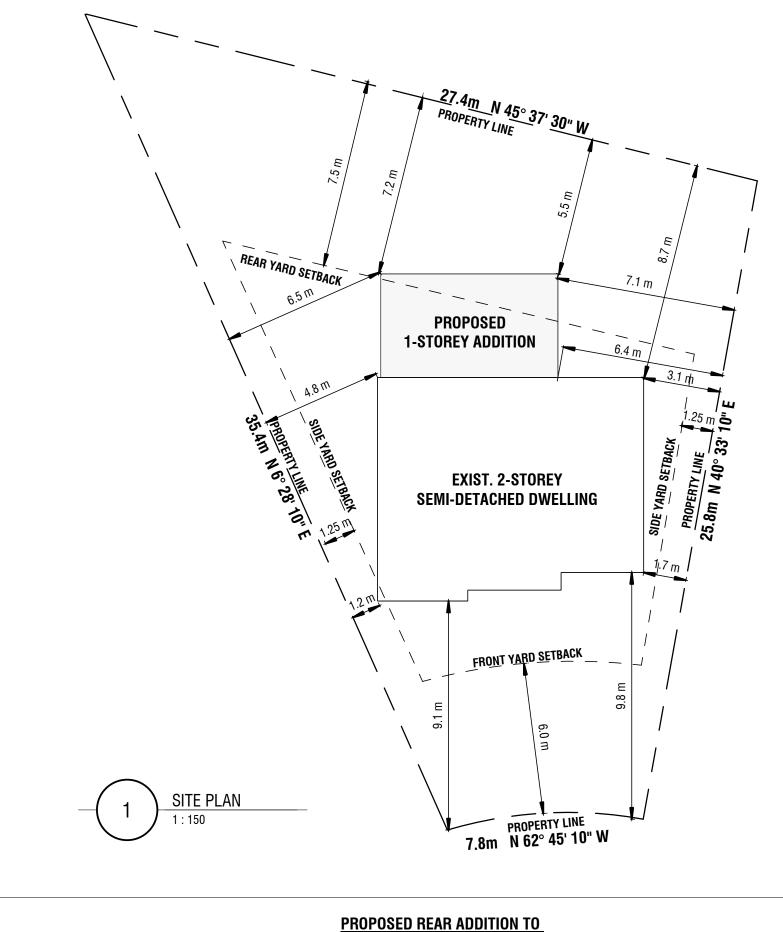

# **STATISTICS**

MAX PERMITTED: 40%

87.7 m<sup>2</sup> (944 ft<sup>2</sup>) **EXISTING COVERAGE:** 87.7 m<sup>2</sup> / 480.23 m<sup>2</sup>

PROPOSED BUILDING AREA:

 $(312 \text{ ft}^2 / 5,169.17 \text{ ft}^2) = 6\%$ 

 $(944 \text{ ft}^2 / 5,169.171 \text{ ft}^2) = 18.3\%$ 

**LIST OF TYPICAL ABBREVIATIONS:** 

P.T. = PRESSURE TREATED

P.L. = POINT LOAD ABOVE

RI = RIGID INSULATION

REINF. = REINFORCED

R.O. = ROUGH OPENING

STL BM = STEEL BEAM

SOG = SLAB ON GRADE

SQ. FT = SQUARE FEET

UNEX. = UNEXCAVATED

UNFIN. = UNFINISHED

U.N.O. = UNLESS NOTED

V.B. = VAPOUR BARRIER

W.W.M. = WELDED WIRE

VERT = VERTICAL

T.J. OR TRPL JST = TRIPLE

TYP. = TYPICAL

OTHERWISE

WD. = WOOD

MESH

S.C.L = STRUCTURAL

REQ"D = REQUIRED

RFTR = RAFTER

COMPOSITE

LUMBER

R = RISER

**EXPOSING BUILDING FACE CALCULATIONS** 

<u>Proposed rear elevation</u> UNPROTECTED OPENINGS - OBC 9.10.15.4 PROP. LIMITING DISTANCE: 5.5 m TOTAL NORTH WALL AREA: 67.8 m<sup>2</sup> (665 sq.ft.)

GLAZED AREA PERMITTED: 12.2m<sup>2</sup> (120 sq.ft.)

MAX AGG. AREA PERMITTED: 18%

GLAZED AREA PROVIDED: 10.2 m<sup>2</sup> (110 sq.ft.) PROPOSED <u>east elevation - Using individual</u> **PORTIONS WITH A SKEWED PROPERTY LINE** 

UNPROTECTED OPENINGS - OBC 9.10.15.4 PROP. LIMITING DISTANCE: 6.4 m TOTAL EAST WALL AREA: 69.7 m<sup>2</sup> (750 sq.ft.) MAX AGG. AREA PERMITTED: 34% GLAZED AREA PERMITTED: 4.4 m<sup>2</sup> (47.6 sq.ft.)

PROP. LIMITING DISTANCE: 4.8 m

**WOOD BEAM SCHEDULE BUILT-UP WOOD MEMBERS: WB-1**: 2 - 2" x 8"

**LVL-7**: 2 - 1 3/4" x 14"

**LVL-8**: 3 - 1 3/4" x 14"

**LVL-9**: 2 - 1 3/4" x 16"

**LVL-10**: 3 - 1 3/4" x 16"

**WB-2**: 3 - 2" x 8" **WB-3**: 4 - 2" x 8" **WB-4**: 2 - 2" x 10" **WB-5**: 3 - 2" x 10" **WB-6**: 4 - 2" x 10" **WB-7**: 2 - 2" x 12"

**WB-8**: 3 - 2" x 12"

**BUILT-UP WOOD POSTS: WP-1**: 2 - 2" x 4" **WP-5**: 2 - 2" x 6"

**WP-2**: 3 - 2" x 4" **WP-6**: 3 - 2" x 6" **WP-3**: 4 - 2" x 4" **WP-7**: 4 - 2" x 6" **WP-4**: 5 - 2" x 4" **WP-8**: 5 - 2" x 6"

STEEL COLUMN SCHEDULE **SP-1:** 3 1/2" dia. HSS STEEL

**COLUMN NOTES:** 

STEEL BEAM SCHEDULE **SB-1**: W8 x 40

#### **GENERAL REQUIREMENTS**

ALL CONSTRUCTION SHALL BE IN CONFORMANCE WITH THE LATEST ONTARIO BUILDING CODE, LATEST APPLICABLE REGULATIONS, AND GOOD CONSTRUCTION PRACTICES.

AVOID SCALING DIRECTLY FROM THE DRAWINGS.

REPORT ANY DISCREPANCIES TO THE DESIGNER IMMEDIATELY. CONTRACTOR SHALL FIELD VERIFY ALL DIMENSIONS PRIOR TO ORDERING OR INSTALLING MATERIALS. FAILURE TO ADHERE TO THIS PROCEDURE SHALL PLACE FULL RESPONSIBILITY FOR ANY ERRORS DIRECTLY UPON THE CONTRACTOR. BUILDING CONTRACTOR/HOMEOWNER TO REVIEW AND VERIFY ALL DIMENSIONS, SPECS, AND CONNECTIONS BEFORE CONSTRUCTION. ANY CHANGE THROUGH THE DISREGARDING OF THIS NOTICE TO BE THE RESPONSIBILITY OF THE CONTRACTOR.

#### SITE WORK / GRADING NOTES

CONTRACTOR TO VERIFY ALL EXISTING GRADES AND ALL FINISHED GRADES ON SITE.

SUB-SOIL CONDITIONS MAY REQUIRE INVESTIGATION & ARE BEYOND THE SCOPE OF THESE DRAWINGS.

ALL SURFACE DRAINAGE TO CONFORM TO OBC 9.14.6.

ROOF DRAINS & DOWNSPOUTS AS PER OBC 9.26.18

PROVIDE ONE DOWNSPOUT FOR EVERY 30M (100ft) RUN OF GUTTER.

SLOPE ALL FINISHED GRADES AWAY FROM BUILDING WITH A MIN. 6" DROP FOR EVERY 6' - 0" DISTANCE, AND ENSURE PROPER POSITIVE SURFACE DRAINAGE AND WILL NOT AFFECT ADJACENT PROPERTIES.

RADON GAS MITIGATION: NEW CONSTRUCTION SHALL COMPLY WITH 9.13.4. SOIL GAS CONTROL IN THE FORM OF 15 MIL POLYETHYLENE VAPOUR BARRIER UNDER THE CONC. FLOOR SLAB. LAPPED NOT LESS THAN 300mm. c/w SEALING ALONG THE PERIMETER OF THE SLAB AND ALL PENETRATIONS USING FLEXIBLE SEALANT.

EXCAVATE FOR FOUNDATIONS AND BUILDING SERVICES TO DEPTHS REQUIRED TO ALLOW FOR PROPER PLACEMENT OF THE WORK. EXCAVATIONS TO BE KEPT FREE FROM STANDING WATER.

FOOTINGS TO HAVE A 4" WEEPING DIA. WEEPING TILE, 6" CRUSHED STONE WRAPPED w/ GEOTEXTILE OVER AND AROUND ALL FOOTINGS, INCLUDING GARAGE FOOTINGS & TO BE DRAINED TO A SEWER, DRAINAGE DITCH OR DRY WELL BY GRAVITY DRAINAGE OR BY PUMPING.

AFTER THE CONSTRUCTION OF FOOTINGS, PITS, WALLS OR PIERS, BACKFILLALL EXCAVATIONS WITH EXISTING APPROVED GRANULAR MATERIALS TO WITHIN 5" OF UNDERSIDE OF CONCRETE SLAB AND WITHIN 6" OF UNDERSIDE OF NEW EXTERIOR FINISHED GRADES.

#### **CONCRETE / FOUNDATION NOTES**

ALL FOUNDATIONS HAVE BEEN DESIGNED WITH AN ASSUMED SOIL BEARING CAPACITY OF 75 KPA. THE DESIGNER IS TO BE NOTIFIED BY THE CONTRACTOR IF THE BEARING PRESSURE CANNOT BE ACHIEVED.

ALL FOUNDATION WORK THAT DOES NOT COMPLY TO PART 9 OF THE OBC IS TO BE ENGINEERED, SIGNED AND SEALED BY A STRUCTURAL ENGINEER.

CONTRACTOR TO CONFIRM LOCATION AND DEPTH OF ALL FOUNDATION WALL STEP DOWNS ON SITE.

FOUNDATION WALLS TO BE 10" POURED CONC. WALLS (25MPa), REINFORCED WITH 15M @16"VERTICAL BARS AT INTERIOR FACE, WHERE BACKFILL HEIGHT MEASURED FROM TOP OF THE BASEMENT SLAB EXCEEDS 7'-7". (ALTERNATIVELY 10" CONC. BLOCK WALLS, REINFORCED WITH 15M @16" VERTICAL BARS, WHERE BACKFILL HEIGHT MEASURED FROM TOP OF THE BASEMENT SLAB EXCEEDS 5'-11".

FOUNDATIONS WALLS TO EXTEND UP MINIMUM 6" ABOVE FINISHED GRADE.

DOWEL NEW FOUND. WALL TO THE EXIST. FOUND WALL W/10M-32" LONG @24" c/c -4" EMBEDMENT, TYP.

ALL EXTERIOR WALL STRIP FOOTINGS TO HAVE MIN. 6" PROJECTION FROM THE FOUNDATION WALL AND TO BE MIN. 6" THICK, REINFORCED W/ 2-15M, CONT.

ALL FOOTINGS TO BE MIN. 48" BELOW FINISHED GRADE.

INSTALL 15M DOWELS (10"Hx30"V) SPACED AT 16" FOR FOOTING -FOUNDATION WALL CONNECTION.

CONNECT NEW AND EXIST. FOOTING AT THE SAME ELEVATION. DOWEL NEW FOOTING TO THE EXIST. FOOTING W/2-10M-32"LG, 8" EMBEDMENT. TYP.

PROVIDE A CAPILLARY BREAK MEMBRANE (DELTA FOOTING BARRIER OR APPROVED EQUAL) BETWEEN FOOTING & FOUNDATION CONNECTION & PROVIDE PARGING COVE AT FOOTING JOINT

FOOTINGS TO HAVE A MAX. 24" VERTICAL RISE BETWEEEN HORIZONTAL PORTIONS AND A MIN. 24" HORIZONTAL DISTANCE B/W VERTICAL RISERS

BASEMENT SLAB ON GRADE TO BE MIN. 4" THICK . REINFORCED WITH FIBRES. OR WELDED WIRE MESH WWM6X6xW2.9/W2.9. SAW CUT AT 15'-0" MAX. EACH WAY.

EXTERIOR STAIR SLAB ON GRADE TO BE MIN. 5" THICK, REINFORCED WITH FIBRES, OR WELDED WIRE MESH WWM6X6xW2.9/W2.9. SAW CUT AT 15'-0" MAX. EACH WAY.

NOTES:

A. PUMP MIX SLUMPS SHALL ALSO CONFORM TO THE ABOVE.

STONE CONCRETE WITH A UNIT WEIGHT OF 23.6 kN/m3

- B. WATER CEMENTING MATERIALS RATIOS FOR EXPOSURE CLASSES SHALL BE AS PER CAN3-A23.1.
- C. AIR CONTENTS FOR EXPOSURE CLASSES AND AGGREGATE SIZES SHALL BE AS PER CAN3-A23.1. D. SLUMP TOLERANCES SHALL BE  $\pm 20$ mm FOR SLUMPS LESS THAN 80mm, AND  $\pm 30$ mm OTHER- WISE.
- ALL BOTTOM EDGES OF EXPOSED SLABS AND BEAMS, AND ALL EXPOSED COLUMN AND WALL EDGES SHALL
- BE BEVELED 20 x 20. ALL TOP EDGES OF EXPOSED SLABS, BEAMS, UPSTANDS AND STAIRS SHALL BE TOOLED, UNLESS NOTED
- OTHERWISE. SEE ALSO ARCHITECTURAL DRAWINGS AND SPECIFICATIONS. NO CALCIUM CHLORIDE. IN ANY FORM. IS PERMITTED IN ANY CONCRETE MIX
- CURING AND PROTECTION OF CONCRETE FOR HOT, COLD OR DRY WEATHER SHALL BE IN ACCORDANCE WITH

CSA-A23.1.

CEMENT SHALL BE PORTLAND CEMENT TYPE 10 - UNLESS NOTED OTHERWISE. CONCRETE SHALL BE

CONCRETE PROPERTIES				
	MIN. 28 DAY	SLUMP	MAX. AGG.	<b>EXPOSURE</b>
ELEMENT	STRENGTH (MPa)	(mm)	SIZE (mm)	CLASS
	,	( /	( )	
FOOTING	25	80	40	N
EXTERIOR SLAB ON GRADE	30	70	20	C-2
INTERIOR SLAB ON GRADE	30	70	20	N
FOUNDATION WALLS	25	80	20	F-1
MASONRY GROUT	20	150	10	

#### <u>MASONRY</u>

REDUCTION OF FOUNDATION WALL THICKNESS TO ALLOW BRICK FACING TO CONFORM WITH OBC 9.15.4.7. C/W BRICK TIED TO FOUNDATION IN REDUCED SECTION WITH METAL TIES @ 8" O.C. VERTICAL & 36" O.C. HORIZONTAL & FILL AIRSPACE OF REDUCED SECTION W/ MORTAR

MASONRY SUPPORTING BEAMS & COLUMNS SHALL CONFORM TO ARTICLE 9.20.8.4

PROVIDE WEEPHOLES SPACED NOT MORE THAN 800MM (2'-7") APART IN MASONRY VENEER WALLS AS REQUIRED IN 9.20.13.8

PROVIDE ALL FLASHING AS PER SUBSECTION. 9.20.13 OF O.B.C.

PROVIDE DRIP EDGE AT WINDOW SILLS AS PER ARTICLE 9.20.13.12.

MASONRY FIREPLACES SHALL CONFONM TO SECTION 9.22

### <u>Steel</u>

ALL STEEL BEAMS REQUIRE MINIMUM 3 1/2" BEARING AND STEEL ANGLE LINTELS REQUIRE MINIMUM 6" BEARING. PROVIDE 7 1/2" SOLID MASONRY UNDER BEAMS OR COLUMNS.


ALL STEEL COLUMNS, STEEL BEAMS AND STEEL ANGLE LINTELS TO BE SHOP PRIMED WITH ONE COAT OF RUST-INHIBITIVE PAINT.

STEEL ANGLE LINTEL SCHEDULE - REFER TO LINTEL SCHEDULE

	MUM ALLOWAB SUPPORTING N			LINTELS
	MINIMUM ANGLE SIZE ,mm (inch)		90mm (3 1/2")	100mm (4")
	(LONG LEG VERTICAL)		BRICK	STONE
L-1	L90x90x6	2.59m	2.47m	2.30m
	(L 3 ½"x3 ½"x¼")	(8'-6")	(8'-1")	(7'-9")
L-2	L100x90x6	2.79m	2.66m	2.48m
	(L 4"x3½"x¼")	(9'-2")	(8'-9")	(8'-2")
L-3	L125x90x8	3.47m	3.31m	3.08m
	(L 5"x3 ½"x5 <sub>16</sub> ")	(11'-5")	(10'-10")	(10'-1")
L-4	L125x90x10	3.64m	3.48m	3.24m
	(L 5"x3 ½"x38")	(11'-11")	(11'-5")	(10'-8")
L-5	L125x90x13	3.82m	3.59m	3.33m
	(L 5"x3 ½"x½")	(12'-7")	(11'-9")	(10'-11")
L-6	L150x90x10	4.06m	3.82m	3.54m
	(L 6"x3 ½"x38")	(13'-4")	(12'-7")	(11'-8")
L-7	L150x90x13	4.32m	4.07m	3.77m
	(L 6"x3 ½"x½")	(14'-2")	(13'-5")	(12'-5")
L-8	L150x100x13	4.37m	4.12m	3.82m
	(L 6"x4"x1 <sub>2</sub> ")	(14'-4")	(13'-6")	(12'-7")
L-9	L180x100x10	4.57m	4.30m	3.99m
	(L 7"x4"x <sup>3</sup> <sub>8</sub> ")	(15'-0")	(14'-1")	(13'-1")
L-10	L180x100x13	4.87m	4.59m	4.25m
	(L 7"x4"x1 <sub>2</sub> ")	(16'-0")	(15'-1")	(14'-0")

#### PLYWOOD SHEATHING NOTES

- 1. SHEATHING SHALL BE EXTERIOR TYPE PLYWOOD CONFORMING TO CSA 0121-M1978, "DOUGLAS FIR PLYWOOD" OR CSA 0151-M1978, "CANADIAN SOFTWOOD PLYWOOD
- 2. ALL SHEATHING IS TO BE TONGUED-AND-GROOVED.
- 3. PLYWOOD SHEATHING SHALL BE INSTALLED WITH THE SURFACE GRAIN AT RIGHT ANGELS TO THE FRAMING AND WITH THE END JOINTS STAGGERED.
- 4. LAYOUT PLYWOOD STAGGERED JOINT PATTERN SUCH THAT PLYWOOD SHEET IS AT LEAST TWO SPAN CONTINUOUS WHERE POSSIBLE.
- 5. ALL END JOINTS MUST BE POSITIONED ALONG CENTRE LINE OF SUPPORT.
- 6. PLYWOOD SHEATHING SHALL BE INSTALLED WITH AT LEAST 3/32" GAP BETWEEN SHEETS.
- 7. FASTENERS SHALL BE SPIRAL OR RING THREAD NAILS 2" LONG MINIMUM, UNLESS NOTED OTHERWISE.
- 8. UNLESS NOTED OTHERWISE, PLYWOOD SHEATHING SHALL BE NAILED TO SUPPORTS AT 6" MAXIMUM ALONG EDGES AND 10"MAXIMUM ALONG INTERMEDIATE SUPPORTS.

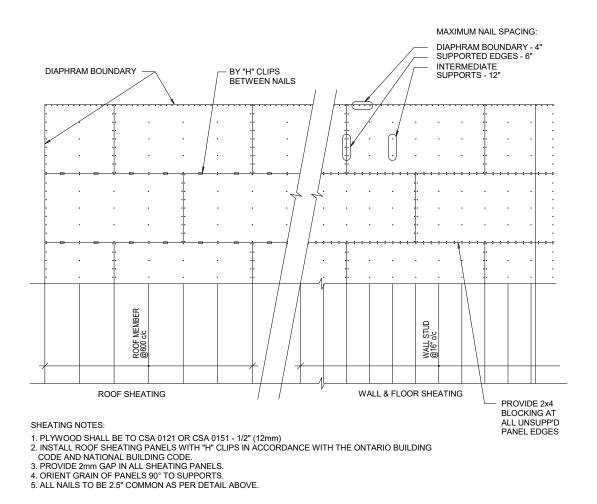

#### TYPICAL SHEATING NAILING PATTERN

#### WOOD FRAME CONSTRUCTION

WOOD CONSTRUCTION SHALL CONFORM TO CSA STANDARD 086 AND TO THE REQUIREMENTS OF THE ONTARIO BUILDING CODE

#### LUMBER:

UNLESS OTHERWISE NOTED, TO BE SPF SPECIES, GRADE No.2 CONFIRMING TO CSA STANDARD 0141 WITH MAXIMUM MOISTURE CONTENT OF 15% AT THE TIME OF INSTALLATION. LUMBER SHALL BEAR THE GRADING STAMP OF AN AGENCY APPROVED BY THE CANADIAN LUMBER STANDARDS ADMINISTRATION BOARD.

#### NAILS, SPIKES AND STAPLES:

O CSA STANDARD B111, GALVANIZED FOR EXTERIOR WORK, OR HIGHLY HUMID AREAS AND FOR TREATED LUMBER, PLAIN ELESWHERE. NAILING OF FRAMING UNLESS OTHERWISE NOTED. SHALL CONFORM TO TABLES 9.23.3 A&B IN THE ONTARIO BUILDING CODE.

#### METAL CONNECTORS AND ROUGH HARDWARE:

BOLTS, NUTS, WASHERS, LAGS, PINS, SCREWS, ALL TO BE HOT DIP GALVANIZED.

#### WOOD PRESERVATIVE:

WHERE REQUIRED, TO CONFORM TO CSA STANDARD 080.0 CSA.

#### FRAMING ANCHORS:

FRAMING ANCHORS, JOIST HANGERS, BEAM HANGERS, POST CAPS, POST ANCHORS, BACK-UP CLIPS AND ANGLES, UNLESS OTHERWISE SHOWN ON THE DRAWINGS, ARE ALL TO BE AS MANUFACTURED BY SIMPSON CONNECTORS OR AN APPROVED EQUAL, SIZED TO THE JOB AT HAND. ALL ARE TO BE INSTALLED IN STRICT ACCORDANCE WITH THE MANUFACTURE'S INSTRUCTIONS UTILIZING "SPECIAL" NAILS WHERE REQUIRED.

2" x 6" P.T. SILL PLATE c/w SILL GASKET ANCHORED TO FOUNDATION WALL WITH 1/2" DIA. x 12" LONG GALV. STEEL ANCHOR BOLTS @ 48" O.C. USE NON-SHRINK GROUT TO LEVEL SILL PLATE WHEN REQUIRED

STUDS TO BE OF SIZE AND SPACING AS NOTED ON THE DRAWINGS. PROVIDE, UNLESS OTHERWISE NOTED, A MINIMUM OF TWO (2) STUDS AT CORNERS, INTERSECTIONS AND EACH SIDE OF THE OPENINGS. ALL STUDS TO BE CONTINUOUS FOR FULL STOREY HEIGHT WITH NO SPLICE. MID HEIGHT BLOCKING FOR ALL STUDS UNLESS NOTED ON DRAWINGS. PROVIDE MINIMUM TWO (2) TOP PLATES FOR LAOD BEARING WALLS. PLATES TO BE LAPPED OR TIED AT CORNERS AND INTERSECTIONS. NON-LOAD BEARING STUD WALLS TO CONFORM TO THE REQUIREMENTS OF THE ONTARIO BUILDING CODE.

#### FLOOR AND ROOF TRUSSES/JOISTS:

PROVIDE TRUSSES/JOISTS OF SIZE, SPACING AND SPAN AS NOTED ON THE DRAWING, UNLESS OTHERWISE NOTED, WHERE TRUSSES/JOISTS FRAME INTO THE SIDE OF A WOOD BEAM, PROVIDE APPROPRIATE HANGERS, NAILED TO THE SIDE OF THE BEAM. PROVIDE DOUBLE JOIST UNDER PARTITION WALLS PARALLEL TO JOISTS (SEE ARCHITECTURAL DRAWINGS FOR LOCATIONS).

ALL CEILING OR FLOOR OPENINGS TO HAVE DOUBLE TRIMMER AND HEADER JOISTS.

#### BRIDGING OR BLOCKING:

PROVIDE CROSS BRIDGING OR SOLID BLOCKING OR APPROVED PROPRIETARY METAL STRAPS IN ACCORDANCE WITH THE ONTARIO BUILDING CODE. SPACING TO BE AT THE END AND AT 2100mm (7'-0") MAXIMUM CENTRES UNLESS JOIST SPAN IS WITHIN 450mm (18") OF THE MAXIMUM SPAN PERMITTED BY THE ONTARIO BUILDING CODE, IN WHICH CASE, BRIDGING OR BLOCKING SHALL BE AT MAXIMUM 1370mm (4'-6") CENTRE.

NOTCHING AND DRILLING ONLY ALLOWED WITHIN THE LIMITATIONS SET OUT IN THE ONTARIO BUILDING CODE.

REMOVE AND REPLACE ANY DEFECTIVE MATERIALS WHEREVER FOUND PRIOR TO FINAL ACCEPTANCE OF THE WORK.

CONTRACTOR SHALL BRACE ALL CONSTRUCTION TEMPORARILY UNTIL ROOF AND FLOOR SHEATHING AND OTHER PERMANENT BRACING ARE IN PLACE.

ALL TIMBER CONNECTION SHALL BE IN ACCORDANCE WITH THE REFERENCE STANDARD AND WITH GOOD CARPENTRY PRACTICE

ALL STEEL ANGLES OR PLATES SHALL CONFORM TO G40.21 M300W

ALL BOLTS SHALL BE A307 BOLTS. PROVIDE STANDARD WASHERS AT TIMBER SURFACE

ALL WOOD IN CONTACT WITH CONCRETE OR THAT IS LESS THAN 150MM (6") ABOVE GROUND OR SLAB SHALL BE PRESSURE TREATED OR SEPARATED WITH 0.05MM POLYETHYLENE FILM OR TYPE S ROLL ROOFING AS PER OBC 9.17 .4.3

### **ROOFING**

ROOF EAVE TO BE FINISHED WITH PRE FINISHED ALUMINUM EAVESTROUGHS, FASCIA AND VENTED SOFFIT. PROVIDE ONE PRE FINISHED ALUMINUM DOWN SPOUT FOR EACH 30' RUN OF EAVESTROUGH OR PART THEREOF AROUND THE PERIMETER OF THE

CONNECT DOWNSPOUTS TO THE STORM SEWER SYSTEM OR ONTO GRADE WITH PRE CAST CONCRETE SPLASH PADS TO PREVENT EROSION.

ROOF SPACE VENTILATION: TO BE 1/300 OF INSULATED AREA FOR ROOF SLOPES GREATER THAN 2 IN 12 AND 1/150 OF INSULATED AREA FOR ROOF SLOPES LESS THAN 2 IN 12 OR ANY ROOF WHERE AN INTERIOR FINISH IS APPLIED TO THE UNDERSIDE OF THE ROOF RAFTERS. NOT MORE THAN HALF OF THE REQUIRED VENTILATION AREA IS TO BE PROVIDED NEAR THE RIDGE EXCEPT FOR CATHEDRAL CEILINGS AND ROOFS WHERE CONTINUOUS RIDGE AND EAVE VENTILATION IS REQUIRED. ALL VENTILATION OPENINGS TO BE PROTECTED FROM THE WEATHER AND INSECTS. VENTS TO BE CONSTRUCTED OF RUST PROOF MATERIAL

EAVE PROTECTION: ICE & WATER SHIELD PROTECTIVE MEMBRANE BY W.R. GRACE OR APPROVED EQUAL . APPLY MEMBRANE OVER PLYWOOD SHEATHING, FROM EDGE OF ROOF EXTENDING A MIN. DISTANCE OF 5' - 0" UP THE ROOF SLOPE TO A LINE NOT LESS THAN 1' - 0" PAST THE INSIDE FACE OF THE EXTERIOR WALL. INSTALL MEMBRANE UP VALLEYS MIN. 1' - 6" UP SLOPE EACH WAY.

#### INTERIOR FINISHES

RENDERINGS ARE NOT TO SCALE; ALL RENDERINGS ARE FOR ARTISTIC DEPICTION ONLY. PLAN UPDATES MAY NOT BE REFLECTED IN RENDERINGS. RENDERINGS SHALL NOT BE USED FOR CONSTRUCTION.

FINAL FINISHES SHALL BE CONFIRMED WITH THE HOME OWNER PRIOR TO APPLICATION.

ALL FLOORS IN RESIDENTIAL OCCUPANCIES TO BE FINISHED & OR WATER RESISTANT AS PER 9.30.1.1. & 9.30.1.2 & ALL WALL TILE FINISH TO COMPLY TO SUBSECTION 9.29.10

ALL GYPSUM WALL BOARD & INSTALLATION TO COMPLY WITH SUBSECTION 9.29.5.

ALL GLASS SHOWER STALLS & BATH ENCLOSURES WILL CONFORM TO ARTICLE 9.6.6.5. - SAFETY GLASS FOR SHOWER STALLS.

WALLS WITH TILE FINISHES SHALL CONFORM SUBSECTION 9.29.10 'WALL TILE FINISH" & ALL DRYWALL FINISHES SHALL COMPLY WITH SUBSECTION 9.29.5. FOR "GYPSUM BOARD FINISH" (TAPED JOINTS)

ROOMS & SPACES SHALL CONFORM TO SECTIONS 9.5. & 9.7.

WATERPROOF FINISH SHALL BE PROVIDED ON WATER RESISTANT BACKING. AROUND SHOWERED & BATHTUBS AS PER ARTICLES 9.29.2.2. & 9.29.10.4

FLAME SPREAD RATING OR INTERIOR FINISHES SHALL NOT EXCEED 150





PROJECT NORTH TRUE NORTH

#### **GENERAL NOTES:**

1) ALL CONTRACTORS AND/OR TRADES SHALL REVIEW ALL PLANS & REPORT ANY DISCREPANCIES PRIOR TO CONSTRUCTION. 2) DO NOT SCALE DRAWINGS. 3) USE ONLY LATEST REVISED DRAWINGS. 5) DRAWINGS ARE THE PROPERTY OF THE DESIGNER. ANY UNAUTHORIZED USE IS PROHIBITED.

NO. DATE: REVISION 1 | 2023.12.04 | EXISTING CONDITIONS

2 | 2024.01.07 | PRELIM DESIGN #1

4 | 2024.02.05 | STRUCTURAL REVIEW

5 | 2024.02.10 | ISSUED FOR VARIANCE

3 |2024.01.18 | PRELIM DESIGN #2

	DRAWING LIST	
SHEET NUMBER	SHEET NAME	
A0	RENDERINGS	
1	SITE PLAN, SCHEDULES & NOTES	
A2	GENERAL NOTES	
A3	EXISTING FLOOR PLANS	
	EXISTING ELEVATIONS - EAST AND NORTH	
	EXISTING ELEVATIONS - SOUTH AND WEST	
A6	PROPOSED BASEMENT PLAN	
A7	PROPOSED MAIN FLOOR PLAN	
	PROPOSED ELEVATIONS - EAST AND NORTH	
	PROPOSED ELEVATIONS - SOUTH AND WEST	
A10	PROPOSED BUILDING SECTION 1	

PROJECT:


# 10 REDHAVEN CT

S. ANTKOWIAK

2024.02.10

**GENERAL NOTES** 

AS NOTED

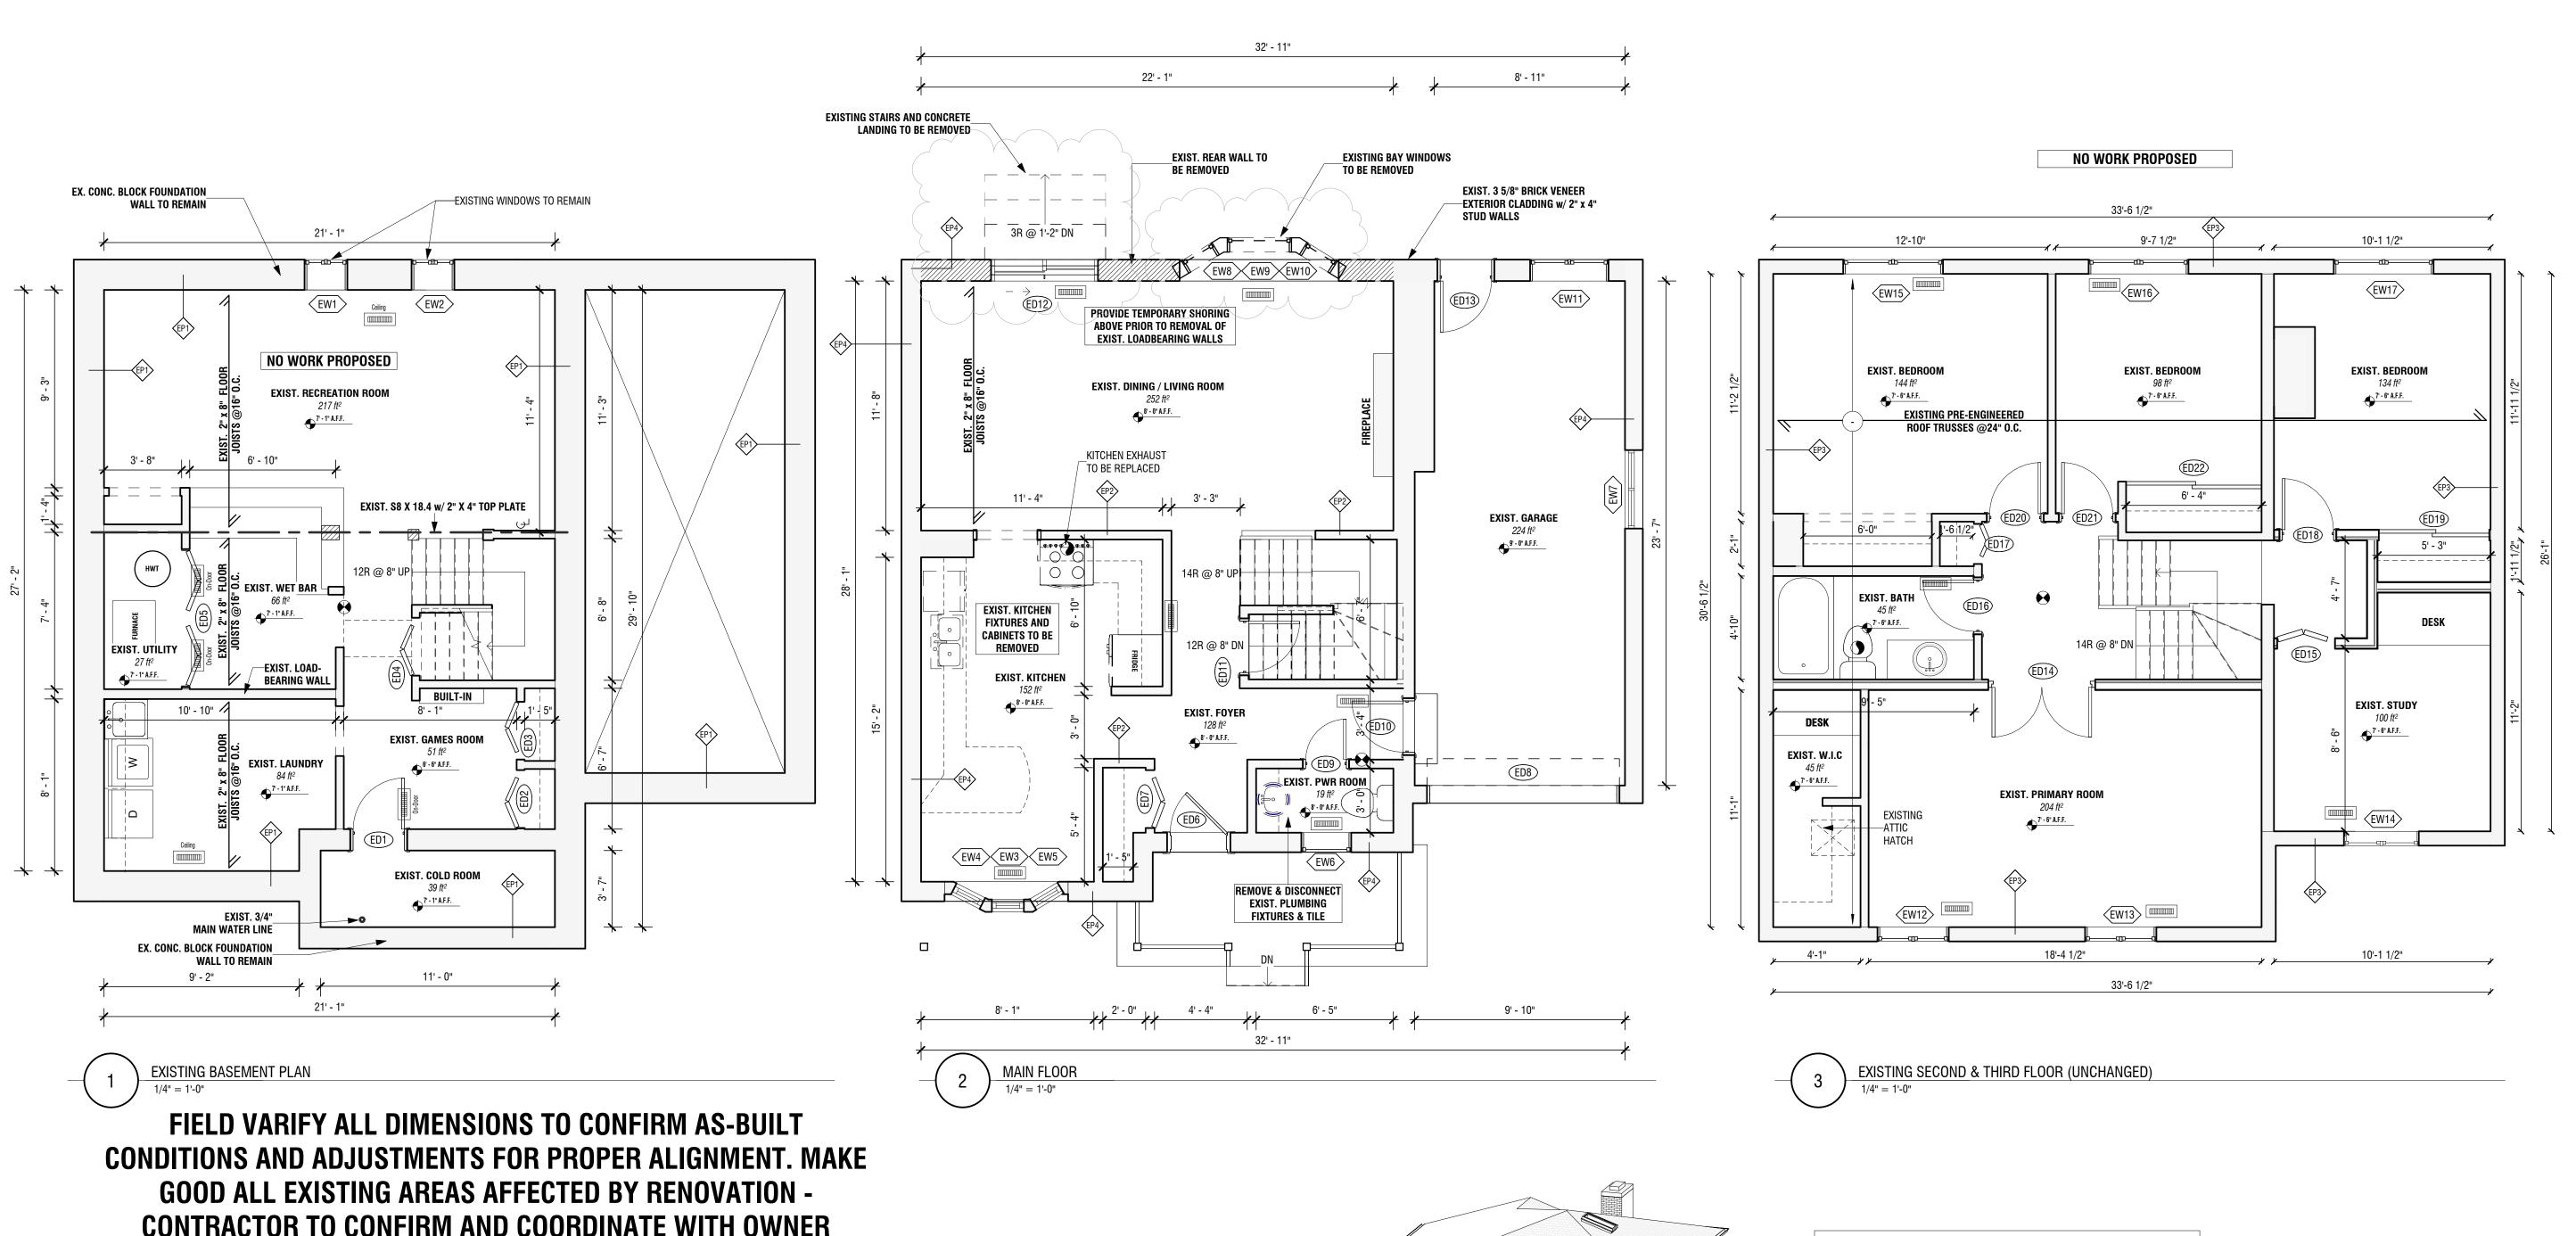



CONTRACTOR TO CONFIRM AND COORDINATE WITH OWNER MATERIAL/FINISHES TO BE SALVAGED AND/OR RESTORED PRIOR TO DEMOLITION.


# **CONFIRM EXIST. STRUCTURE W.R.T. SIZE, SPACING AND** DIRECTION PRIOR TO COMMENCING DEMOLITION THROUGH MINIMALLY DISRUPTIVE INVESTIGATION

#### **GENERAL DEMOLITION NOTES**

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- CONTRACTOR TO BE RESPONSIBLE FOR ANY DEDUCTIONS OR CONCLUSIONS MADE ON THE BASIS OF THIS INFORMATION AND THAT OF ANY ADDITIONAL SITE INSPECTIONS IF MADE.

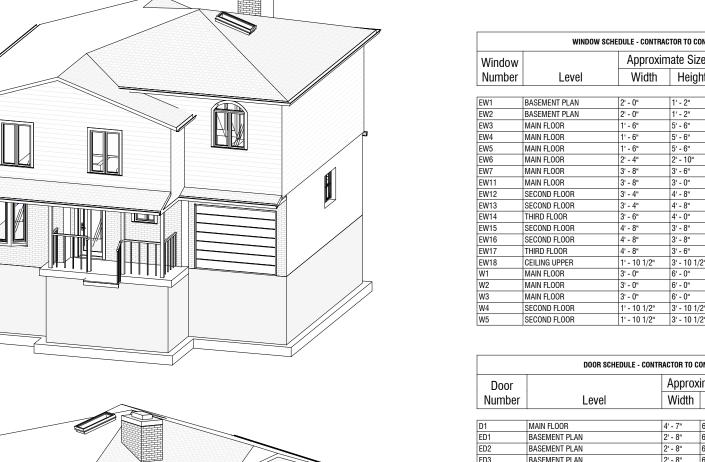

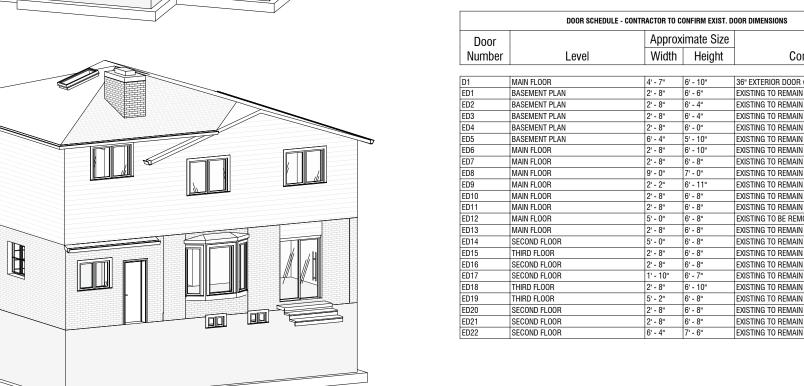

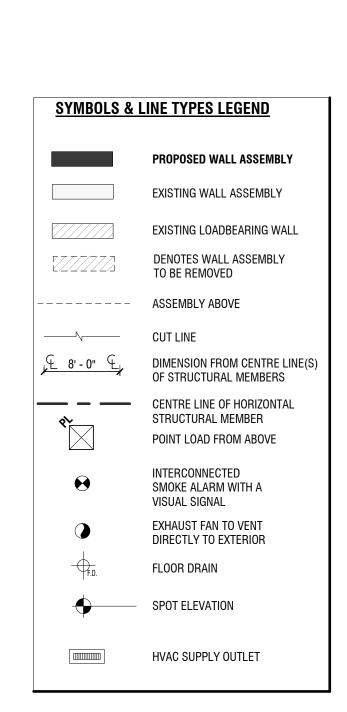

EXISTING TO REMAIN

PROPOSED SIDE WINDOV

PROPOSED REAR WINDOW

PROPOSED REAR WINDOW

PROPOSED SKYLIGHT BY VELUX OR SIMILAR PROPOSED SKYLIGHT BY VELUX OR SIMILAR





PROJECT NORTH	TRUE NORTH
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NO. DATE: REVISION 1 2023.12.04 EXISTING CONDITIONS

2 | 2024.01.07 | PRELIM DESIGN #1

3 | 2024.01.18 | PRELIM DESIGN #2

4 | 2024.02.05 | STRUCTURAL REVIEW

5 2024.02.10 ISSUED FOR VARIANCE

DRAWING LIST				
SHEET NUMBER	SHEET NAME			
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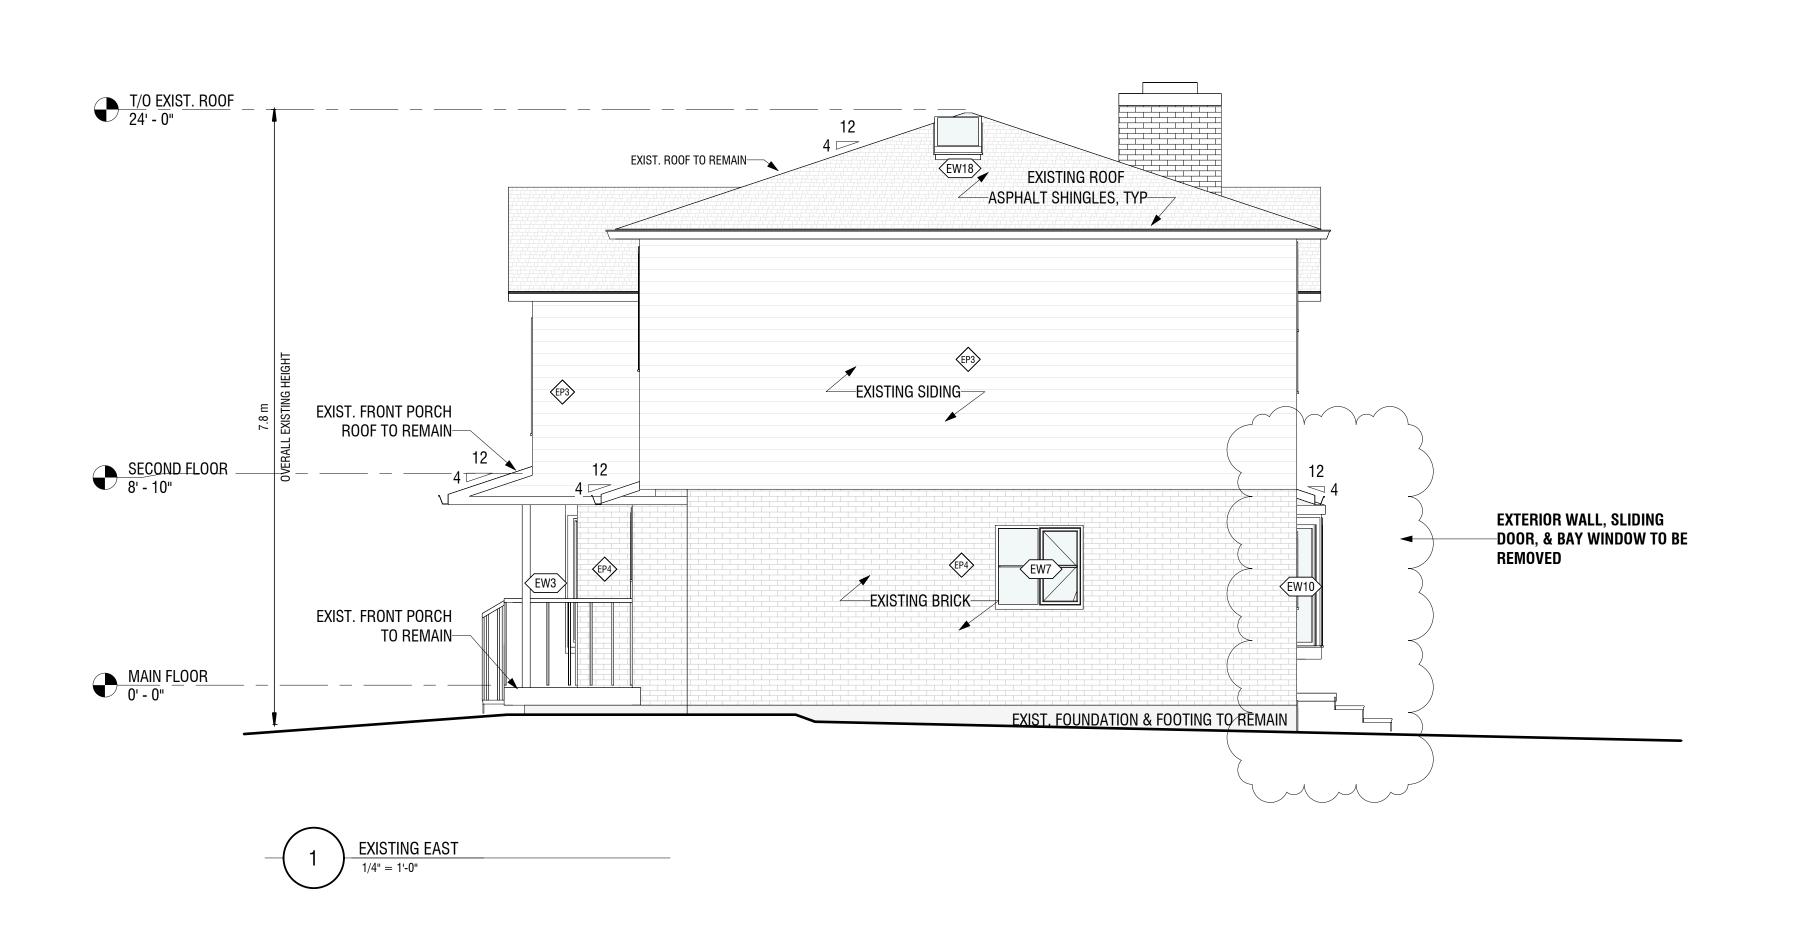
PROJECT:

# 10 REDHAVEN CT

S. ANTKOWIAK 2024.02.10

EXISTING FLOOR **PLANS** 


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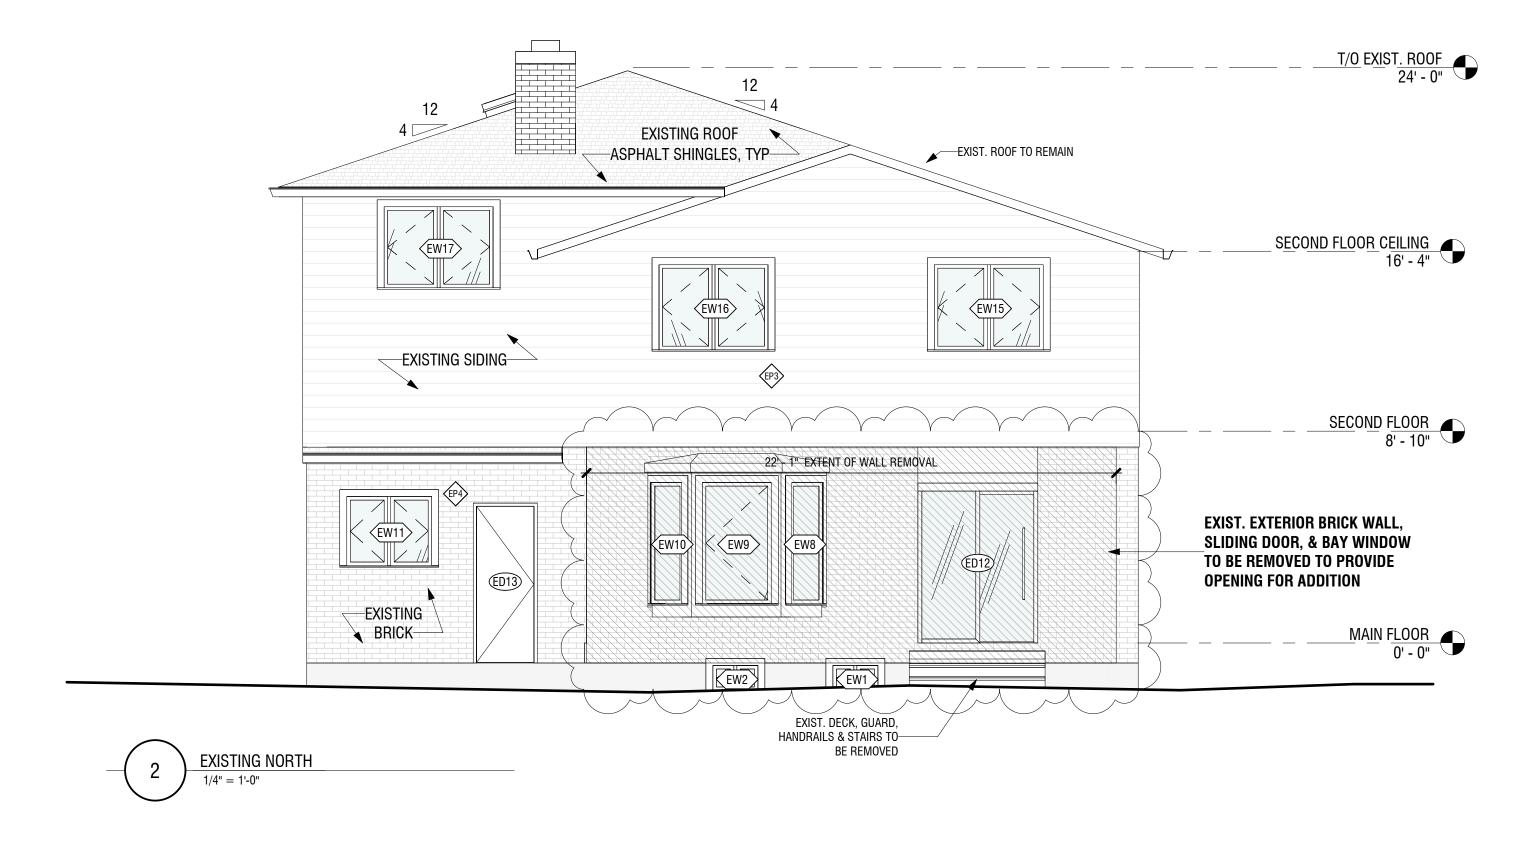
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ROOF PLAN 3/16" = 1'-0"








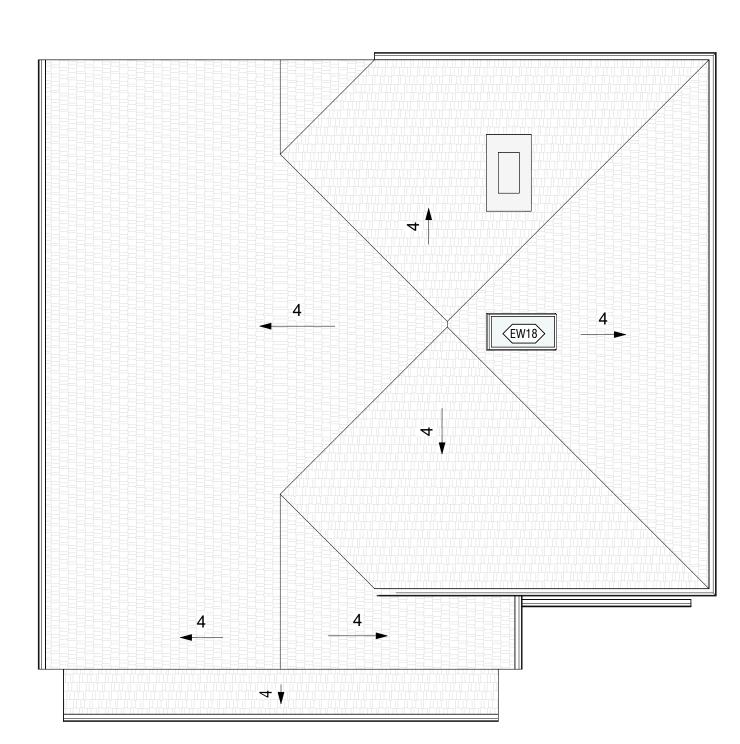

PROJECT NORTH

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DRAWING LIST SHEET NUMBER **SHEET NAME** A0 RENDERINGS A1 SITE PLAN, SCHEDULES & NOTES A2 GENERAL NOTES A3 EXISTING FLOOR PLANS A4 EXISTING ELEVATIONS - EAST AND NORTH A5 EXISTING ELEVATIONS - SOUTH AND WEST A6 PROPOSED BASEMENT PLAN A7 PROPOSED MAIN FLOOR PLAN A8 PROPOSED ELEVATIONS - EAST

PROJECT:

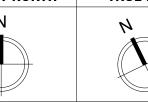10 REDHAVEN CT

AND NORTH

A9 PROPOSED ELEVATIONS -

SOUTH AND WEST

A10 PROPOSED BUILDING SECTION 1


S. ANTKOWIAK

<sup>DATE:</sup>
2024.02.10

EXISTING ELEVATIONS - EAST AND NORTH

AS NOTED


5/11

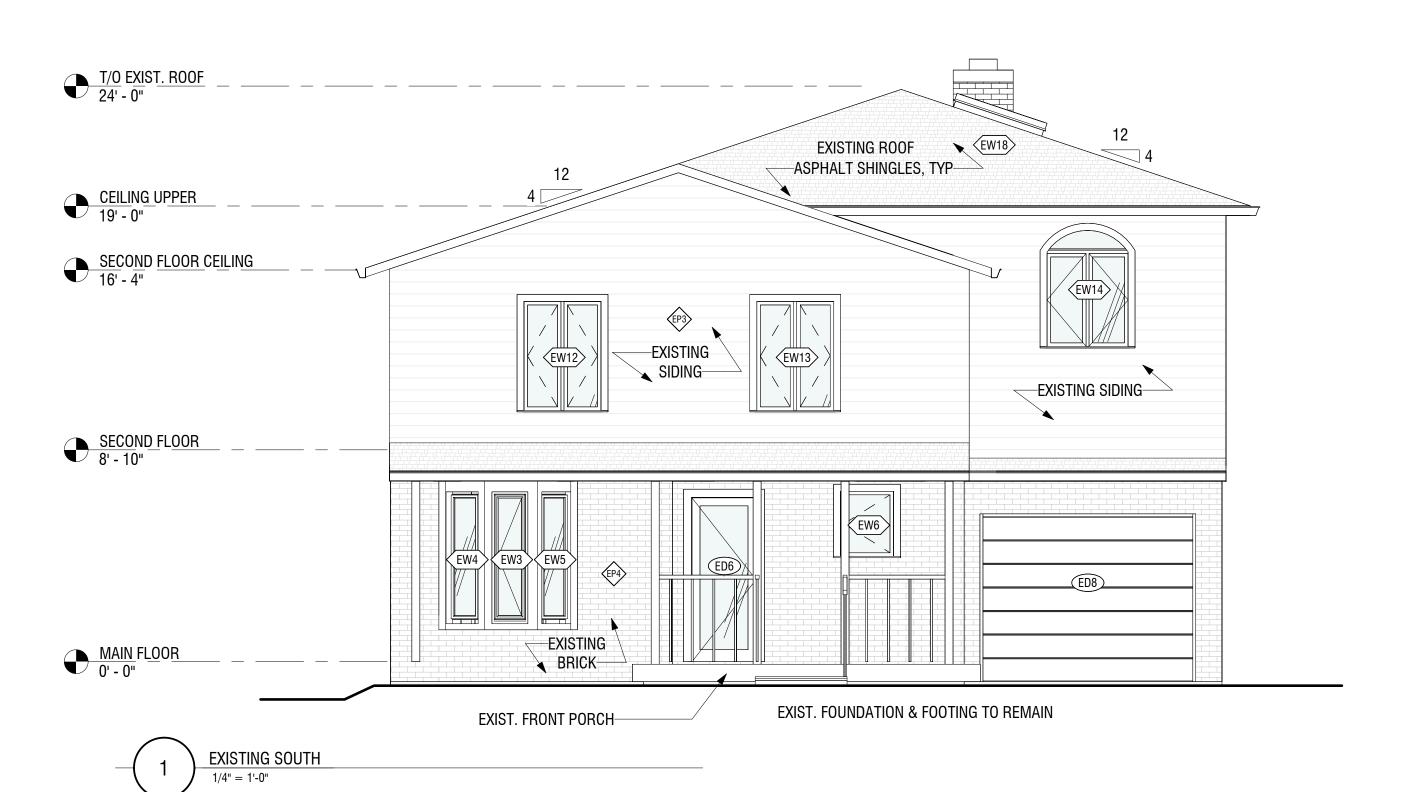



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PROJECT NORTH TRUE NORTH

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PROJECT:
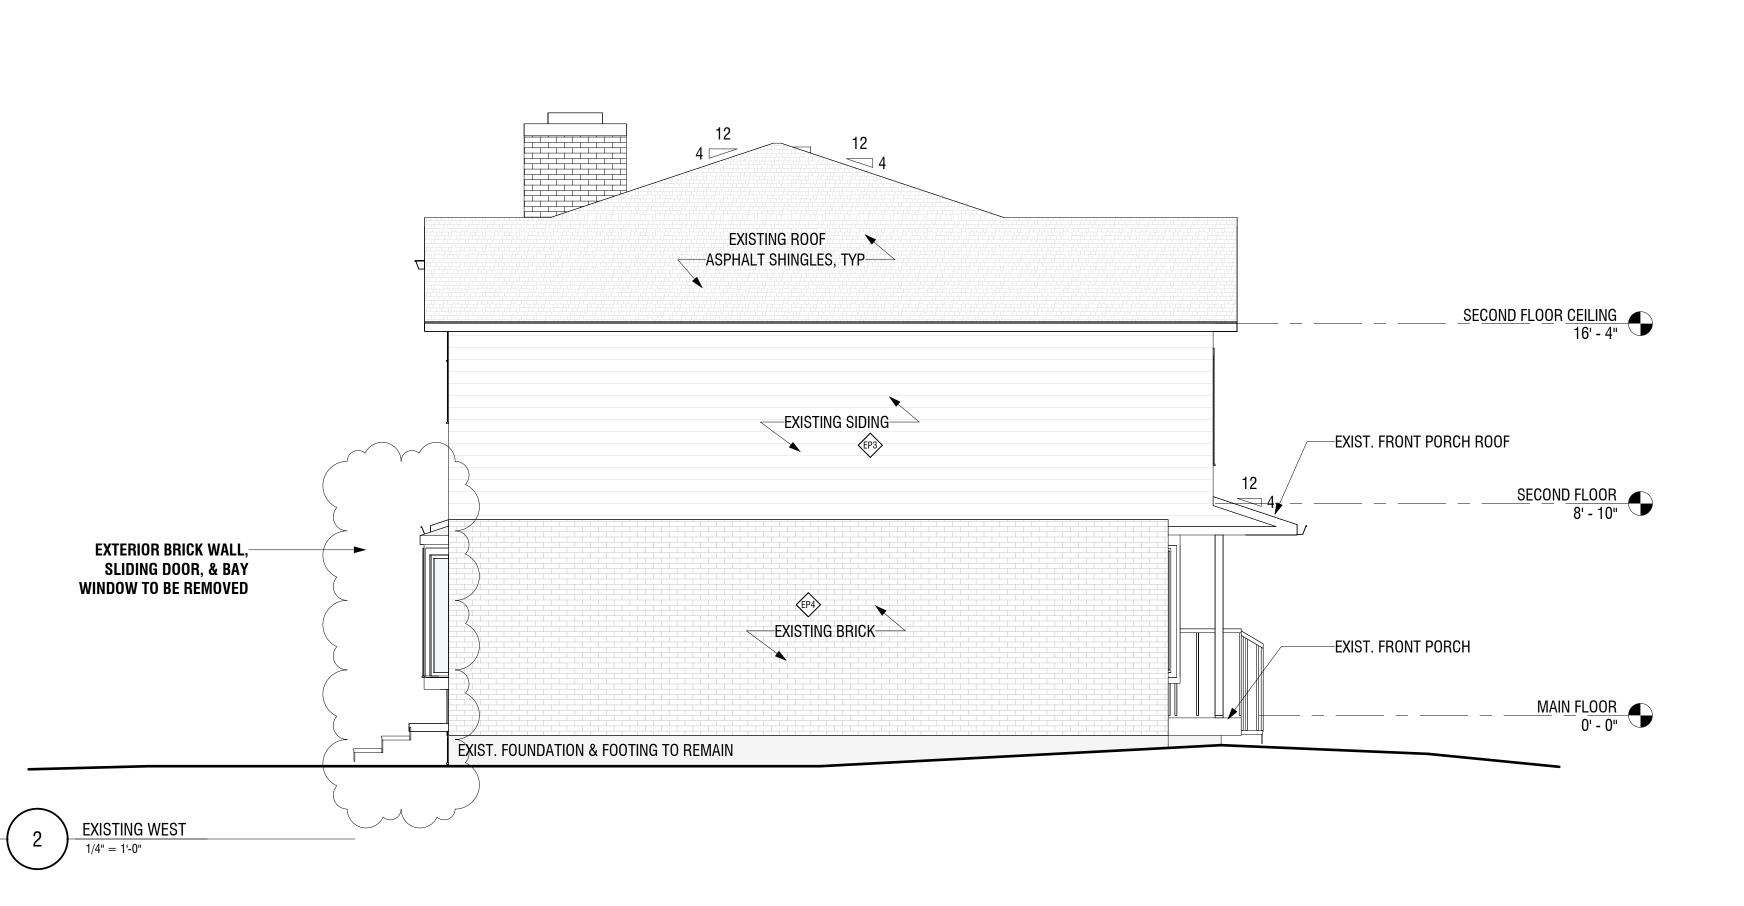
# 10 REDHAVEN CT.


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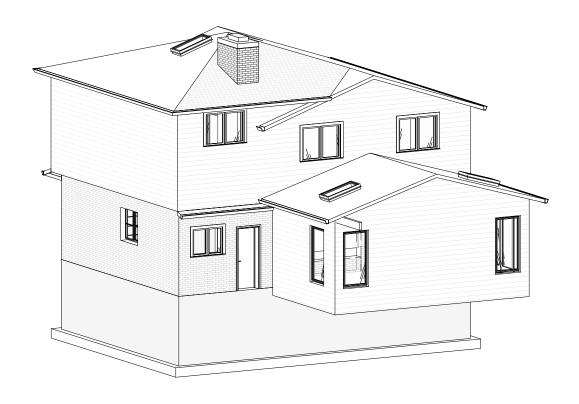
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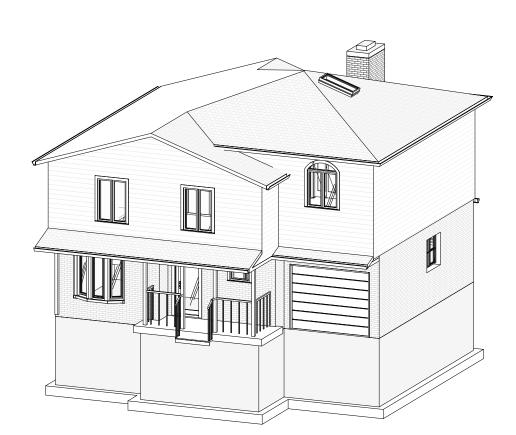
**EXISTING ELEVATIONS -**SOUTH AND WEST

AS NOTED

6/11





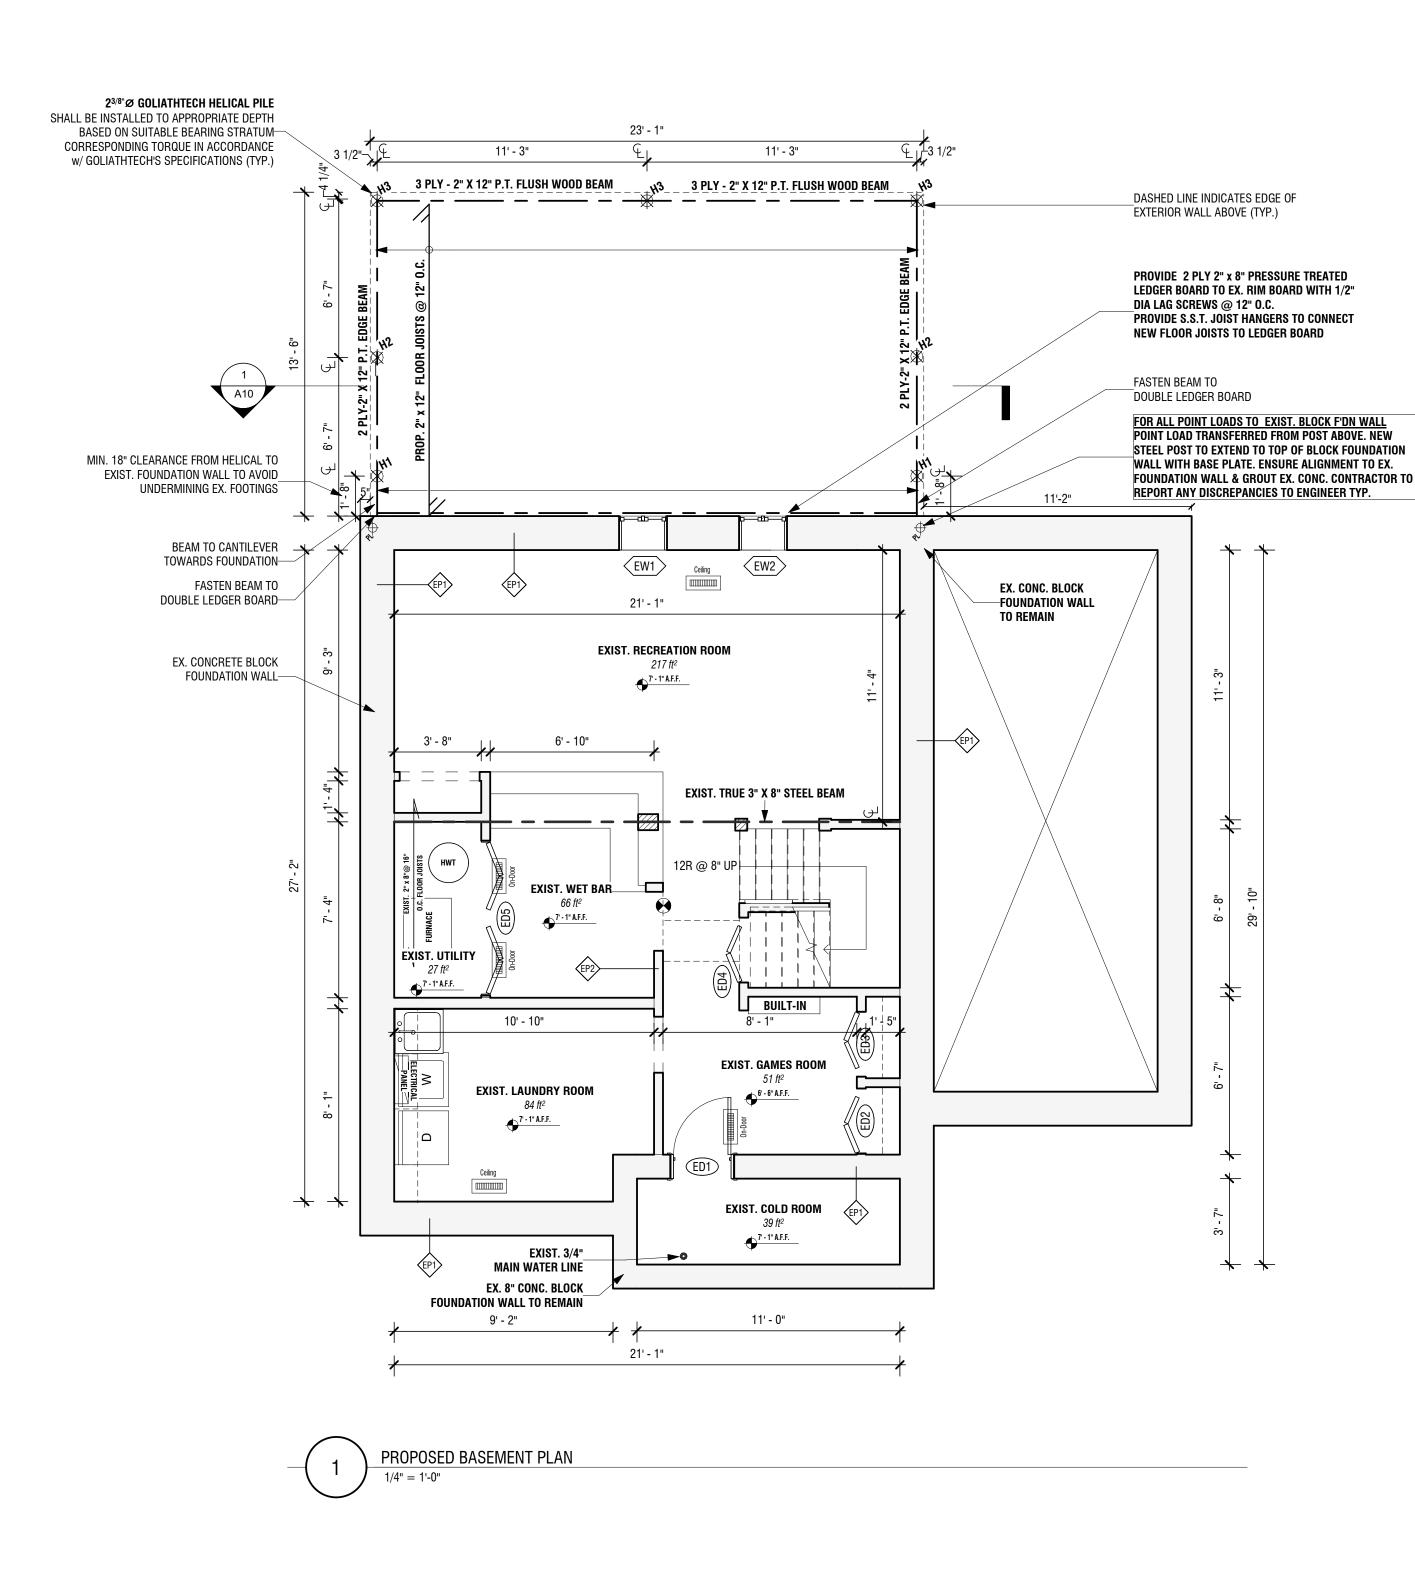

# HELICAL PILE SCHEDULE

#### H1 - 2<sup>3/8</sup>"Ø GOLIATHTECH HELICAL PILE

PROVIDE MIN. COMPRESSIVE RESISTANCE FORCE OF 4500lbs w/ 500 LBS-FT OF APPLIED TORQUE. PROVIDE SADDLE TO EXTEND TO U/S OF BEAM (MIN. 6'-0" BELOW GRADE)

#### H2 - 2<sup>3/8</sup>"Ø GOLIATHTECH HELICAL PILE

PROVIDE MIN. COMPRESS/VE RESISTANCE FORCE OF 6750lbs w/ 1250 LBS-FT OF APPLIED TORQUE. PROVIDE SADDLE TO EXTEND TO U/S OF BEAM (MIN. 6'-0" BELOW GRADE)

#### H3 - 2<sup>3/8</sup>"Ø GOLIATHTECH HELICAL PILE

PROVIDE MIN. COMPRESS/VE RESISTANCE FORCE OF 9000lbs w/ 2000 LBS-FT OF APPLIED TORQUE. PROVIDE SADDLE TO EXTEND TO U/S OF BEAM (MIN. 6'-0" BELOW GRADE)

HELICAL PILES SHALL BE INSTALLED TO APPROPRIATE DEPTH BASED ON SUITABLE BEARING STRATUM CORRESPONDING TORQUE IN ACCORDANCE w/ GOLIATHTECH SPECIFICATIONS.

ABOVE GROUND HEIGHT OF ALL HELICAL PILES ARE < 0.3m UNLESS OTHERWISE NOTED

<u>LIFE SAFETY</u>

<u>USING OBC PART 9 & PART 11, RENOVATIONS HOUSE MORE THAN 5 YEARS OLD</u>

SMOKE (OBC 9.10.19)/CARBON MONOXIDE DETECTORS (OBC 9.33.4)

LOCATIONS SHOWN ARE FOR CONTEXT ONLY. CONTRACTOR TO CONFIRM EXACT LOCATIONS.

AT LEAST ONE SMOKE ALARM MUST BE LOCATED ON EVERY FLOOR.

A SMOKE ALARM SHALL BE INSTALLED IN EACH SLEEPING ROOM AND THE REMAINDER OF THE STOREY, AND IF THE SLEEPING ROOMS ARE SERVED BY A HALLWAY, THE SMOKE ALARM SHALL BE LOCATED IN THE HALLWAY.

SMOKE ALARMS ARE REQUIRED TO BE INSTALLED BY PERMANENT CONNECTION TO AN ELECTRICAL CIRCUIT AND MUST HAVE NO DISCONNECT SWITCH BETWEEN THE CIRCUIT AND SMOKE ALARM. WHERE MORE THAN ONE SMOKE ALARM IS REQUIRED, THEY MUST ALL BE INTERCONNECTED SO THAT IF ONE ACTIVATES, THEY ALL ACTIVATE SIMULTANEOUSLY.

# SMOKE ALARMS MAY BE BATTERY OPERATED (OBC PART 11 COMPLIANCE ALTERNATIVE C175)

SMOKE ALARMS ALSO TO BE EQUIPPED WITH A VISUAL SIGNALLING COMPONENT TO THE REQUIREMENTS IN 18.5.3. OF NFPA 72 & MUST BE INTEGRATED OR INTERCONNECTED WITH SMOKE ALARMS.

CARBON MONOXIDE ALARMS TO BE BE INSTALLED ADJACENT TO BEDROOMS.

<u>FRAMIN</u>

WHERE THE FRAMING SYSTEMS ARE BEING ALTERED TO MATCH EXISTING FRAMING, LESSER AMOUNTS AND EXTENT OF INSULATION AND VAPOR BARRIER IS ACCEPTABLE. (OBC PART 11 COMPLIANCE ALTERNATIVE C199)

**FUTURE GRAB BARS** 

STUD WALL REINFORCEMENT

STUD WALL REINFORCEMENT SHALL BE INSTALLED IN "MAIN BATHROOMS" WITHIN A DWELLING UNIT ACCORDING TO OBC 9.5.2.3

BLOCKING LOCATION

BLOCKING IN WALLS - WHERE INDICATED, BLOCKING IS TO BE INSTALLED BETWEEN OR AGAINST STUDS IN THE WALLS ADJACENT

TO THE TOILET, SHOWER AND/OR BATHTUB TO SUPPORT INSTALLATION OF GRAB BARS IN ACCORDANCE WITH OBC 9.5.2.3.

BLOCKING LOCATION IN WALLS TO BE IN ACCORDANCE WITH GRAB BAR REQUIREMENTS OF OBC 3.8.

# VENTILATION

MECHANICAL EXHAUST FANS - TO BE VENTED TO EXTERIOR & PROVIDE MIN. 5.0 L/S IN KITCHENS & BATHROOMS, 37.5 L/S FOR PRINCIPAL EXHAUST FAN AND SHALL CONFORM TO 9.32.3 OF THE OBC COOKTOP/RANGE TO VENT DIRECTLY TO EXTERIOR, UNLESS OTHERWISE SPECIFIED. PROVED 10" DUCT WITH FAN MOUNTED ON EXTERIOR WALL OR ROOF.

**DIRECT GAS FIREPLACE** - ZERO CLEARANCE GAS FIREPLACE c/w VENT TO EXTERIOR & CARBON MONOXIDE

VENTS TO BE MIN 12" FROM ANY OPENING AND ABOVE FINISH GRADE

#### STAIRS, HANDRAILS & GUARDS

STAIRS IN ACCORDANCE W/ OBC TABLE 9.8.4.1

• STEP RISERS: 5" MIN. (125mm), 7.7/8" MAY (200r)

STEP RISERS: 5" MIN. (125mm), 7 7/8" MAX. (200mm)
RECTANGULAR TREADS RUN: 10" MIN. (255mm), 13 7/8" MAX. (355mm)

NOSING 1" MAX. (25mm)

MIN. WIDTH 34"MIN HEADROOM: 77"

HANDRAILS IN ACCORDANCE W/ OBC 9.8.7
• HEIGHT: 34" MIN., 42" MAX

C109 PART 11 COMPLIANCE ALTERNATIVE: REPLACEMENT OR EXTENSION OF EXISTING STAIR SYSTEMS SHALL BE


EXEMPT FROM THE PROVISIONS OF 9.8.1. TO 9.8.4, EXCEPT THEY SHALL HAVE:

A) A MIN. WIDTH B/W WALL FACES OF 700mm AND

B) A MIN. CLEAR HEIGHT OVER TREAD NOSING OR LANDING OF 1800mm

C113 PART 11 COMPLIANCE ALTERNATIVE: EXISTING HANDRAILS ACCEPTABLE, UNLESS CONSIDERED UNSAFE BY CHIEF BUILDING OFFICIAL

C114 PART 11 COMPLIANCE ALTERNATIVE: EXISTING GUARDS ACCEPTABLE, UNLESS CONSIDERED UNSAFE BY CHIEF BUILDING OFFICIAL

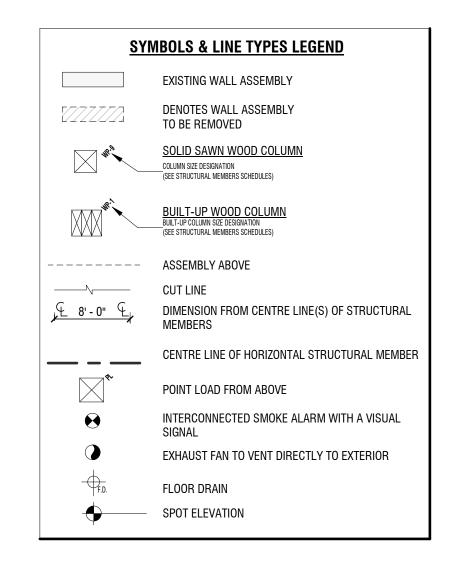

# **SCOPE OF WORK**

#### PROPOSED SCOPE OF WORK TO INVOLVE:

MAIN FLOOR:

- REMOVE EXTERIOR REAR LOADBEARING WALL & REMEDIATE STRUCTURAL COMPONENTS AS NECESSARY
- (AS NOTED ON FLOOR PLANS) ▶ RENOVATE EXISTING KITCHEN w/ NEW FIXTURES, FINISHES,
- & CABINETRY (LAYOUT BY OTHERS)
- RENOVATE EXISTING BATHROOM w/ NEW TOILET, VANITY
   NEW ELOOPING THROUGHOUT MAIN LEVEL
- NEW FLOORING THROUGHOUT MAIN LEVEL
   PRIME AND PAINT MAIN LEVEL WALLS, CEILINGS

	WINDOW	SCHEDULE - CONTRA	CTOR TO CONF	IRM EXIST. WII	NDOW DIMENSIONS
Window		Approxir	Approximate Size		
Number	Level	Width	Height	Height	Comments
EW1	BASEMENT PLAN	2' - 0"	1' - 2"	5' - 10"	EXISTING TO BE REMOVED
EW2	BASEMENT PLAN	2' - 0"	1' - 2"	5' - 10"	EXISTING TO BE REMOVED
EW3	MAIN FLOOR	1' - 6"	5' - 6"	1' - 7"	EXISTING TO REMAIN
EW4	MAIN FLOOR	1' - 6"	5' - 6"	1' - 7"	EXISTING TO REMAIN
EW5	MAIN FLOOR	1' - 6"	5' - 6"	1' - 7"	EXISTING TO REMAIN
EW6	MAIN FLOOR	2' - 4"	2' - 10"	4' - 4"	EXISTING TO REMAIN
EW7	MAIN FLOOR	3' - 8"	3' - 6"	3' - 2"	EXISTING TO REMAIN
EW11	MAIN FLOOR	3' - 8"	3' - 0"	3' - 2"	EXISTING TO REMAIN
EW12	SECOND FLOOR	3' - 4"	4' - 8"	1' - 7"	EXISTING TO REMAIN
EW13	SECOND FLOOR	3' - 4"	4' - 8"	1' - 7"	EXISTING TO REMAIN
EW14	THIRD FLOOR	3' - 6"	4' - 0"	1' - 7"	EXISTING TO REMAIN
EW15	SECOND FLOOR	4' - 8"	3' - 8"	3' - 4"	EXISTING TO REMAIN
EW16	SECOND FLOOR	4' - 8"	3' - 8"	3' - 4"	EXISTING TO REMAIN
EW17	THIRD FLOOR	4' - 8"	3' - 6"	3' - 3"	EXISTING TO REMAIN
EW18	CEILING UPPER	1' - 10 1/2"	3' - 10 1/2"		EXISTING TO REMAIN
W1	MAIN FLOOR	3' - 0"	6' - 0"	1' - 0"	PROPOSED SIDE WINDOW
W2	MAIN FLOOR	3' - 0"	6' - 0"	1' - 0"	PROPOSED REAR WINDOW
W3	MAIN FLOOR	3' - 0"	6' - 0"	1' - 0"	PROPOSED REAR WINDOW
W4	SECOND FLOOR	1' - 10 1/2"	3' - 10 1/2"		PROPOSED SKYLIGHT BY VELUX OR SIMILAR
W5	SECOND FLOOR	1' - 10 1/2"	3' - 10 1/2"		PROPOSED SKYLIGHT BY VELUX OR SIMILAR

DOOR SCHEDULE - CONTRACTOR TO CONFIRM EXIST. DOOR DIMENSIONS					
	Approx	imate Size			
Level	Width	Height	Comments		
MAIN FLOOR	4' - 7"	6' - 10"	36" EXTERIOR DOOR w/ 16" SIDELITE		
BASEMENT PLAN	2' - 8"	6' - 6"	EXISTING TO REMAIN		
BASEMENT PLAN	2' - 8"	6' - 4"	EXISTING TO REMAIN		
BASEMENT PLAN	2' - 8"	6' - 4"	EXISTING TO REMAIN		
BASEMENT PLAN	2' - 8"	6' - 0"	EXISTING TO REMAIN		
BASEMENT PLAN	6' - 4"	5' - 10"	EXISTING TO REMAIN		
MAIN FLOOR	2' - 8"	6' - 10"	EXISTING TO REMAIN		
MAIN FLOOR	2' - 8"	6' - 8"	EXISTING TO REMAIN		
MAIN FLOOR	9' - 0"	7' - 0"	EXISTING TO REMAIN		
MAIN FLOOR	2' - 2"	6' - 11"	EXISTING TO REMAIN		
MAIN FLOOR	2' - 8"	6' - 8"	EXISTING TO REMAIN		
MAIN FLOOR	2' - 8"	6' - 8"	EXISTING TO REMAIN		
MAIN FLOOR	5' - 0"	6' - 8"	EXISTING TO BE REMOVED		
MAIN FLOOR	2' - 8"	6' - 8"	EXISTING TO REMAIN		
SECOND FLOOR	5' - 0"	6' - 8"	EXISTING TO REMAIN		
THIRD FLOOR	2' - 8"	6' - 8"	EXISTING TO REMAIN		
SECOND FLOOR	2' - 8"	6' - 8"	EXISTING TO REMAIN		
SECOND FLOOR	1' - 10"	6' - 7"	EXISTING TO REMAIN		
THIRD FLOOR	2' - 8"	6' - 10"	EXISTING TO REMAIN		
THIRD FLOOR	5' - 2"	6' - 8"	EXISTING TO REMAIN		
SECOND FLOOR	2' - 8"	6' - 8"	EXISTING TO REMAIN		
SECOND FLOOR	2' - 8"	6' - 8"	EXISTING TO REMAIN		
SECOND FLOOR	6' - 4"	7' - 6"	EXISTING TO REMAIN		
	Level  MAIN FLOOR BASEMENT PLAN MAIN FLOOR THIRD FLOOR SECOND FLOOR THIRD FLOOR SECOND FLOOR THIRD FLOOR THIRD FLOOR SECOND FLOOR THIRD FLOOR SECOND FLOOR SECOND FLOOR SECOND FLOOR SECOND FLOOR SECOND FLOOR	Approx	Approximate Size   Width   Height		





**GENERAL NOTES:** 

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NO. DATE: REVISION

1 2023.12.04 EXISTING CONDITIONS

2 | 2024.01.07 | PRELIM DESIGN #1

3 | 2024.01.18 | PRELIM DESIGN #2 | 4 | 2024.02.05 | STRUCTURAL REVIEW

5 2024.02.10 ISSUED FOR VARIANCE

	DRAWING LIST				
SHEET NUMBER	SHEET NAME				
A0	RENDERINGS				
A1	SITE PLAN, SCHEDULES & NOTES				
A2	GENERAL NOTES				
A3	EXISTING FLOOR PLANS				
A4	EXISTING ELEVATIONS - EAST AND NORTH				
A5	EXISTING ELEVATIONS - SOUTH AND WEST				
A6	PROPOSED BASEMENT PLAN				
A7	PROPOSED MAIN FLOOR PLAN				
A8	PROPOSED ELEVATIONS - EAST AND NORTH				

A9 PROPOSED ELEVATIONS - SOUTH AND WEST

A10 PROPOSED BUILDING SECTION 1

PROJECT:

10 REDHAVEN CT


S. ANTKOWIAK


2024.02.10


PROPOSED
BASEMENT PLAN


AS NOTED

7 / 11

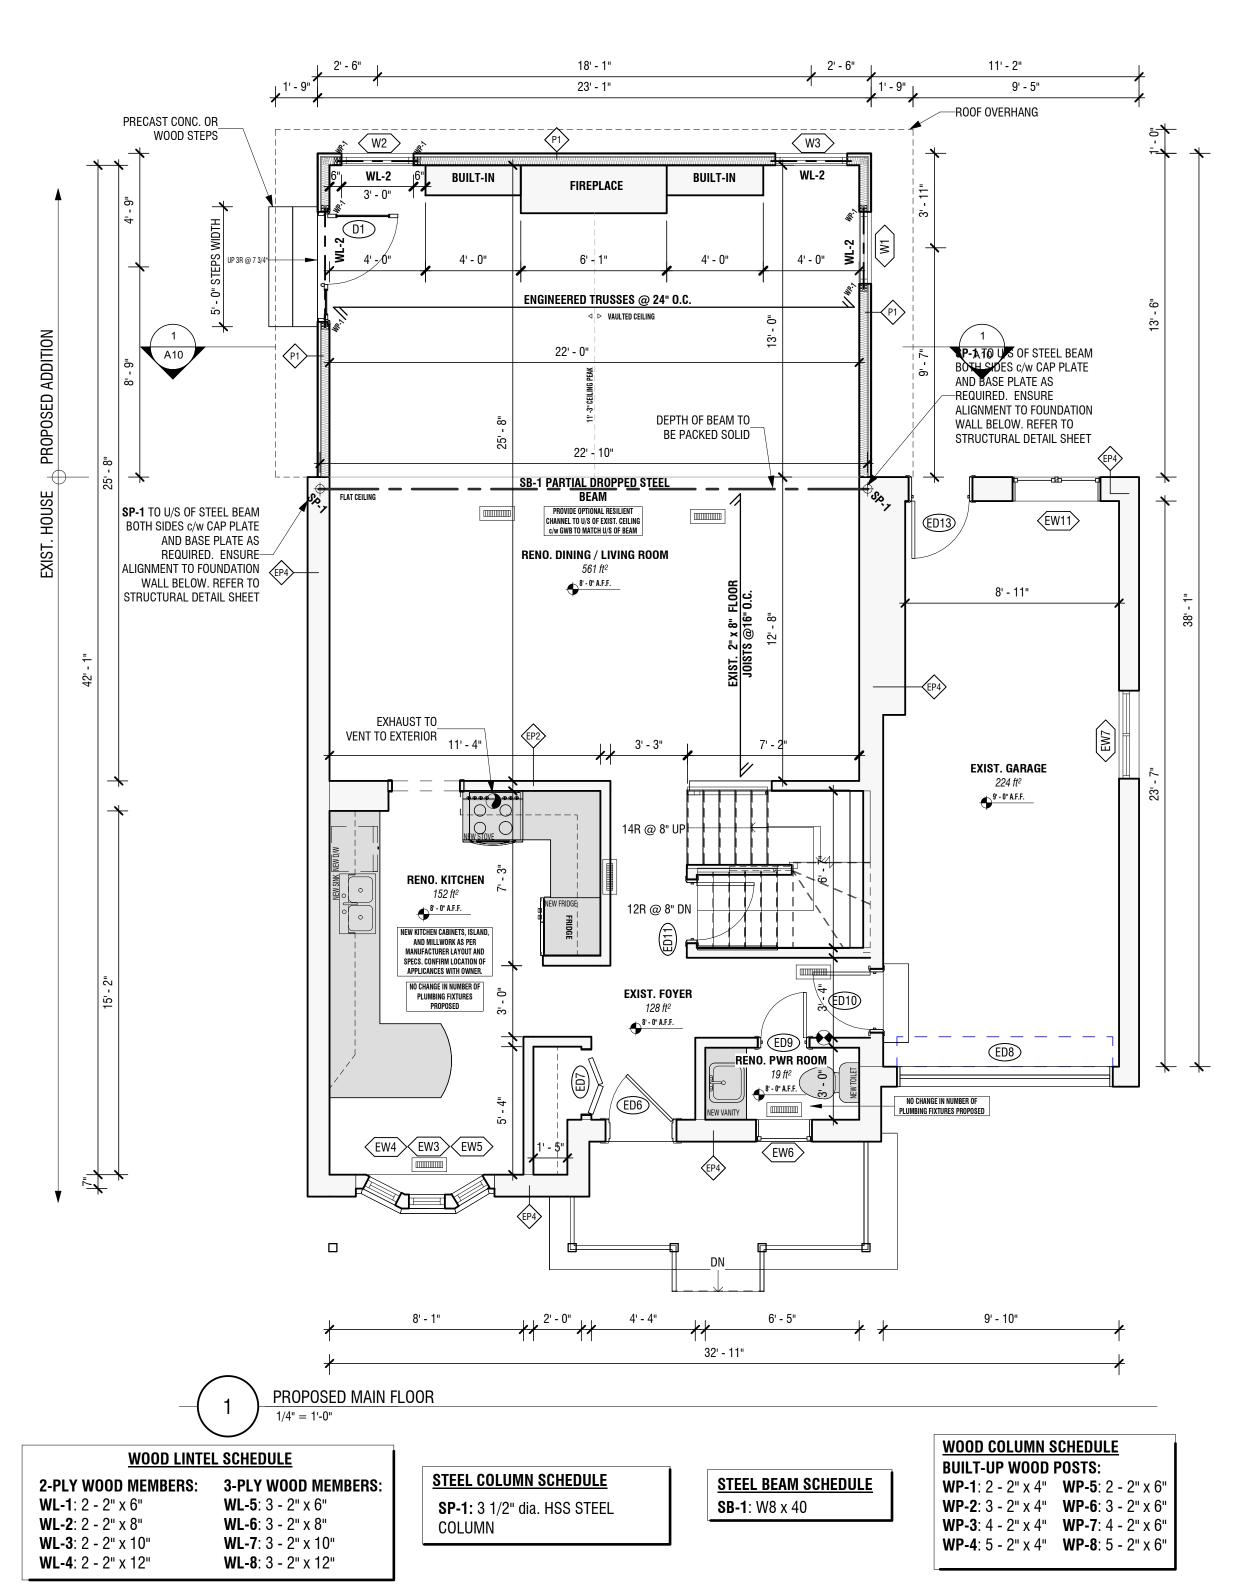

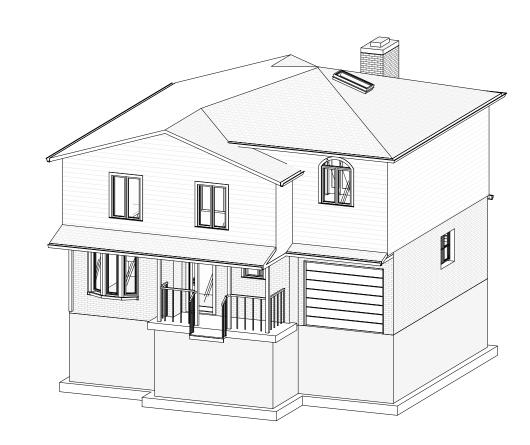

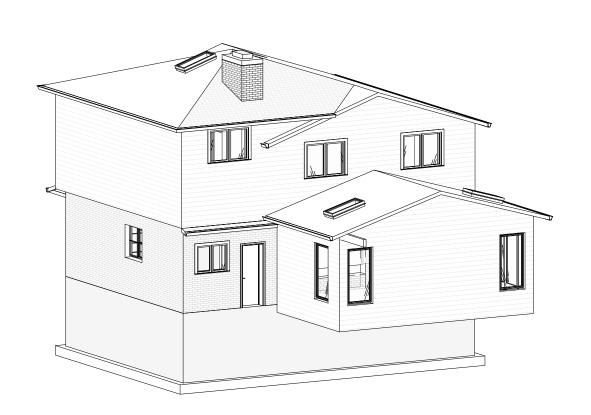

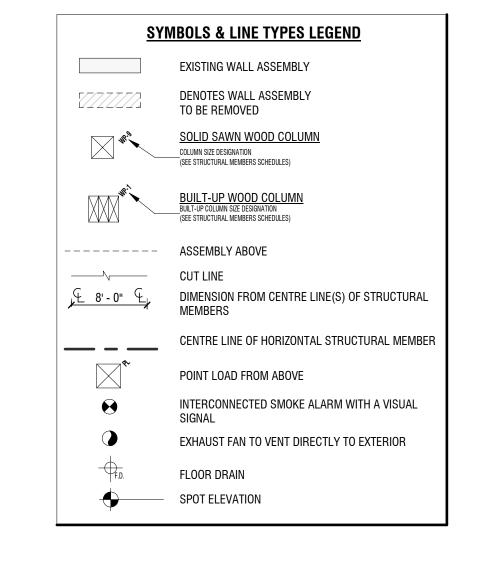

# **SCOPE OF WORK**

#### PROPOSED SCOPE OF WORK TO INVOLVE:

MAIN FLOOR:

- REMOVE EXTERIOR REAR LOADBEARING WALL & REMEDIATE STRUCTURAL COMPONENTS AS NECESSARY (AS NOTED ON FLOOR PLANS)
- RENOVATE EXISTING KITCHEN w/ NEW FIXTURES, FINISHES,
- & CABINETRY (LAYOUT BY OTHERS)
- RENOVATE EXISTING BATHROOM w/ NEW TOILET, VANITY NEW FLOORING THROUGHOUT MAIN LEVEL
- PRIME AND PAINT MAIN LEVEL WALLS, CEILINGS

	WINDOW	SCHEDULE - CONTRA	CTOR TO CONF	RM EXIST. WII	NDOW DIMENSIONS
Window		Approxir	nate Size	Sill	
Number	Level	Width	Height	Height	Comments
			1	1	
EW1	BASEMENT PLAN	2' - 0"	1' - 2"	5' - 10"	EXISTING TO BE REMOVED
EW2	BASEMENT PLAN	2' - 0"	1' - 2"	5' - 10"	EXISTING TO BE REMOVED
EW3	MAIN FLOOR	1' - 6"	5' - 6"	1' - 7"	EXISTING TO REMAIN
EW4	MAIN FLOOR	1' - 6"	5' - 6"	1' - 7"	EXISTING TO REMAIN
EW5	MAIN FLOOR	1' - 6"	5' - 6"	1' - 7"	EXISTING TO REMAIN
EW6	MAIN FLOOR	2' - 4"	2' - 10"	4' - 4"	EXISTING TO REMAIN
EW7	MAIN FLOOR	3' - 8"	3' - 6"	3' - 2"	EXISTING TO REMAIN
EW11	MAIN FLOOR	3' - 8"	3' - 0"	3' - 2"	EXISTING TO REMAIN
EW12	SECOND FLOOR	3' - 4"	4' - 8"	1' - 7"	EXISTING TO REMAIN
EW13	SECOND FLOOR	3' - 4"	4' - 8"	1' - 7"	EXISTING TO REMAIN
EW14	THIRD FLOOR	3' - 6"	4' - 0"	1' - 7"	EXISTING TO REMAIN
EW15	SECOND FLOOR	4' - 8"	3' - 8"	3' - 4"	EXISTING TO REMAIN
EW16	SECOND FLOOR	4' - 8"	3' - 8"	3' - 4"	EXISTING TO REMAIN
EW17	THIRD FLOOR	4' - 8"	3' - 6"	3' - 3"	EXISTING TO REMAIN
EW18	CEILING UPPER	1' - 10 1/2"	3' - 10 1/2"		EXISTING TO REMAIN
W1	MAIN FLOOR	3' - 0"	6' - 0"	1' - 0"	PROPOSED SIDE WINDOW
W2	MAIN FLOOR	3' - 0"	6' - 0"	1' - 0"	PROPOSED REAR WINDOW
W3	MAIN FLOOR	3' - 0"	6' - 0"	1' - 0"	PROPOSED REAR WINDOW
W4	SECOND FLOOR	1' - 10 1/2"	3' - 10 1/2"		PROPOSED SKYLIGHT BY VELUX OR

	2002 0011511115			ACCE DISERVACIONO
	DOOK SCHEDOLE -	CONTRACTOR TO C	UNFIKIM EXIST. D	OUR DIMENSIONS
Door		Approx	imate Size	
Number	Level	Width	Height	Comments
D1	MAIN FLOOR	4' - 7"	6' - 10"	36" EXTERIOR DOOR w/ 16" SIDELITE
ED1	BASEMENT PLAN	2' - 8"	6' - 6"	EXISTING TO REMAIN
ED2	BASEMENT PLAN	2' - 8"	6' - 4"	EXISTING TO REMAIN
ED3	BASEMENT PLAN	2' - 8"	6' - 4"	EXISTING TO REMAIN
ED4	BASEMENT PLAN	2' - 8"	6' - 0"	EXISTING TO REMAIN
ED5	BASEMENT PLAN	6' - 4"	5' - 10"	EXISTING TO REMAIN
ED6	MAIN FLOOR	2' - 8"	6' - 10"	EXISTING TO REMAIN
ED7	MAIN FLOOR	2' - 8"	6' - 8"	EXISTING TO REMAIN
ED8	MAIN FLOOR	9' - 0"	7' - 0"	EXISTING TO REMAIN
ED9	MAIN FLOOR	2' - 2"	6' - 11"	EXISTING TO REMAIN
ED10	MAIN FLOOR	2' - 8"	6' - 8"	EXISTING TO REMAIN
ED11	MAIN FLOOR	2' - 8"	6' - 8"	EXISTING TO REMAIN
ED12	MAIN FLOOR	5' - 0"	6' - 8"	EXISTING TO BE REMOVED
ED13	MAIN FLOOR	2' - 8"	6' - 8"	EXISTING TO REMAIN
ED14	SECOND FLOOR	5' - 0"	6' - 8"	EXISTING TO REMAIN
ED15	THIRD FLOOR	2' - 8"	6' - 8"	EXISTING TO REMAIN
ED16	SECOND FLOOR	2' - 8"	6' - 8"	EXISTING TO REMAIN
ED17	SECOND FLOOR	1' - 10"	6' - 7"	EXISTING TO REMAIN
ED18	THIRD FLOOR	2' - 8"	6' - 10"	EXISTING TO REMAIN
ED19	THIRD FLOOR	5' - 2"	6' - 8"	EXISTING TO REMAIN
ED20	SECOND FLOOR	2' - 8"	6' - 8"	EXISTING TO REMAIN
ED21	SECOND FLOOR	2' - 8"	6' - 8"	EXISTING TO REMAIN
FD22	SECOND ELOOR	6' - 4"	7' - 6"	EXISTING TO REMAIN

	WINDOW	SCHEDULE - CONTRA	CTOR TO CONFI	RM EXIST. WII	NDOW DIMENSIONS
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EW5	MAIN FLOOR	1' - 6"	5' - 6"	1' - 7"	EXISTING TO REMAIN
EW6	MAIN FLOOR	2' - 4"	2' - 10"	4' - 4"	EXISTING TO REMAIN
EW7	MAIN FLOOR	3' - 8"	3' - 6"	3' - 2"	EXISTING TO REMAIN
EW11	MAIN FLOOR	3' - 8"	3' - 0"	3' - 2"	EXISTING TO REMAIN
EW12	SECOND FLOOR	3' - 4"	4' - 8"	1' - 7"	EXISTING TO REMAIN
EW13	SECOND FLOOR	3' - 4"	4' - 8"	1' - 7"	EXISTING TO REMAIN
EW14	THIRD FLOOR	3' - 6"	4' - 0"	1' - 7"	EXISTING TO REMAIN
EW15	SECOND FLOOR	4' - 8"	3' - 8"	3' - 4"	EXISTING TO REMAIN
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W4	SECOND FLOOR	1' - 10 1/2"	3' - 10 1/2"		PROPOSED SKYLIGHT BY VELUX OR SIMILAR
W5	SECOND FLOOR	1' - 10 1/2"	3' - 10 1/2"		PROPOSED SKYLIGHT BY VELUX OR SIMILAR

Door		Approx	imate Size			
Number	Level	Width	Height	Comments		
D1	MAIN FLOOR	4' - 7"	6' - 10"	36" EXTERIOR DOOR w/ 16" SIDELITE		
ED1	BASEMENT PLAN	2' - 8"	6' - 6"	EXISTING TO REMAIN		
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ED3	BASEMENT PLAN	2' - 8"	6' - 4"	EXISTING TO REMAIN		
ED4	BASEMENT PLAN	2' - 8"	6' - 0"	EXISTING TO REMAIN		
ED5	BASEMENT PLAN	6' - 4"	5' - 10"	EXISTING TO REMAIN		
ED6	MAIN FLOOR	2' - 8"	6' - 10"	EXISTING TO REMAIN		
ED7	MAIN FLOOR	2' - 8"	6' - 8"	EXISTING TO REMAIN		
ED8	MAIN FLOOR	9' - 0"	7' - 0"	EXISTING TO REMAIN		
ED9	MAIN FLOOR	2' - 2"	6' - 11"	EXISTING TO REMAIN		
ED10	MAIN FLOOR	2' - 8"	6' - 8"	EXISTING TO REMAIN		
ED11	MAIN FLOOR	2' - 8"	6' - 8"	EXISTING TO REMAIN		
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ED16	SECOND FLOOR	2' - 8"	6' - 8"	EXISTING TO REMAIN		
ED17	SECOND FLOOR	1' - 10"	6' - 7"	EXISTING TO REMAIN		
ED18	THIRD FLOOR	2' - 8"	6' - 10"	EXISTING TO REMAIN		
ED19	THIRD FLOOR	5' - 2"	6' - 8"	EXISTING TO REMAIN		
ED20	SECOND FLOOR	2' - 8"	6' - 8"	EXISTING TO REMAIN		
ED21	SECOND FLOOR	2' - 8"	6' - 8"	EXISTING TO REMAIN		
ED22	SECOND FLOOR	6' - 4"	7' - 6"	EXISTING TO REMAIN		





TRUE NORTH PROJECT NORTH

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A10	PROPOSED BUILDING SECTION 1

PROJECT:

# 10 REDHAVEN CT

S. ANTKOWIAK

2024.02.10

PROPOSED MAIN FLOOR PLAN

AS NOTED

**A7** 



VENTS TO BE MIN 12" FROM ANY OPENING AND ABOVE FINISH GRADE

#### SMOKE (OBC 9.10.19)/CARBON MONOXIDE DETECTORS (OBC 9.33.4)

LOCATIONS SHOWN ARE FOR CONTEXT ONLY. CONTRACTOR TO CONFIRM EXACT LOCATIONS.

# AT LEAST ONE SMOKE ALARM MUST BE LOCATED ON EVERY FLOOR.

A SMOKE ALARM SHALL BE INSTALLED IN EACH SLEEPING ROOM AND THE REMAINDER OF THE STOREY, AND IF THE SLEEPING ROOMS ARE SERVED BY A HALLWAY, THE SMOKE ALARM SHALL BE LOCATED IN THE HALLWAY.

SMOKE ALARMS ARE REQUIRED TO BE INSTALLED BY PERMANENT CONNECTION TO AN ELECTRICAL CIRCUIT AND MUST HAVE NO DISCONNECT SWITCH BETWEEN THE CIRCUIT AND SMOKE ALARM. WHERE MORE THAN ONE SMOKE ALARM IS REQUIRED, THEY MUST ALL BE INTERCONNECTED SO THAT IF ONE ACTIVATES, THEY ALL ACTIVATE SIMULTANEOUSLY.

#### SMOKE ALARMS MAY BE BATTERY OPERATED (OBC PART 11 COMPLIANCE ALTERNATIVE C175)

SMOKE ALARMS ALSO TO BE EQUIPPED WITH A VISUAL SIGNALLING COMPONENT TO THE REQUIREMENTS IN 18.5.3. OF NFPA 72 & MUST BE INTEGRATED OR INTERCONNECTED WITH SMOKE ALARMS.

#### CARBON MONOXIDE ALARMS TO BE BE INSTALLED ADJACENT TO BEDROOMS.

LIFE SAFETY

WHERE THE FRAMING SYSTEMS ARE BEING ALTERED TO MATCH EXISTING FRAMING, LESSER AMOUNTS AND EXTENT OF INSULATION AND VAPOR BARRIER IS ACCEPTABLE. (OBC PART 11 COMPLIANCE ALTERNATIVE C199)

# <u>USING OBC PART 9 & PART 11, RENOVATIONS HOUSE MORE THAN 5 YEARS OLD</u>

#### STUD WALL REINFORCEMENT

<u>FUTURE GRAB BARS</u>

STUD WALL REINFORCEMENT SHALL BE INSTALLED IN "MAIN BATHROOMS" WITHIN A DWELLING UNIT ACCORDING TO OBC 9.5.2.3

# **BLOCKING LOCATION**

BLOCKING IN WALLS - WHERE INDICATED, BLOCKING IS TO BE INSTALLED BETWEEN OR AGAINST STUDS IN THE

WALLS ADJACENT TO THE TOILET, SHOWER AND/OR BATHTUB TO SUPPORT INSTALLATION OF GRAB BARS IN ACCORDANCE WITH OBC

BLOCKING LOCATION IN WALLS TO BE IN ACCORDANCE WITH GRAB BAR REQUIREMENTS OF OBC 3.8.

# <u>VENTILATION</u>

MECHANICAL EXHAUST FANS - TO BE VENTED TO EXTERIOR & PROVIDE MIN. 5.0 L/S IN KITCHENS & BATHROOMS, 37.5 L/S FOR PRINCIPAL EXHAUST FAN AND SHALL CONFORM TO 9.32.3 OF THE OBC COOKTOP/RANGE TO VENT DIRECTLY TO EXTERIOR, UNLESS OTHERWISE SPECIFIED. PROVED 10" DUCT WITH FAN MOUNTED ON EXTERIOR WALL OR ROOF.

**DIRECT GAS FIREPLACE** - ZERO CLEARANCE GAS FIREPLACE c/w VENT TO EXTERIOR & CARBON MONOXIDE

UNLESS CONSIDERED UNSAFE BY CHIEF BUILDING OFFICIAL

**STAIRS, HANDRAILS & GUARDS** 

• NOSING 1" MAX. (25mm)

• HEIGHT: 34" MIN., 42" MAX

MIN HEADROOM: 77"

MIN. WIDTH 34"

STAIRS IN ACCORDANCE W/ OBC TABLE 9.8.4.1

HANDRAILS IN ACCORDANCE W/ OBC 9.8.7

A) A MIN. WIDTH B/W WALL FACES OF 700mm AND

EXISTING STAIR SYSTEMS SHALL BE

• STEP RISERS: 5" MIN. (125mm), 7 7/8" MAX. (200mm)

• RECTANGULAR TREADS RUN: 10" MIN. (255mm), 13 7/8" MAX. (355mm)


C109 PART 11 COMPLIANCE ALTERNATIVE: REPLACEMENT OR EXTENSION OF

EXEMPT FROM THE PROVISIONS OF 9.8.1. TO 9.8.4, EXCEPT THEY SHALL HAVE:

C113 PART 11 COMPLIANCE ALTERNATIVE: EXISTING HANDRAILS ACCEPTABLE,

C114 PART 11 COMPLIANCE ALTERNATIVE: EXISTING GUARDS ACCEPTABLE, UNLESS CONSIDERED UNSAFE BY CHIEF BUILDING OFFICIAL

B) A MIN. CLEAR HEIGHT OVER TREAD NOSING OR LANDING OF 1800mm

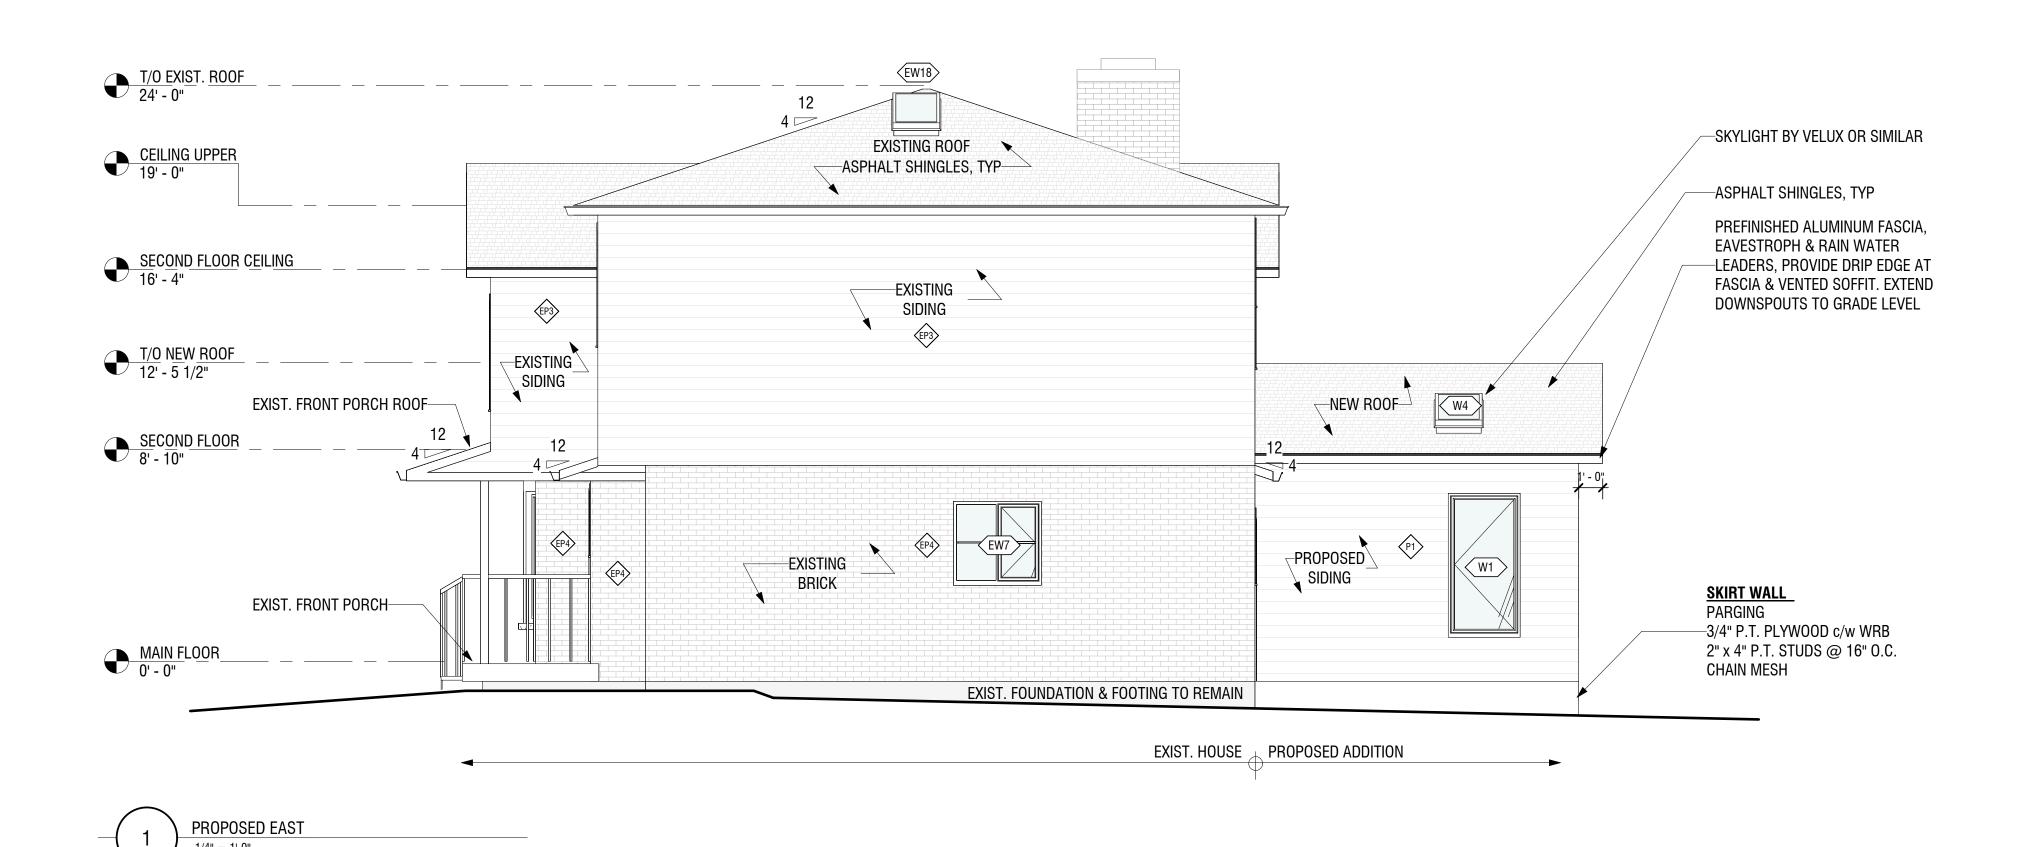


# **EXPOSING BUILDING FACE CALCULATIONS**

PROPOSED REAR ELEVATION UNPROTECTED OPENINGS - OBC 9.10.15.4 PROP. LIMITING DISTANCE: 5.5 m TOTAL NORTH WALL AREA: 67.8 m<sup>2</sup> (665 sq.ft.) MAX AGG. AREA PERMITTED: 18% GLAZED AREA PERMITTED: 12.2m<sup>2</sup> (120 sq.ft.)

GLAZED AREA PROVIDED: 10.2 m<sup>2</sup> (110 sq.ft.)

PROPOSED EAST ELEVATION - USING INDIVIDUAL <u>PORTIONS WITH A SKEWED PROPERTY LINE</u> UNPROTECTED OPENINGS - OBC 9.10.15.4 PROP. LIMITING DISTANCE: 6.4 m TOTAL EAST WALL AREA: 69.7 m<sup>2</sup> (750 sq.ft.) MAX AGG. AREA PERMITTED: 34% TOTAL EAST ADDITION WALL AREA: 13 m<sup>2</sup> (140 sq.ft.) GLAZED AREA PERMITTED: 4.4 m<sup>2</sup> (47.6 sq.ft.) GLAZED AREA PROVIDED: 1.7 m<sup>2</sup> (18 sq.ft.)


PROPOSED WEST ELEVATION- USING INDIVIDUAL PORTIONS WITH A SKEWED PROPERTY LINE UNPROTECTED OPENINGS - OBC 9.10.15.4 PROP. LIMITING DISTANCE: 4.8 m TOTAL WEST WALL AREA: 69.7 m<sup>2</sup> (750 sq.ft.) MAX AGG. AREA PERMITTED: 18% TOTAL WEST ADDITION WALL AREA: 13 m<sup>2</sup> (140 sq.ft.) GLAZED AREA PERMITTED: 2.3 m<sup>2</sup> (25.2sq.ft.) GLAZED AREA PROVIDED: 2.1 m<sup>2</sup> (22 sq.ft.)

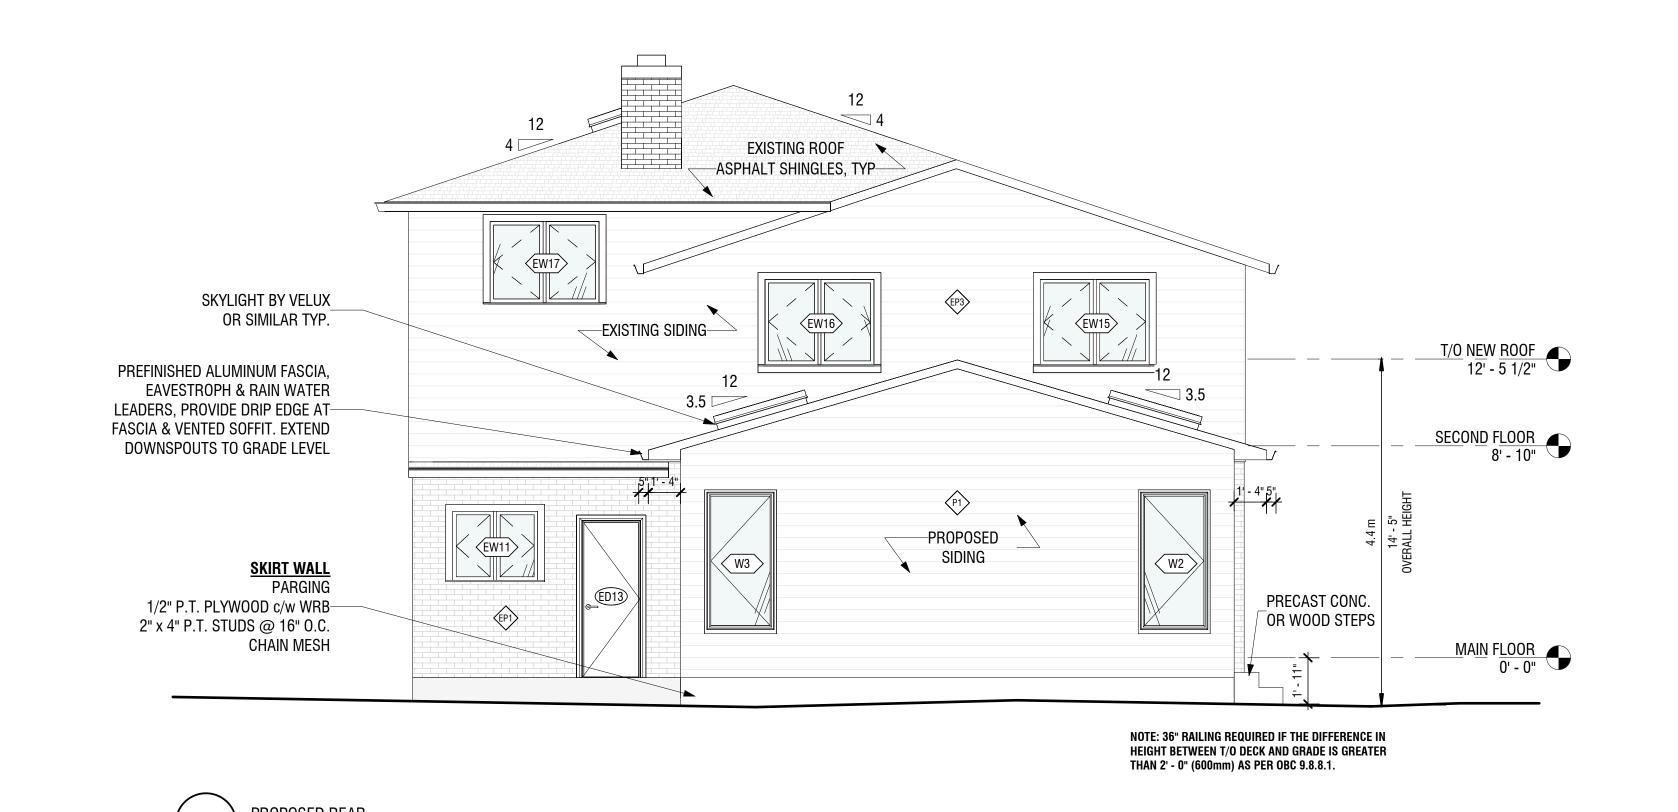





PROJECT NORTH

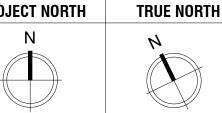

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PROJECT:

# 10 REDHAVEN CT.


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2024.02.10

PROPOSED **ELEVATIONS - EAST** AND NORTH

AS NOTED

9/11

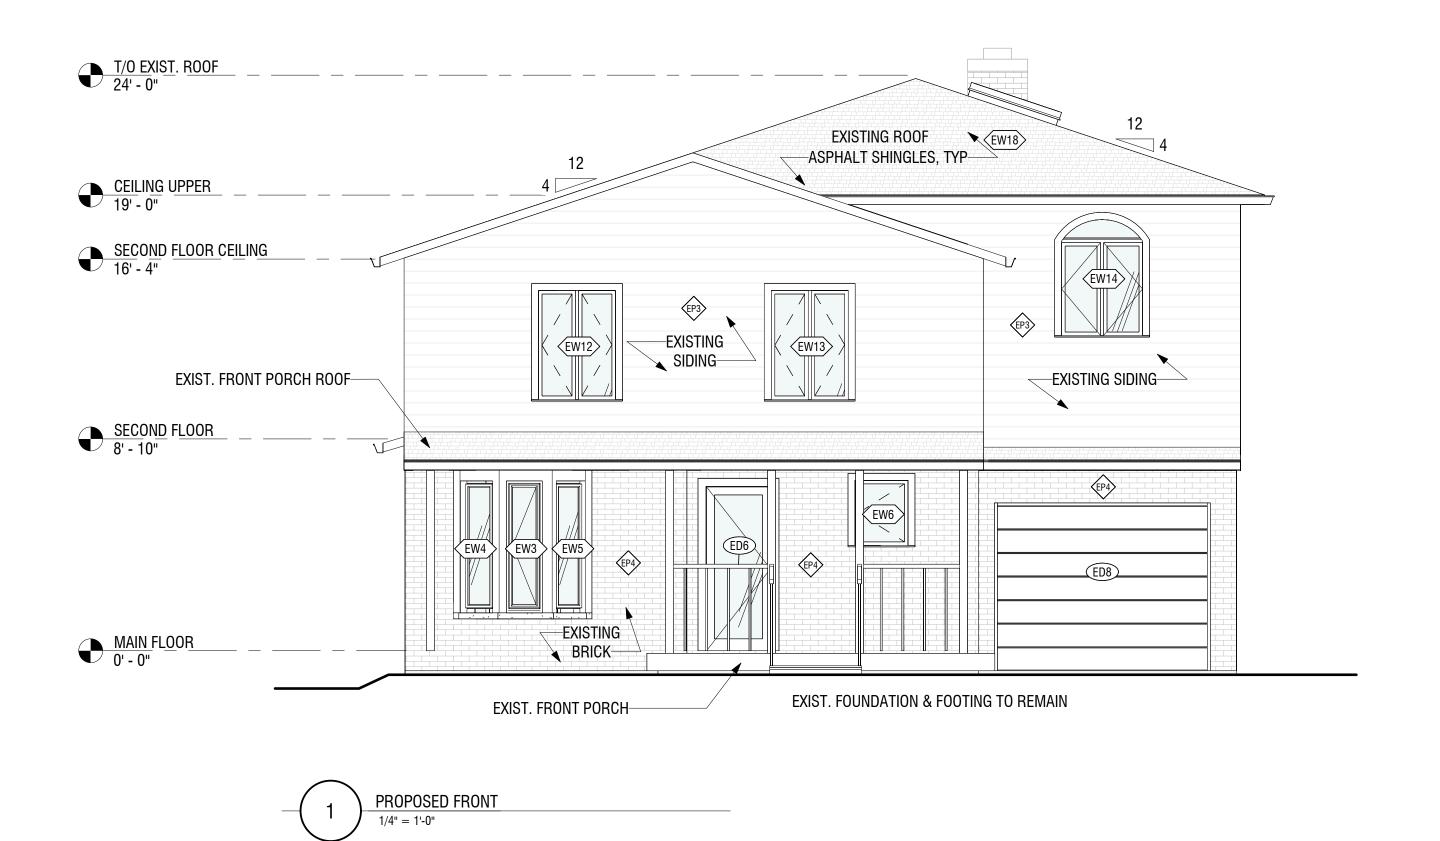

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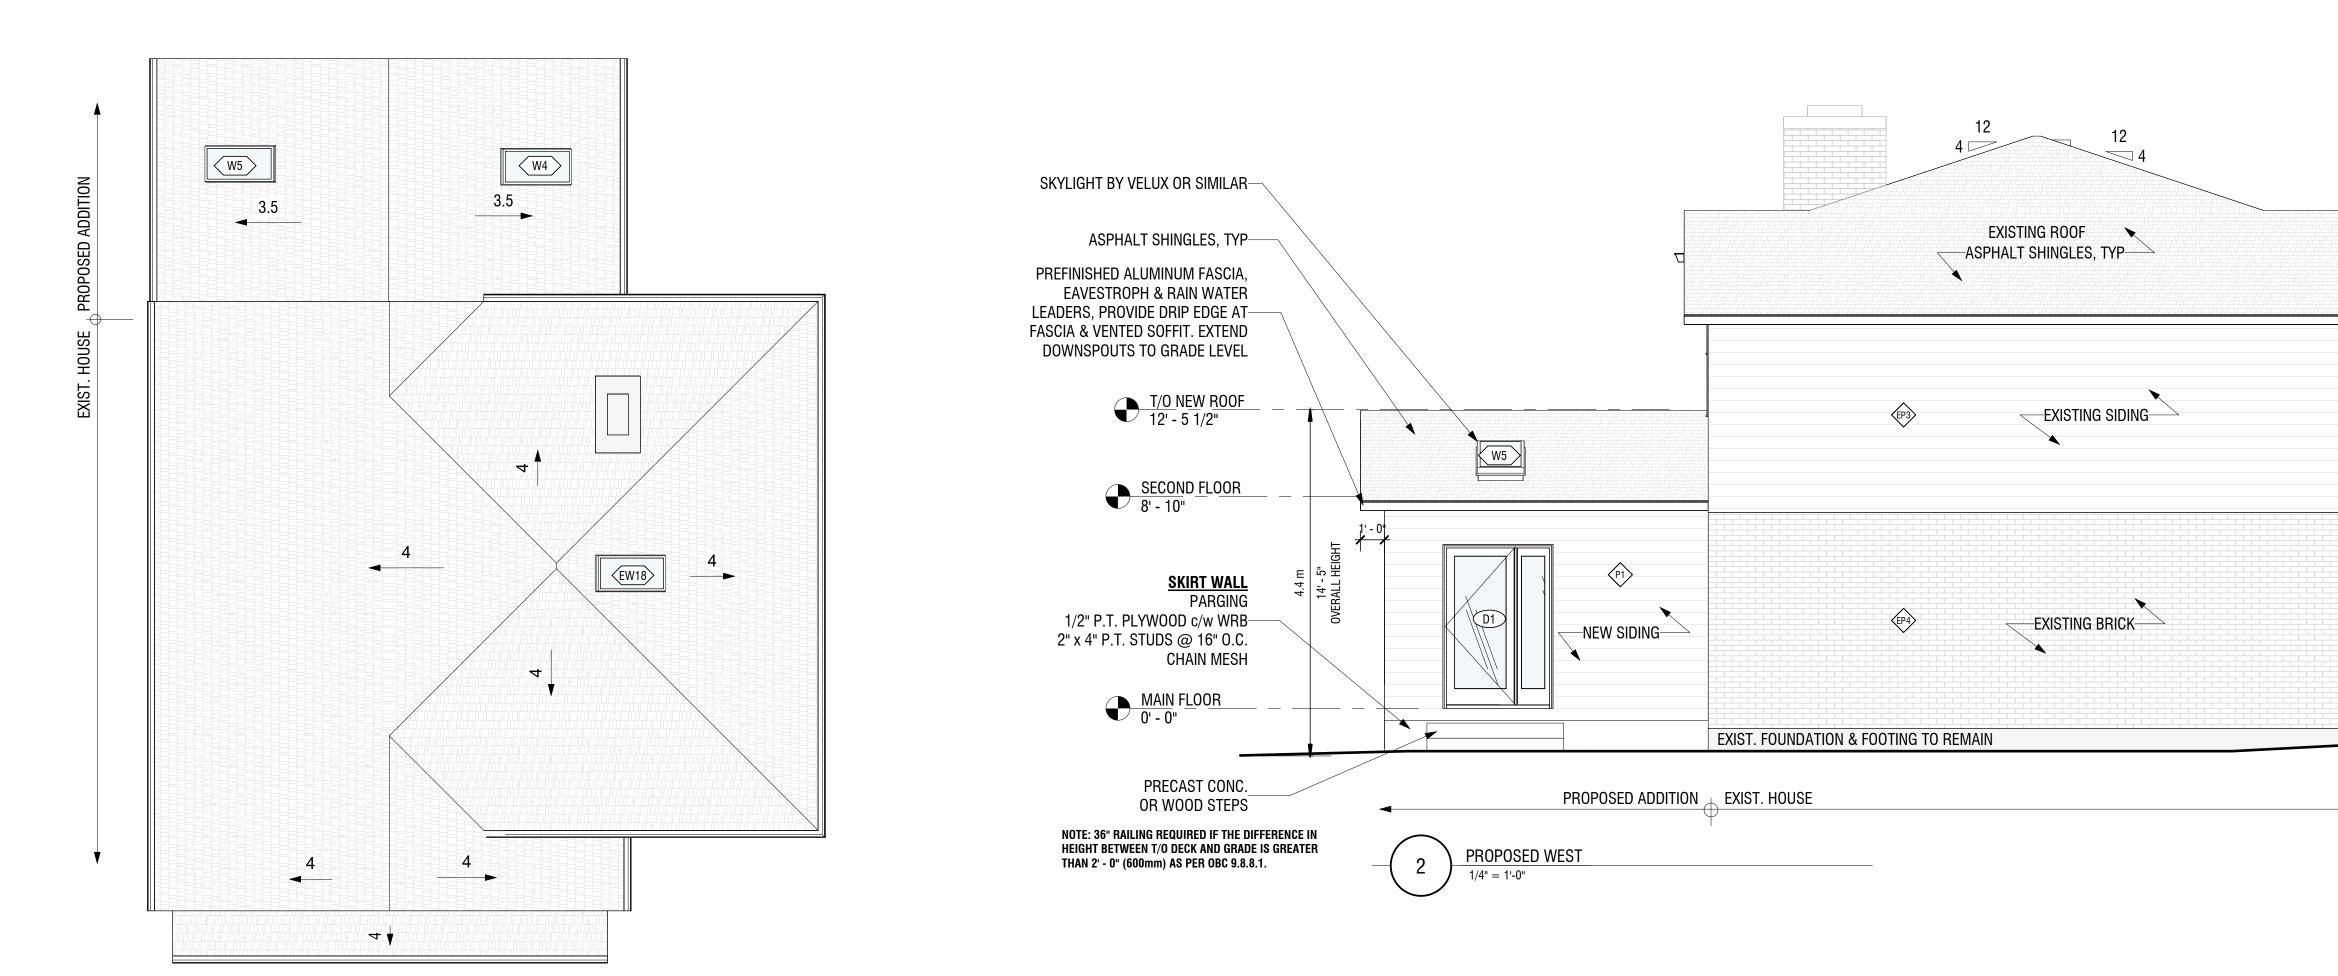
#### PROPOSED EAST ELEVATION - USING INDIVIDUAL

PORTIONS WITH A SKEWED PROPERTY LINE UNPROTECTED OPENINGS - OBC 9.10.15.4 PROP. LIMITING DISTANCE: 6.4 m TOTAL EAST WALL AREA: 69.7 m<sup>2</sup> (750 sq.ft.) MAX AGG. AREA PERMITTED: 34% TOTAL EAST ADDITION WALL AREA: 13 m<sup>2</sup> (140 sq.ft.) GLAZED AREA PERMITTED: 4.4 m<sup>2</sup> (47.6 sq.ft.) GLAZED AREA PROVIDED: 1.7 m<sup>2</sup> (18 sq.ft.)

#### PROPOSED WEST ELEVATION- USING INDIVIDUAL

GLAZED AREA PROVIDED: 2.1 m<sup>2</sup> (22 sq.ft.)


**PORTIONS WITH A SKEWED PROPERTY LINE** UNPROTECTED OPENINGS - OBC 9.10.15.4 PROP. LIMITING DISTANCE: 4.8 m TOTAL WEST WALL AREA: 69.7 m<sup>2</sup> (750 sq.ft.) MAX AGG. AREA PERMITTED: 18% TOTAL WEST ADDITION WALL AREA: 13 m<sup>2</sup> (140 sq.ft.) GLAZED AREA PERMITTED: 2.3 m<sup>2</sup> (25.2sq.ft.)







TRUE NORTH PROJECT NORTH

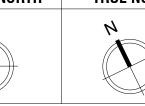

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PROJECT:

EXIST. FRONT PORCH ROOF

EXIST. FRONT PORCH


10 REDHAVEN CT.


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PROPOSED **ELEVATIONS -**SOUTH AND WEST

AS NOTED





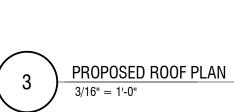

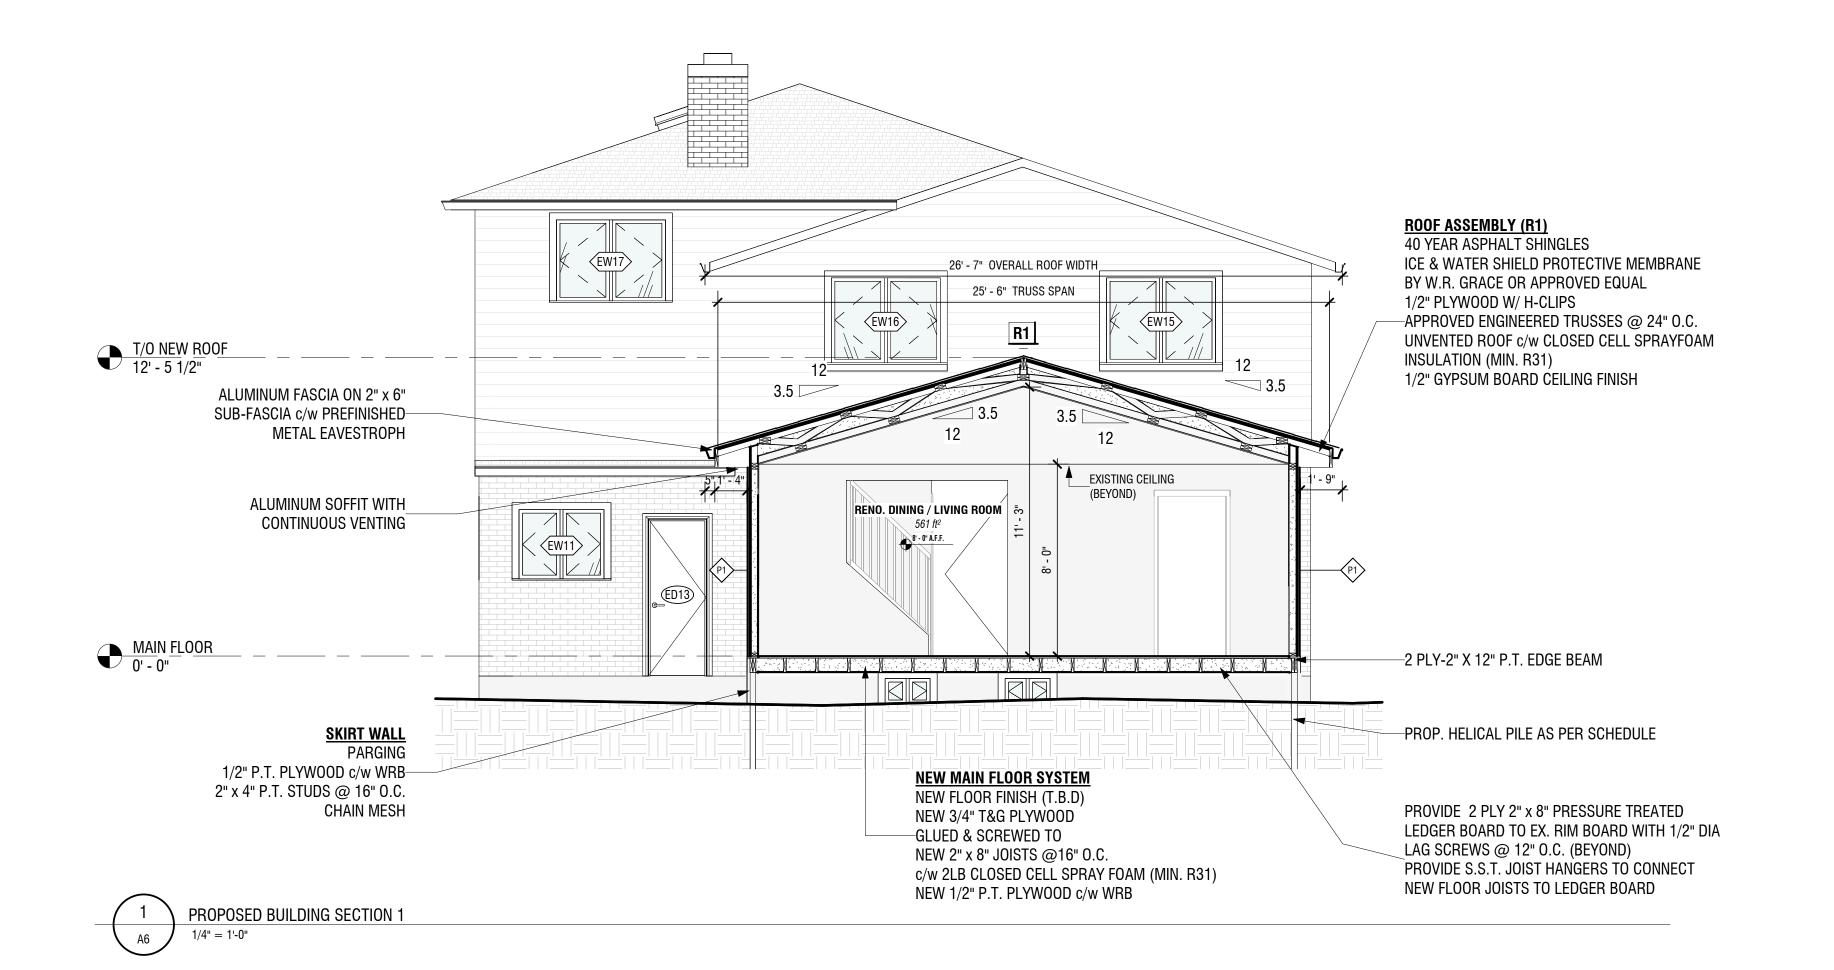

JECT NORTH	TRUE NOR
N	N

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1) ALL CONTRACTORS AND/OR TRADES SHALL REVIEW ALL PLANS & REPORT ANY DISCREPANCIES PRIOR TO CONSTRUCTION.
2) DO NOT SCALE DRAWINGS.
3) USE ONLY LATEST REVISED DRAWINGS.
5) DRAWINGS ARE THE PROPERTY OF THE DESIGNER. ANY UNAUTHORIZED USE IS PROHIBITED.

J.	DATE:	REVISION
	2023.12.04	EXISTING CONDITIONS

2 2024.01.07 PRELIM DESIGN #1

3 | 2024.01.18 | PRELIM DESIGN #2

4 2024.02.05 STRUCTURAL REVIEW

5 2024.02.10 ISSUED FOR VARIANCE

DRAWING LIST			
SHEET Number	SHEET NAME		
A0	RENDERINGS		
A1	SITE PLAN, SCHEDULES & NOTES		
A2	GENERAL NOTES		
A3	EXISTING FLOOR PLANS		
A4	EXISTING ELEVATIONS - EAST AND NORTH		
A5	EXISTING ELEVATIONS - SOUTH AND WEST		
A6	PROPOSED BASEMENT PLAN		
A7	PROPOSED MAIN FLOOR PLAN		
A8	PROPOSED ELEVATIONS - EAST AND NORTH		
А9	PROPOSED ELEVATIONS - SOUTH AND WEST		
A10	PROPOSED BUILDING SECTION 1		

### PROJECT:

# 10 REDHAVEN CT.

S. ANTKOWIAK

2024.02.10

PROPOSED
BUILDING SECTION

CALE:

11 / 11

AS NOTED



#### **Committee of Adjustment**

City Hall, 5<sup>th</sup> Floor, 71 Main St. W., Hamilton, ON L8P4Y5

Phone: (905) 546-2424 ext. 4221

Email: cofa@hamilton.ca

#### APPLICATION FOR A MINOR VARIANCE/PERMISSION

UNDER SECTION 45 OF THE PLANNING ACT

#### 1. APPLICANT INFORMATION

	NAME	MAILII	NG ADDRES	S
Registered Owners(s)	DONNA DANKS			
Applicant(s)	ANTHONY VENNERI			
Agent or Solicitor				
.2 All corresponde	nce should be sent to	── ☐ Purcha ☑ Applica		Owner ☑ Agent/Solicitor
.3 Sign should be	sent to	☐ Purcha: ☑ Applica		<ul><li>✓</li><li>Owner</li><li>☐Agent/Solicitor</li></ul>
.4 Request for digi	tal copy of sign	✓ Yes*	□No	
If YES, provide email address where sign is to be sent				
.5 All corresponde	nce may be sent by ema	ail	✓ Yes*	□No
(if applicable). C	mail must be included fo Only one email address es not guarantee all cor	submitted wi	Il result in the	

#### 2. LOCATION OF SUBJECT LAND

2.1 Complete the applicable sections:

Municipal Address	10 Redhaven Ct		
Assessment Roll Number	00330524000		
Former Municipality Stoney Creek			
Lot		Concession	
Registered Plan Number	M-261	Lot(s)	58
Reference Plan Number (s)		Part(s)	

2.2 Are there any easements or restrictive covenants affecting the subject land
---

₩ No

If YES, describe the easement or covenant and its effect:

#### 3. PURPOSE OF THE APPLICATION

Additional sheets can be submitted if there is not sufficient room to answer the following questions. Additional sheets must be clearly labelled

All dimensions in the application form are to be provided in metric units (millimetres, metres, hectares, etc.)

3.1	Nature ar		. i. c	1. 1.
` <b>4</b> 1	NIGHTING ON	IN AVIANT	AT PAHAT A	nniida tar
	Naillie ai	ICI EXIEIII	OI LEHELA	DUNIEU IOI

To permit the construction of a one-storey rear addition, with a rear yard setback of 5.5m whereas 7.5m is required.

☐ Second Dwelling Unit		Reconstruction of E	Existing	Dwelling
------------------------	--	---------------------	----------	----------

3.2 Why it is not possible to comply with the provisions of the By-law?

The requested variance is required due to the irregular shape of the lot, which imposes significant constraints on the standard building and zoning regulations. This variance is intended to allow for a reasonable use of additional square footage for the homeowner, aligning with the overall intent of zoning laws while acknowledging the unique challenges posed by the lot's shape.

3.3 Is this an application 45(2) of the Planning Act.

]Yes [	₽N	(

If yes, please provide an explanation:

#### 4. DESCRIPTION OF SUBJECT LAND AND SERVICING INFORMATION

#### 4.1 Dimensions of Subject Lands:

Lot Frontage	Lot Depth	Lot Area	Width of Street
7.8m	28.4m	480sq.m	32m court
		-	diameter

	ouildings and structur ce from side, rear ar	es on or proposed for nd front lot lines)	the subject lands:	
Existing:				
Type of Structure	Front Yard Setback	Rear Yard Setback	Side Yard Setbacks	Date of Construction
2-storey semi-detached dwelling	9.1m	8.7m	1.2m/1.7m	1979
Proposed:				
Type of Structure	Front Yard Setback	Rear Yard Setback	Side Yard Setbacks	Date of Construction
1-storey rear addition	-	5.5m	4.8m/6.4m	April 2024
4.3. Particulars of a sheets if neces  Existing:	•	ures on or proposed f	for the subject lands (ส	attach additional
Type of Structure	Ground Floor Area	Gross Floor Area	Number of Storeys	Height
2-storey semi-detached dwelling	89.5 sq.m	188.3 sq.m	2	7.8m
Proposed:				
Type of Structure	Ground Floor Area	Gross Floor Area	Number of Storeys	Height
1-storey rear addition	29 sq.m	29 sq.m	1	4.4m
publicly owi ☐ privately ow	supply: (check approphed and operated piper and operated in direct and direct apperainage: (check apper appe	oed water system Idividual well	☐ lake or other ☐ other means	
<ul> <li>☑ publicly owned and operated storm sewers</li> <li>☐ swales</li> </ul>			☐ ditches ☐ other means	s (specify)

4.6	Type of sewage disposal proposed: (check appropriate box)
	☑ publicly owned and operated sanitary sewage
	☐ system privately owned and operated individual
	septic system other means (specify)
4.7	Type of access: (check appropriate box)
	<ul><li>☐ provincial highway</li><li>☐ municipal road, seasonally maintained</li><li>☐ other public road</li></ul>
	☑ municipal road, maintained all year
4.8	Proposed use(s) of the subject property (single detached dwelling duplex, retail, factory etc.):
	Semi-detached dwelling
4.9	Existing uses of abutting properties (single detached dwelling duplex, retail, factory etc.):
	Semi-detached dwellings
7	HISTORY OF THE SUBJECT LAND
7.1	Date of acquisition of subject lands: 1983
7.2	Previous use(s) of the subject property: (single detached dwelling duplex, retail, factory etc)
	Semi-detached dwelling
7.3	Existing use(s) of the subject property: (single detached dwelling duplex, retail, factory etc)
	Semi-detached dwelling
7.4	Length of time the existing uses of the subject property have continued:
	40 years
7.5	What is the existing official plan designation of the subject land?
	Rural Hamilton Official Plan designation (if applicable):
	Rural Settlement Area:
	Urban Hamilton Official Plan designation (if applicable)
	Please provide an explanation of how the application conforms with the Official Plan.
7.6	What is the existing zoning of the subject land? <u>"R5" (Stoney Creek Zoning By-law 3692-92)</u>
7.8	Has the owner previously applied for relief in respect of the subject property?
	(Zoning By-lawAmendment or Minor Variance) ☐ Yes
	☐ Yes
	,, p p

7.9	Planning Act?	Yes	ication for consent under Section 53 of the ☑ No
	If yes, please provide the file num	nber:	
7.10	If a site-specific Zoning By-law Autwo-year anniversary of the by-la		en received for the subject property, has the expired?
		□Yes	✓ No
7.11		allowed must be	ctor of Planning and Chief Planner that the included. Failure to do so may result in an
8	ADDITIONAL INFORMATION		
8.1	Number of Dwelling Units Existin	g: <u>1</u>	_
8.2	Number of Dwelling Units Propos	sed: <u>0</u>	<del>_</del>
8.3	Additional Information (please inc	clude separate she	eet if needed):

# **COMPLETE APPLICATION REQUIREMENTS** 11.1 All Applications ✓ Application Fee Site Sketch ✓ Complete Application form ✓ Signatures Sheet Other Information Deemed Necessary 11.4 Cover Letter/Planning Justification Report Authorization from Council or Director of Planning and Chief Planner to submit application for Minor Variance Minimum Distance Separation Formulae (data sheet available upon request) Hydrogeological Assessment Septic Assessment **Archeological Assessment** Noise Study Parking Study